
| PRO | PROPOSED TREE LIST SP | | | | | CANOPY CALCULATION CHART | | | | |
|-----|-----------------------|---------------------------------|------------------------|-----------|-----------|--------------------------|------------|---|---|---------------------------|
| KEY | QTY | BOTANICAL NAME | COMMON NAME | SIZE | CONDITION | REMARKS | ORIGIN | CROWN ARA PER TREE (m ²) | CANOPY AREA SUBTOTAL (m ²) | % OF TOTAL CANOPY AREA |
| | | | | | | | | | | |
| AC | 4 | Amelancier canadensis | Shadblow Serviceberry | 60mm cal. | B&B | | Native | 78.5 | 314 | 9% |
| ACM | 2 | Amelancier canadensis multistem | Multistem Serviceberry | 60mm cal. | B&B | Multi-stem | Native | 78.5 | 157 | 5% |
| AS | 1 | Acer saccharum | Sugar Maple | 60mm cal. | B&B | | Native | 154 | 154 | 5% |
| AF | 4 | Acer x freemanii | Freeman's Maple | 60mm cal. | B&B | | Native | 154 | 616 | 19% |
| AG | 3 | Aesculus glabra | Ohio Buckeye | 60mm cal. | B&B | | Native | 154 | 462 | 14% |
| BP | 2 | Betula populifolia 'Multi-stem' | Multi-stem Gray Birch | 60mm cal. | B&B | Multi-stem | Native | 78.5 | 157 | 5% |
| CO | 4 | Celtis occidentalis | Hackberry | 60mm cal. | B&B | | Native | 154 | 616 | 19% |
| GT | 2 | Gleditsia triacanthos 'Skyline' | Skyline Honey Locust | 60mm cal. | B&B | | Native | 154 | 308 | 5% |
| MD | 2 | Malus 'Dolgo' | Dolgo Crabapple | 60mm cal. | B&B | | Non-Native | 78.5 | 157 | 5% |
| MP | 2 | Malus 'Profusion' | Profusion Crabapple | 60mm cal. | B&B | | Non-Native | 78.5 | 157 | 5% |
| QR | 2 | Quercus rubra | Red Oak | 60mm cal. | B&B | | Native | 154 | 308 | 9% |
| | | | | | | | | | | |
| | | | | | | | | | | |


PROPOSED TREE AND PLANT LIST NOTES:


- PROPOSED TREES SHOWN AT 40-YEAR CANOPY PROJECTIONS:
- 3m CANOPY DIAMETER FOR SMALL TREES
- 10m CANOPY DIAMETER FOR MEDIUM TREES - 12m CANOPY DIAMETER FOR LARGE TREES
- 2. ALL PROPOSED PLANT MATERIAL TO BE PLANTED ON PRIVATE PROPERTY.
- TREE SETBACK FROM BUILDING EQUAL TO THEORETICAL MATURE HEIGHT OF TREE AS
- PER GEOTECHNICAL REPORT.
- 4. REFER TO GEOTECHNICAL REPORT FOR LOCATION OF CHAMPLAIN SEA CLAY DEPOSITS.
- 5. SOIL VOLUME CALCULATIONS ARE BASED ON A DEPTH OF 1.5m.

| Р | ROPOSED TI | REE CANOPY CO | VERAGE TOTAL | 3,409m ² |
|---|-------------|-------------------|---------------|----------------------|
| | EXISTING TI | REE CANOPY CO | VERAGE TOTAL | 2,440m ² |
| | SITE AR | EA (INCL. BUILDIN | NG FOOTPRINT) | 14,074m ² |
| | | SITE C | ANOPY COVER | 41.6% |
| | | CANOPY C | COVER TARGET | 40% |
| | | | | |

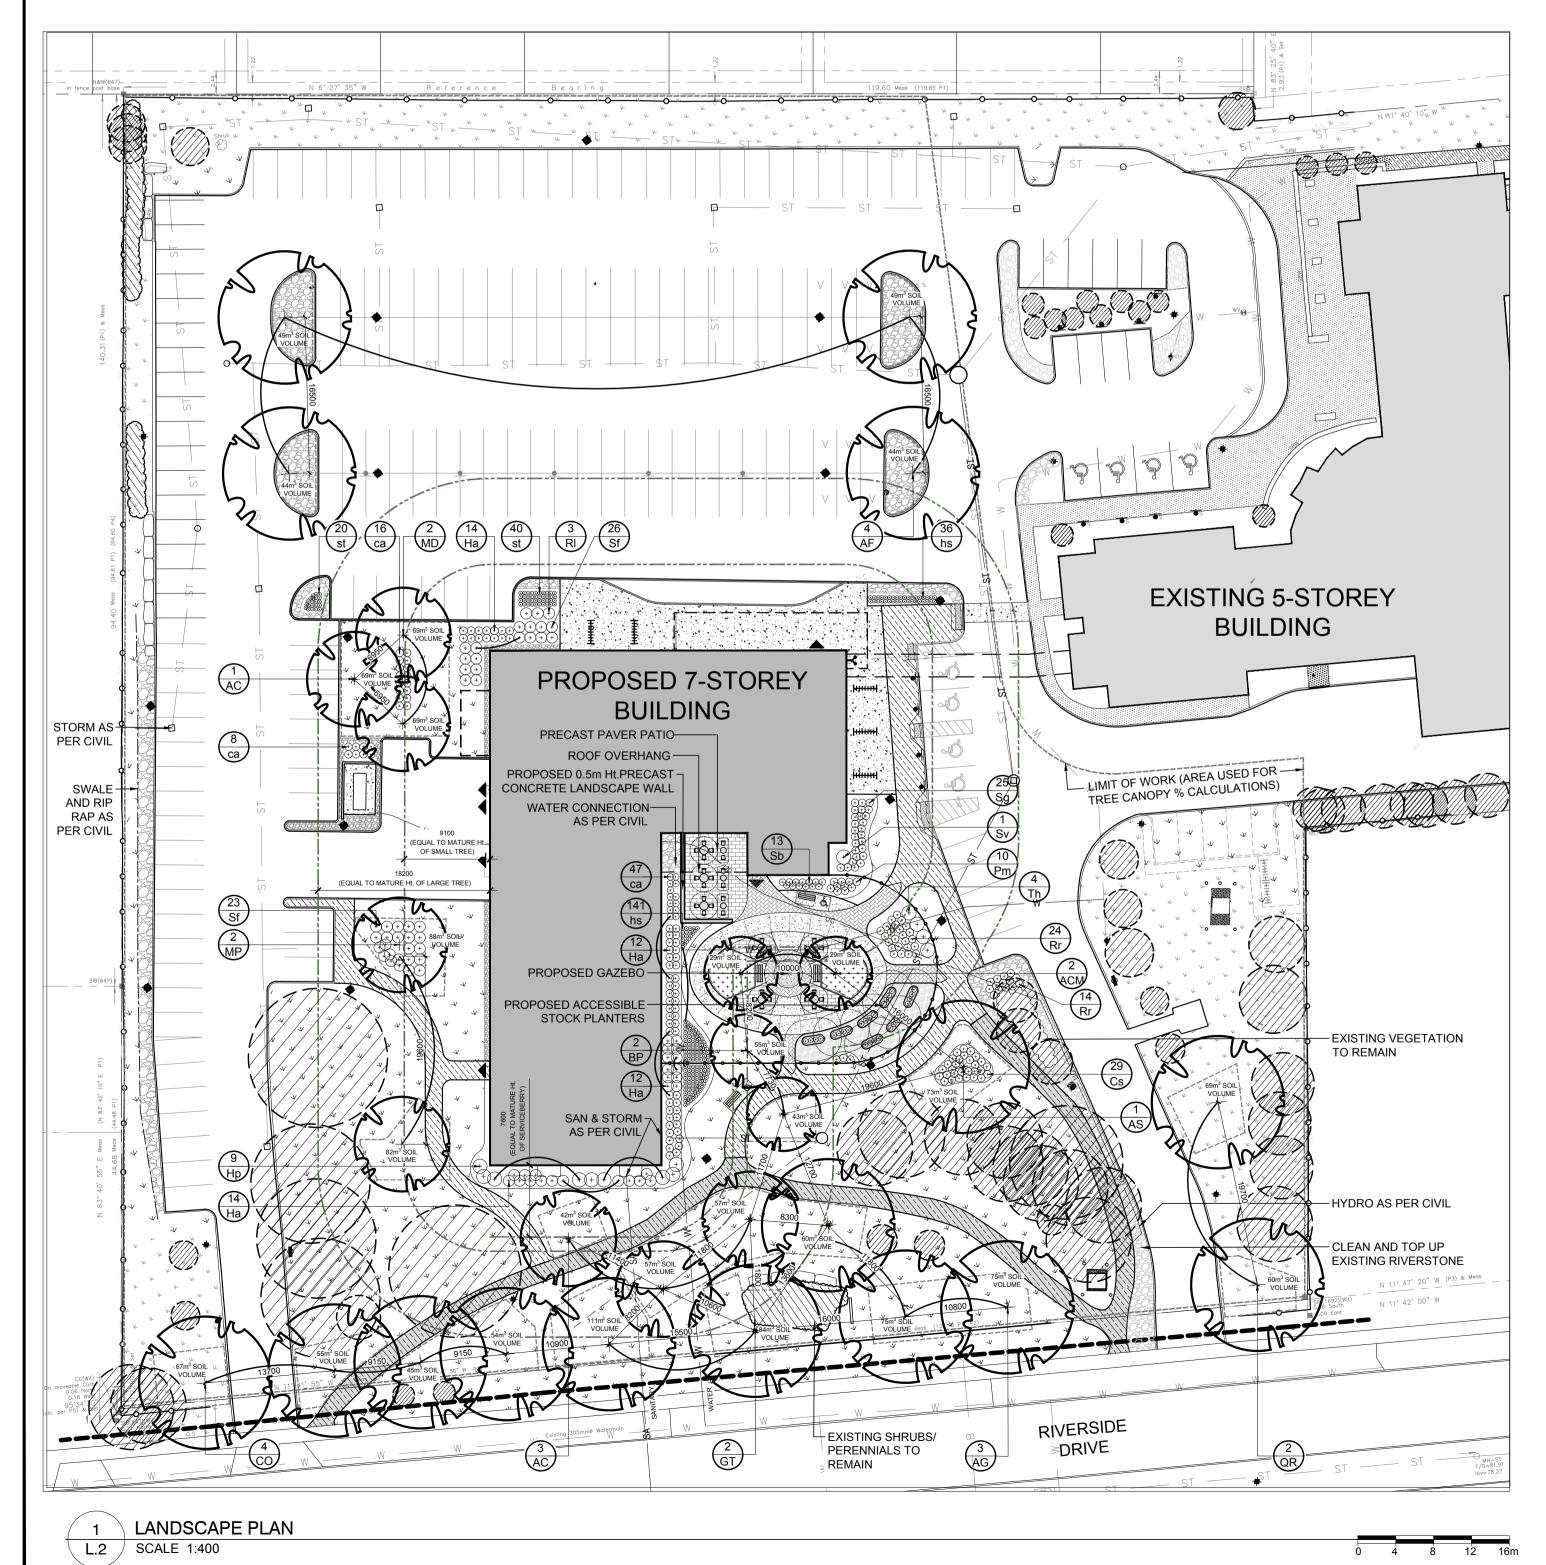


| ΚΕΥ | QTY | BOTANICAL NAME | COMMON NAME | SIZE | CONDITION | REMARKS |
|----------------|-------------|--|------------------------|-------------|-----------|--------------|
| HRUI | BS | | | | | |
| Cs | 29 | Cornus sericea | Red Osier Dogwood | 800mm ht. | Potted | 1200 mm o.c. |
| На | 60 | Hydrangea arborescens 'Annabelle' | Annabelle Hydrangea | 3 gal. pot | Potted | 800 mm o.c. |
| Ηр | 9 | Hydrangea paniculata 'Peegee' | Peegee Hydrangea | 1200mm ht. | Potted | 2000 mm o.c. |
| ² m | 10 | Pinus mugo 'Pumilio' | Dwarf Mugo Pine | 600mm spr. | Potted | 1200 mm o.c. |
| RI | 3 | Rhus typhina 'Laciniata' | Cutleaf Staghorn Sumac | 800mm ht. | Potted | 1200 mm o.c. |
| Rr | 38 | Rosa rugosa | Rugosa Rose | 800mm ht. | Potted | 800 mm o.c. |
| Sb | 13 | Spiraea x bumalda 'Anthony Waterer' | Anthony Waterer Spirea | 600mm ht. | Potted | 1000 mm o.c. |
| Sf | 39 | Spiraea japonica 'Froebelii' | Froebel's Spirea | 500 mm ht. | Potted | 800 mm o.c. |
| Sg | 25 | Spiraea x arguta | Garland Spirea | 800mm spr. | Potted | 1000 mm o.c. |
| Sv | 1 | Syringa vulgaris | Common Purple Lilac | 1200mm ht. | Potted | 1500 mm o.c. |
| Th | 4 | Taxus media 'Hicksii' | Hick's Yew | 1000 mm ht. | Potted | 1500 mm o.c. |
| EREN | \ NNIALS | <u> </u> | | | | |
| са | 71 | Calamagrostis x acutiflora 'Karl Foerster' | Karl Foerster Grass | 250mm pot | Potted | 800 mm o.c. |
| hs | 177 | Hemerocallis 'Stella D'Oro' | Stella D'Oro Day Lily | 1 gal pot | Potted | 300 mm o.c. |
| la | 148 | Leymus arenarius | Blue Lyme Grass | 1 gal pot | Potted | 300 mm o.c. |
| st | 60 | Sedum telephium 'Autumn Joy' | Autumn Joy Sedum | 150mm pot | Potted | 400 mm o.c. |

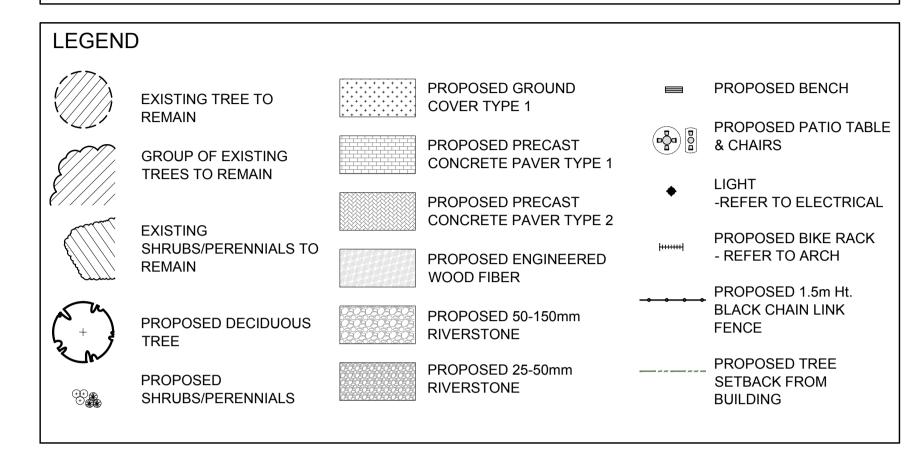

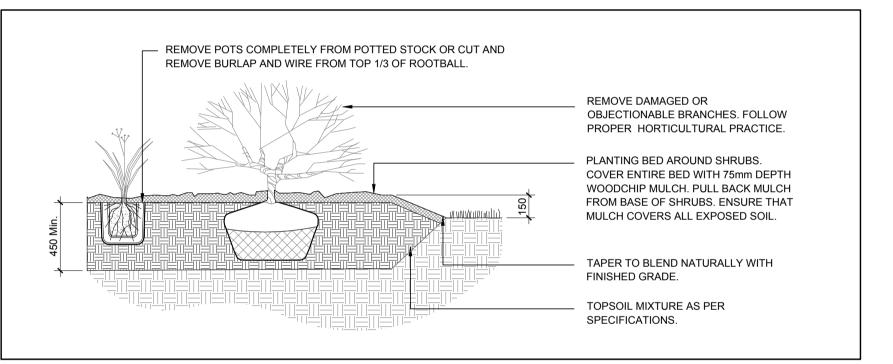


SHRUB / PERENNIAL PLANTING L.2 / SCALE: NTS

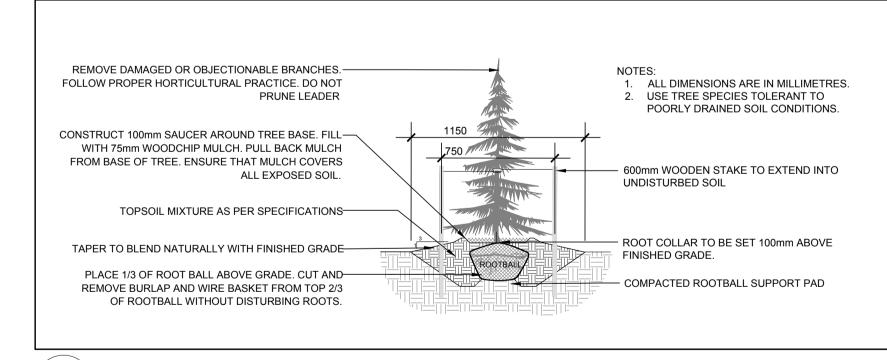

CONIFEROUS TREE PLANTING

SCALE: NTS L.2 /

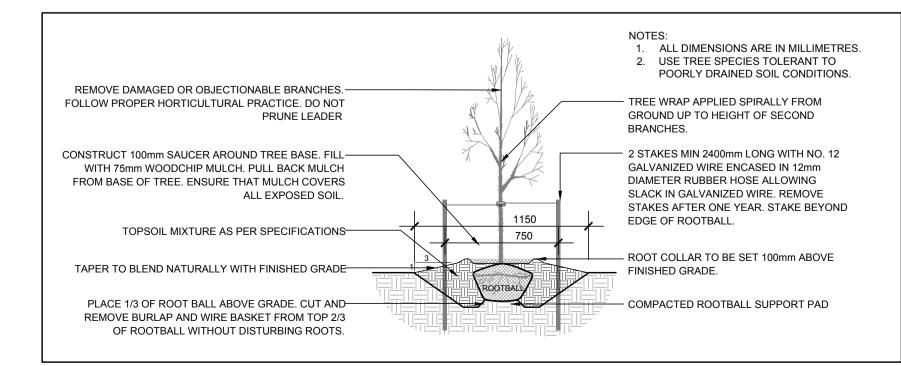

DECIDUOUS TREE PLANTING

SCALE: NTS

CONSULTANTS

& ASSOCIATES ARCHITECTS Inc. 171 Slater St, Suite 100, Ottawa, Ontario, K1P 5H7 Fax: (613) 236-1944 Telephone: (613) 236-7135 E-mail: info@cuhaci.com

St. Patrick's Home of Ottawa Inc.





WSP CANADA INC. 1224 GARDINERS ROAD, SUITE 201 KINGSTON, ONTARIO CANADA K7P 0G2 PHONE: 613-634-7373 WWW.WSP.COM

SURVEYORS:

FARLEY, SMITH & DENIS SURVEYING LTD. ONTARIO LAND SURVEYORS CANADA LANDS SURVEYORS 190 COLONNADE ROAD, OTTAWA, ONTARIO K2E 7J5

GENERAL NOTES:

- 1. IT IS THE RESPONSIBILITY OF THE APPROPRIATE CONTRACTOR OR OFFICIAL TO REPORT ANY ERRORS, OMISSIONS OR DISCREPANCIES ON THIS PLAN WITH ACTUAL SITE CONDITIONS TO THE LANDSCAPE ARCHITECT BEFORE PROCEEDING WITH CONSTRUCTION.
- 2. THE CONTRACTOR IS TO NOTIFY ALL UTILITY COMPANIES AND AUTHORITIES PRIOR TO ANY EXCAVATION AND ASCERTAIN LOCATIONS OF UNDERGROUND SERVICES.
- 3. THE CONTRACTOR IS TO REINSTATE ALL AREAS AND ITEMS DAMAGED AS A RESULT OF CONSTRUCTION ACTIVITY.
- 4. THE CONTRACTOR IS TO COMPLY WITH ALL PERTINENT CODES AND BY-LAWS.
- 5. THE CONTRACTOR IS TO MAINTAIN A POSITIVE SURFACE RUN-OFF THROUGHOUT THE ENTIRE CONSTRUCTION PERIOD.
- 6. THE LANDSCAPE ARCHITECT IS NOT RESPONSIBLE FOR SUBSURFACE CONDITIONS.
- REMAIN ON SITE WITH THE LANDSCAPE ARCHITECT PRIOR TO CONSTRUCTION.

7. THE CONTRACTOR IS TO IDENTIFY ALL EXISTING TREES TO

- 8. THE CONTRACTOR IS TO STAKE THE PROPOSED LOCATION OF ALL PLANT MATERIAL IN CONJUNCTION WITH THE LANDSCAPE ARCHITECT PRIOR TO EXCAVATION.
- 9. MINIMUM DISTANCES FOR SELECTED DECIDUOUS TREES ARE AS
- 9.1. BUILDING FOUNDATIONS REFER TO GEOTECH
- 9.2. SIDEWALKS 1.5M
- 9.3. PUBLIC STREETS 2.5M 9.4. UNDERGROUND INFRASTRUCTURE - 2.0M
- 10. ALL TREES WITHIN 1M OF UNDERGROUND UTILITY TRENCHES ARE TO BE EXCAVATED BY HAND.
- 11. REMOVE ALL PROTECTIVE WRAPPING FROM TREE TRUNKS AFTER INSTALLATION.
- 12. STAKING OF TREES SHALL ONLY BE PERFORMED IF NECESSARY.
- 13. ENSURE THAT MULCH IS PULLED BACK A MINIMUM DISTANCE OF 75MM FROM BASE OF TREE TRUNK.
- 14. THIS PLAN HAS BEEN DEVELOPED AS PER THE GEOTECHNICAL REPORT (NOVEMBER 2022, STANTEC CONSULTING


| 8 | ISSUED FOR FINAL SITE PLAN CONTROL | 07/08/2024 | WF | JL |
|-----|---|------------------|----|----|
| 7 | RESUBMISSION FOR SPC PHASE 3 PRE CONSULTATION | 04/26/2024 | WF | JL |
| 6 | ISSUED FOR COORDINATION | 04/05/2024 | WF | JL |
| 5 | ISSUED FOR DISCUSSION AND REVIEW | 04/04/2024 | WF | JL |
| 4 | ISSUED FOR DISCUSSION AND REVIEW | 03/22/2024 | WF | JL |
| 3 | ISSUED FOR SPA | 01/23/2024 | WF | JL |
| 2 | ISSUED FOR DISCUSSION AND REVIEW | 07/28/2023 | WF | JL |
| 1 | ISSUED FOR DISCUSSION AND REVIEW | 11/04/2022 | ML | JL |
| No. | Issue | Date MM/DD/YY | DR | СК |

JAMES B. LENNOX & ASSOCIATES INC. LANDSCAPE ARCHITECTS 3332 CARLING AVE. OTTAWA, ONTARIO Fax. 1(866) 343-3942

Tel. (613) 722-5168

ST. PATRICK'S SENIORS APARTMENTS 2865 RIVERSIDE DRIVE, OTTAWA ON

LANDSCAPE PLAN

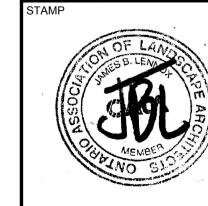

PROJECT NORTH

AS SHOWN

START DATE OCTOBER 2022

PROJECT NO. 23EJC2306

DRAWING NO.

