

Ruby Stella Daylily


**40 YEAR CANOPY CALCULATION:** 1. It is the responsibility of the appropriate contractor or official to report any errors, omissions or discrepancies on this plan with actual site conditions to the Landscape Architect before proceeding with construction. 895 m2 site area 2. The contractor is to notify all utility companies and authorities prior to any excavation and ascertain locations of underground services. 3. The contractor is to reinstate all areas and items damaged as a result of construction activity. (1) large tree proposed (154m2 ea.) 4. The contractor is to comply with all pertinent codes and by-laws. 5. The contractor is to maintain a positive surface run-off throughout the entire construction period. (1) medium tree proposed (79m2 ea.) 6. The Landscape Architect is not responsible for subsurface conditions. (3) large trees to remain (154m2 ea.) 7. The contractor is to identify all existing trees to remain on site with the Landscape Architect prior to construction. 8. The contractor is to stake the proposed location of all plant material in conjunction with the Landscape Architect prior to excavation. =695m2 canopy cover =77.6% canopy cover 9. Minimum distances for selected deciduous trees are as follows: Building Foundations 7.5m Sidewalks 1.5m


Potted


Space 400mm o.c.


\*Large trees calculated at 14m and medium at

100mm pot

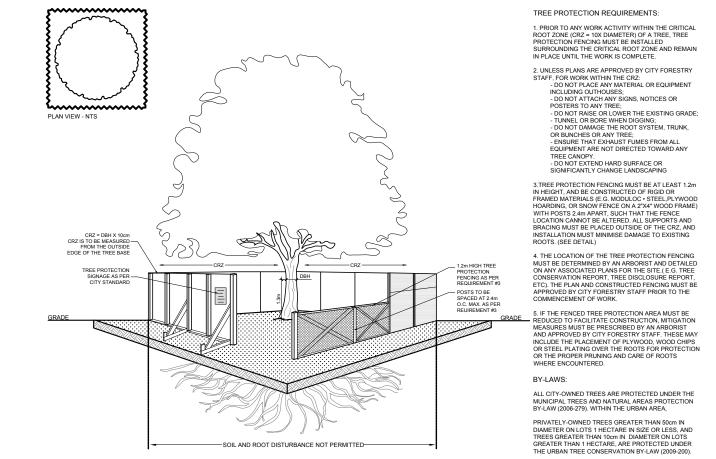

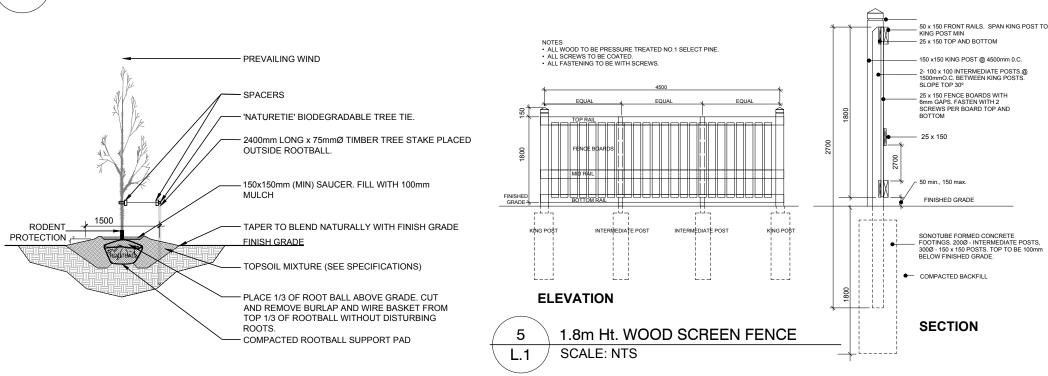

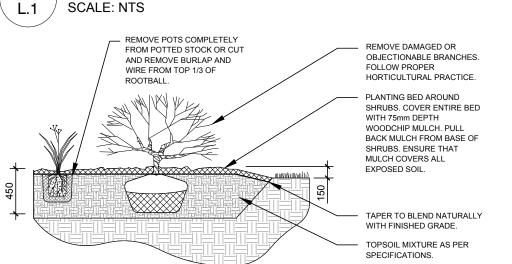

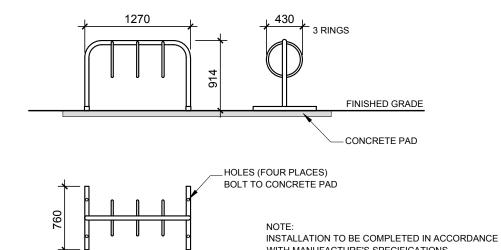

6 THREE RING BIKE RACK L.1 / SCALE: NTS

.. Richards & Associates Limited ENGINEERS · ARCHITECTS · PLANNERS

CIVIL ENGINEERS:

CONSULTANTS

EXISTING TREE TO REMAIN

SMART LIVING

PROPERTIES

GROUP OF EXISTING TREES TO REMAIN

EXISTING TREE TO BE REMOVED

SOIL VOLUME REQUIRED PROPOSED DECIDUOUS TREE

PROPOSED SHRUBS / PERENNIALS

PROPOSED SOD

PROPOSED RIVERSTONE MULCH

PROPOSED PRECAST CONCRETE **PAVERS** 

PROPOSED TREE PROTECTION FENCE

PROPOSED 1.8m Ht. WOOD SCREEN FENCE

> PROPOSED LIGHT STANARDS (REFER TO SITE PLAN FOR DETAILS)

7	REVISED PER NEW SITE PLAN	02/15/2024	ML	JL
6	REVISED PER SITE PLAN REVISIONS	11/29/2023	ML	JL
5	ISSUED FOR BUILDING PERMIT	03/31/2023	ML	JL
4	REVISED PER NEW SITE PLAN	04/29/2022	ML	JL
3	REVISED PER NEW SITE PLAN	03/21/2022	ML	JL
2	REVISED PER CITY COMMENTS	11/16/2021	ML	JL
1	ISSUED FOR SITE PLAN CONTROL	07/29/2021	ML	JL
No	legue	Date	חח	CK


JAMES B. LENNOX & ASSOCIATES INC. LANDSCAPE 3332 CARLING AVE. OTTAWA, ONTARIO Tel. (613) 722-5168 Fax. 1(866) 343-3942

NEW ADDITION TO EXISTING 6 STOREY BUILDING

280 LAURIER AVENUE EAST, OTTAWA ON

TREE CONSERVATION REPORT &

LANDSCAPE PLAN

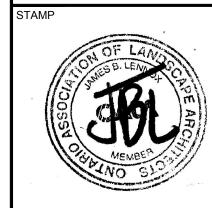

PROJECT NORTH

PROJECT NO. 21SMT2162 DRAWING NO.

SCALE

AS SHOWN

START DATE

JULY 2021

