

SAN STRUCTURE TABLE				
NAME	RIM ELEV.	INVERT IN	INVERT OUT	DESCRIPTION
MH1A	84.47	NW81.820	SW81.760	STRUC OPSPD 701.010 FRAME CITY S25 COVER CITY S24
MH1B	84.50	NW81.141	SE81.090	STRUC OPSPD 701.010 FRAME CITY S25 COVER CITY S24
MH1C	84.78	S81.180 NW80.990	E80.921	STRUC OPSPD 701.010 FRAME CITY S25 COVER CITY S24
MH1D	84.20	W80.640 SE80.650	NW80.582	STRUC OPSPD 701.011 FRAME CITY S25 COVER CITY S24
MHSA46203	84.24	NE81.690 SW81.360	SE81.350	EXISTING MH
MHSA46208	85.10	S81.280 SW81.300	N81.270	EXISTING MH
MHSA50442	84.30	SE80.510	N80.500	EX.MH



LEGEND	
DC	BARRIER CURB & CURB DEPRESSION
PROPOSED CONCRETE SIDEWALK/WALKWAY	PROPOSED ELEVATION EXISTING ELEVATION
SMH#	STORM MANHOLE
CB	CATCH-BASIN CURB INLET OR DITCH INLET
MH#A	SANITARY MANHOLE
---	PROPERTY LINE
WV	WATER VALVE/CHAMBER
FH	FIRE HYDRANT
---	PROPOSED WALL
---	PROPOSED FIRE DEPARTMENT CONNECTION
W	PROPOSED WATER METER AND REMOTE METER
SC	SEDIMENT CONTROL DEVICE PER DETAIL
CO	CURB OPENING PER OPSPD 604.010
ST	EXISTING STORM SEWER
SAN	EXISTING SAN SEWER
---	PROPOSED WATERMAIN/SERVICE
---	PROPOSED SAN SEWER/SERVICE
---	PROPOSED STM SEWER/SERVICE
---	PROPOSED PERFORATED STM SEWER/SERVICE
---	SLOPING AT 3:1 UNLESS SPECIFIED
---	PROPOSED ELEVATION EXISTING ELEVATION
---	SWALE ELEVATION
---	TOP/BOTTOM WALL FACE ELEVATIONS
---	PROPOSED EMERGENCY OVERLAND FLOW ROUTE EXISTING DRAINAGE PATTERN
---	HEAVY DUTY SILT FENCE BARRIER PER OPSPD 219.130
---	BUILDING ENTRANCE
---	TWSP PER SC7.1
---	CENTRELINE OF SWALE
---	PROPOSED ROAD CUT AND REINSTATEMENT PER CITY RID
---	TEMPORARY CONSTRUCTION MUD MAT PER DETAIL
---	EXISTING HYDRO LINE
---	EXISTING OHW
---	EXISTING GAS LINE
---	EXISTING BELL SERVICE

**SUBJECT TO APPROVAL**

No.	Revisions	Date
2	ISSUED FOR SPC AND MUNICIPAL CONSENT	MAY 17, 2024
1	ISSUED FOR SITE PLAN CONTROL	SEPT 25, 2023

Check and verify all dimensions before proceeding with the work. Do not scale drawings.



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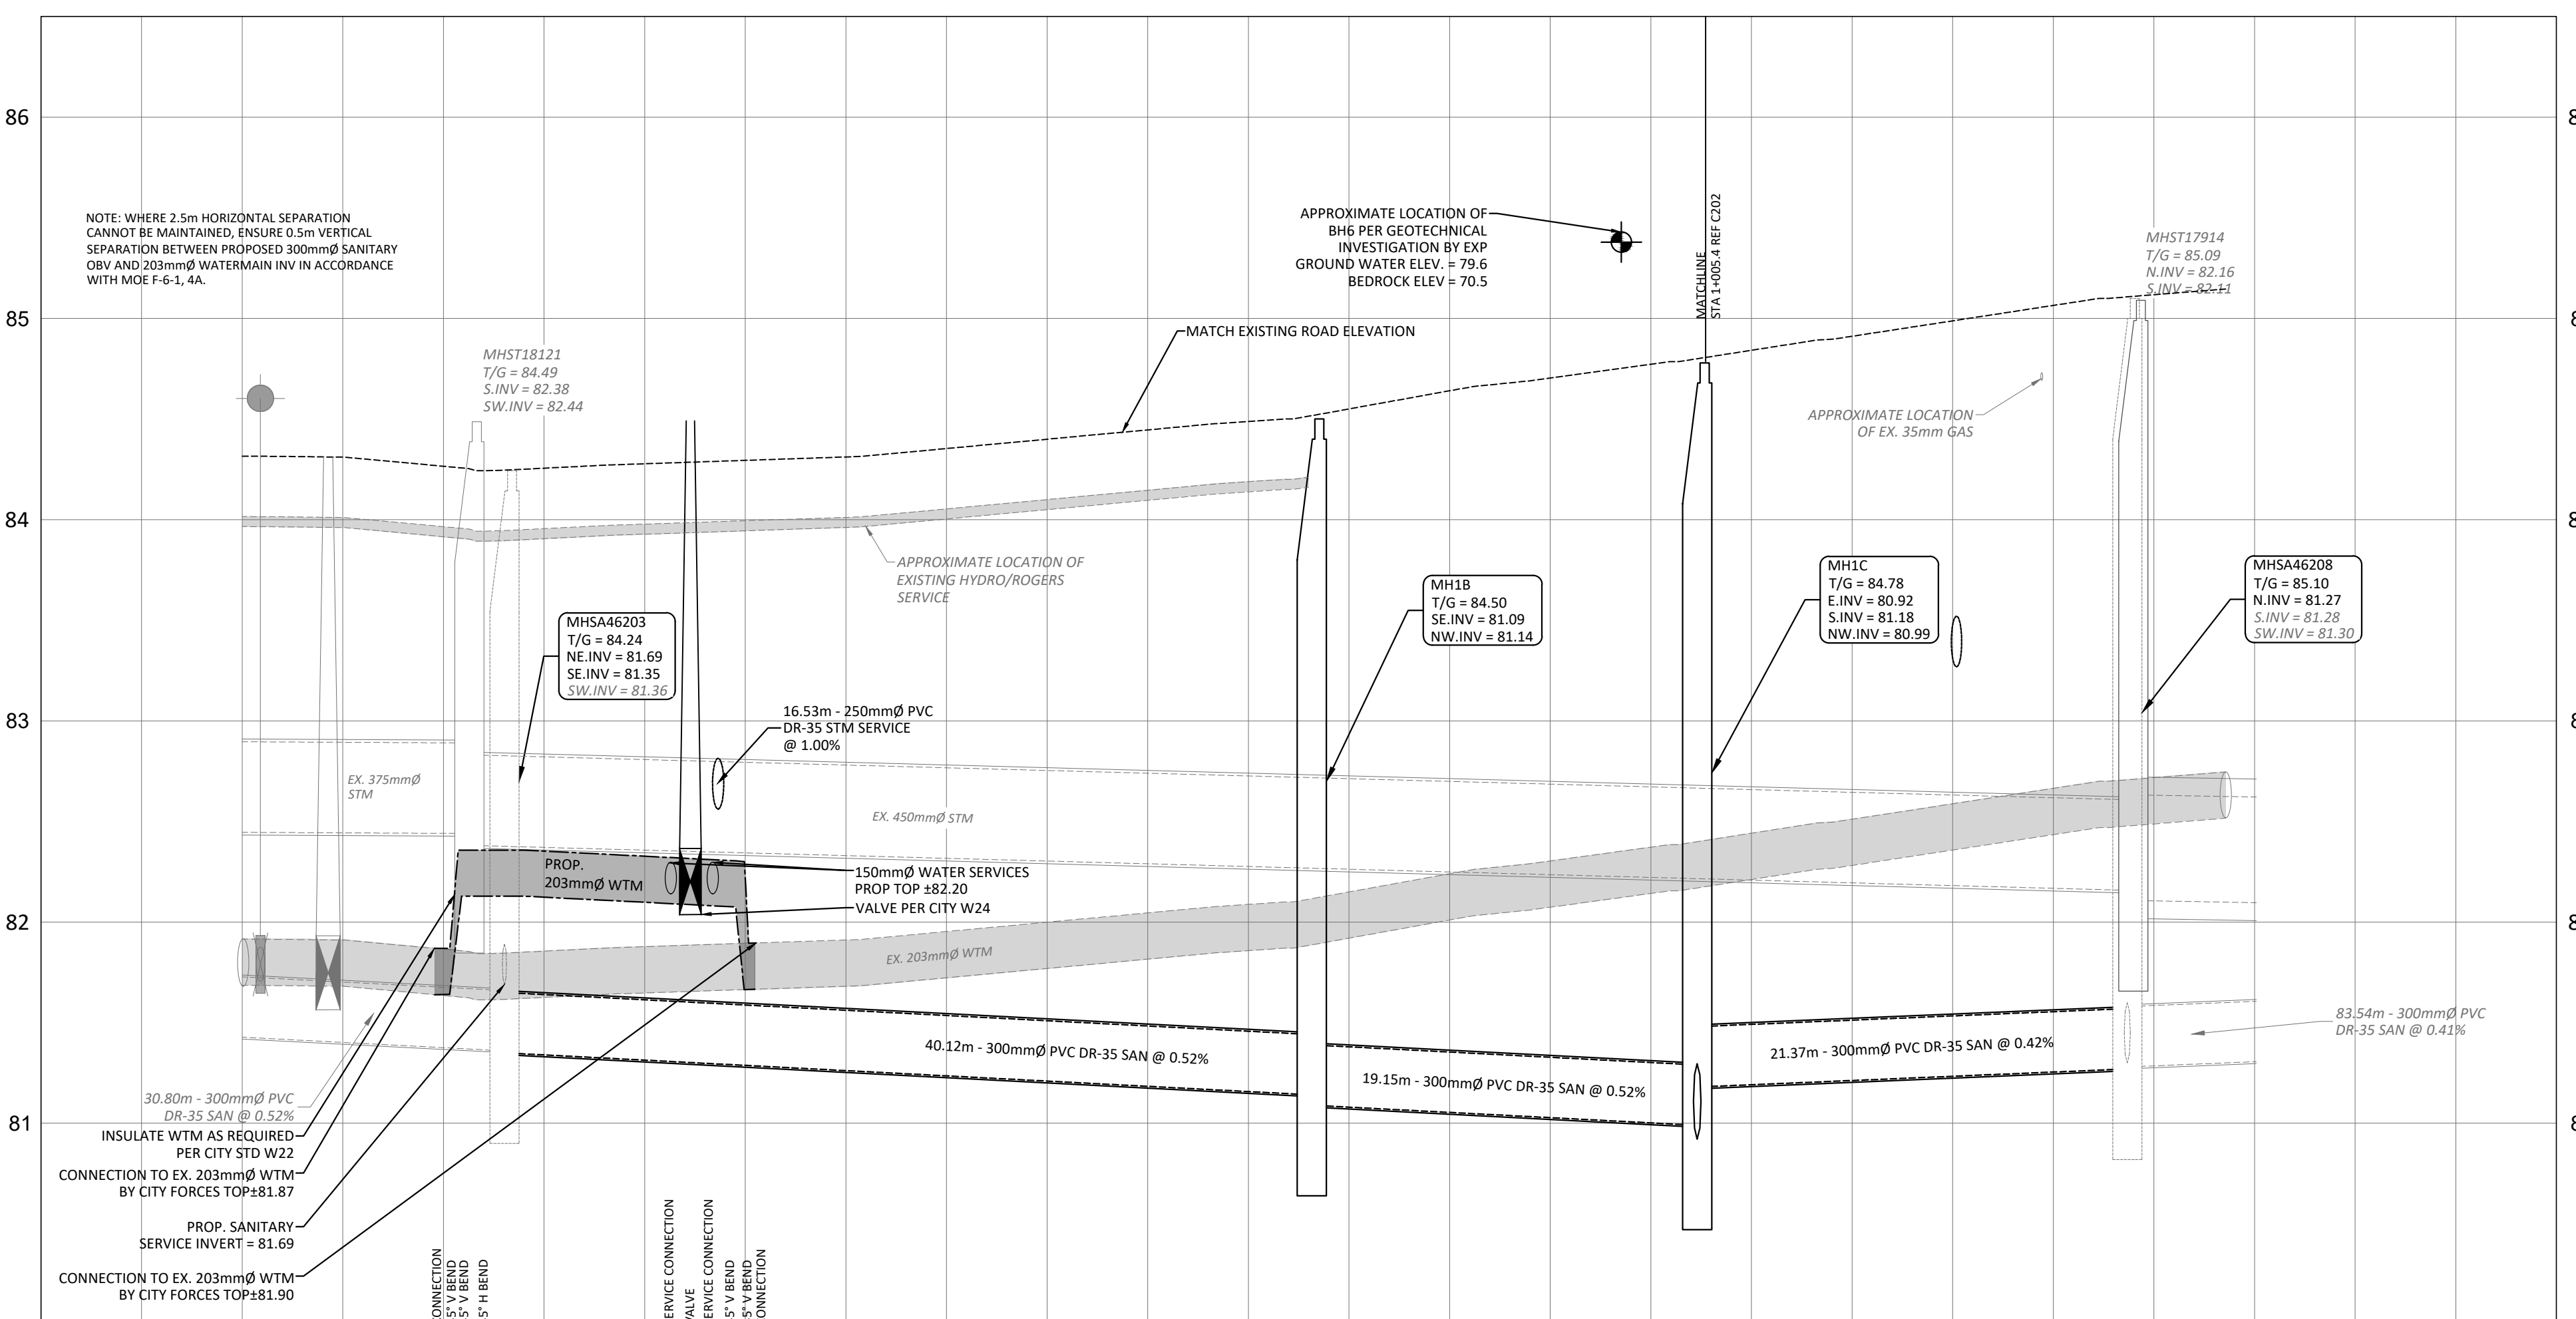
Stamp:

Client: **THEBERGE DEVELOPMENTS LTD.**  
 1600 LAPERRIERE AVE  
 OTTAWA, ON K1Z 8P5

Project: **780 BASELINE - PHASE 1**  
 OTTAWA ON

Drawing Title: **PLAN AND PROFILE STA 0+000 TO 0+100**

Scale: 1:250	Project Number: CCO-22-0952
Drawn By: R.R.R.	Checked By: A.M.
Designed By: R.R.R.	Drawing Number: C201



STATION	EXISTING ELEVATIONS	PROPOSED ELEVATIONS	DESCRIPTION
0+000	84.32 84.32	84.27 84.27	
0+007	81.87 82.36 82.36	81.35 81.35	30.80m - 300mm PVC DR-35 SAN @ 0.52%
0+010	81.87 82.36 82.36	81.35 81.35	
0+012	81.87 82.36 82.36	81.35 81.35	
0+020	84.27 84.27	84.27 84.27	
0+021	82.32 82.32	82.32 82.32	
0+023	82.31 82.31	82.31 82.31	
0+024	82.31 82.31	82.31 82.31	
0+025	82.31 82.31	82.31 82.31	
0+026	82.31 82.31	82.31 82.31	
0+040	84.38 84.38	84.38 84.38	
0+060	84.65 84.65	84.65 84.65	
0+072	84.89 84.89	84.89 84.89	
0+080	85.14 85.14	85.14 85.14	
0+100	85.14 85.14	85.14 85.14	
0+115			

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