

2023079 Innes Road - Electrical Drawing List

INNES ROAD, OTTAWA, ONTARIO

DESCRIPTION	DRAWING NO.	SHEET NO.
Electrical Cover Page	E0.0	1
Electrical Legend, Single Line Diagram, Schedules & Details	E0.1	2
Electrical Site Lighting Photometrics	E1.0	3
Electrical Site Lighting Plan	E1.1	4



Edmonton, AB T5J 3N9 info@designworkseng.com www.designworkseng.com DESIGN WORKS ENGINEERING LTD.

WITHOUT THE DIRECT WRITTEN PERMISSION OF DESIGN WORKS

THIS DRAWING IS NOT TO BE USED FOR CONSTRUCTION UNLESS IT IS SIGNED AND SEALED, AND DRAWINGS HAVE BEEN ISSUED FOR CONSTRUCTION IN THE TABLE BELOW.

DO NOT SCALE THIS DRAWING.

No.	Description	Date
1	ISSUED FOR REVIEW 30%	2023-05-30
2	ISSUED FOR REVIEW 50%	2023-07-28
3	ISSUED FOR REVIEW 75%	2024-01-03
4	ISSUED FOR SPA REV.2	2024-02-22



DRAWN BY: ACF CHECKED BY: SHERRY KALDAS MOSES NORGA, P.ENG. PROJECT #: 2023079 AS NOTED

Innes Road


INNES ROAD, OTTAWA, ONTARIO

Electrical Cover Page


E0.0

ELECTRICAL SYMBOL LEGENDS

SURFACE CEILING MOUNTED LUMINAIRE SURFACE CEILING MOUNTED EMERGENCY POWERED LUMINAIRE RECESSED CEILING MOUNTED LED DOWNLIGHT RECESSED CEILING MOUNTED EMERGENCY POWERED LUMINAIRE SUSPENDED CEILING MOUNTED LUMINAIRE	
RECESSED CEILING MOUNTED LED DOWNLIGHT RECESSED CEILING MOUNTED EMERGENCY POWERED LUMINAIRE	
RECESSED CEILING MOUNTED EMERGENCY POWERED LUMINAIRE	
SUSPENDED CEILING MOLINTED LUMINAIRE	
) GOOD ENDED CEILING MOONTED COMMINANCE	
SUSPENDED CEILING MOUNTED EMERGENCY POWERED LUMINAIRE	
WALL MOUNTED LUMINAIRE	
WALL MOUNTED EMERGENCY POWERED LUMINAIRE	
SURFACE OR SUSPENDED MOUNTED LUMINAIRE	
SURFACE OR SUSPENDED MOUNTED EMERGENCY POWERED LUMINAIRE	
RECESSED MOUNTED LUMINAIRE	
TRACK TYPE LUMINAIRE (REERE TO FIXTURE SCHEDULE FOR HEAD COUNTS AND TRACK LENGTHS)	
POLE MOUNTED LUMINAIRE (QUANTITY OF HEADS AS SHOWN ON PLAN)	
BOLLARD TYPE LUMINAIRE	
SINGLE POLE SWITCH	
THREE WAY OR FOUR WAY SWITCH	
KEY-OPERATED SWITCH	
DIMMER SWITCH	
SWITCH C/W VACANCY SENSOR	
DIMMER SWITCH C/W VACANCY SENSOR	
Switch C/W OCCUPANCY SENSOR	
TIMER SWITCH	
OCCUPANCY SENSOR - CEILING MOUNTED (PROVIDE TYPE SUIT COVERAGE)	
VACANCY SENSOR - CEILING MOUNTED (PROVIDE TYPE SUIT COVERAGE)	
TIMECLOCK CONTROLLER	
PHOTOCELL CONTROLLER	

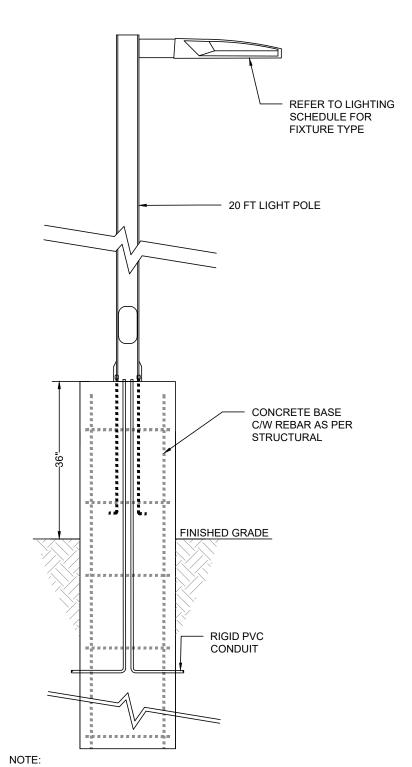

REFER TO STRUCTURAL DRAWINGS FOR STRUCTURAL REINFORCING AND ALL DIMENSIONS RELATED TO THE CONCRETE

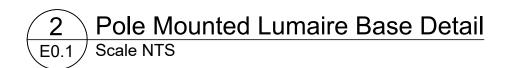



	LUMINAIRES	CROSSTOUR WALL MOUNT LED
	LAMP LED, 4000K	
	LUMENS	6037 LM
	BALLAST	LED DRIVER
	HOUSING	•
	LENS	•
INPUT WATTAGE 58 W		58 W
MOUNTING EXTERIOR		EXTERIOR WALL SURFACE
	SPECIAL REQUIREMENTS	-
	ACCEPTABLE PRODUCTS	LUMARK - XTOR6B-W (OR APPROVED EQUIVALENT)
	LUMINAIRE TYPE	104



	LUMINAIRES	GALLEON AREA AND ROADWAY LUMINAIRE
	LAMP	LED, 4000K
	LUMENS	14372 LM
	BALLAST	-
	HOUSING	-
	LENS	-
	INPUT WATTAGE	113 W
	MOUNTING	20FT POLE
	SPECIAL REQUIREMENTS	-
	ACCEPTABLE PRODUCTS	McGRAW-EDISON - GLEON-SA2C-740-U-T4W (OR APPROVED EQUIVALENT)
	LUMINAIRE TYPE	110



LUMINAIRES CROSSTOUR WALL MC		CROSSTOUR WALL MOUNT LED
LAMP		LED, 5000K
	LUMENS	2134 LM
	BALLAST	LED DRIVER
	HOUSING	•
	LENS	-
	INPUT WATTAGE	18.2 W
	MOUNTING	EXTERIOR WALL SURFACE
	SPECIAL REQUIREMENTS	-
	ACCEPTABLE PRODUCTS	LUMARK - XTOR2B (OR APPROVED EQUIVALENT)
	LUMINAIRE TYPE	111



	LUMINAIRES	GALLEON AREA AND ROADWAY LUMINAIRE
	LAMP	LED, 4000K
	LUMENS	10490 LM
	BALLAST	-
	HOUSING	-
	LENS	-
	INPUT WATTAGE	113 W
ı	MOUNTING	20FT POLE
	SPECIAL REQUIREMENTS	-
	ACCEPTABLE PRODUCTS	McGRAW-EDISON - GLEON-SA2C-740-U-T4W-HSS (OR APPROVED EQUIVALENT)
	LUMINAIRE TYPE	114





P: 780 244 0252 F: 780 244 0252
Suite 1250 10130 103 St NW
Edmonton, AB T5J 3N9
info@designworkseng.com
www.designworkseng.com

COPYRIGHT 2024
DESIGN WORKS ENGINEERING LTD.

COPYRIGHT RESERVED

THESE DRAWINGS AND DESIGN ARE THE EXCLUSIVE PROPERTY OF DESIGN WORKS ENGINEERING LTD.
AND MAY NOT BE REPRODUCED IN ANY WAY OR FORM WITHOUT THE DIRECT WRITTEN PERMISSION OF DESIGN WORKS ENGINEERING LTD.

NOTES


THIS DRAWING IS NOT TO BE USED FOR CONSTRUCTION UNLESS IT IS SIGNED AND SEALED, AND DRAWINGS HAVE BEEN ISSUED FOR CONSTRUCTION IN THE TABLE BELOW.

DO NOT SCALE THIS DRAWING.

No.	Description	Date
1	ISSUED FOR REVIEW 30%	2023-05-30
2	ISSUED FOR REVIEW 50%	2023-07-28
3	ISSUED FOR REVIEW 75%	2024-01-03
4	ISSUED FOR SPA REV.2	2024-02-22

ARCHITECT

CLIENT

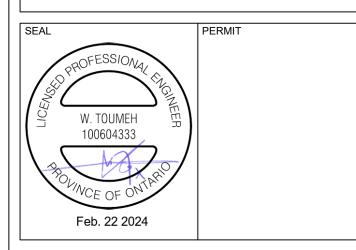

DRAWN BY: ACF

CHECKED BY: SHERRY KALDAS

ENGINEER: MOSES NORGA, P.ENG.

PROJECT #: 2023079

SCALE: AS NOTED

PROJECT

Innes Road


INNES ROAD, OTTAWA, ONTARIO

DESCRIPTION

Electrical Legend,
Single Line Diagram,
Schedules & Details

E0.1

SHEET 2

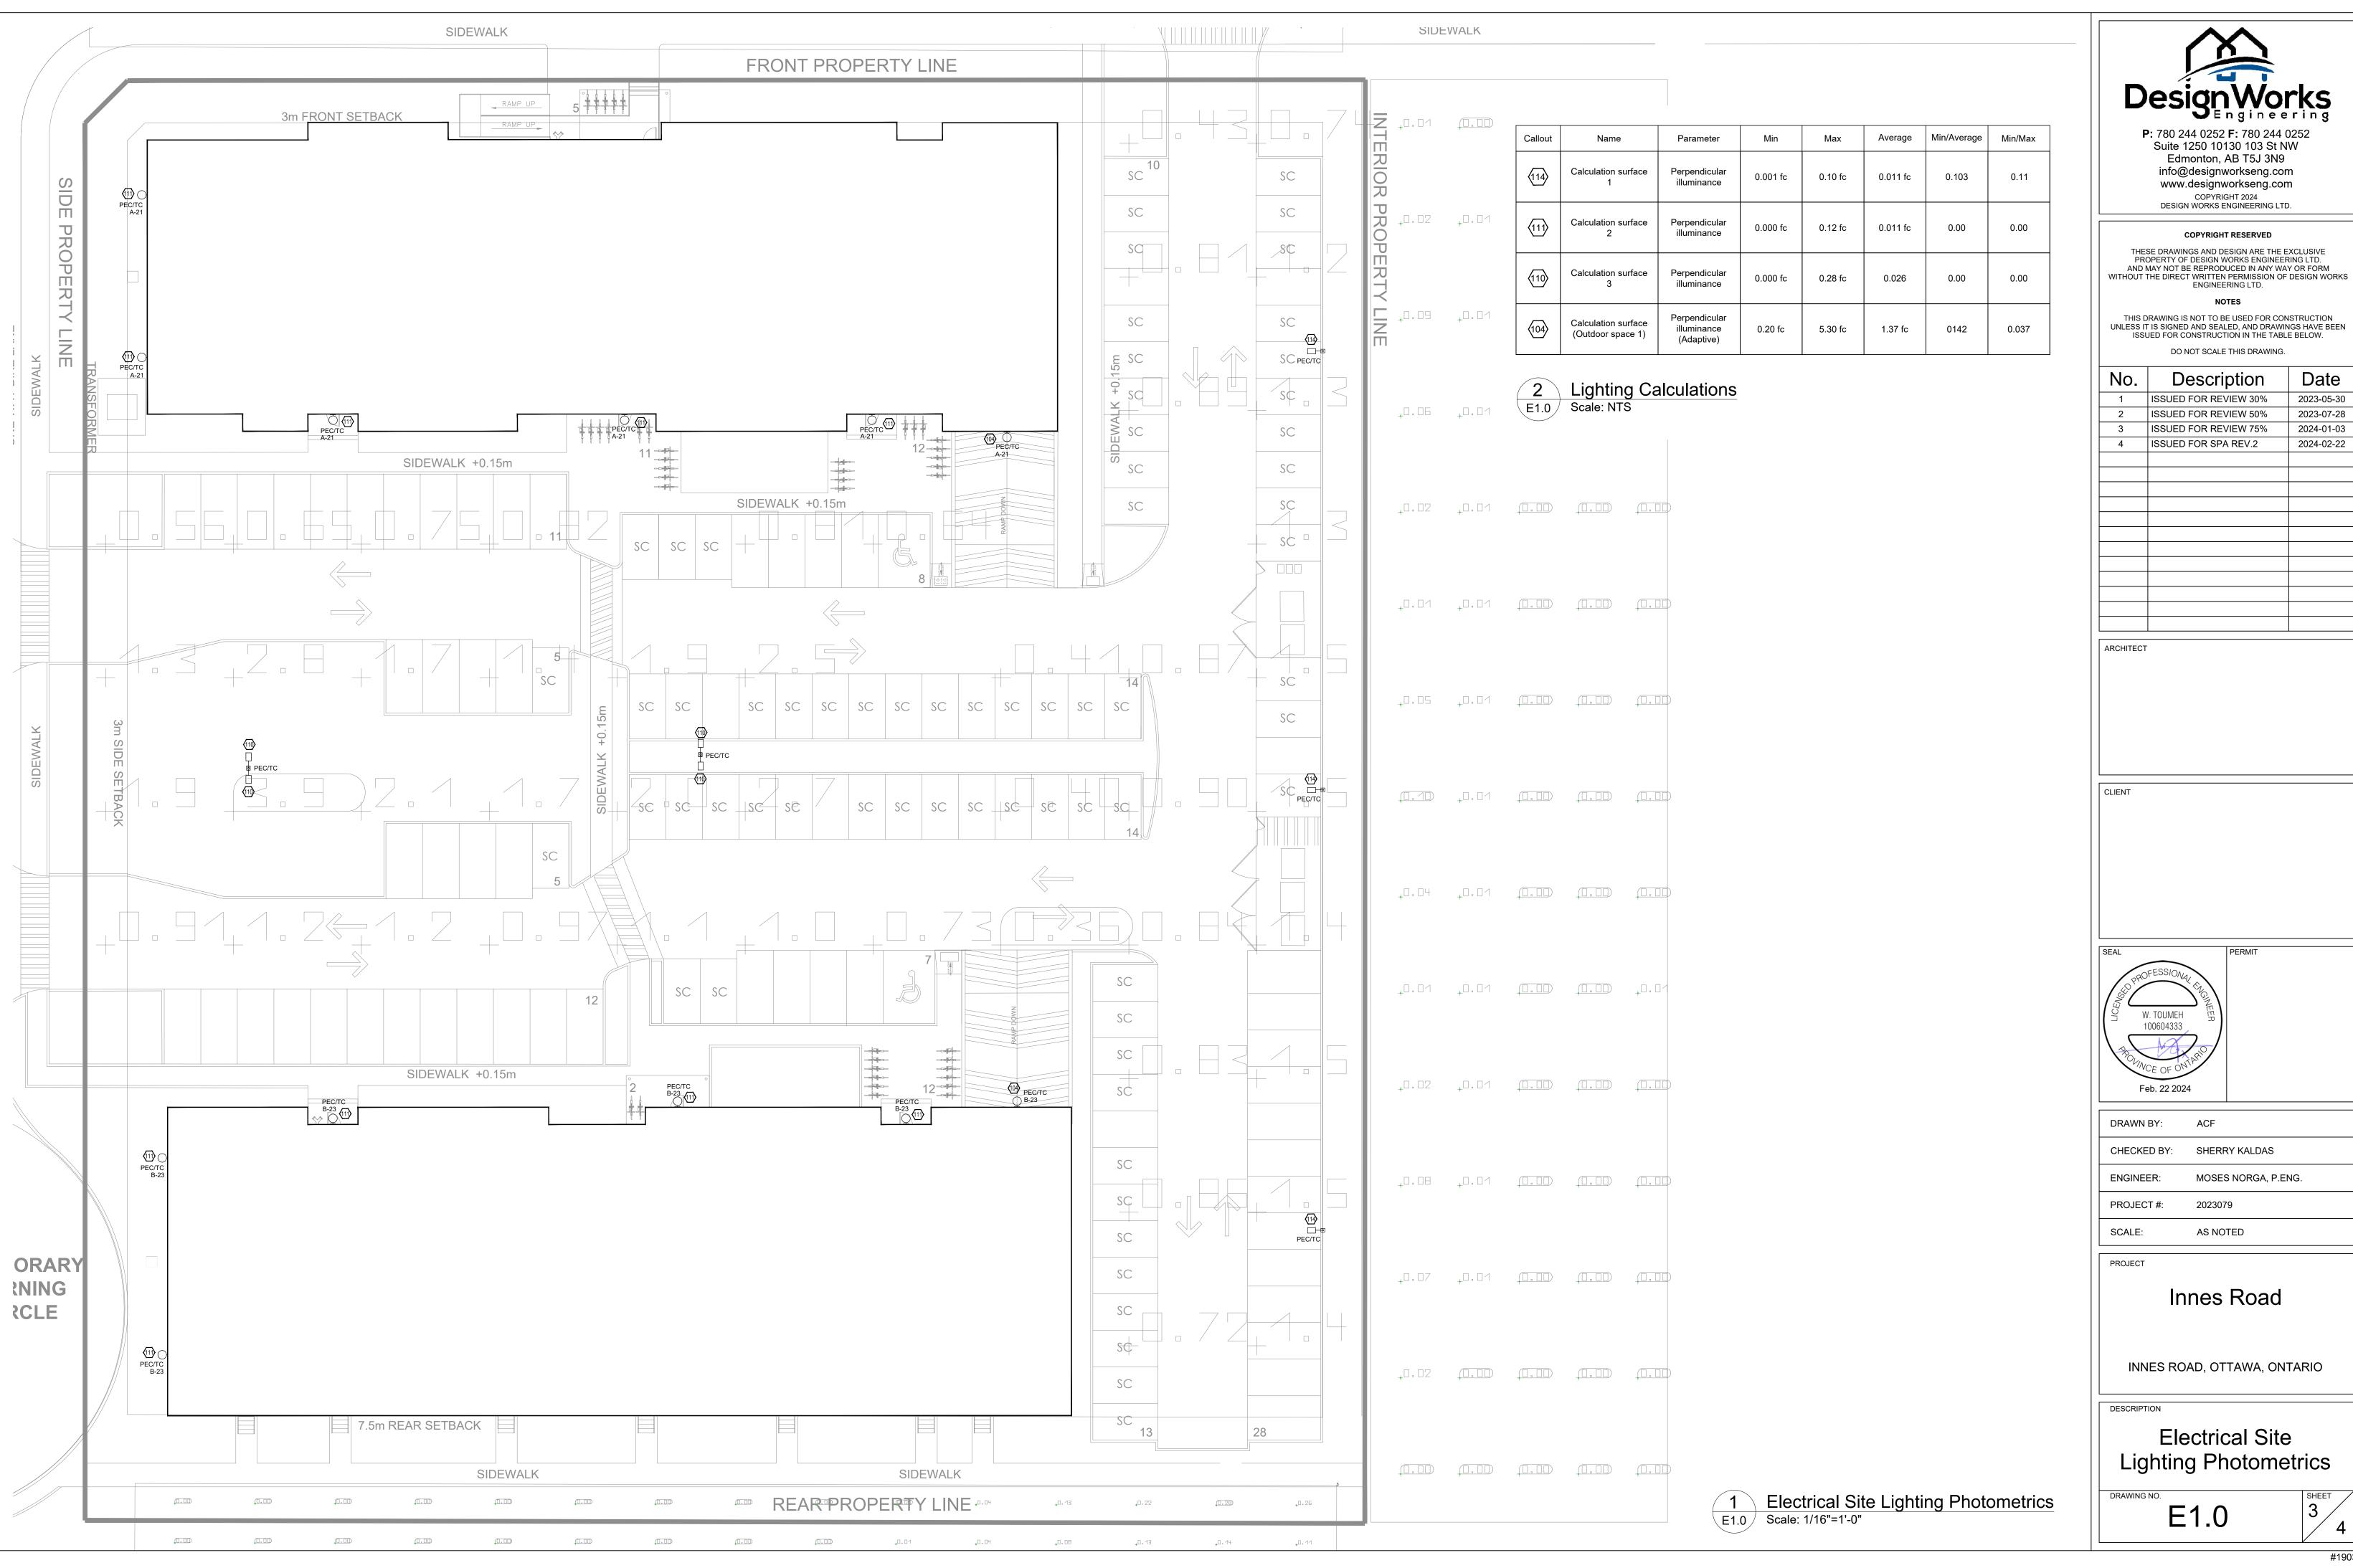

No.	Description	Date
1	ISSUED FOR REVIEW 30%	2023-05-30
2	ISSUED FOR REVIEW 50%	2023-07-28
3	ISSUED FOR REVIEW 75%	2024-01-03
4	ISSUED FOR SPA REV.2	2024-02-22

