

EXISTING CATCHBASIN MANHOLE

EXISTING LIGHT STANDARD TO BE REMOVED

EXISTING ELEVATION

REFER TO ELECTRICAL

WETLAND AREA

RE-ISSUED FOR CITY REVIEW 2024.01.12 —— SA —— NEW SANITARY SEWER RE-ISSUED FOR CITY REVIEW 2023.10.25 — ST — NEW STORM SEWER 2023.08.18 ISSUED FOR TENDER — W — NEW WATERMAIN 2023.08.15 99% DESIGN REVIEW LIMIT OF EXISTING WETLAND 90% DESIGN REVIEW 2022.12.21 66% DESIGN REVIEW _____ 1m BUFFER FOR WETLAND 2021.11.08 33% DESIGN REVIEW R2 **EXISTING NUMBER OF PARKING STALLS** 33% DESIGN REVIEW R1 2021.10.08 EXISTING CATCHBASIN 33% DESIGN REVIEW 01 2020.12.07

KEY PLAN

Orientation

The Contractor shall check and verify all dimensions and report all errors and omissions to the IO-Ówner's/MBS Designee (as applicable) for his/her written direction before proceeding with the Work.

AREA OF WORK



Revisions

B Sheet No where detailed

PROJECT ENGINEER: CIVIL, STRUCTURAL, MECHANICAL & ELECTRICAL



Jp2g Consultants Inc. 1150 MORRISON DRIVE, SUITE 410, OTTAWA, ON K2H 8S9 PHONE: 613-828-7800 FAX: 613-828-2600

GENERAL NOTES

- DESIGN AND CONSTRUCTION IS TO BE IN ACCORDANCE WITH MOST
- THE CONTRACTOR IS RESPONSIBLE FOR CHECKING AND VERIFYING ALL DIMENSIONS WITH RESPECT TO SITE CONDITIONS AND ALL MATERIALS TO THE PROJECT. ANY DISCREPANCY SHALL BE REPORTED TO THE
- THIS DRAWING IS TO BE READ IN CONJUNCTION WITH ALL MATERIAL
- ADDITIONAL DRAWINGS MAY BE ISSUED FOR CLARIFICATION TO ASSIST PROPER EXECUTION OF WORK. SUCH DRAWINGS WILL HAVE THE SAME MEANING AND INTENT AS IF THEY WERE INCLUDED WITH THE CONTRACT
- CONTRACTOR MUST COMPLY WITH LOCAL BY-LAWS, ONTARIO OCCUPATIONAL HEALTH AND SAFETY ACT AND ALL REGULATIONS SET BY AUTHORITIES HAVING JURISDICTION. IN CASE OF CONFLICT OR DISCREPANCY, THE MORE STRINGENT REQUIREMENTS SHALL APPLY.
- CONTRACTOR RESPONSIBLE FOR OBTAINING ALL REQUIRED UTILITY LOCATES, DAYLIGHTING, INSPECTIONS, PERMITS, AND APPROVALS, INCLUDING ALL ASSOCIATED COSTS. LOCATION OF EXISTING UTILITIES ARE APPROXIMATE ONLY AND BASED ON BEST AVAILABLE INFORMATION.
- PROPERTY BOUNDARY INFORMATION IS DERIVED FROM THE PLAN RECEIVED FROM OCDC PREPARED BY ONTARIO REALTY CORPORATION NOVEMBER 2021 BASED ON INFORMATION OBTAINED FROM PLAN OF PART OF LOT 17 CONCESSION 3 (OTTAWA FRONT) TWP. OF GLOUCESTER, NOW IN THE CITY OF GLOUCETSER REGIONAL MUNICIPALITY OF OTTAWA-CARLETON DATED FEB 22, 1999 PREPARED BY D.A. SIMMONS OLS WEBSTER AND SIMMON'S SURVEYING LTD, OTTAWA.

GEOTECHNICAL NOTES

- GEOTECHNICAL ENGINEER LICENSED IN THE PROVINCE OF ONTARIO SHALL INSPECT ALL SUBGRADE SURFACES FOR FOOTING AND PAVEMENT STRUCTURES PRIOR TO CONSTRUCTION.
- CONTRACTOR TO IMPLEMENT A MONITORING PROGRAM FOR VIBRATIONS TO BE OVERSEEN BY A PROFESSIONAL GEOTECHNICAL ENGINEER. CONTRACTOR TO ALLOW IN HIS BID A UNIT RATE FOR STATIC COMPACTION SHOULD VIBRATION MONITORING REQUIRES THE GEOTECHNICAL ENGINEER TO INSTRUCT THE USAGE OF STATIC COMPACTION METHODS.
- CONTRACTOR TO AVOID DIRECTING WATER TOWARDS THE TOP OR BOTTOM OF THE RAVINE SLOPE, BOTH DURING CONSTRUCTION AND AFTER COMPLETION. THE EXISTING CREEK CANNOT HANDLE ANY ADDITIONAL FLOW OR VOLUME, AND THE PROPOSED DRAINAGE PLAN SHOULD AIM TO MINIMIZE AND CONTROL ANY IMPACTS IN THIS REGARD.



OTTAWA CARLETON DETENTION CENTRE TEMPORARY PARKING LOT EXPANSION

10 Project No

Drawing Title EXISTING CONDITIONS

Scale AS NOTED	Date DECEMBER 2022
Drawn by R.W.	Substantial Performance Date —
Designed by D.N. Approved by	Drawing No of
	CADD File NAME -



Innes Road



PARKING AND DRIVE AISLE PROVISIONS UNDER PART4-PARKING, QUEUING AND LOADING PROVISIONS (SECTIONS 100-114

> ZONING BY LAW - SCHEDULE 1A AREA C : SUBSECTION

ZONING BY LAW - PART 4 (SECTIONS 100-114) TABLE 101-MINIMUM PARKING SPACE RATES ROW N28, CORRECTIONAL FACILITY, COLUMN 4: 1 PARKING PER 100m2 OF GROSS FLOOR AREA

GROSS FLOOR AREA = 16,765m² (INCLUDING ALL BLOCKS) REQUIRED PARKING SPACE = 167 PARKING PROPOSED PARKING SPACE = 167+95 = 262 PARKING

NOT PROVIDED PER EXISTING CONDITIONS

PARKING SPACE DIMENSIONS MINIMUM = 5.2mx2.6m (90°)TYPE "A" = 5.8mx3.4m TYPE "B" = 5.8mX2.4m

AISLE AND DRIVEWAY PROVISIONS (SECTION 107) REQUIRED 20 OR MORE PARKING SPACES = 6.7m PROPOSED = 6.7m, 7.15m, 8.57m, 8.74m & 10.04m TABLE 107-MINIMUM REQUIRED AISLE WIDTH ROW (c) 56° - 70° , COLUMN 2 = 6.5m

AODA PARKING REQUIREMENTS CITY OF OTTAWA - ACCESSIBILITY DESIGN STANDARDS - SECTION 3.1 PARKING

> TOTAL PARKING SPACE = 167 PARKING ACCESSIBLE PARKING RATIO = 4% REQUIRED ACCESSIBLE PARKING NUMBER = 7 PROVIDED ACCESSIBLE PARKING NUMBER = 11 5 TYPE "A" ACCESSIBLE PARKING PROPOSED = 5.8mx3.4m 6 TYPE "B" ACCESSIBLE PARKING PROPOSED = 5.8mx2.4m

GEOTECHNICAL NOTES

- GEOTECHNICAL ENGINEER LICENSED IN THE PROVINCE OF ONTARIO SHALL INSPECT ALL SUBGRADE SURFACES FOR FOOTING AND PAVEMENT STRUCTURES PRIOR TO CONSTRUCTION.
- CONTRACTOR TO IMPLEMENT A MONITORING PROGRAM FOR VIBRATIONS TO BE OVERSEEN BY A PROFESSIONAL GEOTECHNICAL ENGINEER. CONTRACTOR TO ALLOW IN HIS BID A UNIT RATE FOR STATIC COMPACTION SHOULD VIBRATION MONITORING REQUIRES THE GEOTECHNICAL ENGINEER TO INSTRUCT THE USAGE OF STATIC COMPACTION METHODS.
- CONTRACTOR TO AVOID DIRECTING WATER TOWARDS THE TOP OR BOTTOM OF THE RAVINE SLOPE, BOTH DURING CONSTRUCTION AND AFTER COMPLETION. THE EXISTING CREEK CANNOT HANDLE ANY ADDITIONAL FLOW OR VOLUME, AND THE PROPOSED DRAINAGE PLAN SHOULD AIM TO MINIMIZE AND CONTROL ANY IMPACTS IN THIS REGARD.

DRAWING NOTES

01 REMOVE AND DISCARD EXISTING DOUBLE SECURITY FENCE.

02 REMOVE EXISTING TREES.

03 EXISTING TREES TO REMAIN. **04** REPAIR OR REPLACE EXISTING FENCE WHERE INDICATED TBC.

05 REMOVE AND REINSTATE ELECTRICAL PLUG IN STATIONS. REFER TO ELECTRICAL DRAWINGS.

06 NOT USED

07 PROTECT EXISTING FIRE HYDRANT DURING CONSTRUCTION.

TREE STUMP TO BE REMOVED.

09 RELOCATE EXISTING POLE.

10 RELOCATE EXISTING GATE. 11 PROPOSED REALIGNED FIRE ROUTE.

12 REMOVE AND DISCARD EXISTING SUBDRAIN.

13 EXISTING GATE FOR SNOW REMOVAL OPERATIONS. NO PARKING TO ALLOW ACCESS FOR PARKING EGRESS.

EXISTING CURB TO BE REMOVED.

16 EXISTING PICNIC TABLE TO BE RELOCATED.


17 EXISTING LANDSCAPE FEATURES TO BE RELOCATED.

18 PROVIDE CURB TERMINATION

19 REMOVE EXISTING CONCRETE HEADWALL

NEW PROPOSED HEADWALL PER OPSD 804.030

REMOVE EXISTING 450mm CULVERT. INSTALL RCP 450 DIA PIPES AND OGS SYSTEMAS SHOWN ON PLAN

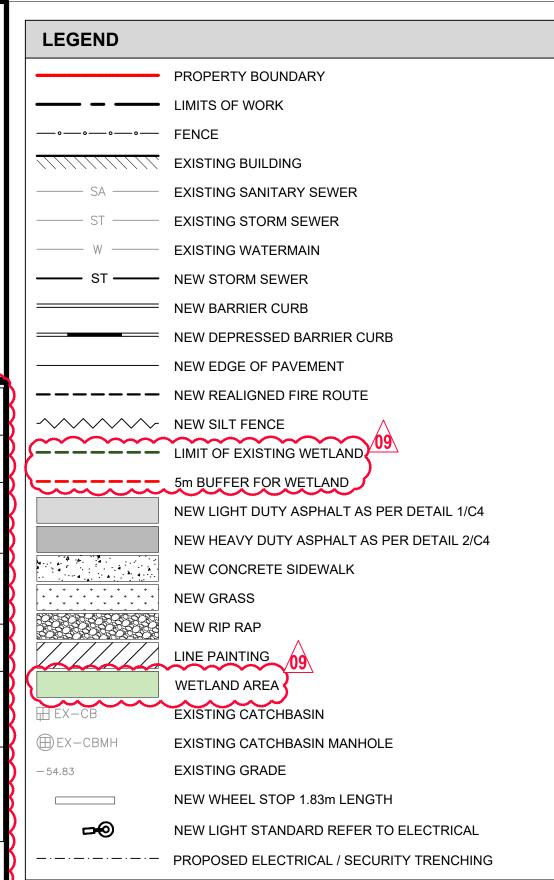

GENERAL NOTES

- DESIGN AND CONSTRUCTION IS TO BE IN ACCORDANCE WITH MOST RECENT ONTARIO BUILDING CODE.
- THE CONTRACTOR IS RESPONSIBLE FOR CHECKING AND VERIFYING ALL DIMENSIONS WITH RESPECT TO SITE CONDITIONS AND ALL MATERIALS TO THE PROJECT. ANY DISCREPANCY SHALL BE REPORTED TO THE ENGINEER.
- THIS DRAWING IS TO BE READ IN CONJUNCTION WITH ALL MATERIAL RELEVANT TO THE PROJECT.
- ADDITIONAL DRAWINGS MAY BE ISSUED FOR CLARIFICATION TO ASSIST PROPER EXECUTION OF WORK. SUCH DRAWINGS WILL HAVE THE SAME MEANING AND INTENT AS IF THEY WERE INCLUDED WITH THE CONTRACT DOCUMENTS.
- CONTRACTOR MUST COMPLY WITH LOCAL BY-LAWS, ONTARIO OCCUPATIONAL HEALTH AND SAFETY ACT AND ALL REGULATIONS SET BY AUTHORITIES HAVING JURISDICTION. IN CASE OF CONFLICT OR DISCREPANCY, THE MORE STRINGENT REQUIREMENTS SHALL APPLY.
- CONTRACTOR RESPONSIBLE FOR OBTAINING ALL REQUIRED UTILITY LOCATES, DAYLIGHTING, INSPECTIONS, PERMITS, AND APPROVALS, INCLUDING ALL ASSOCIATED COSTS. LOCATION OF EXISTING UTILITIES ARE APPROXIMATE ONLY AND BASED ON BEST AVAILABLE INFORMATION.


PROPERTY BOUNDARY INFORMATION IS DERIVED FROM THE PLAN RECEIVED FROM OCDC PREPARED BY ONTARIO REALTY CORPORATION NOVEMBER 2021 BASED ON INFORMATION OBTAINED FROM PLAN OF PART OF LOT 17 CONCESSION 3 (OTTAWA FRONT) TWP. OF GLOUCESTER, NOW IN THE CITY OF GLOUCETSER REGIONAL MUNICIPALITY OF OTTAWA-CARLETON DATED FEB 22, 1999 PREPARED BY D.A. SIMMONS OLS WEBSTER AND SIMMON'S SURVEYING LTD, OTTAWA.

EROSION AND SEDIMENT CONTROL NOTES


- THE CONTRACTOR SHALL IMPLEMENT BEST MANAGEMENT PRACTICES TO PROVIDE FOR PROTECTION OF THE AREA DRAINAGE SYSTEM AND THE RECEIVING WATER COURSE, DURING CONSTRUCTION ACTIVITIES; THIS INCLUDES LIMITING THE AMOUNT OF EXPOSED SOIL, INSTALLING SILT FENCES AND OTHER EFFECTIVE SEDIMENT TRAPS, AND INSTALLING AND MAINTAINING MUD MATS FOR OUTGOING CONSTRUCTION TRAFFIC DURING CONSTRUCTION ACTIVITIES.
- PREVENT SOIL LOSS DURING CONSTRUCTION (BY STORM WATER
- RUNOFF OR WIND EROSION). 3. PROTECT TOPSOIL BY STOCKPILING FOR REUSE.
- 4. PREVENT SEDIMENTATION OF STORM SEWERS AND RECEIVING
- 5. PREVENT AIR POLLUTION FROM DUST AND PARTICULATE MATTER.
- ALL STORM MANHOLES AND CATCHBASIN MANHOLES TO HAVE 300mm SUMPS; ALL CATCHBASINS TO HAVE 600mm SUMPS.
- INSTALL FILTER BAG INSERT IN ALL STORM MANHOLES AND CATCH BASINS IMPACTED DURING CONSTRUCTION, INCLUDING CATCH BASINS IN THE RIGHT OF WAY.
- SEDIMENT AND EROSION CONTROL MEASURES MAY BE MODIFIED IN THE FIELD AT THE DISCRETION OF THE CITY OF OTTAWA INSPECTOR OR CONSERVATION AUTHORITY.
- STORM WATER PUMPED INTO CITY SERVICE SHALL FLOW THROUGH A FILTER SOCK.
- 10. THE CONTRACTOR ACKNOWLEDGES THAT FAILURE TO IMPLEMENT APPROPRIATE EROSION AND SEDIMENTATION CONTROL MEASURES MAY BE SUBJECT TO PENALTIES IMPOSED BY ANY APPLICABLE REGULATORY

LANDSCAPING NOTES

- CONTRACTOR TO ENSURE THAT THERE IS NO EXCAVATION OVER 20% OF THE CRITICAL ROOT ZONE (CRZ) OF RETAINED TREES DUE TO ASPHALT CONSTRUCTION, REFER TO LANDSCAPING DRAWINGS FOR DELINEATION OF CRITICAL ZONE
- ALL LIGHT AND CAMERA POLES AND BASES SHALL BE LOCATED OUTSIDE THE 5 METERS BUFFER OF THE WETLAND.

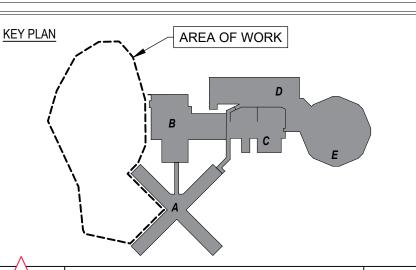

/09 \	RE-ISSUED FOR CITY REVIEW	2024.01.12
08	RE-ISSUED FOR CITY REVIEW	2023.10.25
07	ISSUED FOR TENDER	2023.08.18
06	99% DESIGN REVIEW	2023.08.15
05	90% DESIGN REVIEW	2022.12.21
04	66% DESIGN REVIEW	2022.02.02
03	33% DESIGN REVIEW R2	2021.11.08
02	33% DESIGN REVIEW R1	2021.10.08
01	33% DESIGN REVIEW	2020.12.07
No	Revisions	Date
		ı

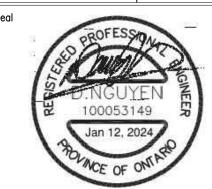

The Contractor shall check and verify all dimensions and report |all errors and omissions to the IO-Owner's/MBS Designee (as applicable) for his/her written direction before proceeding with the Work.



B Sheet No where detailed

Jp2g Project #: 20-5060A

PROJECT ENGINEER: CIVIL, STRUCTURAL, MECHANICAL & ELECTRICAL



Jp2g Consultants Inc. NGINEERS · PLANNERS · PROJECT MANAGERS 1150 MORRISON DRIVE, SUITE 410, OTTAWA, ON K2H 8S9 PHONE: 613-828-7800 FAX: 613-828-2600



Infrastructure Ontario


OTTAWA CARLETON DETENTION CENTRE TEMPORARY PARKING LOT EXPANSION

INNES ROAD, GLOUCESTER TOWNSHIP

10 Project No

SITE PLAN - NEW PARKING LAYOUT

5. IF REQUIRED, THE CONTRACTOR SHALL CONTACT HYDRO OTTAWA TO	OGS SYSTEMAS SHOWN ON PLAN	AGENCY.	Scale AS NOTED	Date DECEMBER 2022
ARRANGE FOR DISCONNECTING THE SERVICE FROM THE DISTRIBUTION SYSTEM AND REMOVAL OF ALL HYDRO OTTAWA ASSETS AT LEAST TEN (10) BUSINESS DAYS PRIOR TO DEMOLITION/REMOVAL OF THE SERVICED	22 INSTALL RIP RAP AND GEOTEXTILE PER OPSD 810.010 23 FOR ELECTIRCAL/SECURITY TRENCHING AND FOUNDATION, REFER TO	LANDSCAPING NOTES	Brawn by	Substantial Performance Date
STRUCTURE. 6. THE CONTRACTOR SHALL NOT USE STEEL CURB AND SIDEWALK FORM SUPPORT PINS IN THE VICINITY OF HYDRO OTTAWA UNDERGROUND	ELECTRICAL DRAWINGS (TYPICAL) 24 SUPPLY AND INSTALL NEW OIL GRIT SEPARATOR. STRUCTURE TO BE LOCATED OUTSIDE OF ACCESS PATH, PROVIDE TOP SOIL AROUND STRUCTURE FRAME ELEVATION. ENSURE MIN 300mm GRANULAR A ABOVE THE PROPOSED RCP PIPES.	CONTRACTOR TO ENSURE THAT THERE IS NO EXCAVATION OVER 20% OF THE CRITICAL ROOT ZONE (CRZ) OF RETAINED TREES DUE TO ASPHALT CONSTRUCTION, REFER TO LANDSCAPING DRAWINGS FOR DELINEATION OF CRITICAL ZONE	Besigned by D.N.	Drawing No
PLANT FOR ELECTRICAL SAFETY.	ABOVE THE PROPOSED NOT PIPES.	2. ALL LIGHT AND CAMERA POLES AND BASES SHALL BE LOCATED OUTSIDE THE 5 METERS BUFFER OF THE WETLAND.	7	CADD File NAME -

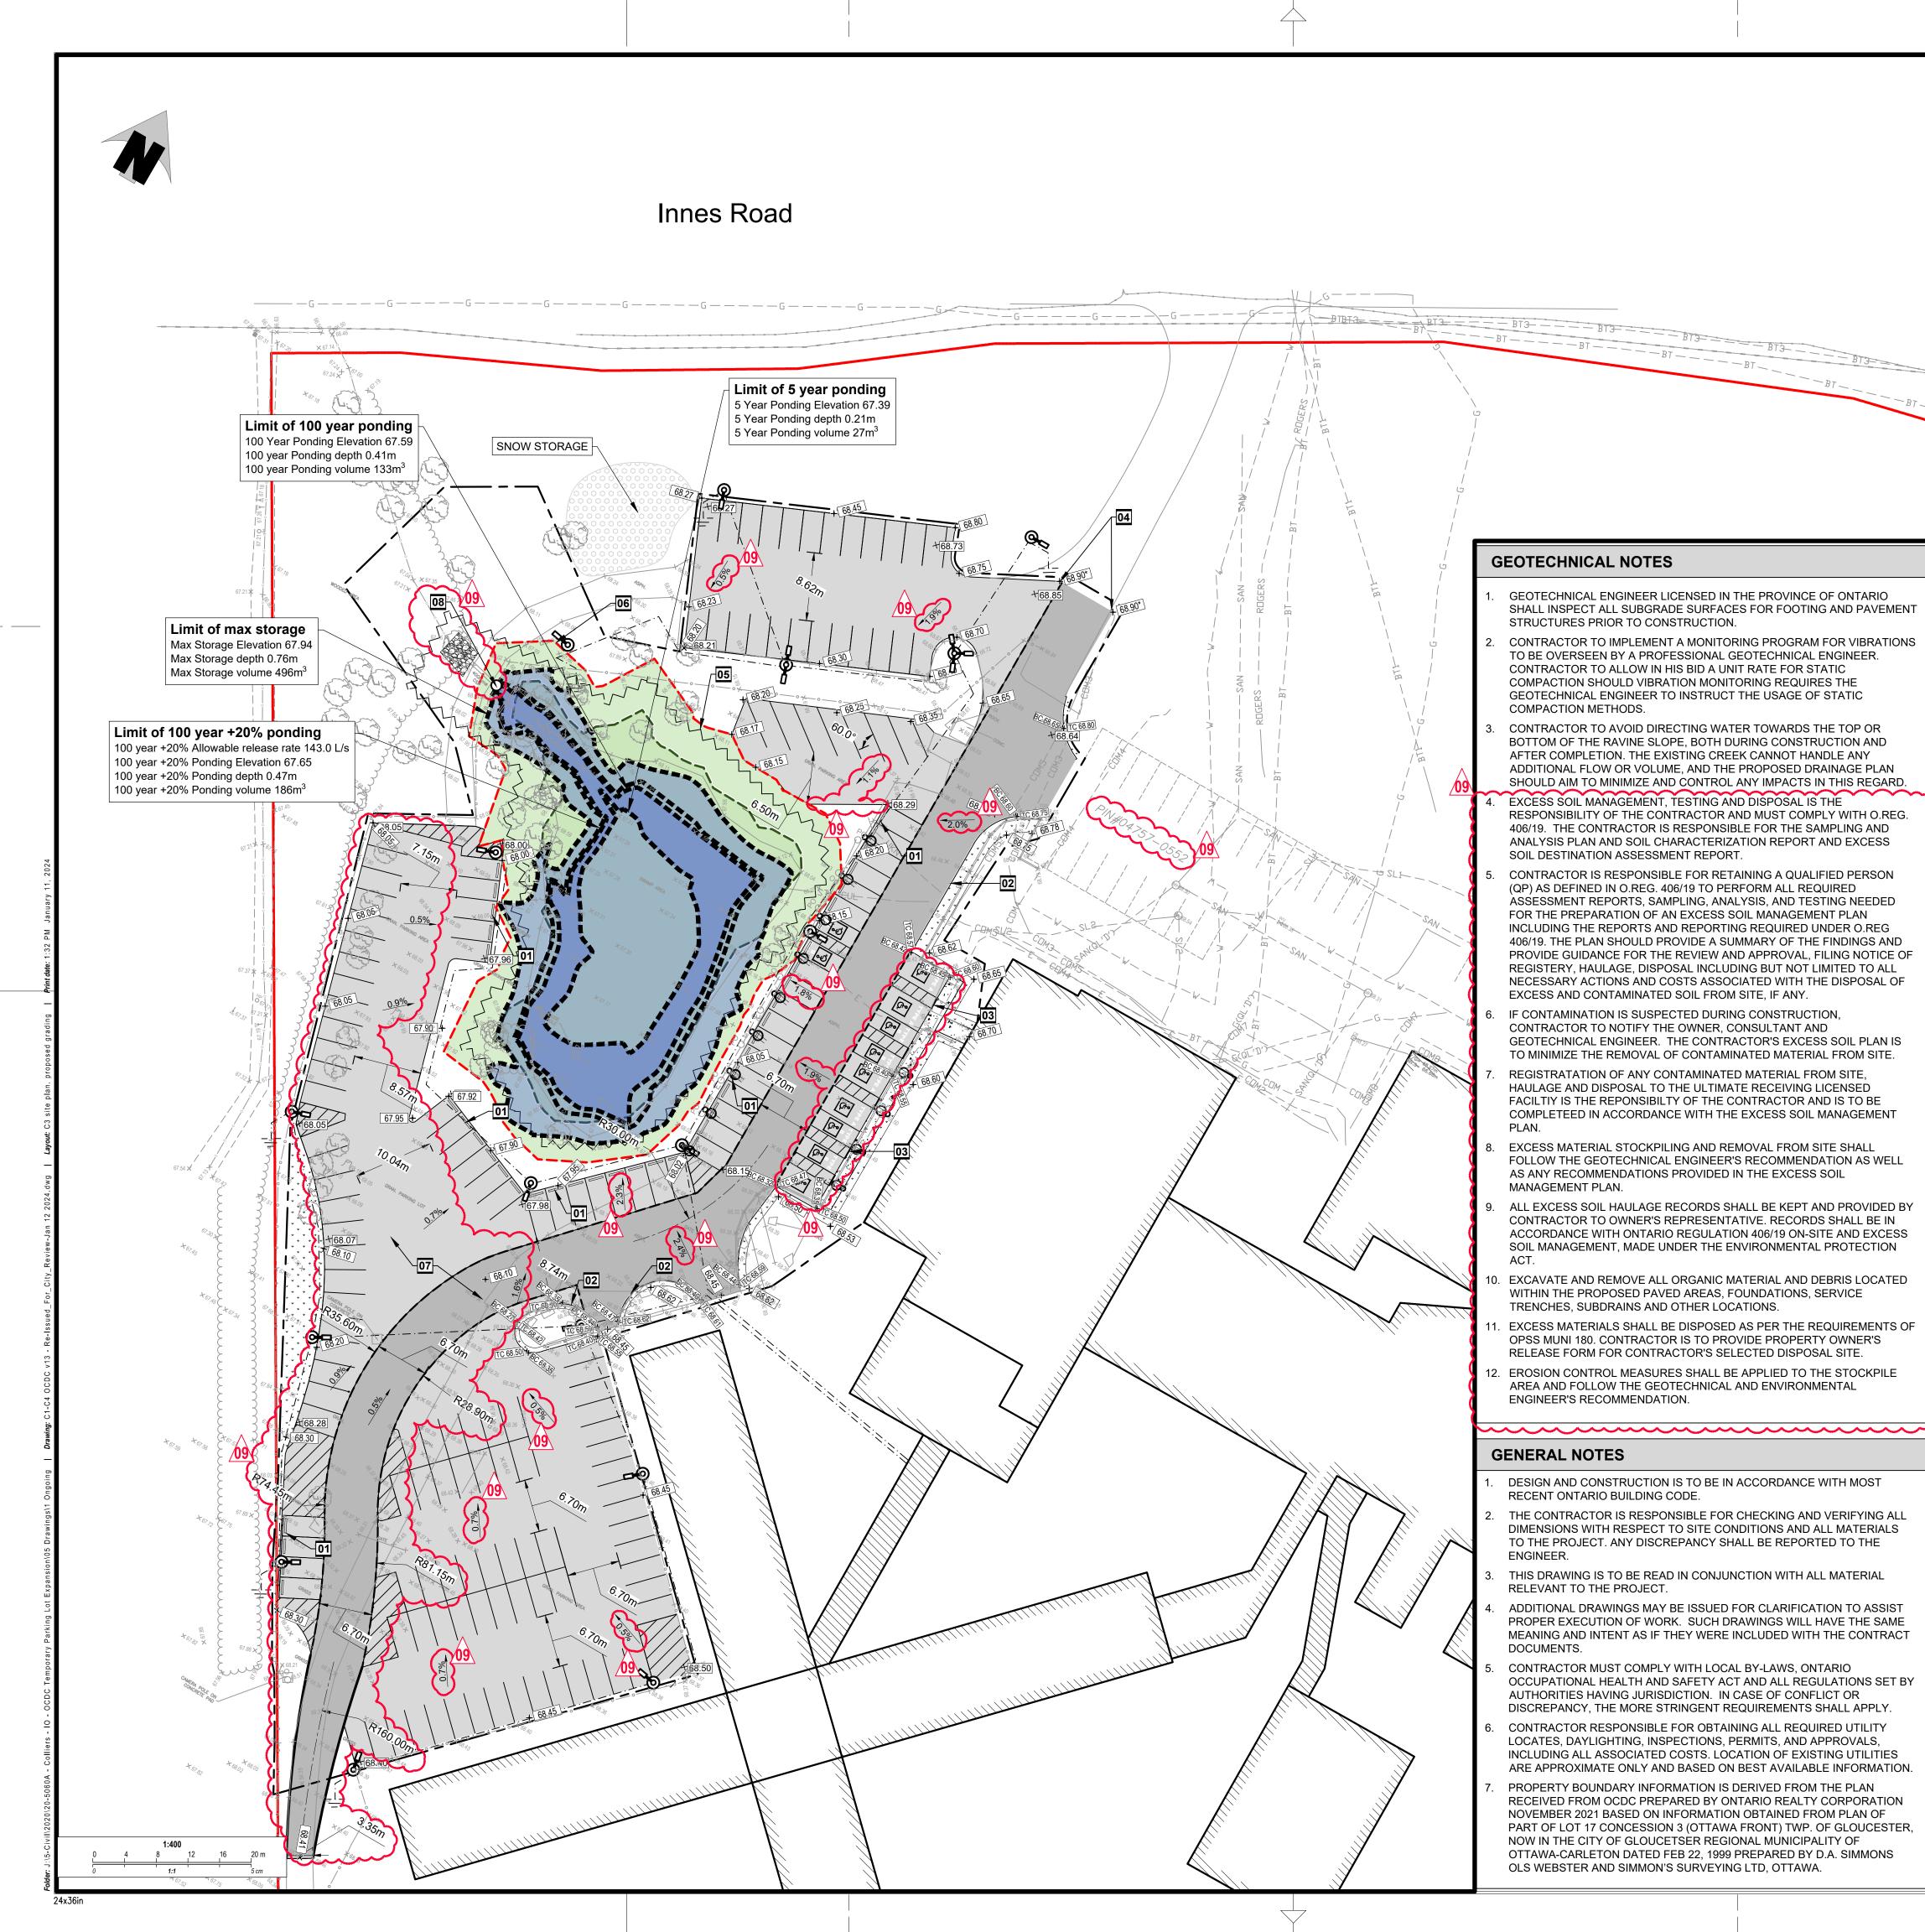

LEGEND PROPERTY BOUNDARY — — LIMITS OF WORK —∘—∘—∘— FENCE EXISTING BUILDING **EXISTING SANITARY SEWER EXISTING STORM SEWER** — W — EXISTING WATERMAIN ---- ST ---- NEW STORM SEWER NEW LIGHT DUTY ASPHALT AS PER DETAIL 1/C4 NEW ASPHALT GRINDING AND PAVING AS PER DETAIL 2/C4 NEW CONCRETE SIDEWALK **NEW GRASS** WETLAND AREA NEW SILT FENCE ---- LIMIT OF EXISTING WETLAND EXISTING CATCHBASIN ⊞ EX-CB ⊕ EX−CBMH **EXISTING CATCHBASIN MANHOLE EXISTING GRADE** +54.83 68.65 + NEW GRADE NEW SLOPE NEW TOP AND BOTTOM OF CURB NEW BARRIER CURB

DRAWING NOTES


01 INSTALL NEW PRECAST WHEEL STOPPER, TYPICAL

NEW DEPRESSED BARRIER CURB


- CONSTRUCT NEW CONCRETE BARRIER CURB IN ACCORDANCE WITH CITY OF OTTAWA STANDARD DETAIL SC1.1
- CONSTRUCT NEW CONCRETE BARRIER CURB WITH 2.0m WIDE SIDEWALK IN ACCORDANCE WITH CITY OF OTTAWA STANDARD DETAILS SC1.4. PROVIDE ACCESSIBLE RAMPS, MAX 5%, BESIDE EACH ACCESSIBLE PARKING SPOT AS DENOTED BY THE MARKING LINES.
- CONTRACTOR TO CONFIRM EXISTING ELEVATION AT LIMIT OF ASPHALT. TIE IN NEW ASPHALT TO EXISTING.
- 105 INSTALL SILT FENCE IN ACCORDANCE WITH OPSD 219.130 AROUND EXISTING WETLAND DURING CONSTRUCTION.
- PROTECT EXISTING WETLAND DURING CONSTRUCTION. DO NOT ALTER GRADE OR MATERIAL WITHIN 5M OF EXISTING WETLAND
- O7 CONTRACTOR TO REMOVE AND DISPOSE OFF SITE ALL EXISTING GRANULAR MATERIAL
- SUPPLY AND INSTALL NEW DOWNSTREAM DEFENDER STRUCTURE TO BE SIZED BY MANUFACTURER , MINIMUM 80% TSS REMOVAL. DRAINAGE AREA= 1.035 HA 100 YEARS WEIGHTED RUNOFF COEFFCIENT=0.71. USE 'FINE PARTICLE DISTRIBUTION'. MUST ACCOMODATE 143.0 L/S. PROVIDE WATERTIGHT LID AS PER OPSD 401.030. CONTRACTOR SHALL SUBMIT SHOP-DRAWINGS FOR OGS.

EROSION AND SEDIMENT CONTROL NOTES


- THE CONTRACTOR SHALL IMPLEMENT BEST MANAGEMENT PRACTICES TO PROVIDE FOR PROTECTION OF THE AREA DRAINAGE SYSTEM AND THE RECEIVING WATER COURSE, DURING CONSTRUCTION ACTIVITIES; THIS INCLUDES LIMITING THE AMOUNT OF EXPOSED SOIL, INSTALLING SILT FENCES AND OTHER EFFECTIVE SEDIMENT TRAPS, AND INSTALLING AND MAINTAINING MUD MATS FOR OUTGOING CONSTRUCTION TRAFFIC DURING CONSTRUCTION ACTIVITIES.
- PREVENT SOIL LOSS DURING CONSTRUCTION (BY STORM WATER RUNOFF OR WIND EROSION).
- PROTECT TOPSOIL BY STOCKPILING FOR REUSE.
- 4. PREVENT SEDIMENTATION OF STORM SEWERS AND RECEIVING STREAMS.
- PREVENT AIR POLLUTION FROM DUST AND PARTICULATE MATTER.
- 6. ALL STORM MANHOLES AND CATCHBASIN MANHOLES TO HAVE 300mm SUMPS; ALL CATCHBASINS TO HAVE 600mm SUMPS.
- INSTALL FILTER BAG INSERT IN ALL STORM MANHOLES AND CATCH BASINS IMPACTED DURING CONSTRUCTION, INCLUDING CATCH BASINS IN THE RIGHT OF WAY.
- SEDIMENT AND EROSION CONTROL MEASURES MAY BE MODIFIED IN THE FIELD AT THE DISCRETION OF THE CITY OF OTTAWA INSPECTOR OR CONSERVATION AUTHORITY.
- STORM WATER PUMPED INTO CITY SERVICE SHALL FLOW THROUGH A FILTER SOCK.
- 10. THE CONTRACTOR ACKNOWLEDGES THAT FAILURE TO IMPLEMENT APPROPRIATE EROSION AND SEDIMENTATION CONTROL MEASURES MAY BE SUBJECT TO PENALTIES IMPOSED BY ANY APPLICABLE REGULATORY AGENCY.

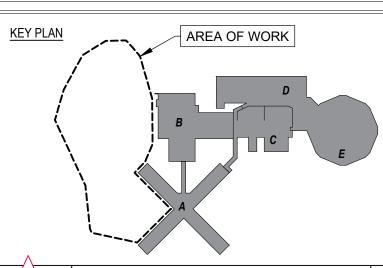

09	RE-ISSUED FOR CITY REVIEW	2024.01.12
08	RE-ISSUED FOR CITY REVIEW	2023.10.25
07	ISSUED FOR TENDER	2023.08.18
06	99% DESIGN REVIEW	2023.08.15
05	90% DESIGN REVIEW	2022.12.21
04	66% DESIGN REVIEW	2022.02.02
03	33% DESIGN REVIEW R2	2021.11.08
02	33% DESIGN REVIEW R1	2021.10.08
01	33% DESIGN REVIEW	2020.12.07
No	Revisions	Date

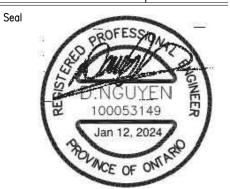

The Contractor shall check and verify all dimensions and report all errors and omissions to the IO-Ówner's/MBS Designee (as applicable) for his/her written direction before proceeding with the Work.

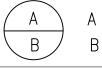

B Sheet No where detailed

Jp2g Project #: 20-5060A

PROJECT ENGINEER: CIVIL, STRUCTURAL, MECHANICAL & ELECTRICAL



Jp2g Consultants Inc. NGINEERS · PLANNERS · PROJECT MANAGERS 1150 MORRISON DRIVE, SUITE 410, OTTAWA, ON K2H 8S9 PHONE: 613-828-7800 FAX: 613-828-2600



OTTAWA CARLETON DETENTION CENTRE TEMPORARY PARKING LOT EXPANSION

INNES ROAD, GLOUCESTER TOWNSHIP

10 Project No

Drawing Title SITE GRADING PLAN

Scale	Date
AS NOTED	DECEMBER 2022
Drawn by	Substantial Performance Date
R.W.	_
Designed by	Drawing No
D.N.	
Approved by	
	OADD ET MANE

General Notes

- DRAWINGS TO BE READ IN CONJUNCTION WITH ARCHITECTURAL AND LANDSCAPE DRAWINGS
- ALL SERVICES, MATERIALS, CONSTRUCTION METHODS AND INSTALLATIONS SHALL BE IN ACCORDANCE WITH THE LATEST STANDARDS AND REGULATIONS OF THE: CITY OF OTTAWA STANDARD SPECIFICATIONS AND DRAWINGS, ONTARIO PROVINCIAL SPECIFICATION STANDARD SPECIFICATION (OPSS) AND ONTARIO PROVINCIAL STANDARD DRAWINGS (OPSD), UNLESS OTHERWISE SPECIFIED, TO THE SATISFACTION OF THE CITY AND THE CONSULTANT
- THE POSITION OF EXISTING POLE LINES, CONDUITS, WATERMAINS, SEWERS AND OTHER UNDERGROUND AND ABOVEGROUND UTILITIES, STRUCTURES AND APPURTENANCES IS NOT NECESSARILY SHOWN ON THE CONTRACT DRAWING, AND WHERE SHOWN, THE ACCURACY OF THE POSITION OF SUCH UTILITIES AND STRUCTURES IS NOT GUARANTEED. PRIOR TO CONSTRUCTION, THE CONTRACTOR SHALL SATISFY HIMSELF OF THE EXACT LOCATION OF ALL SUCH UTILITIES AND STRUCTURES, AND SHALL ASSUME ALL LIABILITY FOR DAMAGE TO THEM DURING THE COURSE OF CONSTRUCTION. ANY RELOCATION OF EXISTING UTILITIES REQUIRED BY THE DEVELOPMENT OF SUBJECT LANDS IS TO BE UNDERTAKEN AT CONTRACTOR'S EXPENSE.
- THE CONTRACTOR MUST NOTIFY ALL EXISTING UTILITY COMPANY OFFICIALS FIVE (5) BUSINESS DAYS PRIOR TO START OF CONSTRUCTION AND HAVE ALL EXISTING UTILITIES AND SERVICES LOCATED IN THE FIELD OR EXPOSED PRIOR TO THE START OF CONSTRUCTION, INCLUDING BUT NOT LIMITED TO POWER, COMMUNICATION AND GAS LINES.
- ALL TRENCHING AND EXCAVATIONS TO BE IN ACCORDANCE WITH THE LATEST REVISIONS OF THE OCCUPATIONAL HEALTH AND SAFETY ACT AND REGULATIONS FOR CONSTRUCTION PROJECTS AND AS PER THE RECOMMENDATIONS INCLUDED IN THE GEOTECHNICAL REPORT.
- REFER TO ARCHITECTS PLANS FOR BUILDING DIMENSIONS, LAYOUT AND REMOVALS. REFER TO LANDSCAPE PLAN FOR LANDSCAPED DETAILS AND OTHER RELEVANT INFORMATION. ALL INFORMATION SHALL BE CONFIRMED PRIOR TO COMMENCEMENT OF CONSTRUCTION.
- TOPOGRAPHIC SURVEY COMPLETED AND PROVIDED BY J.D. BARNES LTD. PROJECT NO.: 17-10-013-00, DATED APRIL 24, 2017. CONTRACTOR TO VERIFY IN THE FIELD PRIOR TO CONSTRUCTION OF ANY WORK AND NOTIFY THE ENGINEER OF ANY DISCREPANCIES.
- 8. ALL ELEVATIONS ARE GEODETIC AND UTILIZE METRIC UNITS. VERIFY THAT JOB BENCHMARKS HAVE NOT BEEN ALTERED OR DISTURBED.
- 9. ALL GROUND SURFACES SHALL BE EVENLY GRADED WITHOUT PONDING AREAS AND WITHOUT LOW POINTS EXCEPT WHERE APPROVED SWALE OR CATCH BASIN OUTLETS ARE PROVIDED.
- 10. ALL EDGES OF DISTURBED PAVEMENT SHALL BE SAW CUT TO FORM A NEAT AND STRAIGHT LINE PRIOR TO PLACING NEW PAVEMENT. PAVEMENT REINSTATEMENT SHALL BE WITH STEP JOINTS OF 500mm WIDTH MINIMUM.
- 11. ALL DISTURBED AREAS OUTSIDE PROPOSED GRADING LIMITS TO BE RESTORED TO ORIGINAL ELEVATIONS AND CONDITIONS UNLESS OTHERWISE SPECIFIED. ALL RESTORATION SHALL BE COMPLETED WITH THE GEOTECHNICAL REQUIREMENTS FOR BACKFILL AND COMPACTION.
- 12. ABUTTING PROPERTY GRADES TO BE MATCHED UNLESS OTHERWISE
- 13. CONTRACTOR SHALL OBTAIN AND PAY FOR ALL NECESSARY PERMITS AND APPROVALS FROM THE MUNICIPAL AUTHORITIES PRIOR TO COMMENCING CONSTRUCTION, INCLUDING WATER PERMIT AND ROAD
- 14. MINIMIZE DISTURBANCE TO EXISTING VEGETATION DURING THE EXECUTION OF ALL WORKS.
- 15. REMOVE FROM SITE ALL EXCESS EXCAVATED MATERIAL UNLESS OTHERWISE DIRECTED FROM THE ENGINEER. EXCAVATE AND REMOVE ALL ORGANIC MATERIAL AND DEBRIS LOCATED WITHIN THE PROPOSED BUILDING, PARKING AND ROADWAY LOCATIONS.
- 16. AT PROPOSED UTILITY CONNECTION POINTS AND CROSSINGS (I.E. STORM SEWER, SANITARY SEWER, WATER, ETC.) THE CONTRACTOR SHALL DETERMINE THE PRECISE LOCATION AND DEPTH OF EXISTING UTILITIES AND REPORT ANY DISCREPANCIES OR CONFLICTS TO THE ENGINEER BEFORE COMMENCING WORK.
- 17. CONTRACTOR TO OBTAIN POST-CONSTRUCTION TOPOGRAPHIC SURVEY, COMPLETED BY OLS OR P.ENG CONFIRMING COMPLIANCE WITH DESIGN GRADING AND SERVICING. SURVEY IS TO INCLUDE LOCATION AND INVERTS FOR BURIED UTILITIES.
- 18. REPORT REFERENCES;
 - i. INSTITUTIONAL PARKING SPACE STUDY, PREPARED BY STEPHENSON ENGINEERING LTD., PROJECT NO.: 20180784, DATED SEPTEMBER 27,

Parking Lot

** CONTRACTOR IS RESPONSIBLE FOR ALL INSTALLATION, MONITORING, REPAIR AND REMOVAL OF ALL EROSION AND SEDIMENT CONTROL FEATURES.**

PRIOR TO START OF CONSTRUCTION:

- 1.1. INSTALL SILT FENCE IN LOCATION SHOWN.
- 1.2. INSTALL FILTER FABRIC OR SILT SACK FILTERS IN ALL THE CATCHBASINS AND MANHOLES TO REMAIN DURING CONSTRUCTION WITHIN THE SITE (SEE TYPICAL DETAIL).
- 1.3. INSPECT MEASURES IMMEDIATELY AFTER INSTALLATION.

2. DURING CONSTRUCTION:

- MINIMIZE THE EXTENT OF DISTURBED AREAS AND THE DURATION OF EXPOSURE AND IMPACTS TO EXISTING GRADING.
- 2.2. PERIMETER VEGETATION TO REMAIN IN PLACE UNTIL PERMANENT STORM WATER MANAGEMENT IS IN PLACE. OTHERWISE, IMMEDIATELY INSTALL SILT FENCE WHEN THE EXISTING SITE IS DISTURBED AT THE PERIMETER.
- PROTECT DISTURBED AREAS FROM OVERLAND FLOW BY PROVIDING TEMPORARY SWALES TO THE SATISFACTION OF THE FIELD ENGINEER. TIE-IN TEMPORARY SWALE TO EXISTING CB'S AS
- PROVIDE TEMPORARY COVER SUCH AS SEEDING OR MULCHING IF DISTURBED AREA WILL NOT BE REHABILITATED WITHIN 30 DAYS.
- INSPECT SILT FENCES, FILTER FABRIC FILTERS AND CATCH BASIN SUMPS WEEKLY AND WITHIN 24 HOURS AFTER A STORM EVENT. CLEAN AND REPAIR WHEN NECESSARY.
- DRAWING TO BE REVIEWED AND REVISED AS REQUIRED DURING CONSTRUCTION
- EROSION CONTROL FENCING TO BE ALSO INSTALLED AROUND THE BASE OF ALL STOCKPILES.
- DO NOT LOCATE TOPSOIL PILES AND EXCAVATION MATERIAL CLOSER THAN 2.5m FROM ANY PAVED SURFACE, OR ONE WHICH IS TO BE PAVED BEFORE THE PILE IS REMOVED. ALL TOPSOIL PILES ARE TO BE SEEDED IF THEY ARE TO REMAIN ON SITE LONG ENOUGH FOR SEEDS TO GROW (LONGER THAN 30 DAYS).
- CONTROL WIND-BLOWN DUST OFF SITE BY SEEDING TOPSOIL PILES AND OTHER AREAS TEMPORARILY (PROVIDE WATERING AS REQUIRED AND TO THE SATISFACTION OF THE ENGINEER).
- 2.10. NO ALTERNATE METHODS OF EROSION PROTECTION SHALL BE PERMITTED UNLESS APPROVED BY THE FIELD ENGINEER.
- 2.11. CITY ROADWAY AND SIDEWALK TO BE CLEANED OF ALL SEDIMENT FROM VEHICULAR TRACKING AS REQUIRED.
- 2.12. DURING WET CONDITIONS, TIRES OF ALL VEHICLES/EQUIPMENT LEAVING THE SITE ARE TO BE SCRAPED.
- 2.13. ANY MUD/MATERIAL TRACKED ONTO THE ROAD SHALL BE REMOVED IMMEDIATELY BY HAND OR RUBBER TIRE LOADER.
- 2.14. TAKE ALL NECESSARY STEPS TO PREVENT BUILDING MATERIAL, CONSTRUCTION DEBRIS OR WASTE BEING SPILLED OR TRACKED ONTO ABUTTING PROPERTIES OR PUBLIC STREETS DURING CONSTRUCTION AND PROCEED IMMEDIATELY TO CLEAN UP ANY AREAS SO AFFECTED.
- 2.15. ALL EROSION CONTROL STRUCTURE TO REMAIN IN PLACE UNTIL ALL DISTURBED GROUND SURFACES HAVE BEEN STABILIZED EITHER BY PAVING OR RESTORATION OF VEGETATIVE GROUND COVER.
- 2.16. THE CONTRACTOR SHALL IMPLEMENT BEST MANAGEMENT PRACTICES, TO PROVIDE FOR PROTECTION OF THE AREA DRAINAGE SYSTEM AND THE RECEIVING WATERCOURSE, DURING CONSTRUCTION ACTIVITIES. THE CONTRACTOR ACKNOWLEDGES THAT FAILURE TO IMPLEMENT APPROPRIATE EROSION AND SEDIMENT CONTROL MEASURES MAY BE SUBJECT TO PENALTIES IMPOSED BY ANY APPLICABLE REGULATORY AGENCY.

Parking Lot

Notes: Culvert

- CONTRACTOR TO REINSTATE ROAD CUTS AS PER CITY OF OTTAWA
- CONTRACTOR TO PREPARE SUBGRADE, INCLUDING PROOFROLLING, TO THE SATISFACTION OF THE GEOTECHNICAL CONSULTANT PRIOR TO THE COMMENCEMENT OF PLACEMENT OF GRANULAR B MATERIAL
- CONTRACTOR TO SUPPLY, PLACE AND COMPACT GRANULAR B MATERIAL IN ACCORDANCE WITH THE RECOMMENDATIONS OF THE GEOTECHNICAL CONSULTANT. CONTRACTOR TO PROVIDE CONSULTANT WITH SAMPLES OF GRANULAR B MATERIAL FOR TESTING AND CERTIFICATION FROM THE GEOTECHNICAL CONSULTANT THAT THE MATERIAL MEETS THE GRADATION REQUIREMENTS SPECIFIED IN THE GEOTECHNICAL REPORT
- GRANULAR A MATERIAL TO BE PLACED ONLY UPON APPROVAL BY THE GEOTECHNICAL CONSULTANT OF GRANULAR B PLACEMENT.
- CONTRACTOR TO SUPPLY, PLACE AND COMPACT GRANULAR A MATERIAL IN ACCORDANCE WITH THE RECOMMENDATIONS OF THE GEOTECHNICAL CONSULTANT. CONTRACTOR TO PROVIDE CONSULTANT WITH SAMPLES OF GRANULAR A MATERIAL FOR TESTING AND CERTIFICATION FROM THE GEOTECHNICAL CONSULTANT THAT THE MATERIAL MEETS THE GRADATION REQUIREMENTS SPECIFIED IN THE GEOTECHNICAL REPORT
- ASPHALT MATERIAL TO BE PLACED ONLY UPON APPROVAL BY THE GEOTECHNICAL CONSULTANT OF GRANULAR A PLACEMENT
- CONTRACTOR TO SUPPLY, PLACE AND COMPACT ASPHALT MATERIAL IN ACCORDANCE WITH THE RECOMMENDATIONS OF THE GEOTECHNICAL CONSULTANT. CONTRACTOR TO PROVIDE CONSULTANT WITH SAMPLES OF ASPHALT MATERIAL FOR TESTING AND CERTIFICATION FROM THE GEOTECHNICAL CONSULTANT THAT THE MATERIAL MEETS THE REQUIREMENTS SPECIFIED IN THE GEOTECHNICAL REPORT.
- CONTRACTOR IS RESPONSIBLE FOR ESTABLISHING LINE AND GRADE IN ACCORDANCE WITH THE PLANS, AND FOR PROVIDING THE CONSULTANT WITH VERIFICATION PRIOR TO PLACEMENT.
- ALL EXCESS MATERIAL TO BE HAULED OFFSITE AND DISPOSED OF AT AN APPROVED DUMP SITE. SHOULD THE CONTRACTOR DISCOVER ANY HAZARDOUS MATERIAL, CONTRACTOR IS TO NOTIFY CONSULTANT. CONSULTANT TO DETERMINE APPROPRIATE DISPOSAL METHOD/LOCATION.
- PAVEMENT STRUCTURE (MATERIAL TYPES AND THICKNESS) FOR HEAVY DUTY, AND LIGHT DUTY COURT AREAS TO BE AS SPECIFIED IN THE GEOTECHNICAL REPORT AND SHOWN ON THE PLANS.


CULVERT BEDDING TO BE CONSTRUCTED AS PER OPSD 802.031

CONTRACTOR TO PROVIDE CCTV FOR THE PROPOSED CULVERT.

RIP RAP TO BE INSTALLED AT CULVERT OUTLET AS PER OPSD 810.01

- 150mm OPSS Granular 'A base (crushed limestone) 65mm Superpave 12.5mm PG 58-34 300mm OPSS Granular 'B' asphalt concrete Type II subbase Existing subgrade condition, compaction requirements and replacement with granular CONTRACTOR TO REMOVE AND material if required to be DISPOSE OFF SITE ALL **EXISTING GRANULAR MATERIAL** confirmed by the geotechnical

1 \ Pavement Structure for Light Duty Pavement (Typ.) C4 / Scale: As shown

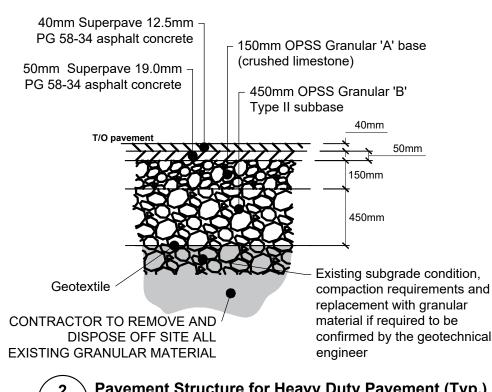


- Milling (50mm) or as shown Sawcut existing asphalt full depth - Surface course asphalt 50mm sawcut depth - Base course asphalt Granular 'A' base - Granular 'B' Type 2 sub-base

GEOTECHNICAL NOTES

- 1. A GEOTECHNICAL ENGINEER LICENSED IN THE PROVINCE OF ONTARIO SHALL INSPECT ALL SUBGRADE SURFACES FOR FOOTING AND TRENCHES, PIPE BEDDING, CLAY SEALS AND PAVEMENT STRUCTURES PRIOR TO CONSTRUCTION.
- 2. IT IS STRICTLY RECOMMENDED TO REFER GEOTECHNICAL INVESTIGATION REPORT: GEOTECHNICAL INVESTIGATION REPORT BUILDING EXPANSION OTTAWA CARLETON DETENTION CENTRE - 244 INNES ROAD, PREPARED BY DST CONSULTING ENGINEERS AUGUST 11, 207.
- 3. STRINGENT CONSTRUCTION CONTROL PROCEDURES SHOULD BE MAINTAINED TO ENSURE THAT UNIFORM SUBGRADE MOISTURE AND DENSITY CONDITIONS ARE ACHIEVED
- 4. SHOULD SURFACE AND SUBSURFACE WATER SEEPAGE OCCUR INTO THE EXCAVATIONS COLLECT ANY WATER ENTERING THE EXCAVATIONS AND REMOVE IT BY PUMPING FROM SUMP.
- 5. IT IS RECOMMENDED THAT THE CULVERT BEDDING BE 300 MM THICK AND CONSIST OF OPSS GRANULAR A. THE BEDDING MATERIAL SHOULD BE PLACED ALONG THE SIDES AND ON TOP OF THE PIPE TO PROVIDE A MINIMUM COVER OF 300 MM. THE BEDDING SHOULD BE COMPACTED TO AT LEAST 98 PERCENT OF THE SPMDD. PROVIDE GEOTEXTILE AT SUBGRADE LEVEL.
- 6. BACKFILL AROUND STRUCTURES SHOULD CONSIST OF FREE-DRAINING GRANULAR MATERIAL CONFORMING TO OPSS GRANULAR B TYPE II
- 7. SPECIAL PROVISIONS SHOULD BE ALLOWED BY CONTRACTOR FOR LOADING CONDITIONS ON PAVEMENT STRUCTURE DURING CONSTRUCTION SUCH AS RESTRICTED LANES. HALF-LOADS DURING PAVING AND/OR TEMPORARY CONSTRUCTION ROADWAYS ESPECIALLY IF CONSTRUCTION TIME SPANS THROUGH UNFAVORABLE WEATHER PERIOD.
- 8. IT IS RECOMMENDED THAT A GEOTEXTILE BE PLACED ON THE SURFACE OF THE SUBGRADE PRIOR OF PLACEMENT OF ANY GRANULAR SUB-BASE. THIS MUST BE ALLOWED FOR BY THE CONTRACTOR AND INSTALLED WHEN DIRECTED BY THE GEOTECHNICAL ENGINEER.
- 9. WEAKER SUBGRADE MAY DEVELOP AT SUBGRADE LEVEL OF SERVICE TRENCHES. IT IS RECOMMENDED TO PROVIDE MIN 500mm THICK GRANULAR SUB-BASE, OPSS GRANULAR B TYPE II, AND GEOTEXTILE AT SUBGRADE LEVEL TO THE SATISFACTION OF THE GEOTECHNICAL
- 10. THE PROPOSED PARKING AREA AND ACCESS ROADS SHOULD BE STRIPPED OF ALL EXISTING FILL, SURFACE AND BURIED TOPSOIL (ORGANIC) LAYERS, ORGANIC STAINED SOILS AND OTHER OBVIOUSLY UNSUITABLE MATERIAL. THE SUBGRADE SHOULD BE PROPERLY SHAPED, CROWNED, THEN PROOF ROLLED WITH A HEAVY VIBRATORY ROLLER IN THE FULL-TIME PRESENCE OF A REPRESENTATIVE OF THE GEOTECHNICAL ENGINEER'S OFFICE.
- 11. THE GRANULAR MATERIALS USED FOR PAVEMENT CONSTRUCTION SHOULD CONFORM TO ONTARIO PROVINCIAL STANDARD SPECIFICATIONS (OPSS 1010) FOR GRANULAR A AND GRANULAR B TYPE II AND SHOULD BE COMPACTED TO 100 PERCENT OF THE SPMDD.
- 12. THE ASPHALTIC CONCRETE USED, AND ITS PLACEMENT SHOULD MEET OPSS 1150 OR 1151 REQUIREMENTS. IT SHOULD BE COMPACTED FROM 92 PERCENT TO 97 PERCENT OF THE MRD (ASTM D2041). ASPHALT PLACEMENT SHOULD BE IN ACCORDANCE WITH OPSS 310 AND OPSS 313.
- 13. TO MINIMIZE SETTLEMENT OF THE PAVEMENT STRUCTURE OVER SERVICES TRENCHES, THE TRENCH BACKFILL MATERIAL WITHIN THE FROST ZONE, TO 1.8 M DEPTH BELOW FINAL GRADE, SHOULD MATCH THE EXISTING MATERIAL ALONG THE TRENCH WALLS TO MINIMIZE DIFFERENTIAL FROST HEAVING OF THE SUBGRADE SOIL, PROVIDED THIS MATERIAL IS COMPACTIBLE. OTHERWISE, FROST TAPERS MAY BE REQUIRED.
- 14. IT IS RECOMMENDED THAT ALL EXISTING STRUCTURES, VEGETATION, TOPSOIL, BURIED CONCRETE UNITS, AND DEFECTED MATERIALS, BE ENTIRELY REMOVED OF SITE FROM THE BENEATH OF THE PROPOSED PAVED AREAS.
- 15. EXISTING FILL MATERIALS CAN BE REMAINED IN PLACE IF IT IS FREE OF ORGANIC MATERIALS. THE EXISTING FILL MUST BE COMPACTED AND PROOF-ROLLED.
- 16. ALL SOFT SPOT AREAS REVEALED DURING PROOF-ROLL, ON EXISTING GRANULAR FILL AND SUBGRADE, MUST BE REPLACED WITH OPSS ACCEPTABLE GRANULAR "B" TYPE II TO A DEPTH OF AT LEAST 500 MM.
- 17. IT IS RECOMMENDED THAT DURING THE SUBGRADE PREPARATION, AT THE LOCATION OF PARKING LOTS, THE SUBGRADE TO BE SLOPPED FOR POSITIVE DRAINAGE TOWARDS THE POND.

18. GEOTEXTILE MUST BE INSTALLED ON THE SUBGRADE PRIOR TO INSTALLATION OF ANY GRANULAR MATERIALS.

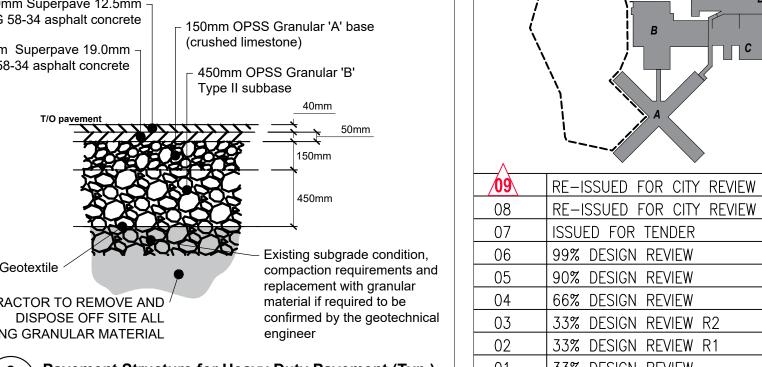

33% DESIGN REVIEW 01 2 \ Pavement Structure for Heavy Duty Pavement (Typ.) C4 / Scale: As shown Revisions Orientation

2024.01.12

2023.10.25

2023.08.18

2023.08.15

2022.12.21

2022.02.02


2021.11.08

|2021.10.08

2020.12.07

The Contractor shall check and verify all dimensions and report all errors and omissions to the IO-Owner's/MBS Designee (as applicable) for his/her written direction before proceeding with the Work.

AREA OF WORK

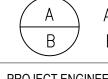

B Sheet No where detailed

PROJECT ENGINEER: CIVIL, STRUCTURAL, MECHANICAL & ELECTRICAL



Jp2g Consultants Inc. 1150 MORRISON DRIVE, SUITE 410, OTTAWA, ON K2H 8S9 PHONE: 613-828-7800 FAX: 613-828-2600



OTTAWA CARLETON DETENTION CENTRE TEMPORARY PARKING LOT EXPANSION

INNES ROAD, GLOUCESTER TOWNSHIP 10 Project No Building No

Drawing Title DETAILS AND NOTES

AS NOTED DECEMBER 2022 Drawn by Substantial Performance Date R.W. Drawing No Designed by D.N. Approved by

CADD File NAME