
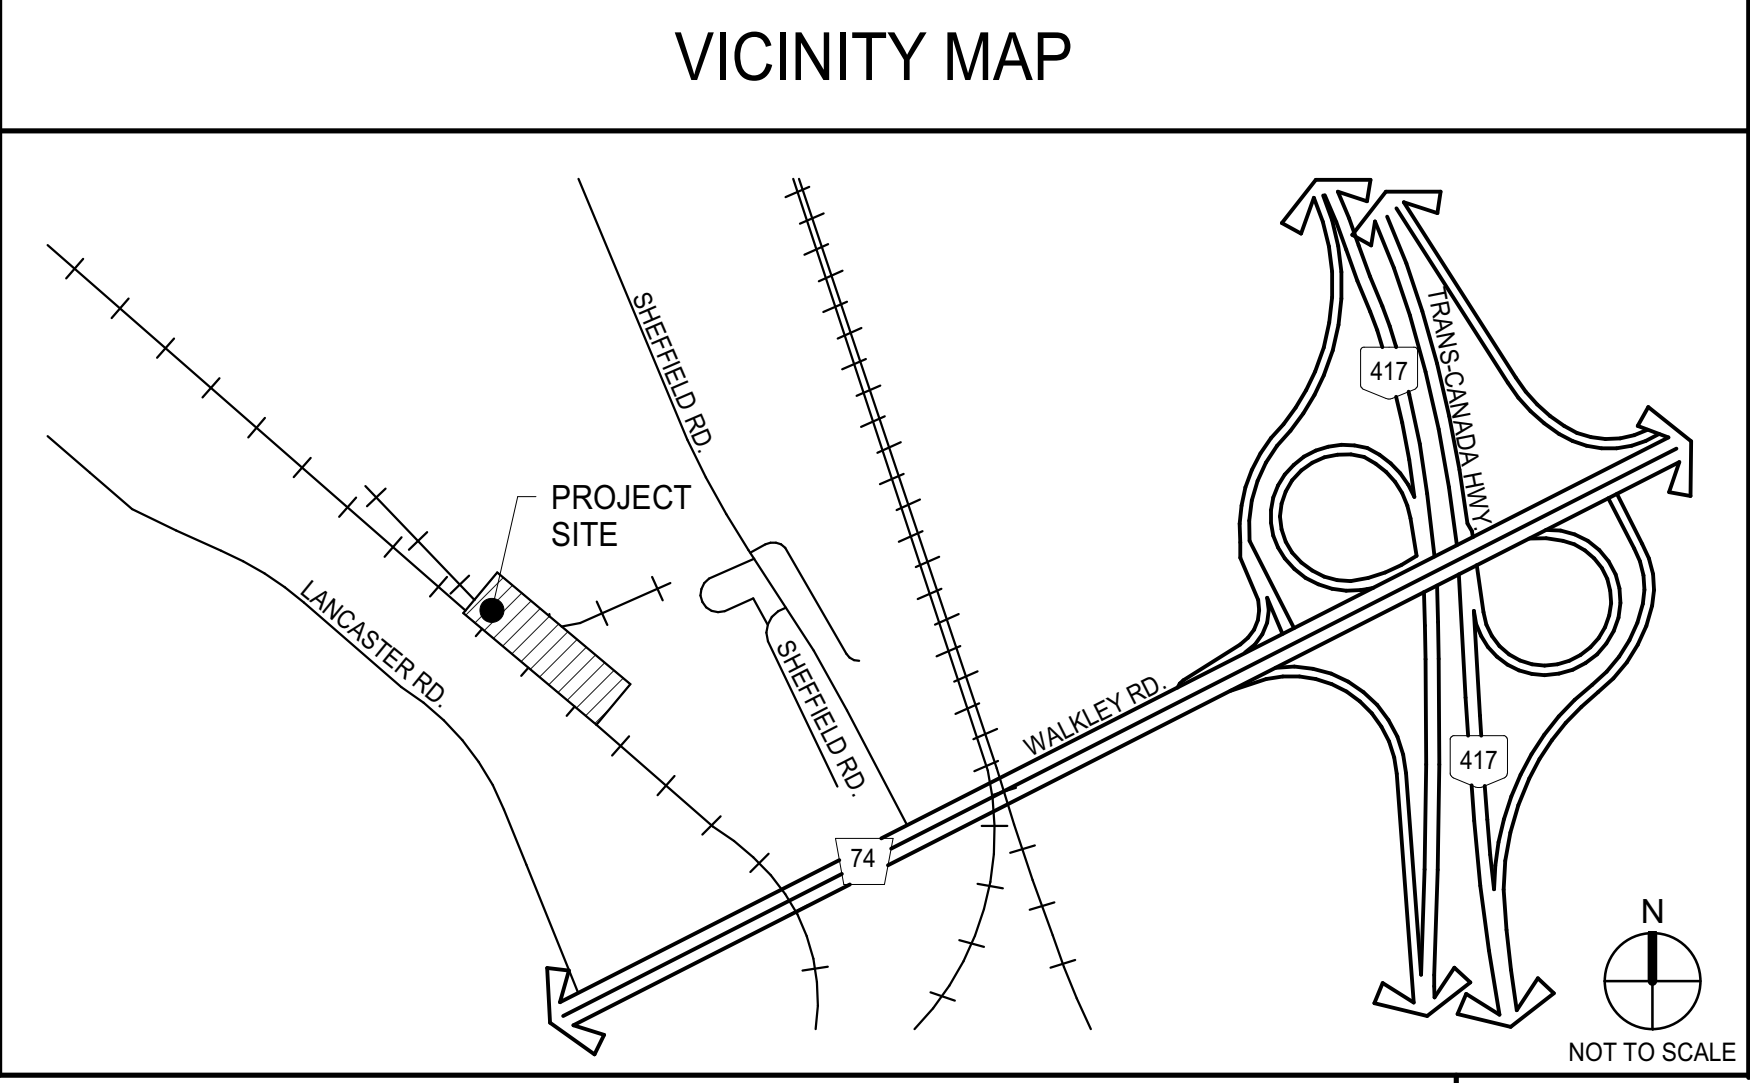


### OBC MATRIX

NAME OF PRACTICE: WARE MALCOMB (A BUSINESS NAME OF WMA INC.) CERTIFICATE OF PRACTICE NUMBER: 3619 NAME OF PROJECT: 2760-2770 SHEFFIELD ROAD LOCATION: 2760 SHEFFIELD RD. OTTAWA ON K1B 3V9, CANADA.		BUILDING CODE REFERENCE: REFERENCES ARE TO DIVISION B UNLESS NOTED. (A) FOR DIVISION A OR (C) FOR DIVISION C.																																																								
ITEM	ONTARIO BUILDING CODE DATA MATRIX PARTS 3 OR 9																																																									
1	PROJECT DESCRIPTION: <input checked="" type="checkbox"/> NEW <input type="checkbox"/> PART 11 <input type="checkbox"/> PART 3 <input type="checkbox"/> PART 9 INDUSTRIAL SHELL BUILDING <input type="checkbox"/> ADDITION 11.1 TO 11.4 1.1.2 (A) 1.1.2 (A) & 9.10.1.3 <input type="checkbox"/> CHANGE OF USE <input type="checkbox"/> ALTERATION																																																									
2	MAJOR OCCUPANCY(S) <b>GROUP F, DIVISION 2; GROUP D (SUBSIDIARY)</b>	3.1.2.1.(1)	9.10.2																																																							
3	BUILDING AREA (sq.m.) NEW: <b>10,564.4 SM</b> TOTAL: <b>10,564.4 SM</b>	1.4.1.2 (A)	1.4.1.2 (A)																																																							
4	GROSS AREA (sq.m.) NEW: <b>10,564.4 SM</b> TOTAL: <b>10,564.4 SM</b>	1.4.1.2 (A)	1.4.1.2 (A)																																																							
5	NUMBER OF STOREYS ABOVE GRADE: <b>1</b> BELOW GRADE: <b>N/A</b>	1.4.1.2 (A) & 3.2.1.1	1.4.1.2 (A) & 9.10.4																																																							
6	NUMBER OF STREETS / FIRE FIGHTER ACCESS: <b>3</b>	3.2.2.10 & 3.2.5.5	9.10.20																																																							
7	BUILDING CLASSIFICATION(S) <b>3.2.2.67 GROUP F, DIV 2, ANY HEIGHT, ANY AREA SPRINKLERED</b>	3.2.2.20-83	9.10.2																																																							
8	SPRINKLER SYSTEM PROPOSED <input checked="" type="checkbox"/> ENTIRE BUILDING <input type="checkbox"/> SELECTED COMPARTMENTS <input type="checkbox"/> SELECTED FLOOR AREAS <input type="checkbox"/> BASEMENT <input type="checkbox"/> IN LIEU OF ROOF RATING <input type="checkbox"/> NOT REQUIRED	3.2.2.20-83 3.2.1.5 3.2.2.17 INDEX	9.10.8.2  INDEX																																																							
9	STANDPIPE REQUIRED <input type="checkbox"/> YES <input checked="" type="checkbox"/> NO	3.2.9	N/A																																																							
10	FIRE ALARM REQUIRED <input type="checkbox"/> YES <input checked="" type="checkbox"/> NO	3.2.4	9.10.18																																																							
11	WATER SERVICE / SUPPLY IS ADEQUATE <input checked="" type="checkbox"/> YES <input type="checkbox"/> NO <input type="checkbox"/> N/A	3.2.5.7	N/A																																																							
12	HIGH BUILDING <input type="checkbox"/> YES <input checked="" type="checkbox"/> NO	3.2.6	N/A																																																							
13	CONSTRUCTION RESTRICTIONS <input type="checkbox"/> COMBUSTIBLE PERMITTED <input checked="" type="checkbox"/> NON-COMBUSTIBLE REQUIRED <input type="checkbox"/> BOTH ACTUAL CONSTRUCTION <input type="checkbox"/> COMBUSTIBLE <input checked="" type="checkbox"/> NON-COMBUSTIBLE <input type="checkbox"/> BOTH	3.2.2.20-83	9.10.6																																																							
14	MEZZANINE(S) AREA m2 <b>N/A</b>	3.2.1.1.(3)-(8)	9.10.4.1																																																							
15	OCCUPANT LOAD BASED ON <input type="checkbox"/> m2 / PERSON <input type="checkbox"/> DESIGN OF BUILDING 1ST FLOOR: OCCUPANCY: <b>F2/D</b> LOAD (PERSONS): <b>&lt;300</b> 2ND FLOOR: <b>XX</b> OCCUPANCY: <b>XX</b> LOAD (PERSONS): <b>XX</b>	3.1.17	9.9.1.3																																																							
16	BARRIER-FREE DESIGN <input checked="" type="checkbox"/> YES <input type="checkbox"/> NO	3.8	9.5.2																																																							
17	HAZARDOUS SUBSTANCES <input type="checkbox"/> YES <input checked="" type="checkbox"/> NO	3.3.1.2 & 3.3.1.19	9.10.1.3 (4)																																																							
18	REQUIRED FIRE RESISTANCE RATING (FRR) HORIZONTAL ASSEMBLIES FRR (HOURS) FLOORS: <b>2</b> HOURS ROOF: <b>-</b> HOURS MEZZANINE: <b>1</b> HOURS FRR OF SUPPORTING MEMBERS FLOORS: <b>2</b> HOURS ROOF: <b>-</b> HOURS MEZZANINE: <b>1</b> HOURS	LISTED DESIGN No. OR DESCRIPTION (SG-2) 3.2.2.20-83 & 3.2.1.4 LISTED DESIGN No. OR DESCRIPTION (SG-2)	9.10.8 9.10.9																																																							
19	SPATIAL SEPARATION - CONSTRUCTION OF EXTERIOR WALLS	3.2.3	9.10.14																																																							
	<table border="1"> <thead> <tr> <th>WALL</th> <th>AREA OF EBF (sq. m.)</th> <th>LD (m)</th> <th>L/H OR H/L</th> <th>PERMITTED MAX. % OF OPENINGS</th> <th>PROPOSED % OF OPENINGS</th> <th>FRR (HOURS)</th> <th>LISTED DESIGN No. OR DESCRIP.</th> <th>COMB. CONSTR.</th> <th>COMB. CONSTR. NONC. CLADDING</th> <th>NON-COMB. CONSTRUCTION</th> </tr> </thead> <tbody> <tr> <td>NORTH</td> <td>2537</td> <td>&gt;15</td> <td>-</td> <td>-</td> <td>-</td> <td>-</td> <td>-</td> <td>-</td> <td>-</td> <td>-</td> </tr> <tr> <td>SOUTH</td> <td>2537</td> <td>&gt;15</td> <td>-</td> <td>-</td> <td>-</td> <td>-</td> <td>-</td> <td>-</td> <td>-</td> <td>-</td> </tr> <tr> <td>EAST</td> <td>574</td> <td>&gt;15</td> <td>-</td> <td>-</td> <td>-</td> <td>-</td> <td>-</td> <td>-</td> <td>-</td> <td>-</td> </tr> <tr> <td>WEST</td> <td>574</td> <td>13.76</td> <td>-</td> <td>89%</td> <td>-</td> <td>-</td> <td>-</td> <td>-</td> <td>-</td> <td>-</td> </tr> </tbody> </table>	WALL	AREA OF EBF (sq. m.)	LD (m)	L/H OR H/L	PERMITTED MAX. % OF OPENINGS	PROPOSED % OF OPENINGS	FRR (HOURS)	LISTED DESIGN No. OR DESCRIP.	COMB. CONSTR.	COMB. CONSTR. NONC. CLADDING	NON-COMB. CONSTRUCTION	NORTH	2537	>15	-	-	-	-	-	-	-	-	SOUTH	2537	>15	-	-	-	-	-	-	-	-	EAST	574	>15	-	-	-	-	-	-	-	-	WEST	574	13.76	-	89%	-	-	-	-	-	-		
WALL	AREA OF EBF (sq. m.)	LD (m)	L/H OR H/L	PERMITTED MAX. % OF OPENINGS	PROPOSED % OF OPENINGS	FRR (HOURS)	LISTED DESIGN No. OR DESCRIP.	COMB. CONSTR.	COMB. CONSTR. NONC. CLADDING	NON-COMB. CONSTRUCTION																																																
NORTH	2537	>15	-	-	-	-	-	-	-	-																																																
SOUTH	2537	>15	-	-	-	-	-	-	-	-																																																
EAST	574	>15	-	-	-	-	-	-	-	-																																																
WEST	574	13.76	-	89%	-	-	-	-	-	-																																																
20	PLUMBING FIXTURE REQUIREMENTS FEMALE/MALE COUNT AT <b>XX</b> % MALE/ <b>XX</b> % FEMALE UNLESS NOTED OTHERWISE TBD	PART 3	PART 9																																																							
21	OTHERS (DESCRIBE)																																																									

# SHEFFIELD INDUSTRIAL BUILDING

2760-2770 SHEFFIELD RD. OTTAWA ON K1B 3V9, CANADA.

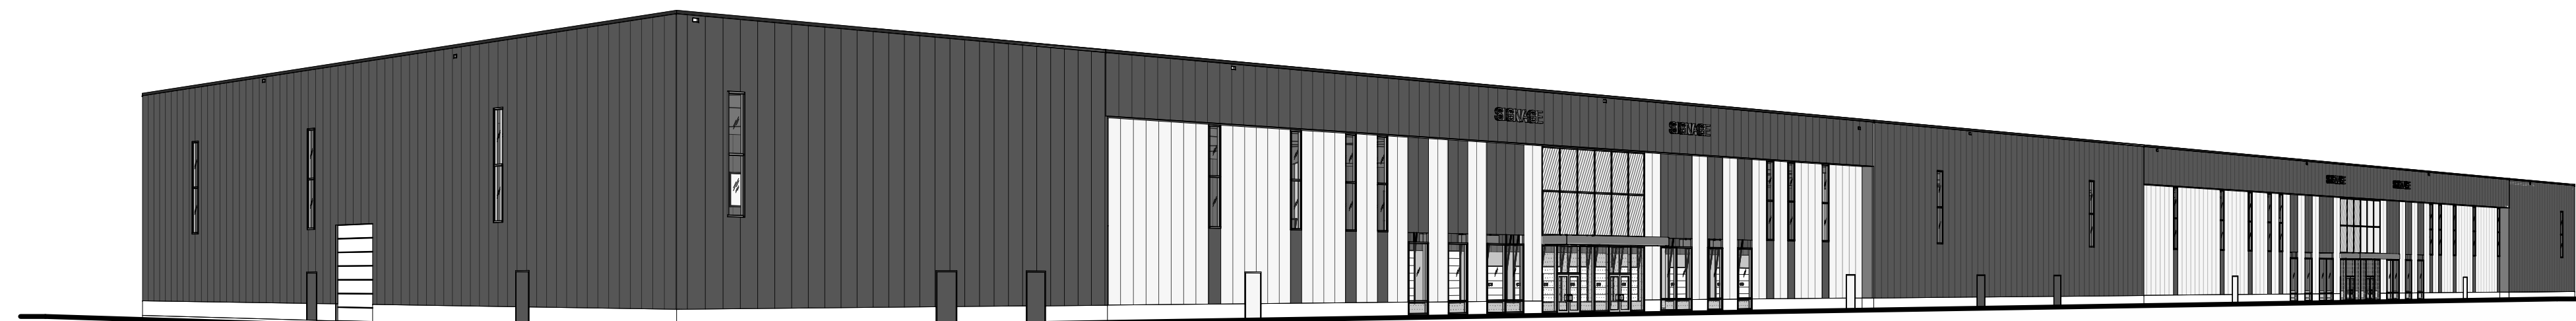

**OWNER**  
**RICHCRAFT PROPERTIES INC.**  
 2280 ST. LAURENT BLVD. SUITE 201 OTTAWA, ON K1G 4K1  
 PRIMARY CONTACT: KEVIN YEMM  
 PH: (613) 739-7111 EXT. 132  
 EMAIL: KYEMM@RICHCRAFT.COM

**OWNER'S CONSULTANTS**  
**ENVIRONMENTAL CONSULTANT**  
 PATERSON GROUP  
 9 AURIGA DRIVE, OTTAWA, ONTARIO K2E 7T9  
 PRIMARY CONTACT: MARK S. D'ARCY  
 PH: (613) 226-7381 EXT. 207  
 EMAIL: mdarcy@patersongroup.ca

**ARCHITECT'S CONSULTANTS**  
**LANDSCAPE ARCHITECT**  
 NAK DESIGN STRATEGIES  
 1285 WELLINGTON STREET WEST, OTTAWA, ONTARIO K1Y 3A8  
 PRIMARY CONTACT: PAT GAUVREAU  
 PH: (613) 237-2345 EXT. 28  
 EMAIL: pgauvreau@nak-design.com

**SHEET INDEX**

ARCHITECTURAL		TOTAL SHEETS
G010	TITLE SHEET	6
A100	SITE PLAN	
A120	FLOOR PLAN	
A190	ROOF PLAN	
A210	EXTERIOR ELEVATIONS	
A310	BUILDING SECTIONS	
ARCHITECTURAL SHEET COUNT: 6		

**ARCHITECT**  
**WARE MALCOMB**  
 1420 BLAIR TOWERS PLACE, SUITE #104, GLOUCESTER, ONTARIO, CANADA K1J 9L8  
 P 343.633.2977  
 PRIMARY CONTACT: JOHN HOLLAND  
 PH: (905) 760-1221 EXT. 2134  
 EMAIL: jholland@waremalcomb.com  
 ALTERNATE CONTACT: HARRISON WERNER  
 PH: (905) 760-1221 EXT. 2145  
 EMAIL: hwerner@waremalcomb.com

**GEOTECHNICAL ENGINEER**  
 PATERSON GROUP  
 9 AURIGA DRIVE OTTAWA, ONTARIO K2E 7T9  
 (613) 226-7381 EXT. 332  
 PRIMARY CONTACT: SCOTT DENNIS  
 PH: (613) 226-7381 EXT. 332  
 EMAIL: sdennis@patersongroup.ca

**CIVIL ENGINEER**  
 WARE MALCOMB  
 180 BASS PRO MILLS DR#103, VAUGHAN, ONTARIO L4K 0G9,  
 PRIMARY CONTACT: DAVID NEWSON  
 PH: (905) 760-1221 EXT. 2128  
 EMAIL: (905) 760-1221 EXT. 2128

**WARE MALCOMB**  
 1420 Blair Towers Place, Suite #104  
 Gloucester, Ontario, Canada K1J 9L8  
 P 343.633.2977  
 ARCHITECTURE CIVIL ENGINEERING  
 PLANNING BRANDING  
 INTERIORS BUILDING MEASUREMENT



**SHEFFIELD INDUSTRIAL BUILDING**  
 2760-2770 SHEFFIELD RD. OTTAWA ON K1B 3V9, CANADA.

**TITLE SHEET**

DATE	REMARKS
1 2023-05-17	ISSUED FOR SPA

PA/PM:	J. HOLLAND
DRAWN BY.:	D.P. / E.C.
JOB NO.:	OTW21-0002-00

**SHEET**  
**G010**

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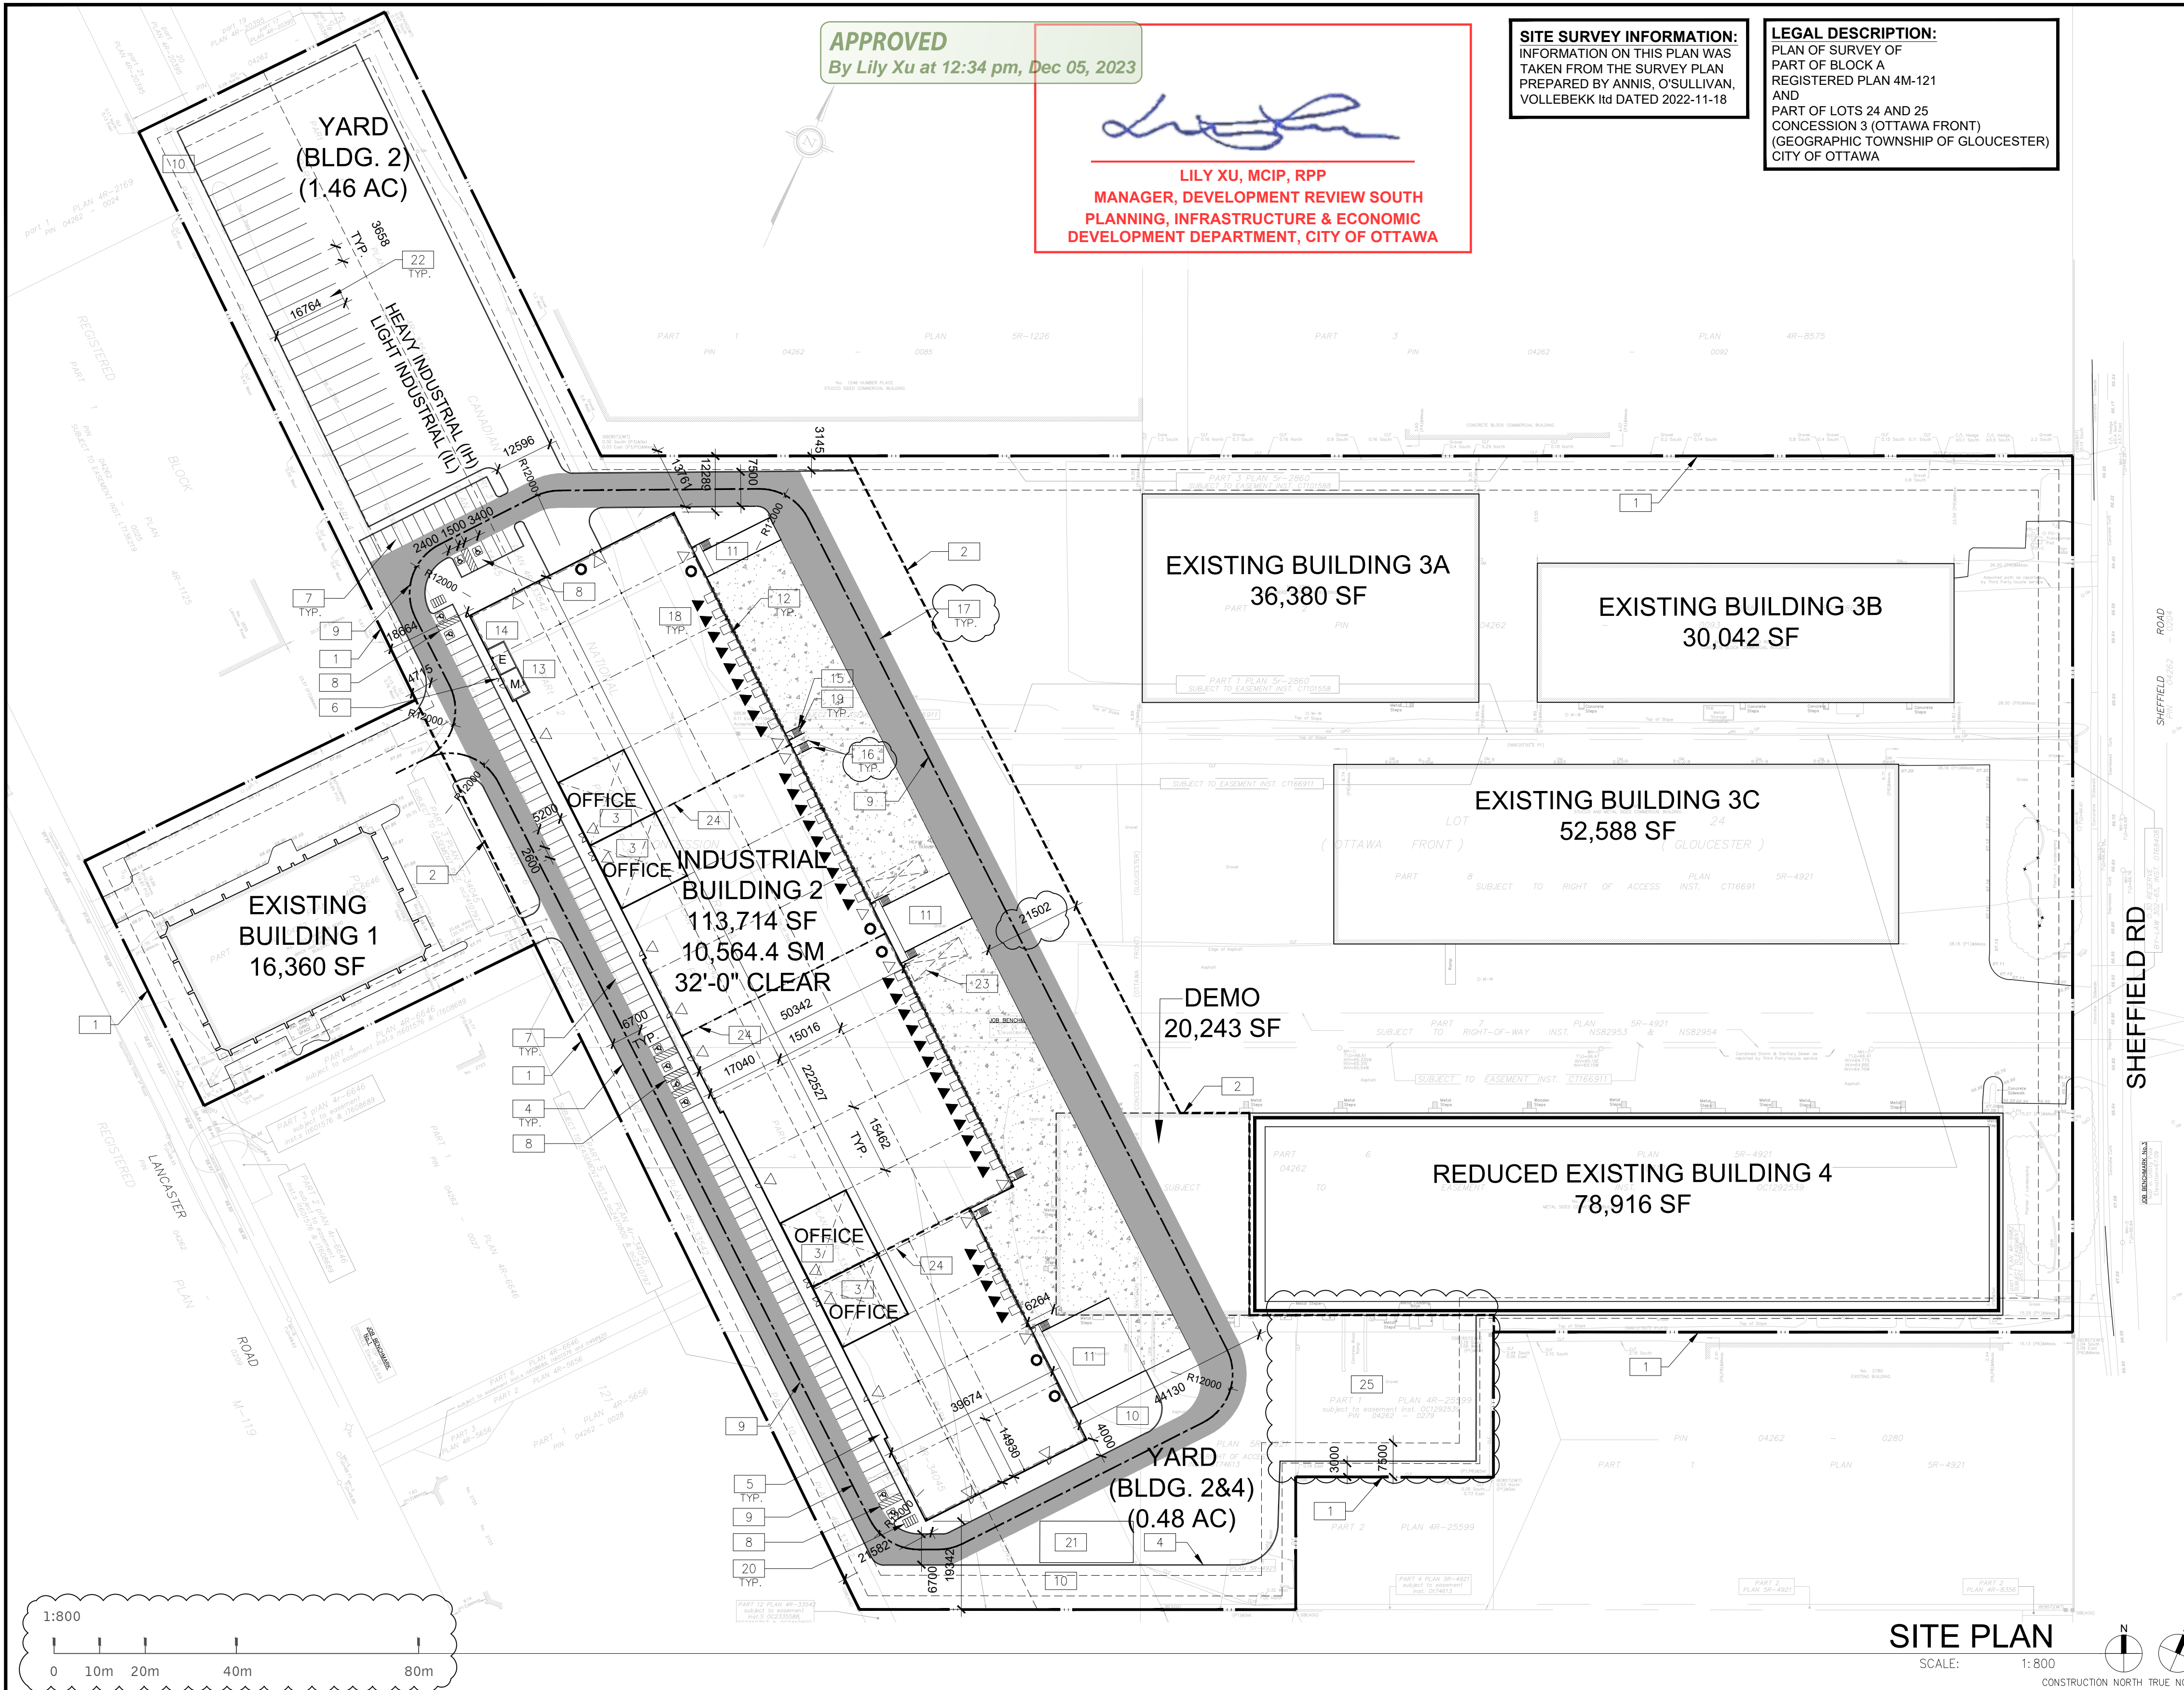


**APPROVED**  
By Lily Xu at 12:34 pm, Dec 05, 2023

*Lily Xu*  
**LILY XU, MCIP, RPP**  
MANAGER, DEVELOPMENT REVIEW SOUTH  
PLANNING, INFRASTRUCTURE & ECONOMIC  
DEVELOPMENT DEPARTMENT, CITY OF OTTAWA

**SITE SURVEY INFORMATION:**  
INFORMATION ON THIS PLAN WAS  
TAKEN FROM THE SURVEY PLAN  
PREPARED BY ANNIS, O'SULLIVAN,  
VOLLEBEKK Ltd DATED 2022-11-18

**LEGAL DESCRIPTION:**  
PLAN OF SURVEY OF  
PART OF BLOCK A  
REGISTERED PLAN 4M-121  
AND  
PART OF LOTS 24 AND 25  
CONCESSION 3 (OTTAWA FRONT)  
(GEOGRAPHIC TOWNSHIP OF GLOUCESTER)  
CITY OF OTTAWA



**OTW21-0002-00**

**SITE STATISTICS**


<b>ZONING</b>	IH/IL	
<b>GROSS SITE AREA</b>	84,452 SM	
<b>PROJECT LIMIT AREA</b>	37,191 SM	
<b>Zone Permitted Use (OTTAWA ZONING BY-LAW NO. 2008-250)</b>		
<b>Proposed Use</b>	Warehouse	
<b>Regulations (Part 11: Industrial Zones)</b>		
	<b>Proposed</b>	<b>Required IH (IL)</b>
Min. Front Yard Building Setback (m)	18.66 m	7.5 m
Min. Interior Side Yard Building Set back (m)	12.29 m	7.5 m
Min.Rear Yard Building Setback (m)	N/A	7.5 m
Min.Landscape Front Yard Setback (m)	4.72 m	3 m
Min.Landscape Side Yard Setback (m)	3.15 m	3 m
Min.Landscape Rear Yard Setback (m)	N/A	3 m
Max. Floor Space Index	0.12	2
Max. Building Height	12 m	22 m (18m)
<b>BUILDING FLOOR AREA</b>		
Building 2		
Warehouse Area	9,684.40m <sup>2</sup>	
Office Area	880.00m <sup>2</sup>	
<b>TOTAL BUILDING GFA</b>	<b>10,564.40m<sup>2</sup></b>	
<b>PARKING REQUIREMENT</b>		
	<b>PROPOSED</b>	<b>REQUIRED</b>
Warehouse GFA @ 0.8 Spaces per 100m <sup>2</sup> , first 5000m <sup>2</sup>	99	63
Warehouse GFA @ 0.4 Spaces per 100m <sup>2</sup> , above 5000m <sup>2</sup>	99	63
<b>Total No. of Parking Spaces</b>	<b>99</b>	<b>63</b>
Barrier Free Parking Spaces	10	5
Parking Stall Dimensions	2.6 m X 5.2 m	
Barrier Free Parking Stall Type A	3.4m X 5.2m	
Barrier Free Parking Stall Type B	2.4m X 5.2m	
Bicycle Parking Space Dimensions	1.8m X 0.6m	
No. Of Bicycle Parking (Warehouse: 1 per 2000m <sup>2</sup> , Office 1 per 250m <sup>2</sup> )	10	9
Loading Space Dimensions	3.5m X 9.0m	
Oversized Loading Space Dimensions	4.3m X 13.0m	
No. Of Loading Spaces	35	2
No. Of Oversized Loading Spaces	2	2
Trailer Parking	26	N/A
<b>DOCK STATISTICS</b>		
Proposed		
DOCK-HIGH DOORS	35	
OVER-HEAD DOORS	6	

**WARE MALCOMB**  
ARCHITECTURE  
PLANNING  
INTERIORS  
CIVIL ENGINEERING  
BRANDING  
BUILDING MEASUREMENT  
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Gloicester, Ontario, Canada K1J 9L8  
P 343.633.2977

**ONTARIO ASSOCIATION OF ARCHITECTS**  
JOHN P. HOLLAND  
LICENCE 8649




**SHEFFIELD INDUSTRIAL BUILDING**  
2760-2770 SHEFFIELD RD.  
OTTAWA  
ON K1B 3V9, CANADA.

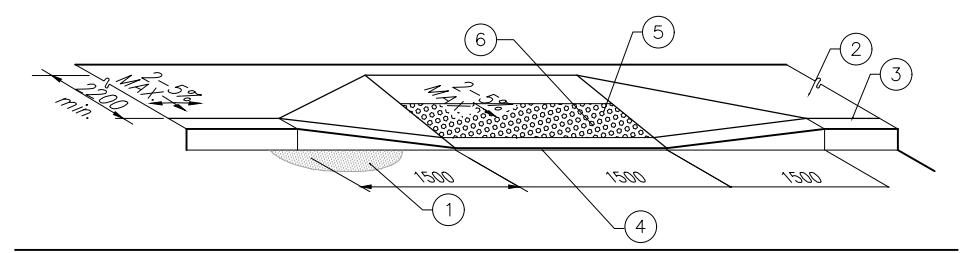

- 1 PAVEMENT
- 2 ACCESSIBLE ROUTE OF PEDESTRIAN TRAVEL 2200mm MIN. (UNLESS OTHERWISE NOTED ON PLANS)
- 3 TOP FACE OF CURB
- 4 DEPRESSED CURB
- 5 TRUNCATED DOMES WITH A HEIGHT OF 4.5-5.5mm, BASE DIAMETER OF 21-25mm, REGULAR SPACING PATTERN AT 55-60mm ON CENTER
- 6 A MINIMUM 600mm WIDE SECTION DETECTABLE WARNING SURFACE SHALL BE PROVIDED WHEN FLAT TRAVEL SURFACE ADJACENT TO A VEHICULAR WAY (0mm CURB FACE)

**ACCESSIBLE CURB RAMP**  
SCALE: N.T.S.

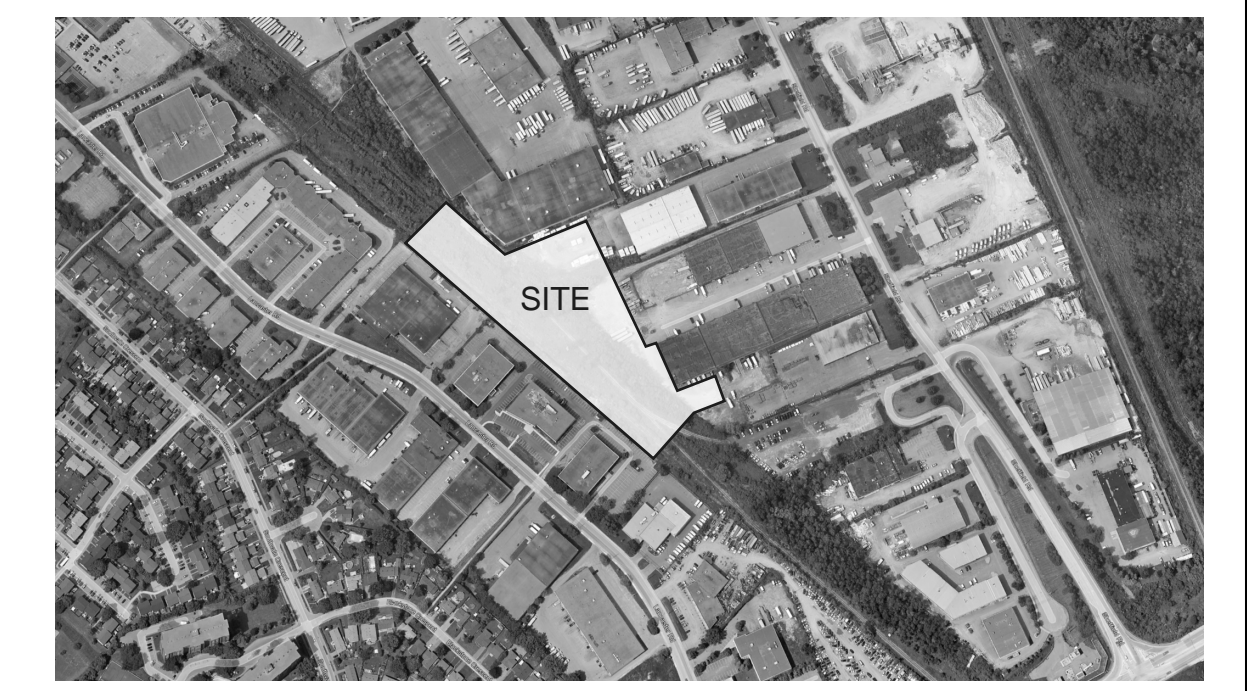

**KEY PLAN**  
SCALE: N.T.S.

**SITE PLAN NOTES**


- 1 PROPERTY LINE
- 2 PROJECT LIMIT LINE
- 3 PRINCIPLE ENTRY - TENANT FIT-UP SUBJECT TO INTERIOR ALTERATION PERMIT
- 4 150mm WIDE CURB TYPICAL
- 5 SIDEWALK - SEE LANDSCAPE DWGS FOR CONSTRUCTION DETAILS
- 6 FIRE DEPARTMENT/SIAMESE CONNECTION
- 7 2600x5200mm PARKING STALL, PAINTED PARKING STRIPING PER CITY OF OTTAWA ZONING BY-LAW NO. 2008-250
- 8 TYPICAL ACCESSIBLE PARKING STALLS, PAINTED PARKING STRIPING PER BY-LAW OTTAWA ZONING BY-LAW NO. 2008-250. EACH PAIR OF SHARED STALLS TO HAVE TYPE A: 3.4m X 5.2m AND TYPE B: 2.4m X 5.2m WITH 1.5m WIDE PAINTED BARRIER FREE AISLE AND SIGNAGE REFER TO ONTARIO INTEGRATED ACCESSIBILITY STANDARDS.
- 9 FIRE ACCESS ROUTE W/ 12.0M TURNING RADIUS (---)
- 10 LANDSCAPE AREA - SEE LANDSCAPE DRAWINGS
- 11 DRIVE-IN RAMP BOUNDED BY RETAINING WALLS WITH GUARDRAILS WHERE GRADE CHANGE IS MORE THAN 600mm - REFER TO CIVIL DWGS
- 12 12.0m x 3.5m TRUCK LOADING SPACE (TYP.)
- 13 PROPOSED LOCATION OF MECHANICAL RM

- 14 PROPOSED LOCATION OF ELECTRICAL RM
- 15 GALVANIZED STEEL GUARDRAIL WITH HANDRAIL
- 16 STEEL BOLLARD
- 17 SHADED AREA DENOTES HEAVY DUTY ASPHALT, TYPICAL FOR ALL AREAS REQUIRING FIRE OR TRACTOR TRUCK ACCESS.
- 18 TRUCK LOADING DOCK (TYP.)
- 19 EXTERIOR GALVANIZED STEEL STAIRS
- 20 GALV. BICYCLE RACKS - SEE LANDSCAPE DRAWINGS
- 21 SNOW STORAGE AREA
- 22 TRUCK TRAILER PARKING
- 23 3m x 4.3m OVERSIZED TRUCK LOADING SPACE
- 24 FUTURE TENANT DEMISING WALL, SUBJECT TO TENANT FIT UP
- 25 EXISTING TRUCK CURB BEHIND BUILDING 4 TO BE REPAVED.

**SITE LEGEND**


- NEW HEAVY DUTY PAVEMENT (HATCHED)
- NEW LANDSCAPED AREA (HATCHED)
- NEW RIVER STONE AREA (HATCHED)
- PAINTED DIAGONAL LINES WHERE INDICATED
- FUTURE EV PARKING STALLS
- PROPERTY LINE
- SITE BOUNDARY LINE
- GAS METER LOCATION.
- FIRE DEPT CONNECTION (VERIFY LOCATION WITH CIVIL DRAWINGS)
- EXISTING FIRE HYDRANT (VERIFY LOCATION WITH CIVIL DRAWINGS)
- PROPOSED FIRE HYDRANT
- LIGHT POLE
- WALL MOUNTED LIGHT
- MH DENOTES MANHOLE
- PROPOSED CATCHBASIN
- TACTILE INDICATORS AT DEPRESSED CURB
- BICYCLE RACK (1800 x 600 PER BIKE)
- MAN DOOR
- DOCK HIGH TRUCK DOOR
- GRADE LEVEL TRUCK DOOR
- FIRE ROUTE SIGNS
- PYLON SIGNAGE
- CONCRETE SIDEWALK
- ASPHALT PATHWAY
- STONE DUST PATHWAY



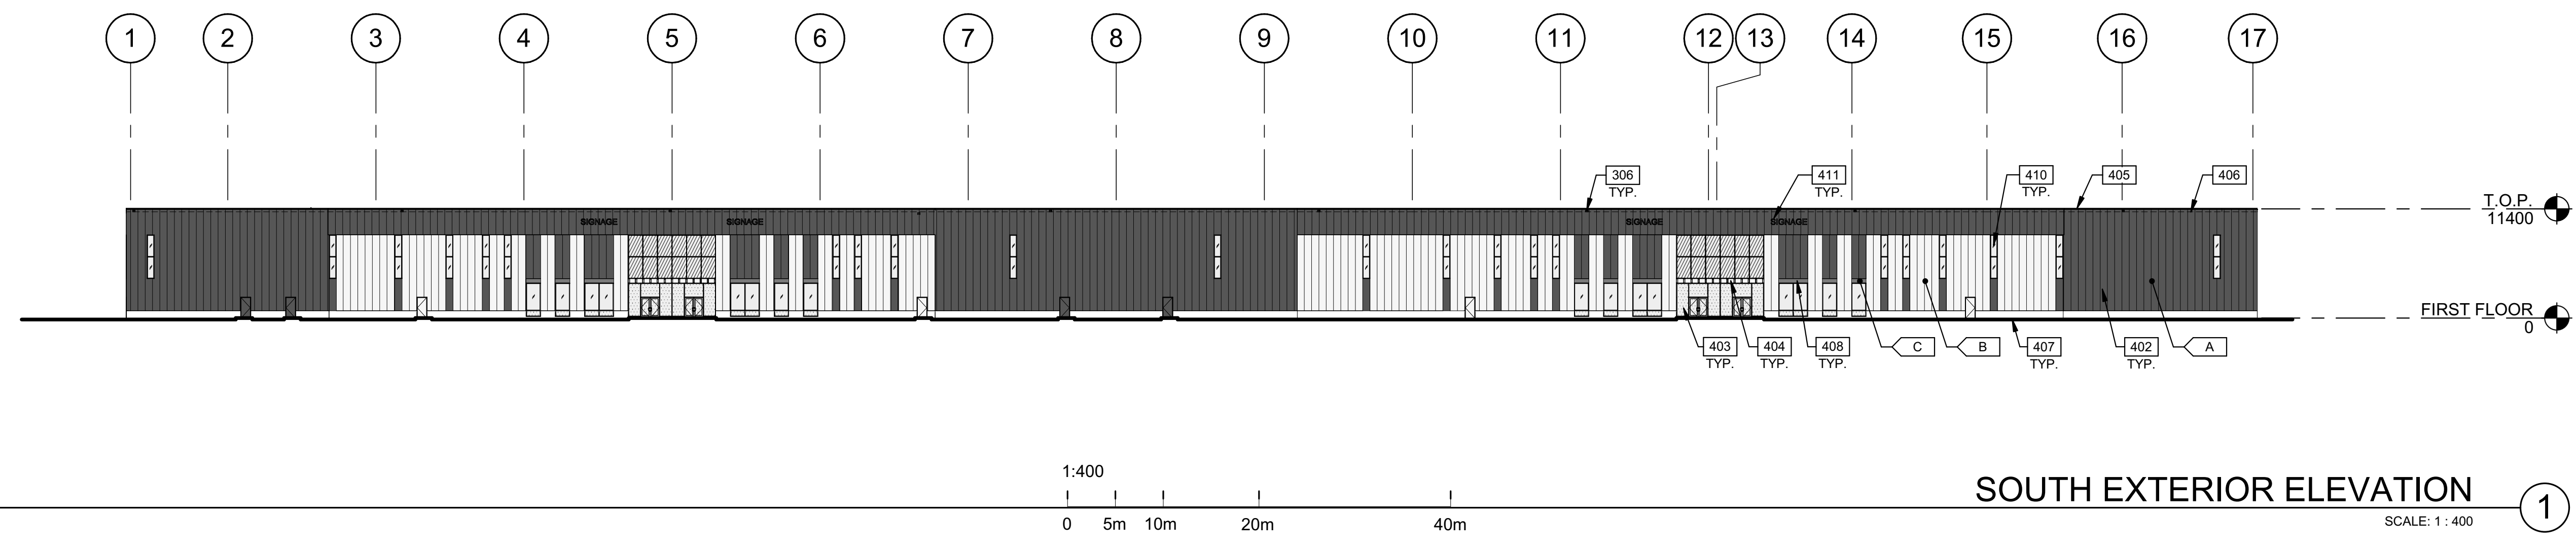


**SOUTH EXTERIOR ELEVATION**

SCALE: 1 : 400

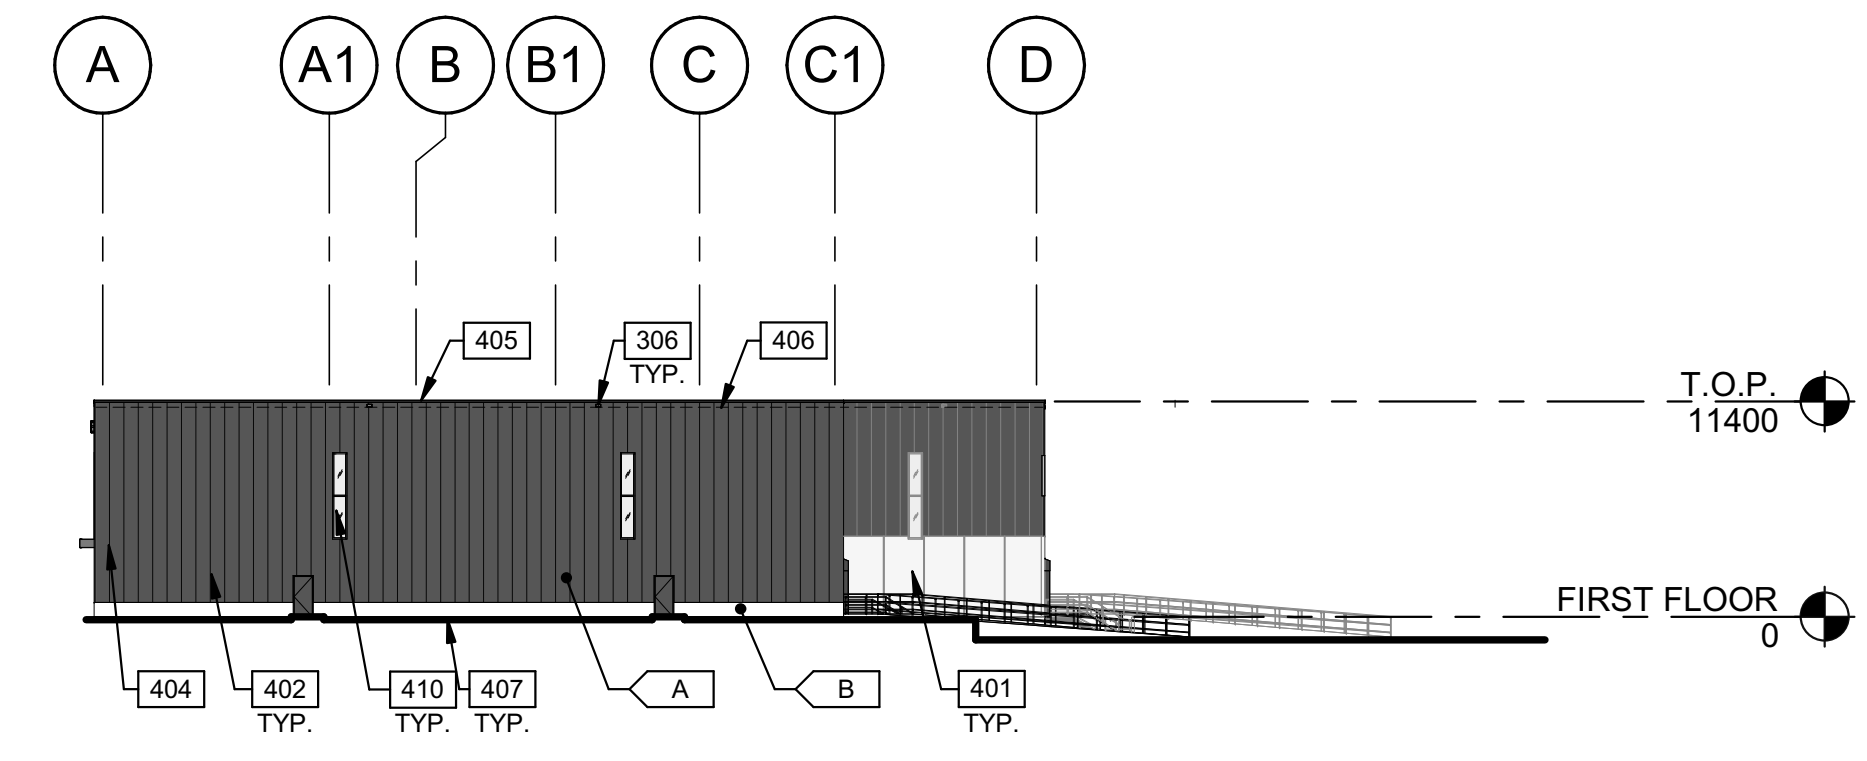


**EAST EXTERIOR ELEVATION**

SCALE: 1 : 400

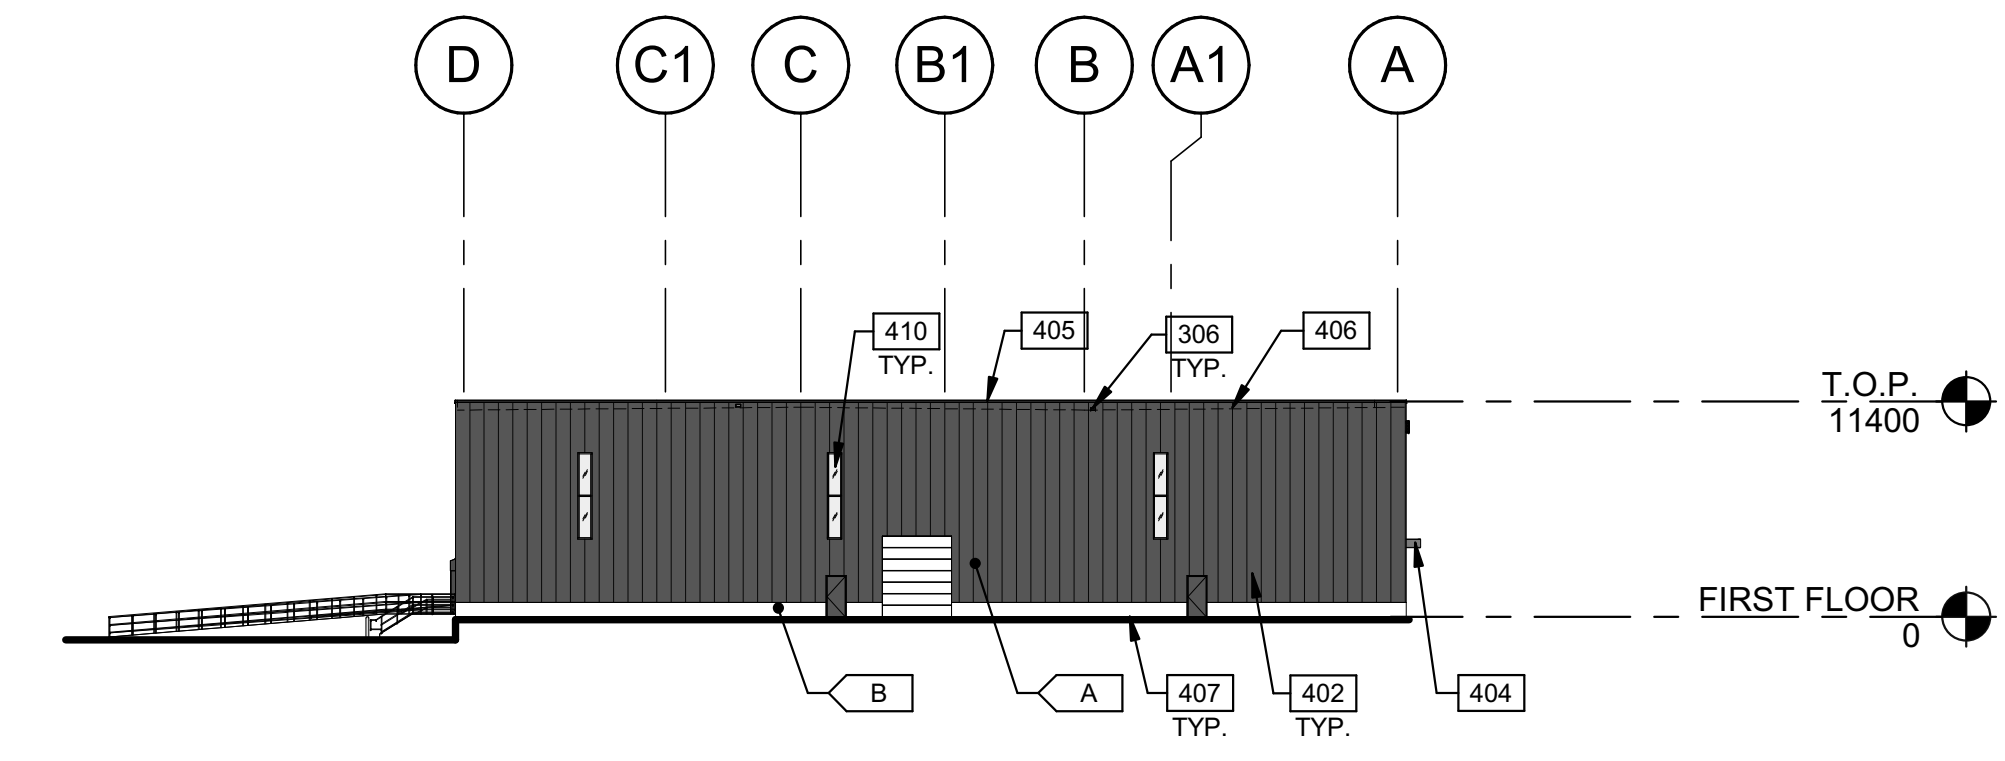

**WEST EXTERIOR ELEVATION**

SCALE: 1 : 400

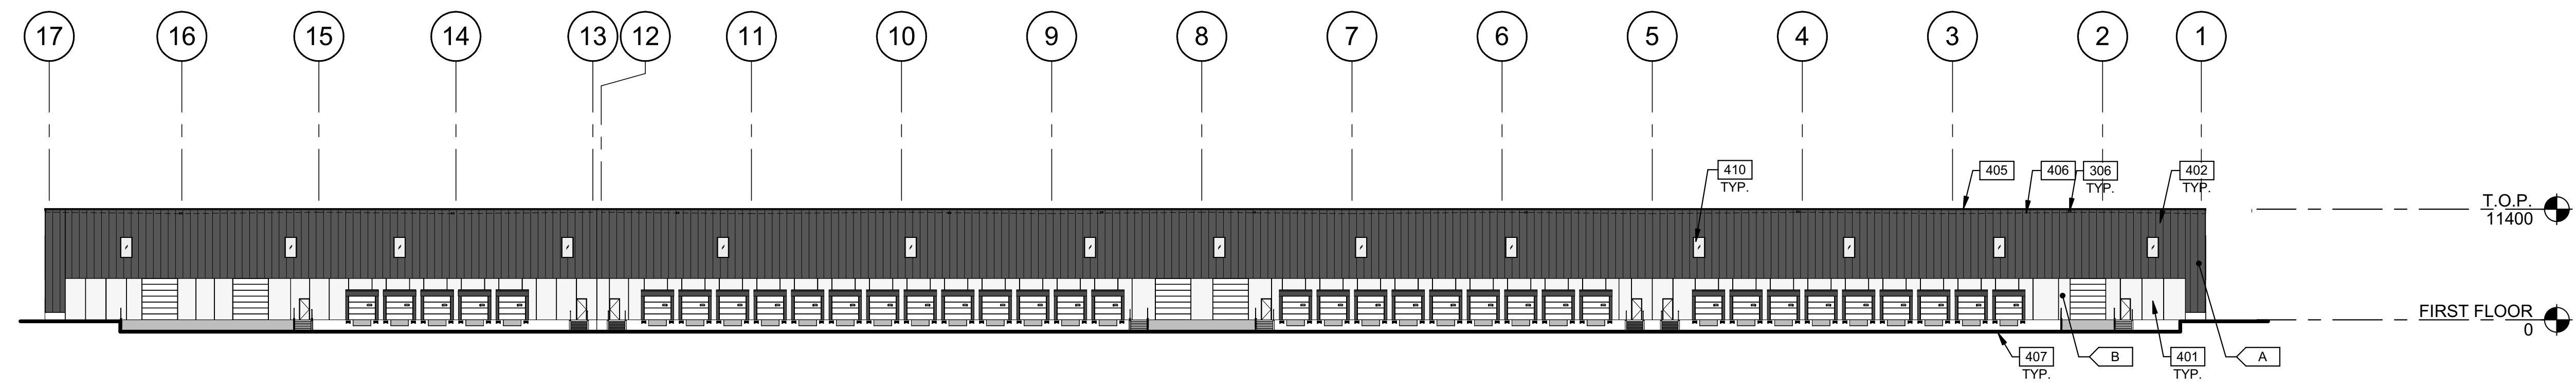

**NORTH EXTERIOR ELEVATION**

SCALE: 1 : 400

**LEGENDS**

- GLASS:**
- VISION GLASS
  - SPANDREL GLASS
  - TEMPERED GLASS

- COLOURS:**
- BASE COLOUR: BLACK
  - SECONDARY COLOUR: WHITE
  - ACCENT COLOUR: BRONZE

**KEYNOTES**

- 306 OVERFLOW SCUPPER.
- 401 PRECAST INSULATED CONCRETE WALL PANEL SYSTEM.
- 402 INSULATED METAL PANEL.
- 403 CURTAIN WALL GLAZING SYSTEM.
- 404 CANOPY WITH HSS PROFILE.
- 405 CONTINUOUS METAL CAP FLASHING, PAINTED TO MATCH ADJACENT WALL.
- 406 ROOF LINE BEYOND.
- 407 GRADE LINE VARIES.
- 408 ALUMINUM COMPOSITE METAL PANEL.
- 410 CLERESTORY WINDOW.
- 411 TENANT SIGNAGE.

**APPROVED**  
By Lily Xu at 12:35 pm, Dec 05, 2023

**LILY XU, MCIP, RPP**  
MANAGER, DEVELOPMENT REVIEW SOUTH  
PLANNING, INFRASTRUCTURE & ECONOMIC  
DEVELOPMENT DEPARTMENT, CITY OF OTTAWA

**WARE MALCOMB**  
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ONTARIO ASSOCIATION  
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ARCHITECTS  
JOHN P. HOLLAND  
LICENCE  
8649

**RICHCRAFT**


**SHEFFIELD INDUSTRIAL BUILDING**  
2760-2770 SHEFFIELD RD.  
OTTAWA  
ON K1B 3V9, CANADA.

EXTERIOR ELEVATIONS		REMARKS
DATE	ISSUED FOR	
1	2023-05-17	


PA/PM:	J. HOLLAND
DRAWN BY.:	D.P. / E.C.
JOB NO.:	OTW21-0002-00

SHEET  
**A210**

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**BUILDING SECTION 1**  
SCALE: 1 : 400

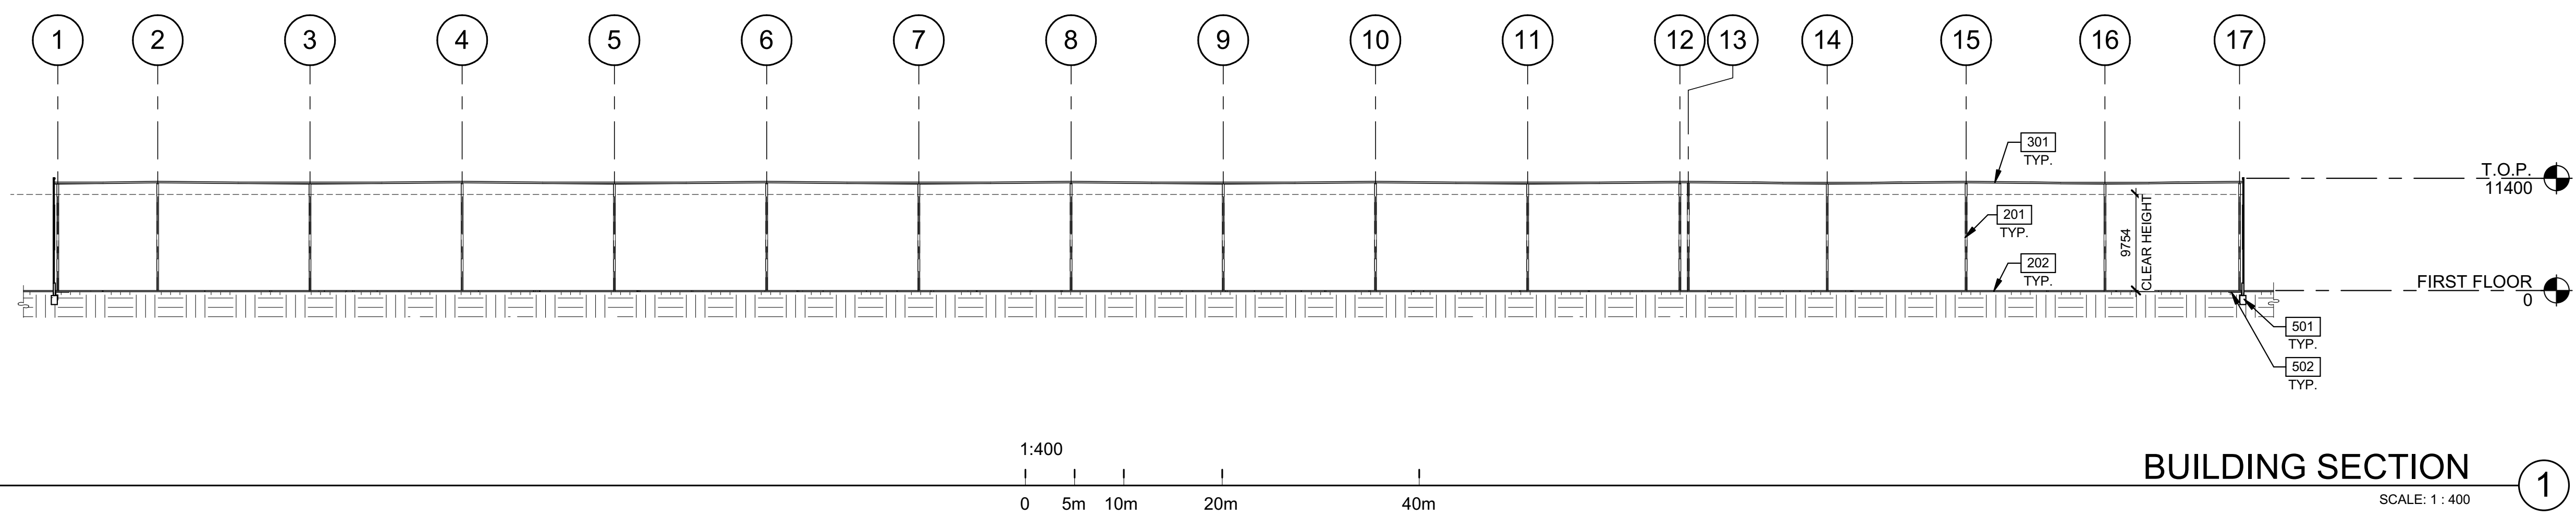

**BUILDING SECTION 2**  
SCALE: 1 : 400

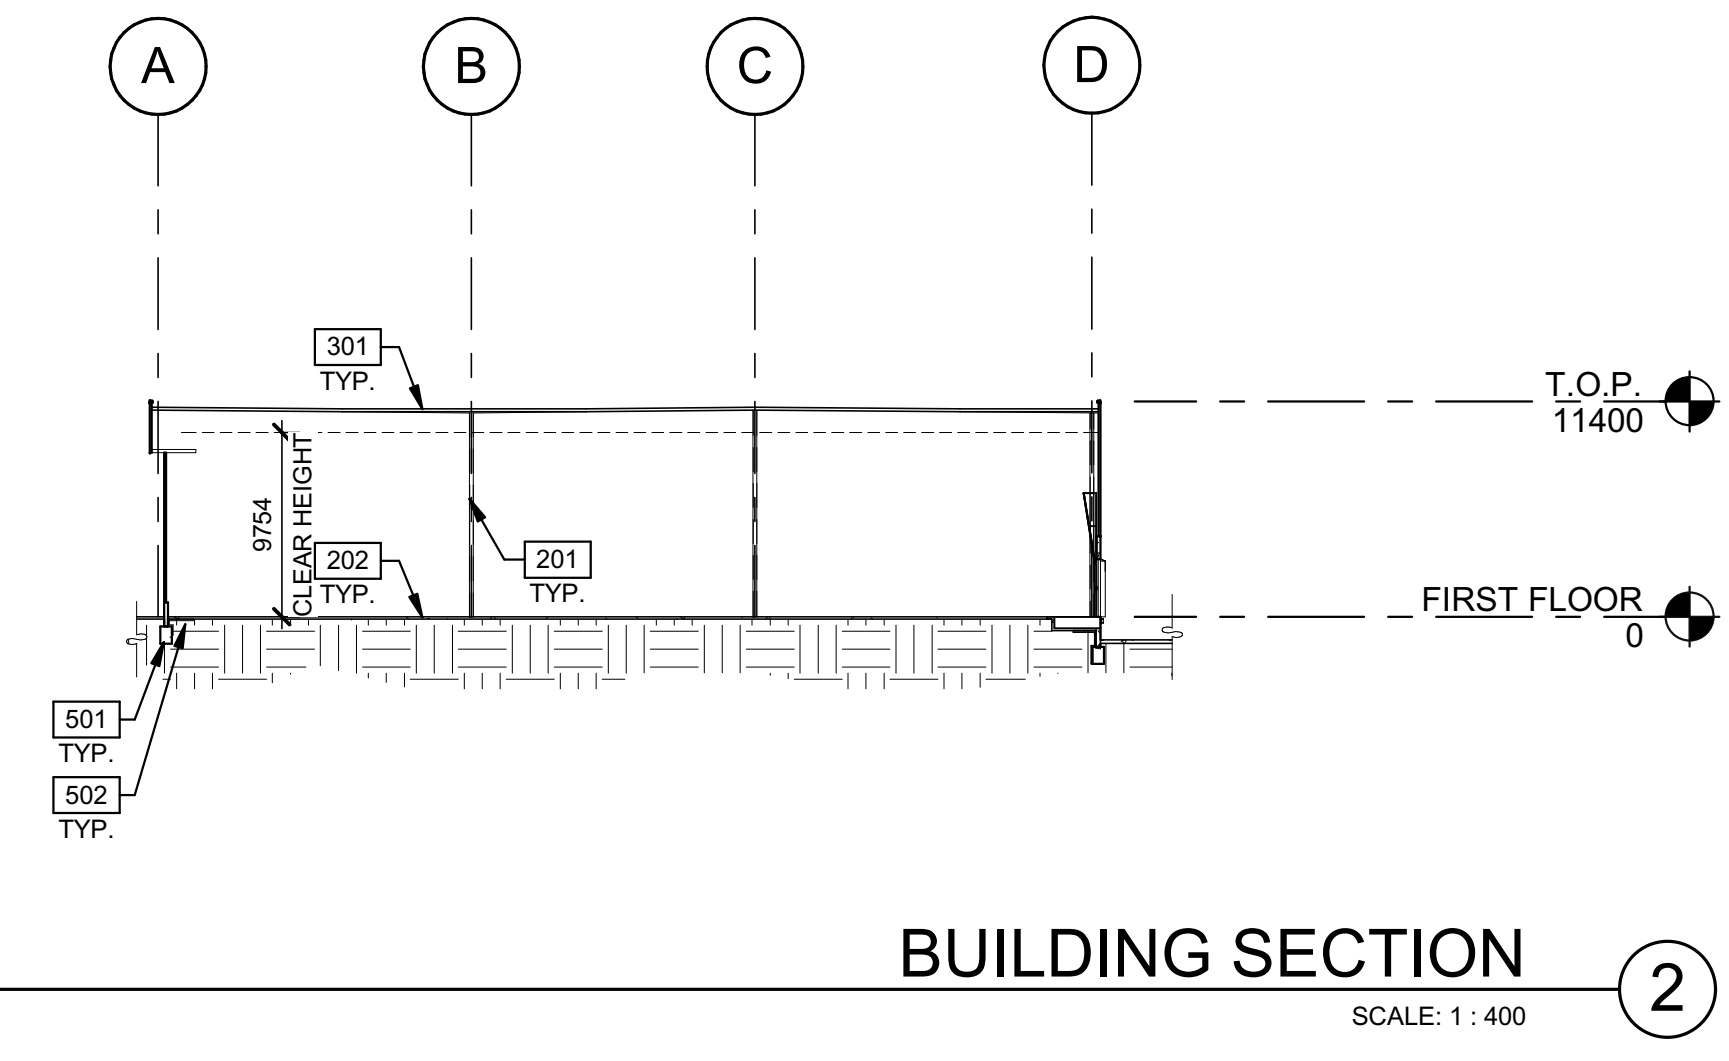**KEYNOTES**

- 201 STRUCTURAL STEEL COLUMN.
- 202 CONCRETE SLAB.
- 301 2-PLY MEMBRANE ON 6" POLYISO INSULATION.
- 501 CONCRETE FOOTING.
- 502 PROVIDE RIGID INSULATION AT FOOTINGS AND WALL PANELS BELOW SLAB.

**WARE MALCOMB**  
 ARCHITECTURE  
 CIVIL ENGINEERING  
 PLANNING  
 INTERIORS  
 BRANDING  
 BUILDING MEASUREMENT

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 LICENCE  
 8649

**RICHCRAFT**

**SHEFFIELD INDUSTRIAL BUILDING**  
 2760-2770 SHEFFIELD RD.  
 OTTAWA  
 ON K1B 3V9, CANADA.

BUILDING SECTIONS		REMARKS
DATE	ISSUED FOR	
1	2023-05-17	ISSUED FOR SPA

PA/PM:	J. HOLLAND
DRAWN BY.:	D.P. / E.C.
JOB NO.:	OTW21-0002-00

SHEET  
**A310**

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