
WARE MALCOMB 180 BASS PRO MILLS DRIVE, UNIT 103 VAUGHAN, ON, L4K 0G9

ARCHITECT:

WARE MALCOMB 180 BASS PRO MILLS DRIVE, UNIT 103 VAUGHAN, ON, L4K 0G9

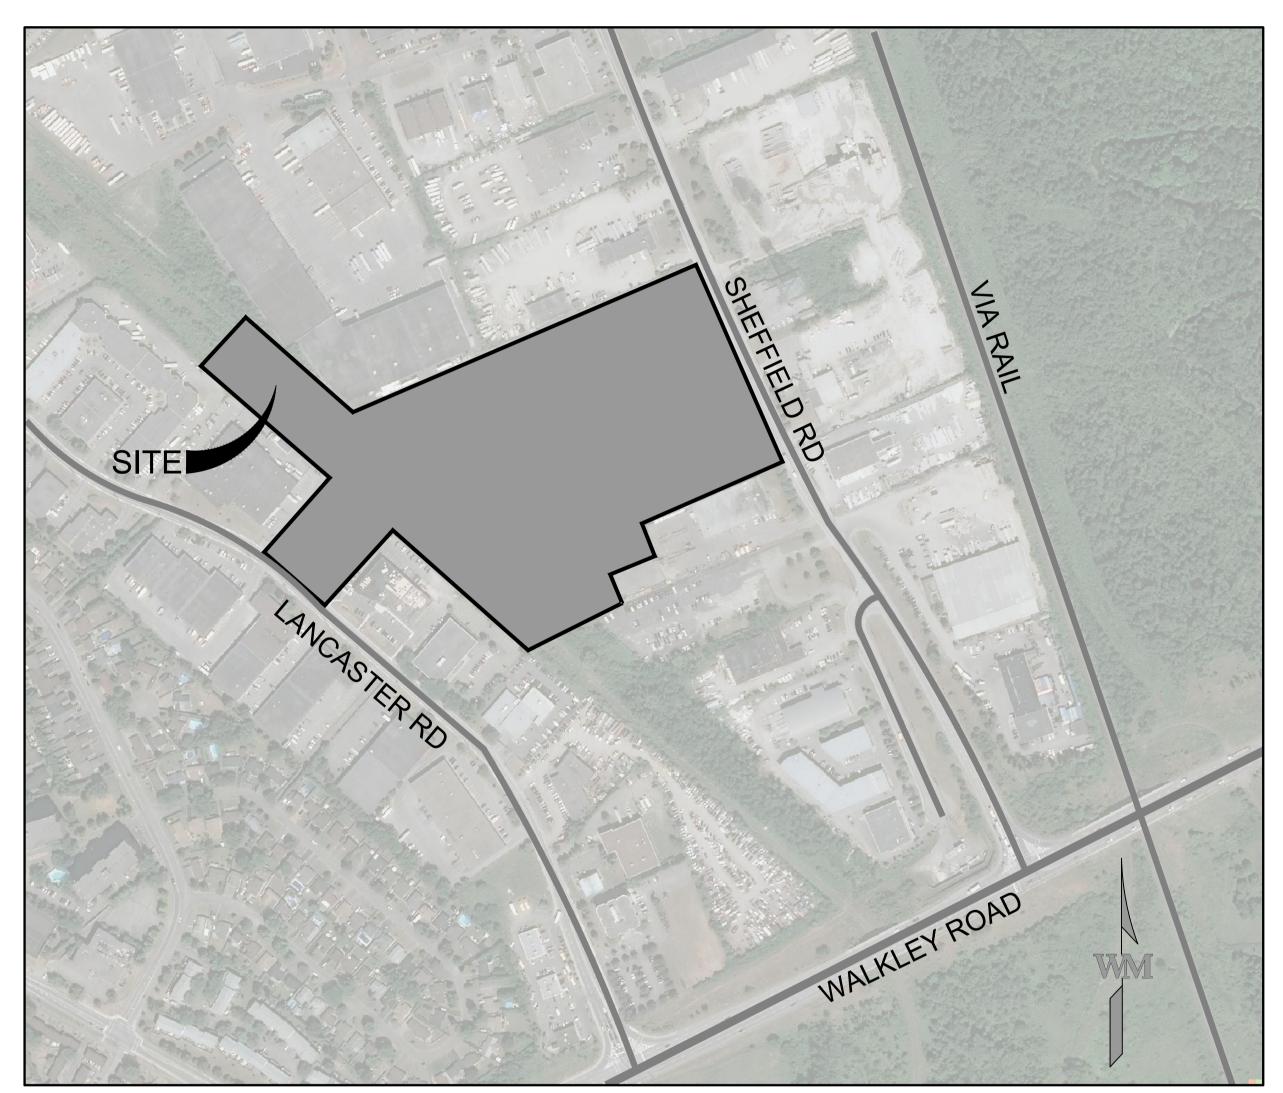

KEY PLAN SCALE N.T.S.

PREPARED BY: ONTARIO LAND SURVEYOR

ELEVATIONS SHOWN ARE GEODETIC AND ARE

BASIS OF BEARINGS

2016 REAL TIME NETWORK GPS OBSERVATIONS AND ARE REFERENCED TO SPECIFIED CONTROL

SHEET INDEX

NOTES

ESC & CONSTRUCTION MANAGEMENT PLAN

SURVEYOR

DATE: NOVEMBER 18, 2022

BENCHMARK

REFEREED TO THE CGVD28 GEODETIC DATUM.

BEARINGS ARE GRID, DERIVED FROM CAN-NET POINTS 01919680105 AND 019198434761, MTM ZONE 9 (76*30' WEST LONGITUDE) NAD-83.

COVER SHEET C1.0

C1.1

PRE-DEVELOPMENT DRAINAGE PLAN POST DEVELOPMENT DRAINAGE PLAN C3.0

GRADING PLAN SERVICING PLAN C5.0

C7.0 DETAILS FIELD

WARE MALCOMB




OF WARE MALCOME

2023-10-20

LEGEND:

DRAINAGE AREA BOUNDARY

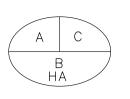

A=DRAINAGE AREA ID B=DRAINAGE AREA (HA) C=RUNOFF COEFFICIENT




OVERLAND FLOW ROUTE

WARE MALCOMB
LEADING DESIGN FOR COMMERCIAL REAL ESTATE

FOR AND ON BEHALF OF WARE MALCOMB

PLAN FIELD ROAD ONTARIO - DRAINAGE I SHEF DE

PA / PM: DRAWN BY: 2023-10-20

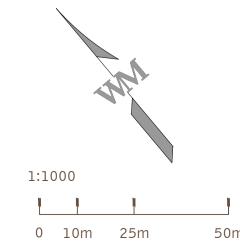

WARE MALCOMB assumes no responsibility for utility locations. The utilities shown on this drawing have been plotted from the best available information. It is, however, the contractors responsibility to field verify the location of all utilities prior to the commencement of any construction.

WARE MALCOMB
LEADING DESIGN FOR COMMERCIAL REAL ESTATE

CAUTION: IF THIS LINE IS NOT 100mm THIS IS A REDUCED PRINT -

unit 103
vaughan ontario I4k 5w4
5 905.760.1221
waremalcomb.com

N.H. ITZKOVSKY 100175130

FOR AND ON BEHALF OF WARE MALCOMB


2760-2770 SHEFFIELD ROAD OTTAWA, ONTARIO OST DEVELOPMENT DRAINAGE PLA

DATE REMARKS
2023-10-20 ISSUED FOR SITE PLAN APPROVAL

JOB NO.: OTW21-0002
PA / PM: NI
DRAWN BY: SJ
DATE: 2023-10-20

C3.0


Sheet 4 of 10

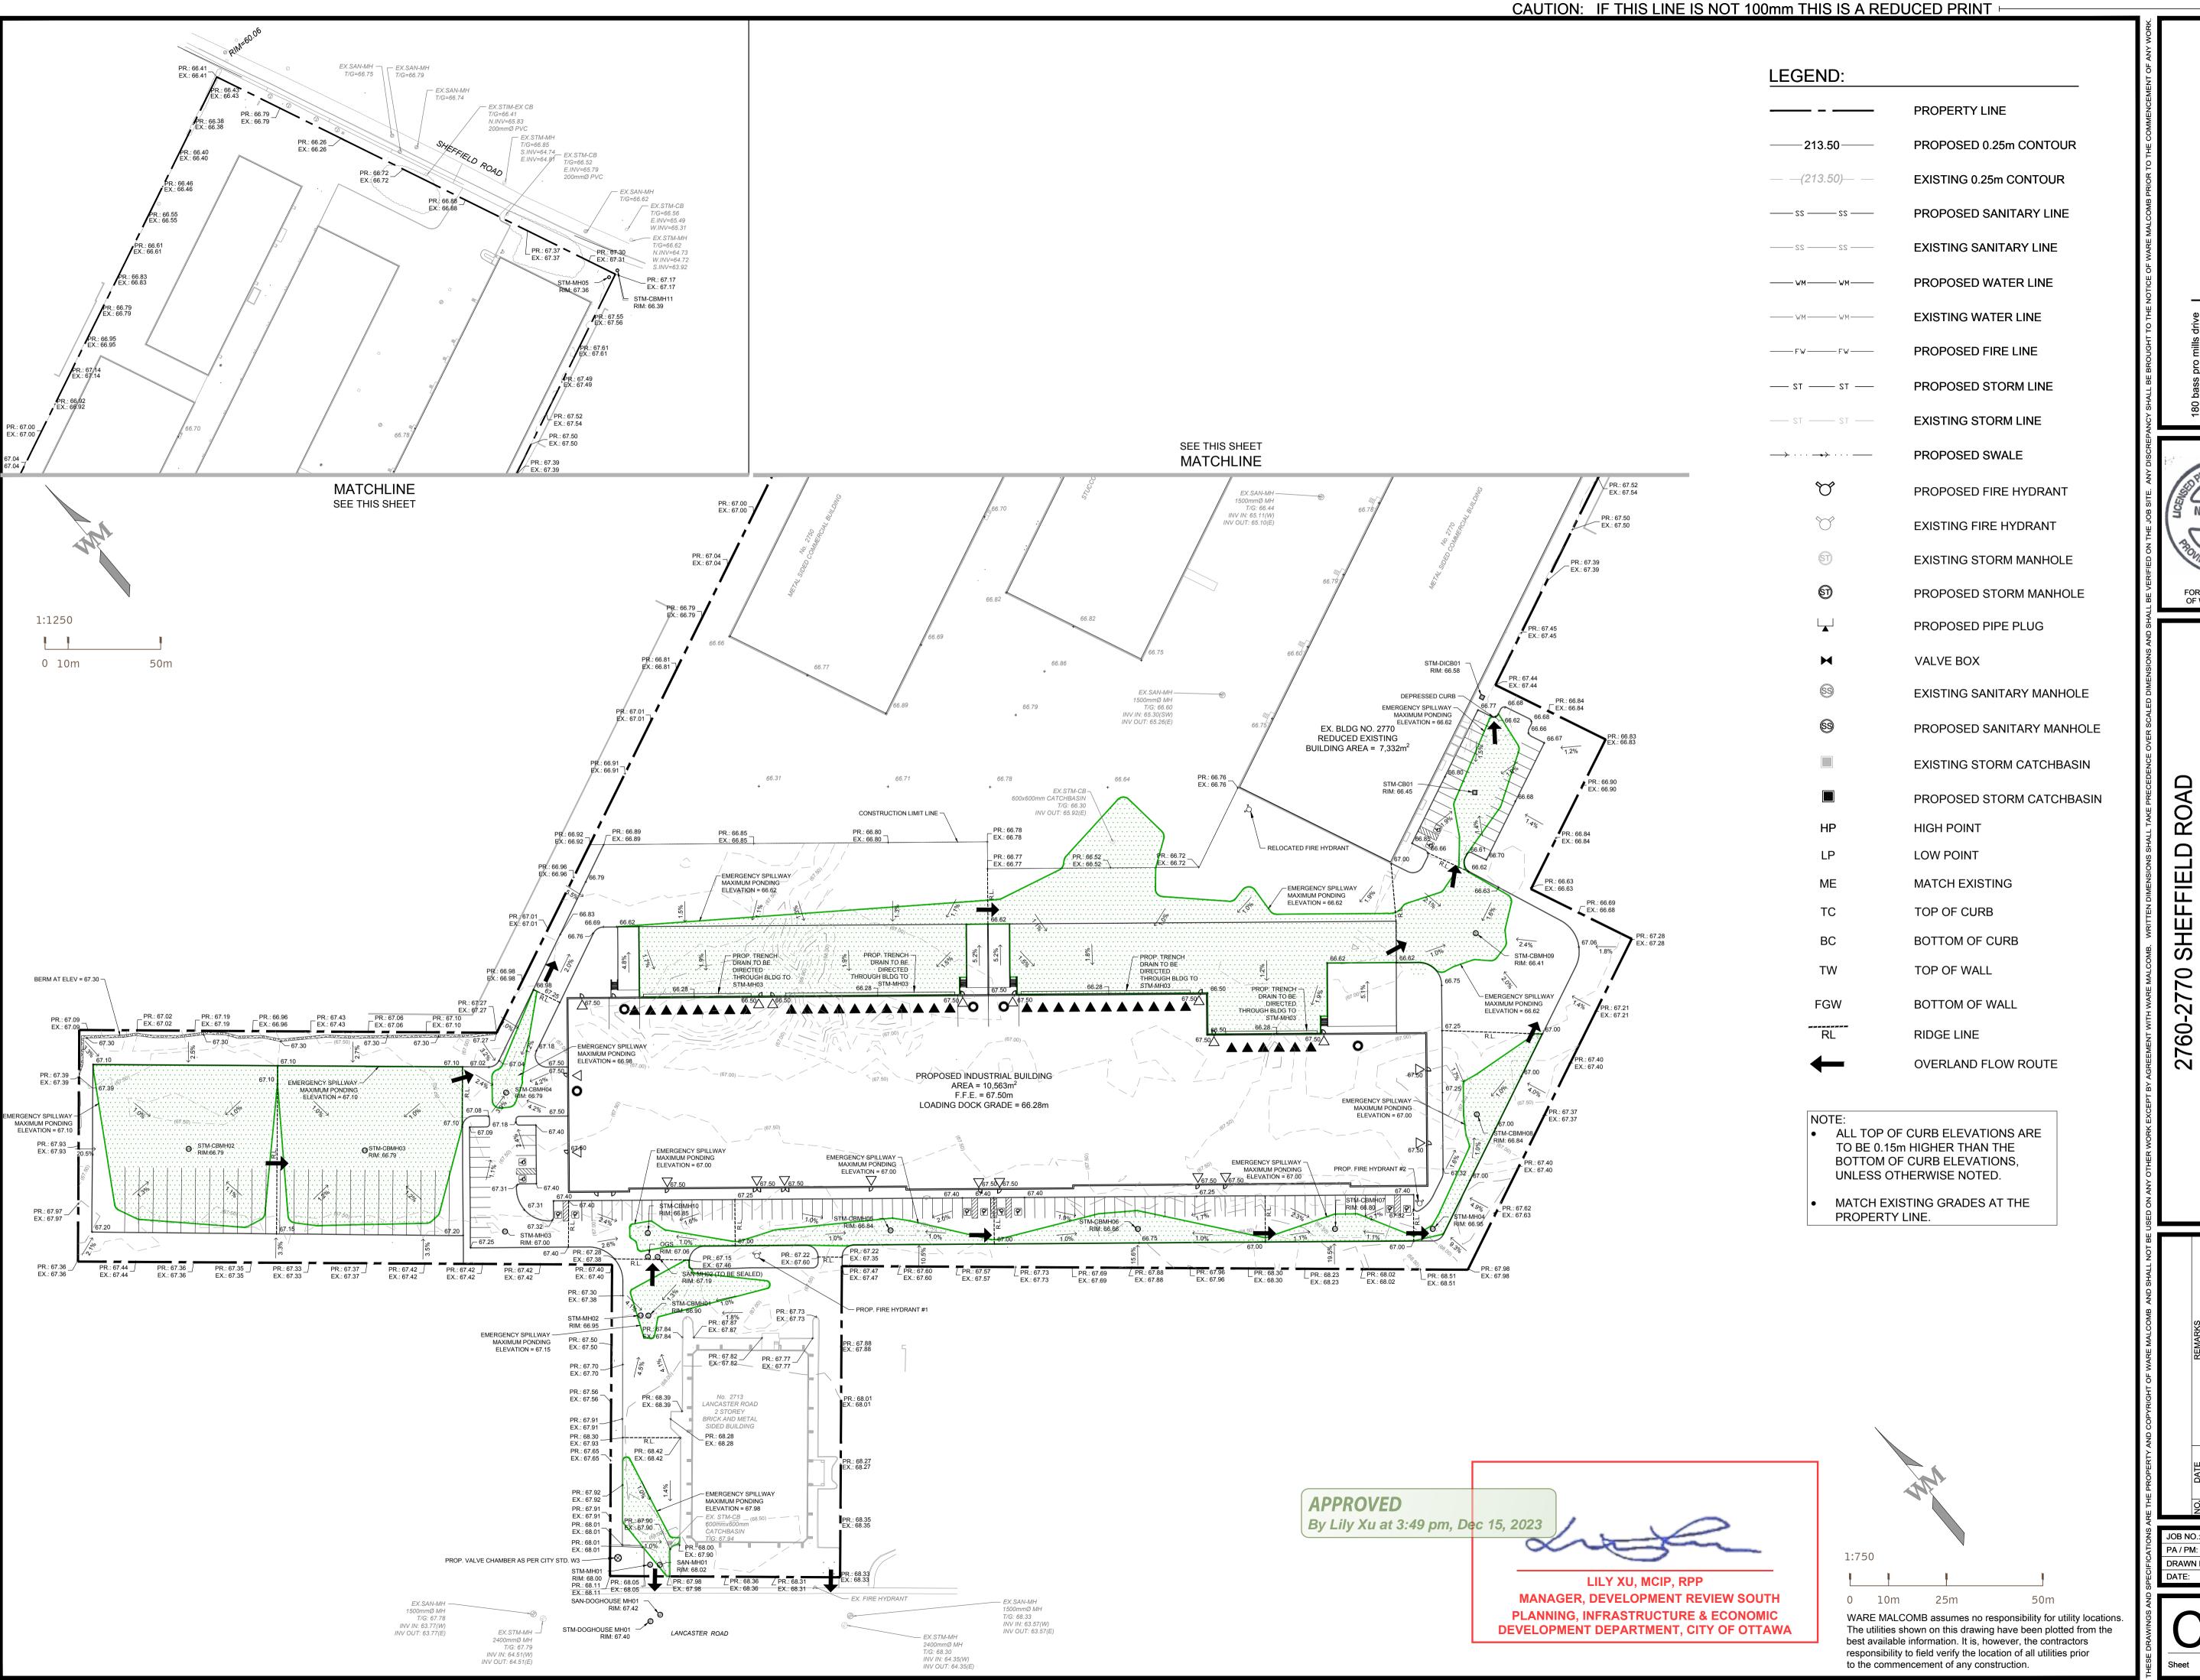


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MALCOMB WARE

N. H. ITZKOVSKY 100175130 OF WARE MALCOMB

2023-10-20

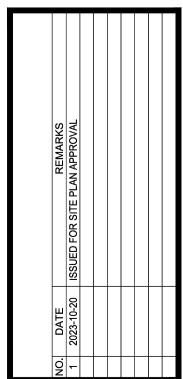W.INV=65.31

EX.SAN-MH — EX.SAN-MH T/G=66.79

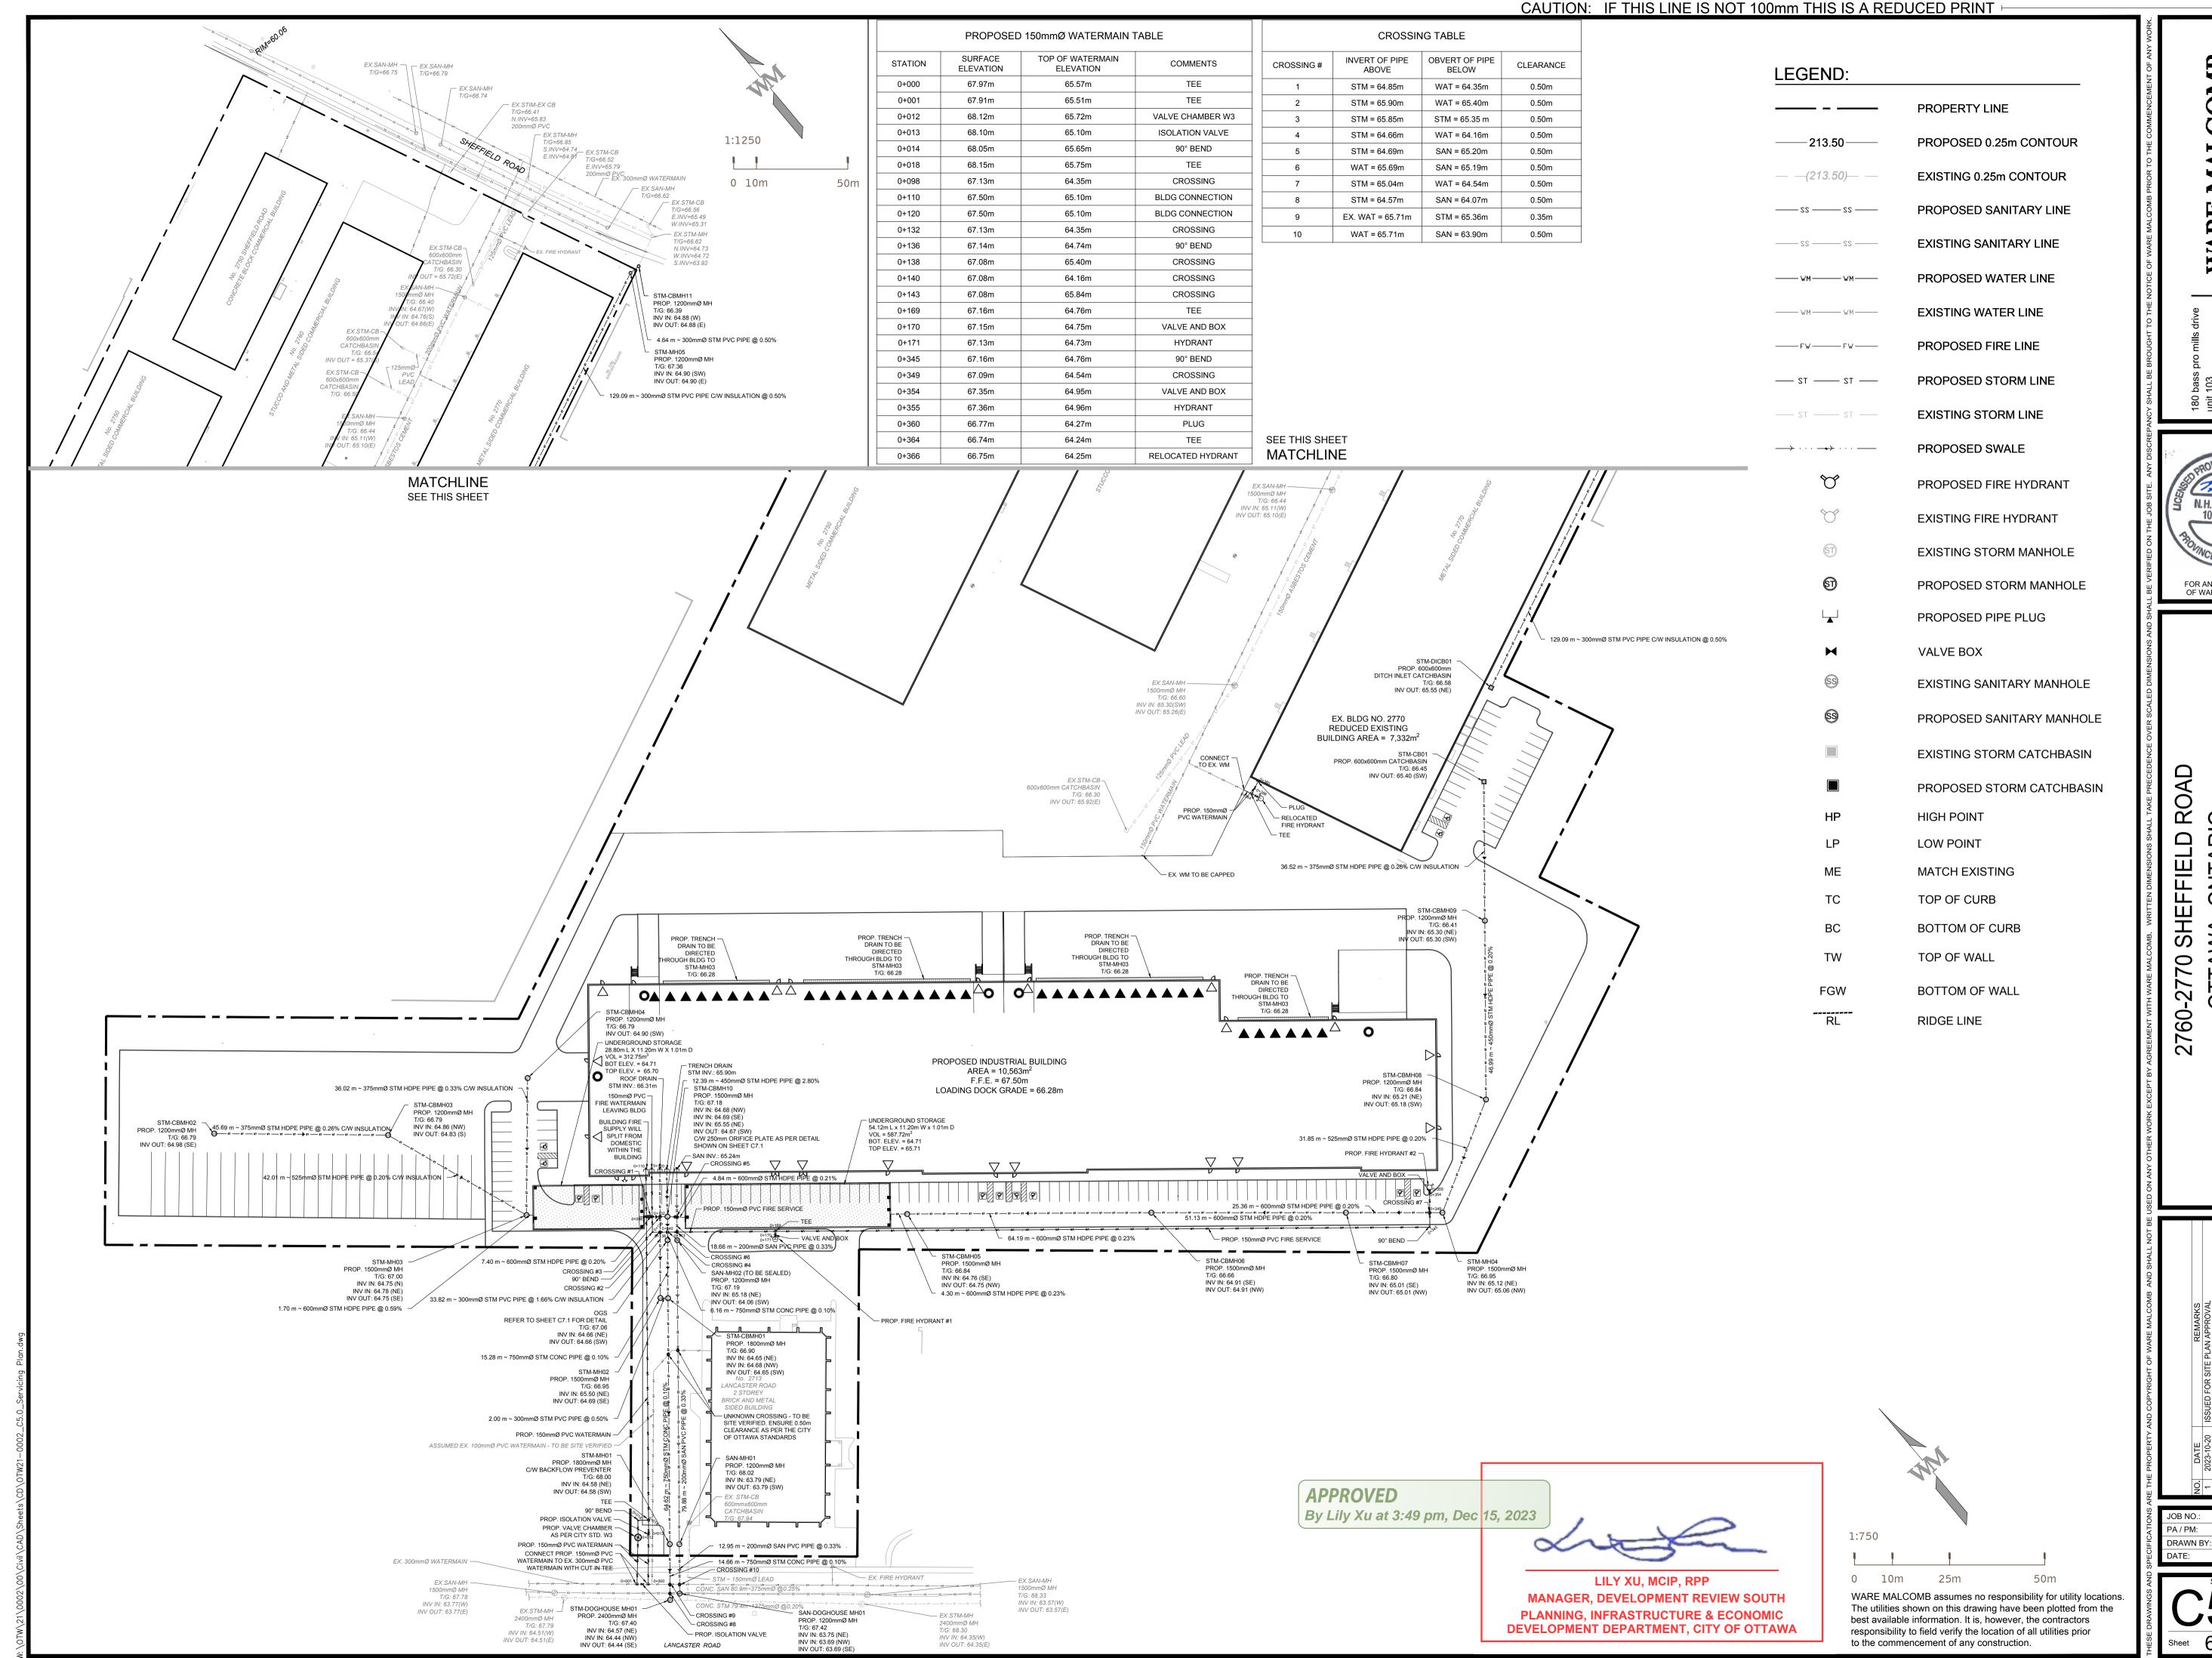CATCHBASIN T/G: 66.30 IV OUT = 65.72(E)

SEDIMENT TRAP (TYP. ALL)

PER OPSD 219.211
SEE SHEET C7.0 FOR DETAIL

REDUCED EXISTING BUILDING AREA = 7,332m²

SEE DETAIL ON SHEET C7.0

SEDIMENT TRAP (TYP. ALL)

500mmØ MH T/G: 66.40 /

EX.STM-CB-600x600mm CATCHBASIN T/G: 66.50

T/G: 66.60

TRUCK ACCESS ROUTE

SEDIMENT TRAP (TYP.

SEE DETAIL ON SHEET

INV OUT: 65.92(E)

1500mmØ MH T/G: 68.33 INV IN: 63.57(W) INV OUT: 63.57(E)

2400mmØ MH T/G: 68.30 INV IN: 64.35(W) INV OUT: 64.35(E)

T/G: 66.44 / IN: 65.11(W) /


VEHICLE TRACK CONTROL SEE THIS SHEET FOR DETAIL

-STRAW BALES TYP. SPACED OUT EVERY 25.0m PER OPSD 219.180


NOTES FOR SEDIMENT & EROSION CONTROL

- DISTURBED AREAS THAT HAVE FAILED TO HAVE STABLE GROUND COVER ESTABLISHED BY OCTOBER JOTH SHALL BE PROTECTED WITH A SILTATION CONTROL FENCE OR STRAW MULCH ETC. AND MAINTAINED BY THE CONTRACTOR UNTIL VEGETATION BECOMES ESTABLISHED IN THE SUBSEQUENT GROWING SEASON.
- ANY DEWATERING WASTE SHALL BE DISCHARGED TO A VEGETATED AREA AT LEAST 30 M FROM ANY WATERCOURSE AND FILTERED. FILTERING METHODS MUST BE APPROVED BY THE SITE ADMINISTRATOR.
- SILT FENCE SHALL BE PUT IN PLACE PRIOR TO AND MAINTAINED DURING ALL GRADING. SILT FENCE SHALL COMPLY WTH OPSD 219.110 FOR LIGHT DUTY AND / OR OPSD219130 FOR HEAVY DUTY, UNLESS NOTED OTHERWISE. SILT FENCE TO BE INSPECTED PRIOR TO COMMENCEMENT OF EARTH GRADING ACTIVITIES. SILT FENCE TO BE INSPECTED AND REPAIRED OR REPLACED IF DAMAGED AS DIRECTED BY THE SITE ADMINISTRATOR. SILT CONTROLS TO BE INSPECTED ON A REGULAR BASIS AND AFTER EVERY RAIN EVENT. INSTALLATION SHALL BE TO THE MANUFACTURER'S SUGGESTED SPECIFICATIONS.
- THE CONTRACTOR SHALL BE PREPARED FOR UNEXPECTED CONDITIONS AND ACCORDINGLY HAVE STOCKPILED MATERIALS ON SITE FOR NECESSARY REPAIRS AS A RESULT OF FAILED OR INADEQUATE CONTROL MEASURES.ALL SEDIMENT AND EROSION CONTROL MEASURES SHALL BE INSPECTED AT LEAST ONCE A WEEK, AND AFTER EVERY RAINFALL EVENT.
- MUD MATS WHERE CONSTRUCTION TRAFFIC ENTERS OR LEAVES THE SITE SHALL BE USED. MUD MATS TO BE 200MM IN DEPTH, 8.0M WIDE BY 10.0M LONG, WHERE THE 10.0M OF LENGTH NEED TO BE 50MM TO 100MM OF CRUSHED STONE; OR MEET MUNICIPAL STANDARDS
- CONTRACTOR SHALL OBTAIN A CURRENT COPY AND BECOME FAMILIAR WITH OPS 805, CONSTRUCTION SPECIFICATION FOR TEMPORARY EROSION AND SEDIMENT CONTROL MEASURES AS WELL AS ALL APPLICABLE MUNICIPAL STANDARDS.
- THE CONTRACTOR MAY CONSIDER ALTERNATIVE SEDIMENT AND EROSION CONTROL MEASURES. SUCH MEASURES SHOULD BE PRESENTED IN WRITING FOR APPROVAL OF THE SITE ADMINISTRATOR AND MUST BE APPROVED IN WRITING BY THE CONSERVATION AUTHORITY.
- THE TOPS OF ALL FILTER FABRIC MUST BE A MINIMUM OF 1,0 METRES ABOVE THE GROUND LEVEL AND ATTACHED TO THE FENCE WITH A CONTINUOUS STEEL WIRE. ALTERNATIVELY, THE FILTER FABRIC MUST BE FOLDED OVER THE TOP OF THE FENCE AND ATTACHED TO THE FENCE WTH WIRE LOOPED THROUGH THE FABRIC ON BOTH SIDES OF THE FENCE. FILTER FABRIC IS TO BE TERRAFIX 270R OR EQUIVALENT.
- ALL DISTURBED GROUND LEFT INACTIVE SHALL BE STABILIZED BY SEEDING. SODDING. MULCHING, OR COVERING OR OTHER EQUIVALENT CONTROL MEASURES. THIS PERIOD OF INACTIVITY SHALL BE AT THE DISCRETION OF THE MUNICIPAL DIRECTOR OF ENGINEERING BUT SHALL NOT EXCEED (30) DAYS OR SUCH LONGER PERIOD DEEMED ADVISABLE BY THE MUNICIPAL DIRECTOR OF ENGINEERING.
- 10. CONTRACTOR SHALL INSTALL AND MAINTAIN CATCHBASIN SEDIMENT BARRIERS THROUGHOUT THE SITE DURING ALL CONSTRUCTION ACTIVITIES IN ORDER TO MITIGATE SEDIMENT ENTERING THE STORM STORM SEWERS.
- 11. NO FUEL TO BE STORED ON SITE. IN CASE OF A SPILL PLEASE CONTACT: MOECO SPILLS ACTION CENTER 1-800-268-6060.
- 12. SEDIMENT CONTROLS ARE TO REMAIN IN PLACE UNTIL WRITTEN DIRECTION IS RECEIVED FROM THE ENGINEER REGARDING THEIR

SITE AREA	84,454 sq.m	STA	GE 1 - TOPSOIL STRIP	PING AND AREA GRA	DING
AREA OF	42,064 sq.m	ESC MEASURE	TIMING OF INSTALLATION	INSPECTION/MAINTENANCE	
ALTERATION		- SILT FENCE	PRIOR TO TOPSOIL STRIPPING		JUST PRIOR TO FINA
EXISTING LAND USE	UNDEVELOPED	MUD MAT		INSPECTION WITH CITY STAFF ONCE INSTALLATION	GRADING REPLACEMENT WIT
ADJOINING		IVIOD IVIA I		IS COMPLETE. CONTRACTOR	
PROPERTY LAND USE	INDUSTRIAL	TOPSOIL STOCKPILE		TO UNDERTAKE WEEKLY	OR CONSTRUCTION
		-		INSPECTIONS AND AFTER	MUNICIPAL SERVIC
SOIL TYPE	SILTY CLAY			EACH RAINFALL EVENT,	
		-		INCLUDING WEEKLY	
				REPORTING. REGULAR	
				MAINTENANCE TO REMOVE	
				ACCUMLATED SEDIMENT	
				AND REPAIR MEASURES.	
		ST	AGE 2 - MUNICIPAL SE	RVICING CONSTRUC	TION
		ESC MEASURE	TIMING OF INSTALLATION	INSPECTION/MAINTENANCE	TIMING OF REMOV
		RESTORATION	AFTER AREA GRADING AND	CONTRACTOR TO	JUST PRIOR TO FINA
		HYDROSEEDING	INSTALLATION OF STORM	UNDERTAKE WEEKLY	GRADING WITH PHA
		6501445NIT TD 4 06	DRAINAGE SYSTEM IS	INSPECTIONS AND AFTER	3 MEASURES
		SEDIMENT TRAPS	COMPLETE.	EACH RAINFALL EVENT,	
		CONNECTIONS TO		INCLUDING WEEKLY	
		CONNECTIONS TO STORM SEWER		REPORTING. REGULAR MAINTENANCE TO REMOVE	
		STORIVISEWER		ACCUMULATED SEDIMENT	
				AND REPAIR MEASURES.	
				AND REPAIR WEASONES.	

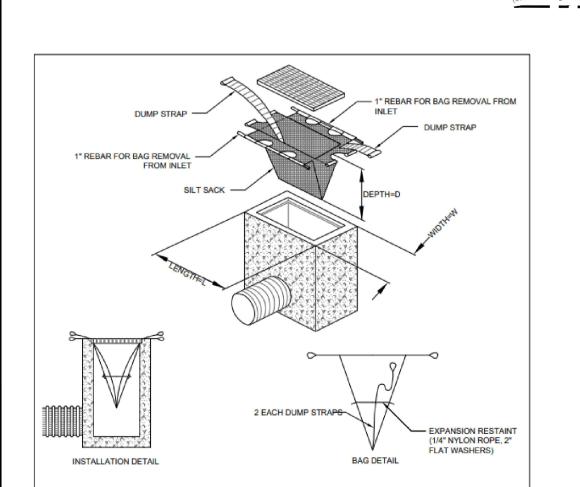

INLET SEDIMENT CONTROL DEVICE

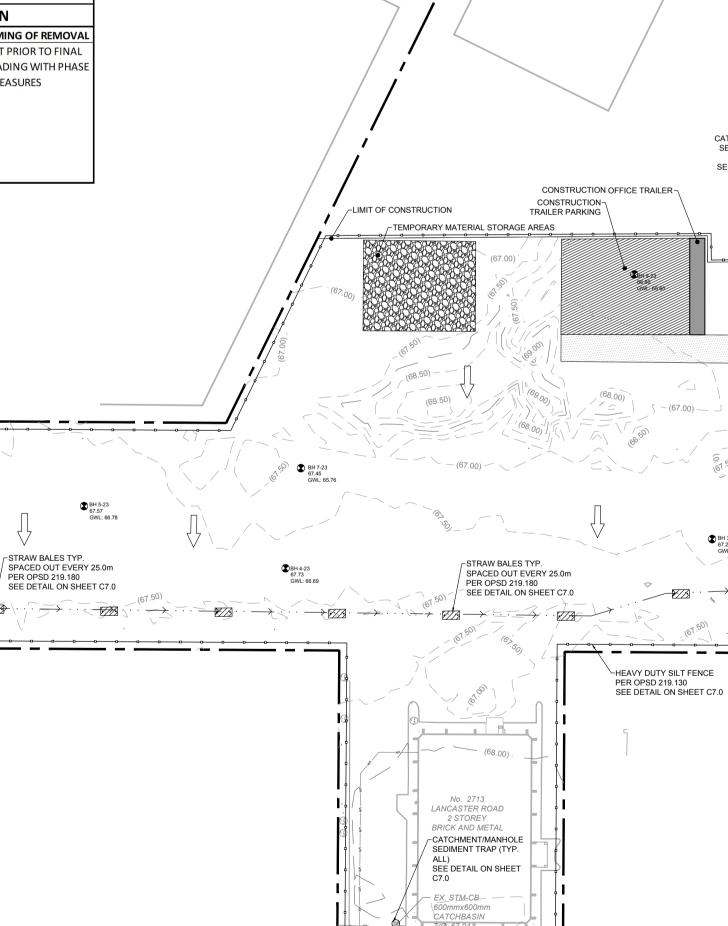

1500mmØ MH T/G: 67.78 INV IN: 63.77(W) INV OUT: 63.77(E)

INV IN: 64.51(W)

STM ~ 150mmØ LEAD EX. FIRE HYDRANT

STM ~ 150mmØ LEAD

EX. FIRE HYDRANT

STM ~ 150mmØ LEAD

EX. FIRE HYDRANT

LANCASTER ROAD

CONC. STM 79.4m~1375mm\@0.20\%

SEQUENCE OF CONSTRUCTION

CONSTRUCTION PERICO.

1. ENGINEER TO BE NOTIFIED PRIOR TO INITIATION OF ANY ON SITE WORKS.

2. SILT FENCE AND CONSTRUCTION ACCESS MATS TO BE INSTALLED PRIOR TO THE COMMENCEMENT OF

3. VEGETATION REMOVAL MAY COMMENCE AFTER ALL SILT FENCE IS INSTALLED AND APPROVED BY THE

EROSION CONTROL MEASURES TO BE MAINTAINED AS DIRECTED BY THE ENGINEER DURING THE

ADDITIONAL CONTROL MEASURES MAY BE REQUIRED AT THE DISCRETION OF THE ENGINEER.


6. ALL DISTURBED GROUND LEFT INACTIVE FOR MORE THAN 30 DAYS SHALL BE STABILIZED WITH SEED,

SOD, MULCH OR OTHER ADEQUATE COVERING, AS INSTRUCTED BY THE ENGINEER.

4. COMMENCE WITH EARTH EXCAVATION AND SITE SERVICING (TO BE REMOVED FROM SITE - NO

APPROVED By Lily Xu at 3:49 pm, Dec 15, 2023 LILY XU, MCIP, RPP MANAGER, DEVELOPMENT REVIEW SOUTH

PLANNING, INFRASTRUCTURE & ECONOMIC DEVELOPMENT DEPARTMENT, CITY OF OTTAWA

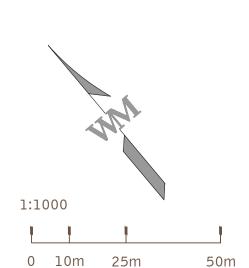

WARE MALCOMB assumes no responsibility for utility locations. The utilities shown on this drawing have been plotted from the best available information. It is, however, the contractors responsibility to field verify the location of all utilities prior to the commencement of any construction.

LEGEND: SILT FENCE —(213.50)— EXISTING CONTOUR **ROCK CHECK DAM** STRAW BALE TEMPORARY SWALE OVERLAND FLOW ROUTE


BOREHOLE

OF WARE MALCOMB

WARE

FIELD SHEF 70


DRAWN BY: 2023-10-20

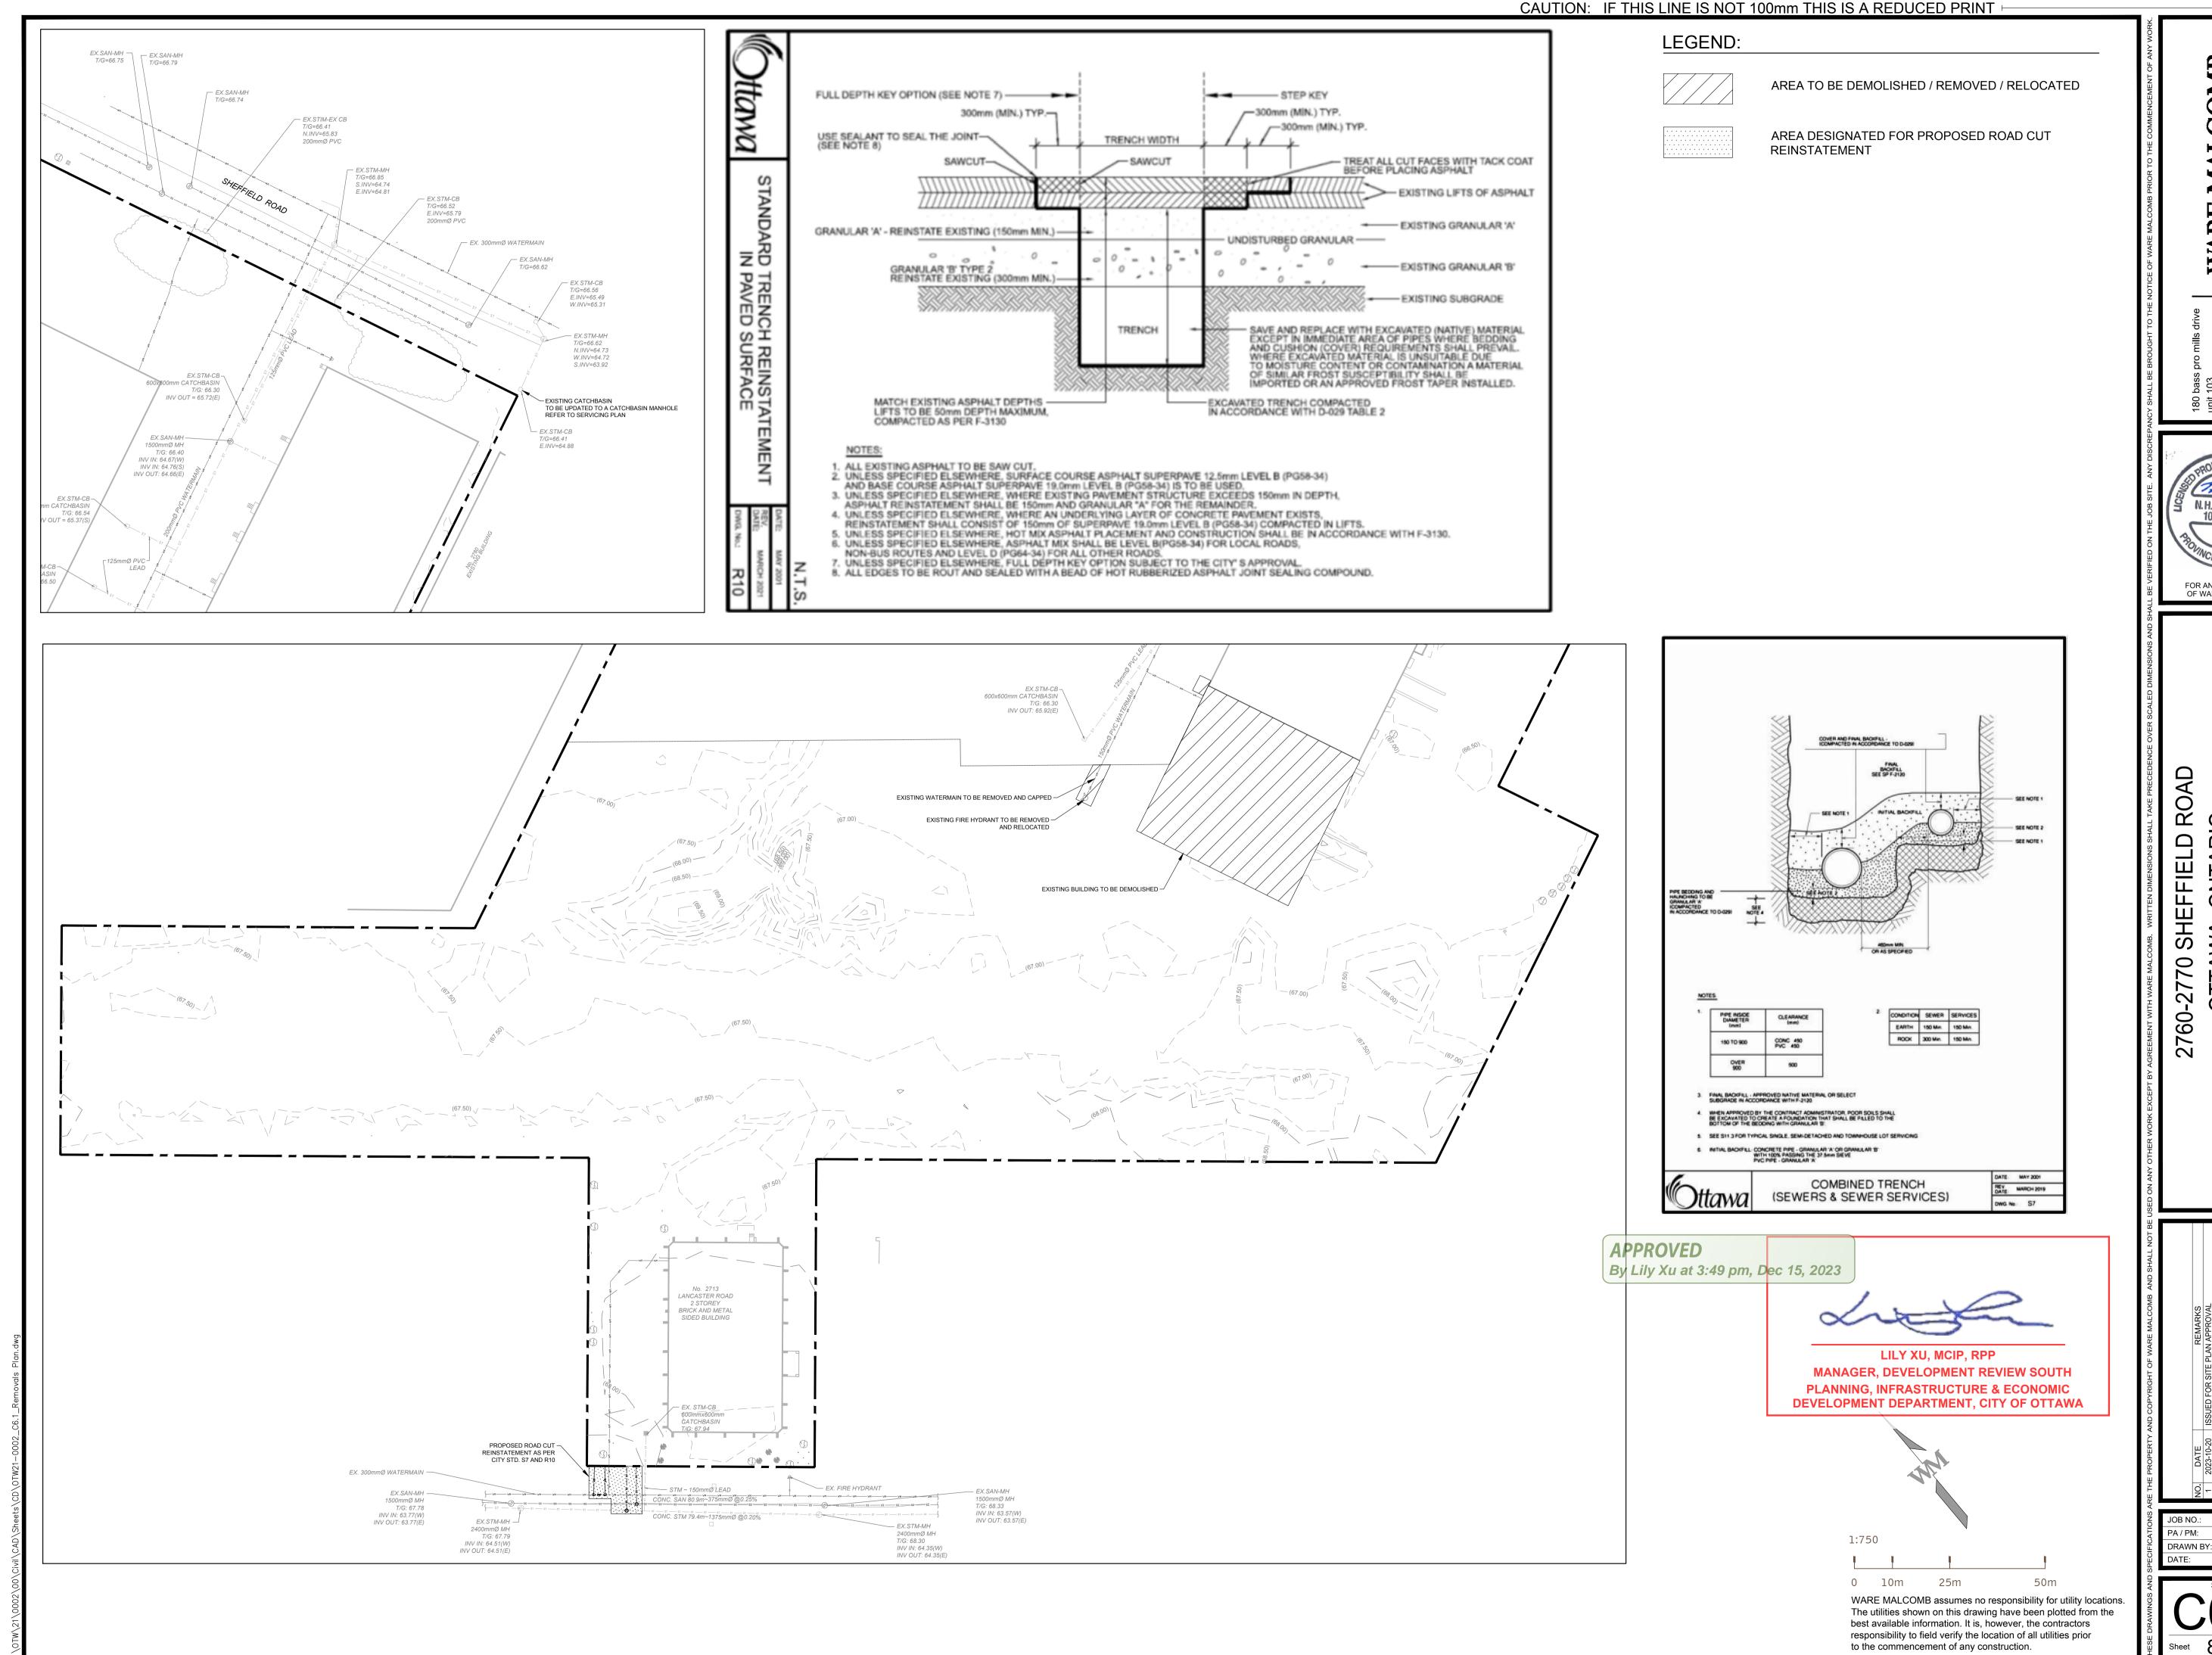

MALCOMB WARE

OF WARE MALCOMB

2023-10-20

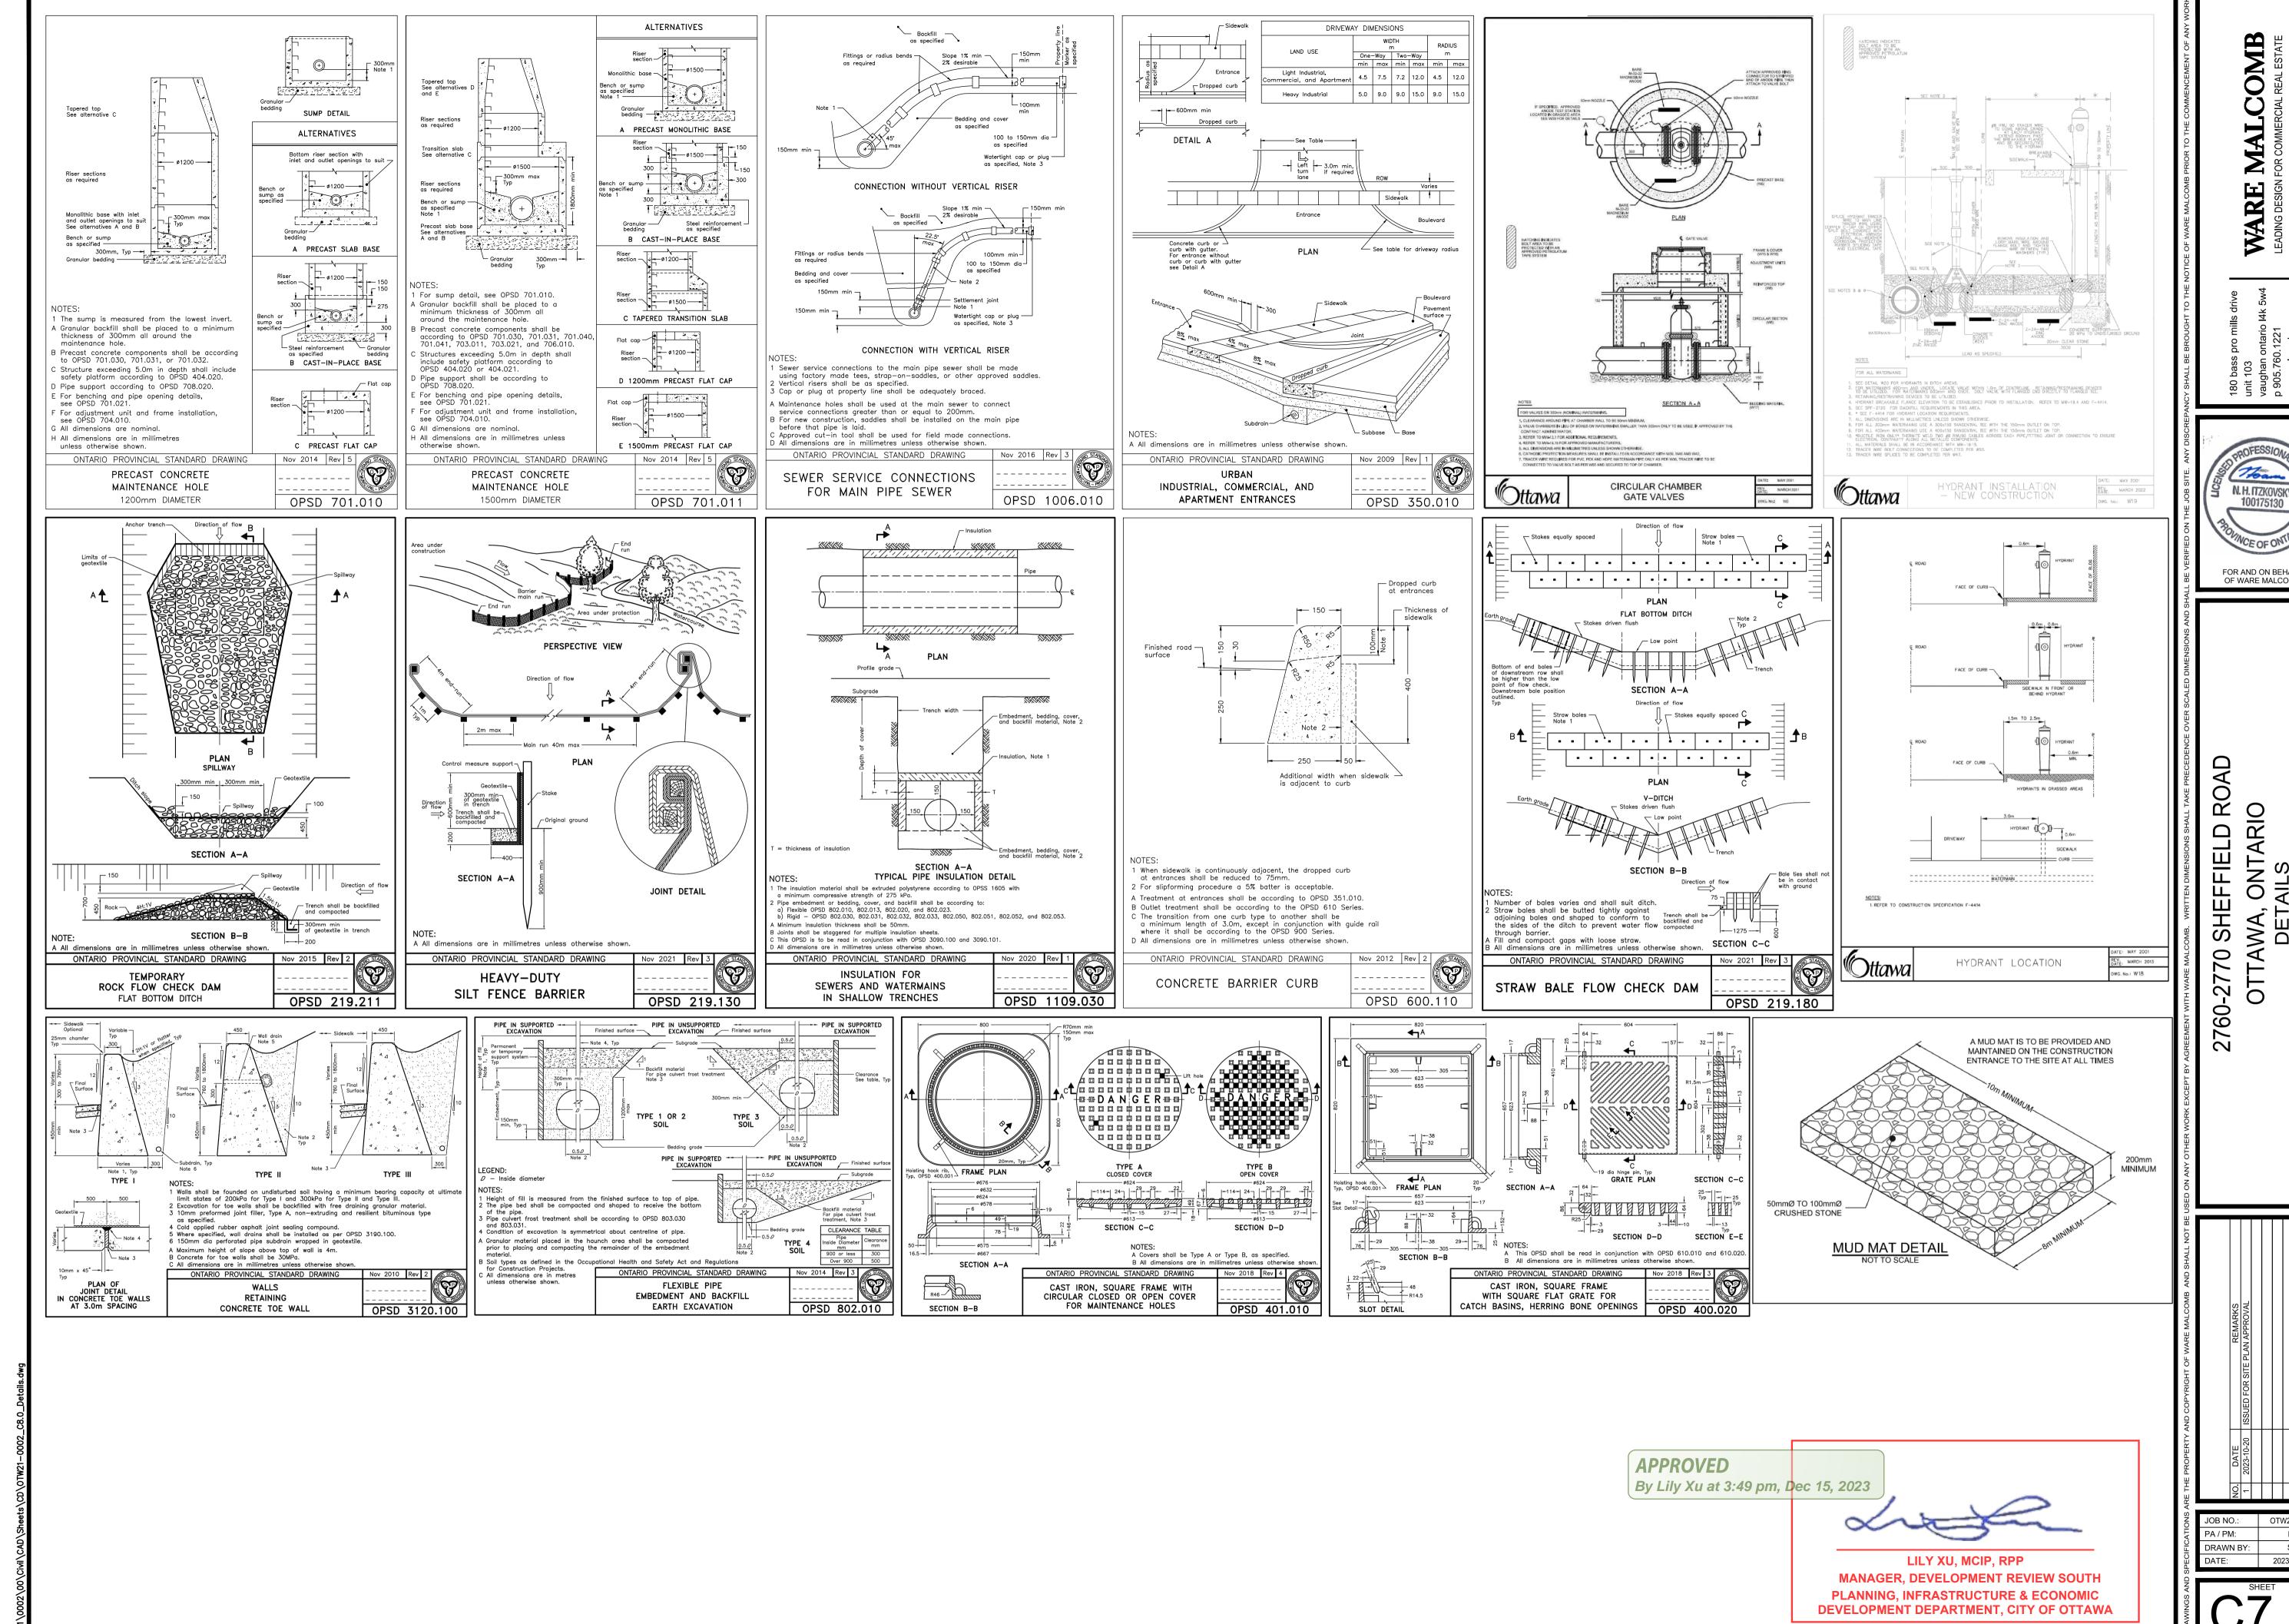


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N. H. ITZKOVSKY

FOR AND ON BEHALF OF WARE MALCOMB

SJ 2023-10-20

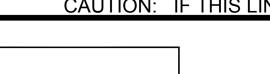

1. COORDINATE WITH MANUFACTURER'S REPRESENTATIVE/DISTRIBUTOR FOR PRE-CONSTRUCTION MEETING AND SITE INSPECTION DURING INSTALLATION. 2. ENGINEERING DRAWINGS SUPERSEDE ALL PROVIDED DOCUMENTATION. REFER TO SITE ENGINEERS FOR ADDITIONAL 2. ENGINEERING DIAWNINGS SUPERSEDE ALE PROVIDED DOCUMENTATION. REPERTO STILE ENGINEERS FOR ADDITIONAL INSTRUCTIONS. 3. COORDINATE GREENSTORM INSTALLATION ACTIVITIES WITH OTHER SITE ACTIVITIES 4. ALL DIMENSIONS ARE IN METERS UNLESS NOTED OTHERWISE 5. THE SUB-GRADE AND SIDE BACKFILL TO BE COMPACTED TO 95% SPD OR AS DIRECTED BY THE QUALIFIED ENGINEER. 6. PRESENCE OF GROUND WATER ABOVE THE BASE OF THE SYSTEM MUST BE IDENTIFIED TO STORMCON. ALL PUBLISH

DRAWING

TITLE	SHEET NO
COVER SHEET	1 OF 7
SYSTEM LAYOUT SHEET&SYSTEM CALCULATION SHEET	2-5 OF 7
SYSTEM OVERLAY SHEET	6 OF 7
DETAIL SHEET	7 OF 7

2760-2770 SHEFFIELD ROAD

OTTAWA, ON

		PROJECT	INFORMATI	ON	
SITE CONTACT	PHIL ALLEN		416-286-5990	PHILALLEN@STORM	MCON.CA
ENGINEER / TECHNICAL SPECIALIST	ERIC CUMISKI	ĒΥ	289-380-3742	ECUMISKEY@STOR	RMCON.CA
SALES REP:	GREG DZIEWI	ECKI	437-231-6080	GREGD@STORMCC	ON.CA
PROJECT NO:	2023-037				
	REVISION	DATE		COMMENT	BY
	01	09/06/2023	REVISED AS F	PER LATEST COMMENTS	JD
COMMENTS:	·				
COMMENTS.					
1					

MITED TO MANHOLES, CATCH BASINS, STORM PIPES AND FITTINGS, MANIFOLDS, ASTINGS AND OTHER NECESSARY APPURTENANCES THAT MAY NOT BE SUPPLIED B TORMCON. IT IS THE RESPONSIBILITY OF THE CONTRACTOR AND/OR SUPPLIER TO ONFIRM THE MATERIALS PROVIDED.

STORMOON 69 CONNIE CRESCENT CONCORD, ON L4K 3W1

		CONFIRM FOR BURIED UNDERGROUND UTILITIES INCLUDING GAS, ELECTRICAL, PIPELINES OR CONDUITS
		9. ROOTS FROM SURROUNDING TREES MAY DAMAGE THE SYSTEM. DESIGN ENGINEER TO ENSURE ADEQUATE SEPARATIC
SINDEX		FROM ALL TREES
		WHEN INSTALLED IN CONFORMANCE TO THE INSTALLATION GUIDELINES, GREENSTORM-ST CAN HANDLE STANDARD
		CL-625 TRUCK LOADING AFTER 0.80m COVER. FOR NON-STANDARD LOADS AND INSTALLATION WITHIN GROUNDWATER,
		CONTACT MANUFACTURER'S REPRESENTATIVE/DISTRIBUTOR
	SHEET NO	11. PROTECT THE INSTALLATION AGAINST DAMAGE WITH CONSTRUCTION TAPE, FENCING OR OTHER MEANS TILL THE
	0.1.22.1.10	CONSTRUCTION IS COMPLETE.

EANS TILL THE 12. ENSURE THAT CONSTRUCTION FOLLOWS APPLICABLE FEDERAL, PROVINCIAL, LOCAL, MUNICIPAL AND LOCAL LAWS, ORDINANCES, REGULATIONS AND SAFETY REQUIREMENTS. 13. VEHICULAR LOADING IS PROHIBITED UNTIL BACKFILLED AS PER MANUFACTURER'S INSTALLATION GUIDELINES. THE US

MAXIMUM AND MINIMUM INSTALLATION DEPTHS ASSUME THE GROUND WATER IS AT OR BELOW THE BASE OF THE SYSTEM UNLESS OTHERWISE NOTED.

CONFIRM GEOTECHNICAL SOIL EVALUATION BY A QUALIFIED ENGINEER TO DETERMINE SUITABILITY OF STRUCTURAL.

- OF EQUIPMENT OVER GREENSTORM CHAMBERS IS LIMITED NO EQUIPMENT IS ALLOWED ON BARE CHAMBERS.
 NO RUBBER TIRED LOADER, DUMP TRUCK, OR EXCAVATORS ARE ALLOWED UNTIL PROPER FILL DEPTHS ARE REACHED IN ACCORDANCE WITH THE CONSTRUCTION GUIDE. WEIGHT LIMITS FOR CONSTRUCTION EQUIPMENT CAN BE FOUND IN THE CONSTRUCTION GUIDE.
- CHECK REQUIRED MATERIALS AND EQUIPMENT 13. ALL GREENSTORM CHAMBERS AND ACCESSORIES AS SPECIFIED IN THE ENGINEER'S PLANS INCLUDING NON-WOVEN GEOTEXTILE, CONNECTORS, QUADS, SIDEWALLS ADAPTER, RISER AND LINER WHERE APPLICABLE. 14. RECIPROCATING SAW OR ROUTER
- 15. TRANSIT OR LASER LEVEL MEASURING DEVICE
 16. COMPACTION EQUIPMENT WITH MAXIMUM GROSS VEHICLE WEIGHT OF 12,000 LBS (5,440 KGS).
 17. ACCEPTABLE FILL MATERIAL AS SHOWN IN INSTALLATION INSTRUCTIONS.
 18. QUANTITIES FOR GEOSYNTHETIC ARE APPROXIMATE AND MAY VARY BASED ON OVERLAP, WASTAGE. YOUR SUPPLIER IMMEDIATELY TO REPORT DAMAGE OR PACKING-LIST DISCREPANCIES.
- CONTRACTORS ARE EXPECTED TO COMPREHEND AND USE THE MOST CURRENT INSTALLATION INSTRUCTIONS PRIOI TO BEGINNING A SYSTEM INSTALLATION. FOR THE MOST CURRENT INSTRUCTIONS, CONTACT STORMCON AT (289)
- 380-3742 OR VISIT WWW.STORMCON.CA. 2. CONTACT STORMOON AT LEAST TWO WEEKS PRIOR TO SYSTEM INSTALLATION TO ARRANGE FOR A PRE-CONSTRUCT ACTUAL DESIGN MAY VARY, REFER TO APPROVED CONSTRUCTION DRAWINGS FOR JOB-SPECIFIC DETAILS.
- ACTION. DESIGN MAY VARY. REPER TO APPROVED CONSTRUCTION DRAWINGS FOR 30B-SPECIFIC DETAILS.

 ENGINEERING DRAWINGS SUPERSEDE ALL PROVIDED DOCUMENTATION.

 THE FOUNDATION STONE SHALL BE LEVEL AND COMPACTED PRIOR TO CHAMBER INSTALLATION.


 ANY DISCREPANCIES WITH THE SYSTEM SUB-GRADE SOIL'S BEARING CAPACITY MUST BE REPORTED TO THE GEOTECHNICAL ENGINEER.


 CONTRACTOR TO REFER TO GREENSTORM INSTALLATION INSTRUCTIONS CONCERNING VEHICULAR TRAFFIC. RESPONSIBILITY FOR PREVENTING VEHICLES THAT EXCEED REQUIREMENTS SPECIFIED FROM TRAVELING ACROSS OR PARKING OVER THE CHAMBER SYSTEM LIES SOLELY WITH THE CONTRACTOR THROUGHOUT THE ENTIRE SITE CONSTRUCTION PROCESS. THE PLACEMENT OF WARNING TAPE, TEMPORARY FENCING, AND/OR APPROPRIATELY
- LOCATED SIGNS IS HIGHLY RECOMMENDED.
 TRAFFIC OF INSTALLATION EQUIPMENT OR OTHER VEHICULAR TRAFFIC OVER TOP OF THE GREENSTORM STORMW SYSTEM IS STRICTLY RESTRICTED AND PROHIBITED UNTIL SATISFACTORY COVER AND COMPACTION IS ACHIEVED
- ACCORDING TO MANUFACTURERS INSTALLATION INSTRUCTIONS.


 8. EROSION AND SEDIMENT-CONTROL MEASURES MUST MEET LOCAL CODES AND THE DESIGN ENGINEER'S SPECIFICATIONS THROUGHOUT THE ENTIRE SITE CONSTRUCTION PROCESS.


 9. GREENSTORM SYSTEMS MUST BE DESIGNED AND INSTALLED IN ACCORDANCE WITH STORMCON'S MINIMUM


	REQUIREMENTS. FAILURE TO DO SO WILL VOID THE LIMITED WARRANTY.
U F	THIS DRAWING WAS PREPARED TO SUPPORT THE PROJECT ENGINEER OF RECORD FOR THE PROPOSED SYSTEM. IT IS THE ULTIMATE RESPONSIBILITY OF THE PROJECT ENGINEER OF RECORD TO ENSURE THAT THE GREENSTORM SYSTEM'S DESIGN IS IN ULL COMPLIANCE WITH ALL APPLICABLE LAWS AND REGULATIONS. IT IS THE CONTRACTOR OF RECORD'S RESPONSIBILITY O ENSURE THAT THE STORMOON PRODUCTS ARE DESIGNED IN ACCORDANCE WITH STORMOON'S MINIMUM REQUIREMENTS. STORMOON DOES NOT APPROVE PLANS, SIZING, OR SYSTEM DESIGNS.

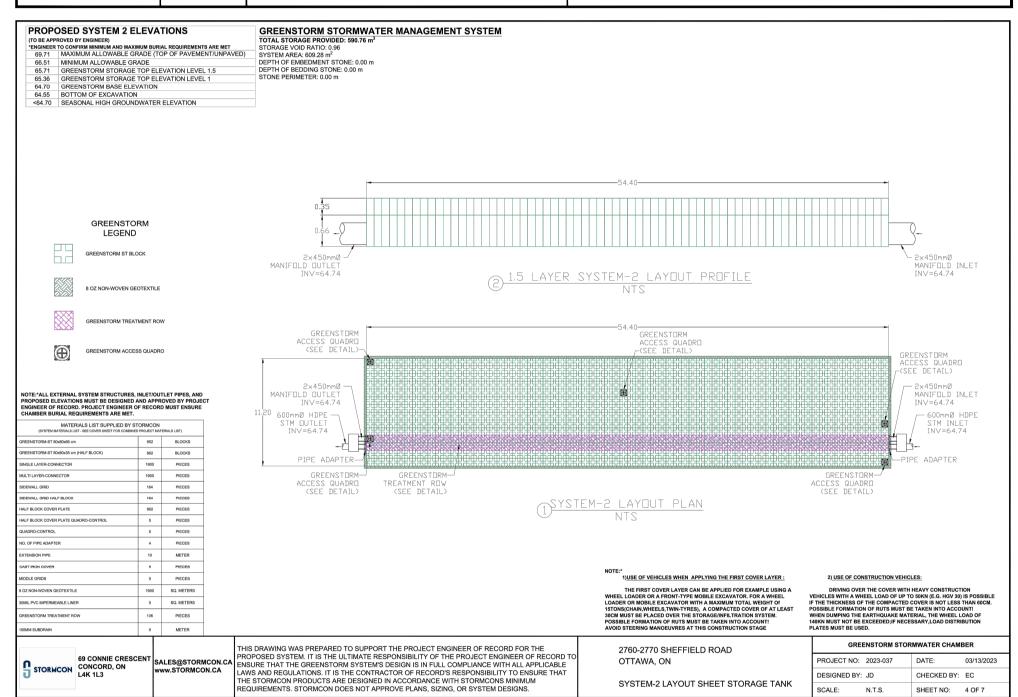

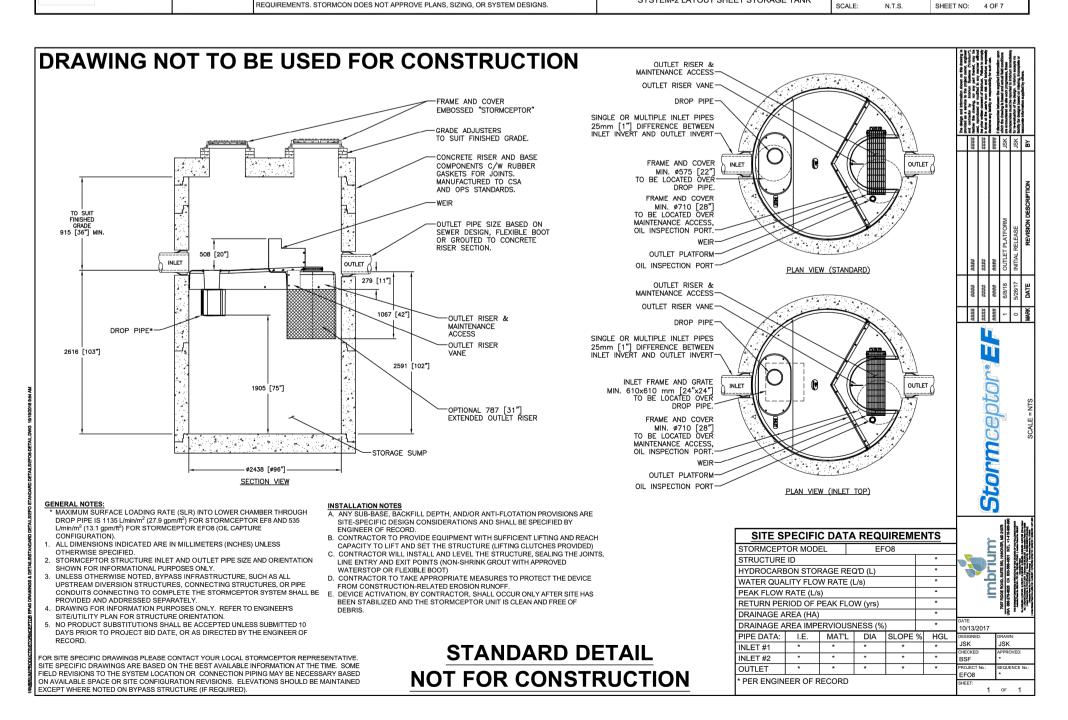

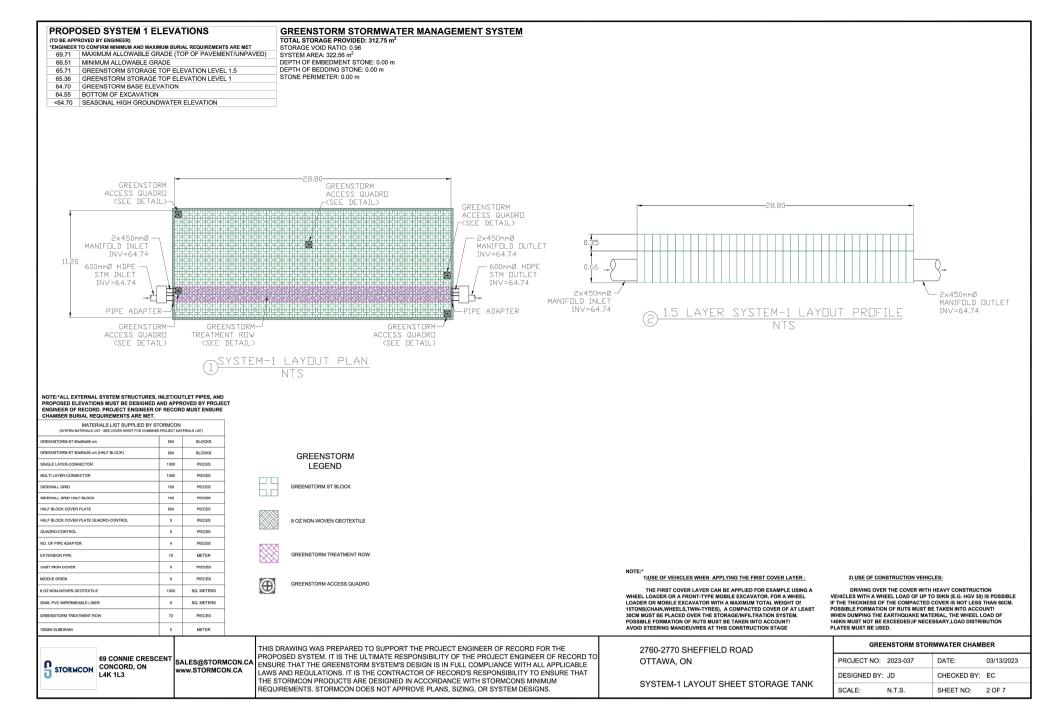

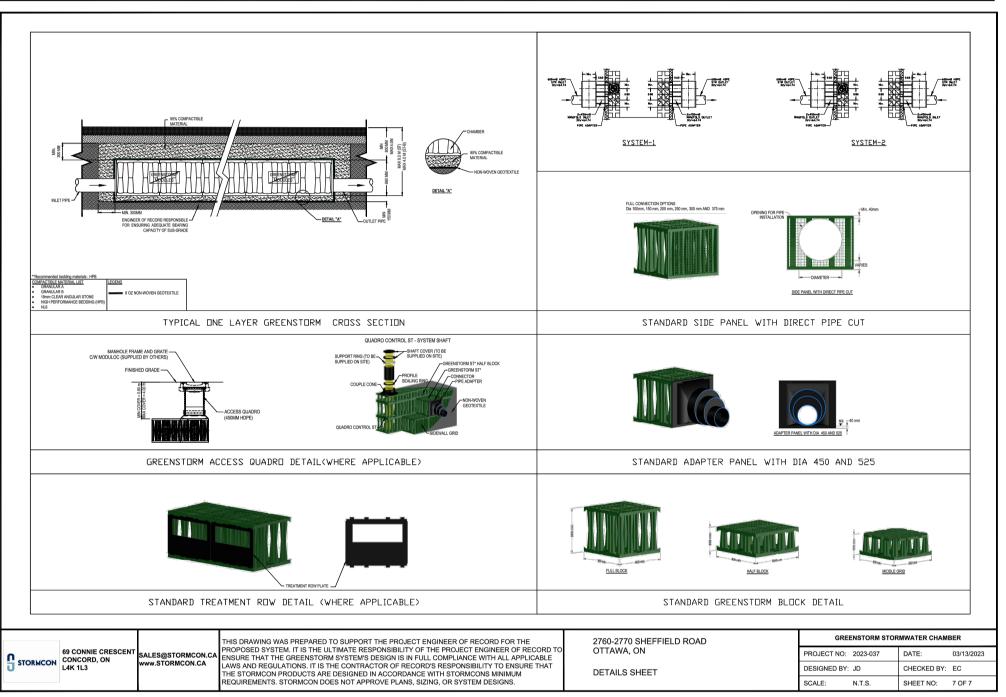


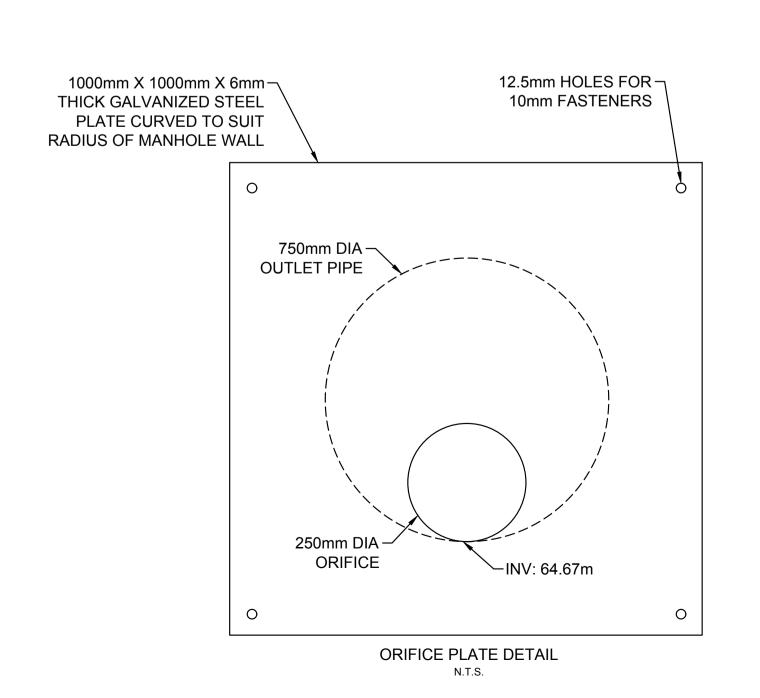



DEVELOPMENT DEPARTMENT, CITY OF OTTAWA

MALCOMB WARE

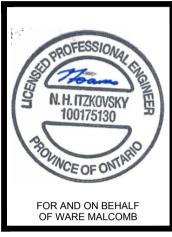

0 FIELD SHEF 0 .27 2760-

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