200/201 FRIEL STREET



202-950 GLADSTONE AVENUE OTTAWA, ON K1Y 3E6 T 613 233 8579 F 613 233 4051 W LashleyLA.com

diamond schmitt







200/201, FRIEL STREET
OTTAWA, ONTARIO
ISSUED FOR

SITE PLAN CONTROL-RESUBMISSION

11 DECEMBER 2023

DRAWING INDEX

TREE PROTECTION PLAN TP -1

DEMOLITION PLAN D1-1

LANDSCAPE PLAN L1-1

LANDSCAPE PLAN POPS AREA L1-2

PLANTING PLAN L1-3

DETAILS L2-1

DETAILS L2-2










LEGEND


— PropertyLine

Building Line


Fence Line

— Tree Protection Line

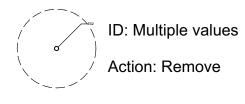

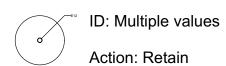

ID	Botanical Name	Common Name	DBH	Condition	Action	Location	Notes
E01	Ulmus pumila	Siberian Elm	0.424	Average	Remove	Project Property	
E02	Ulmus pumila	Siberian Elm	0.418	Poor	Remove	Project Property	
E03	Ulmus pumila	Siberian Elm	0.205	Poor	Remove	Project Property	Entwined in fence
E04	Acer negundo	Manitoba Maple	0.3	Poor	Remove	Adjacent Property	Entwined in fence
E05	Acer negundo	Manitoba Maple	0.22	Poor	Remove	Adjacent Property	Entwined in fence
E06	Acer negundo	Manitoba Maple	0.17	Good	Remove	Adjacent Property	
E07	Celtis occidentalis	Hackberry	0.11	Good	Remove	Project Property	
E08	Celtis occidentalis	Hackberry	0.19	Good	Remove	City of Ottawa Property	
E09	Pinus nigra	Austrian Pine	0.46	Good	Remove	Project Property	
E10	Pinus nigra	Austrian Pine	0.43	Good	Remove	Project Property	
E11	Tilia cordata	Little Leaf Linden	0.33	Good	Remove	Project Property	
E12	Ulmus americana	American Elm	0.45	Good	Retain	Project Property	
E13	Celtis occidentalis	Hackberry	0.14	Poor	Remove	Project Property	
E14	Pinus nigra	Austrian Pine	0.34	Good	Retain	Project Property	
E15	Pinus nigra	Austrian Pine	0.42	Average	Retain	Project Property	
E16	Pinus nigra	Austrian Pine	0.25	Good	Retain	Project Property	
E17	Pinus nigra	Austrian Pine	0.379	Average	Retain	Project Property	
E18	Acer negundo	Manitoba Maple	0.266	Average	Remove	City of Ottawa Property	
E19	Tilia cordata	Little Leaf Linden	0.32	Good	Retain	City of Ottawa Property	

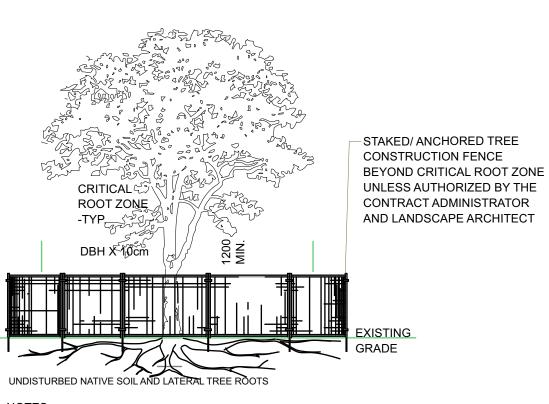

THE FOLLOWING PROTECTION MEASURES MUST BE IMPLEMENTED FOR RETAINED TREES, BOTH WITHIN THE WORK AREA AND ON ADJACENT PARCELS.

- 1. UNDER THE GUIDANCE OF AN ARBORIST, ERECT A MODULAR FENCE AT THE CRITICAL ROOT ZONE (CRZ) OF TREES WHERE THE CRZ IS ESTABLISHED AS BEING 10 CENTIMETERS FROM THE TRUNK FOR EVERY CENTIMETER OF TRUNK DIAMETER AT BREAST HEIGHT.
- 2. TREE PROTECTION SHALL BE ERECTED TO PROVIDE A CONTINUOUS BARRICADE
- BETWEEN DESIGNATED TREES AND THE WORK AREA PRIOR TO CONSTRUCTION. 3. TUNNEL OR BORE WHEN DIGGING WITHIN THE CRZ OF A TREE. 4. ENSURE ALL EQUIPMENT AND CONSTRUCTION RELATED MATERIAL ARE NOT PLACED
- OR TEMPORARILY STORED WITHIN THE CRZ. 5. ENSURE EXHAUST FUMES FROM ALL EQUIPMENT ARE NOT DIRECTED TOWARDS ANY
- 6. FLOODING OR DEPOSITION OF SEDIMENT SHALL BE PREVENTED WHERE TREES ARE
- LOCATED. 7. ALL DISTURBED ROOT SYSTEMS SHALL BE EXPOSED AND BACKFILLED IN ONE
- CONTINUOUS OPERATION TO MINIMIZE DESICCATION. 8. EXPOSED ROOTS SHALL BE KEPT CONTINUOUSLY MOIST DURING EXCAVATION.
- 9. REMOVE BROKEN AND DAMAGED ROOTS WITH SHARP PRUNING SHEARS.
- 10. THE TREE PROTECTION MODULAR FENCE IS TEMPORARY, SHALL BE MAINTAINED AT ALL TIMES DURING

CONSTRUCTION OPERATIONS, AND SHALL BE REMOVED UPON COMPLETION OF WORK WHEN AGREED TO BY THE CONTRACT ADMINISTRATOR AND LANDSCAPE ARCHITECT.



KEY PLAN, NTS

LANDSCAPE NOTES

- 1. All general site information and conditions compiled from architect's and engineer's plans and surveys.
- 2. Do not scale this drawing.
- Report any discrepancies prior to commencing work. No responsibility is born by the Landscape Architect for unknown subsurface conditions.
- 4. Reinstate all areas and items damaged as a result of construction activities to the satisfaction of the Landscape Architect.
- 5. Drawing may not be used for construction until signed by Landscape Architect as issued for construction.
- 6. The accuracy of the position of utilities is not guaranteed. Individual utility co. must be contacted for confirmation of
- utility existence and location prior to digging. 8. This drawing is an instrument of service and requires the permission of the Landscape Architect for use. Copyright is
- reserved by the Landscape Architect, David M. Lashley. 9. Plant material shall be No.1 Grade and shall comply with the Metric Guide Specifications for Nursery stock
- (latest edition), published by Canadian Nursery Trades Association. 10. Plant substitutions shall not be permitted unless

approved by the Landscape Architect.

- 11. Obtain approval of planting prior to digging.
- 12. Topsoil shall be garden sirl mixture sandy loam with min. 5% organic matter and peat moss added at ratio of 1:10, topsoil to be approved by Landscape

CLIENT:

Architect.



- F 2023-12-11 ISSUED FOR SITE PLAN CONTROL-RESUBMISSION
- 2023-08-25 ISSUED FOR 100% DESIGN DEVELOPMENT
- D | 2023-07-12 | ISSUED FOR SITE PLAN CONTROL-RS #2 2023-05-18 ISSUED FOR REZONING & SITE PLAN CONTROL-RS #1
- B | 2023-05-12 | ISSUED FOR 100% SCHEMATIC DESIGN
- A 2023-03-22 ISSUED FOR REZONING AND SITE PLAN CONTROL

NO. DATE DESCRIPTION









PROJECT:

OCH 200/201 FREIL STREET

200/201 FREIL STREET, OTTAWA, ONTARIO

DRAWING TITLE:

TREE PROTECTION PLAN

2023-03-14 **DRAWING NO.:** SCALE: AS NOTED DRAWN BY: LA PROJECT NO.: 22844-1








— PropertyLine

Fence Line

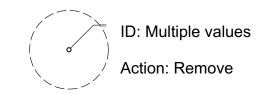

ID: Multiple values Action: Retain



KEY PLAN, NTS

LANDSCAPE NOTES


- 1. All general site information and conditions compiled from architect's and engineer's plans and surveys.
- 2. Do not scale this drawing.
- 3. Report any discrepancies prior to commencing work. No responsibility is born by the Landscape Architect for unknown subsurface conditions.
- 4. Reinstate all areas and items damaged as a result of construction activities to the satisfaction of the Landscape Architect.
- 5. Drawing may not be used for construction until signed by Landscape Architect as issued for construction.
- 6. The accuracy of the position of utilities is not guaranteed.
- Individual utility co. must be contacted for confirmation of
- utility existence and location prior to digging. 8. This drawing is an instrument of service and requires the permission of the Landscape Architect for use. Copyright is reserved by the Landscape Architect, David M. Lashley.
- 9. Plant material shall be No.1 Grade and shall comply with the Metric Guide Specifications for Nursery stock (latest edition), published by Canadian Nursery Trades Association.
- 10. Plant substitutions shall not be permitted unless approved by the Landscape Architect.
- 11. Obtain approval of planting prior to digging.
- 12. Topsoil shall be garden sirl mixture sandy loam with min. 5% organic matter
- and peat moss added at ratio of 1:10, topsoil to be approved by Landscape Architect.

CLIENT:



- F 2023-12-11 ISSUED FOR SITE PLAN CONTROL-RESUBMISSION
- E | 2023-08-25 | ISSUED FOR 100% DESIGN DEVELOPMENT
- D | 2023-07-12 | ISSUED FOR SITE PLAN CONTROL-RS #2
- C 2023-05-18 ISSUED FOR REZONING & SITE PLAN CONTROL-RS #1
- B 2023-05-12 ISSUED FOR 100% SCHEMATIC DESIGN

A 2023-03-22 ISSUED FOR REZONING AND SITE PLAN CONTROL NO. DATE

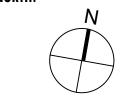






OCH 200/201 FREIL STREET

200/201 FREIL STREET, OTTAWA, ONTARIO

DRAWING TITLE:

DEMOLITION PLAN

2023-03-14 **DRAWING NO.:** AS NOTED DRAWN BY: LA PROJECT NO.: 22844-1

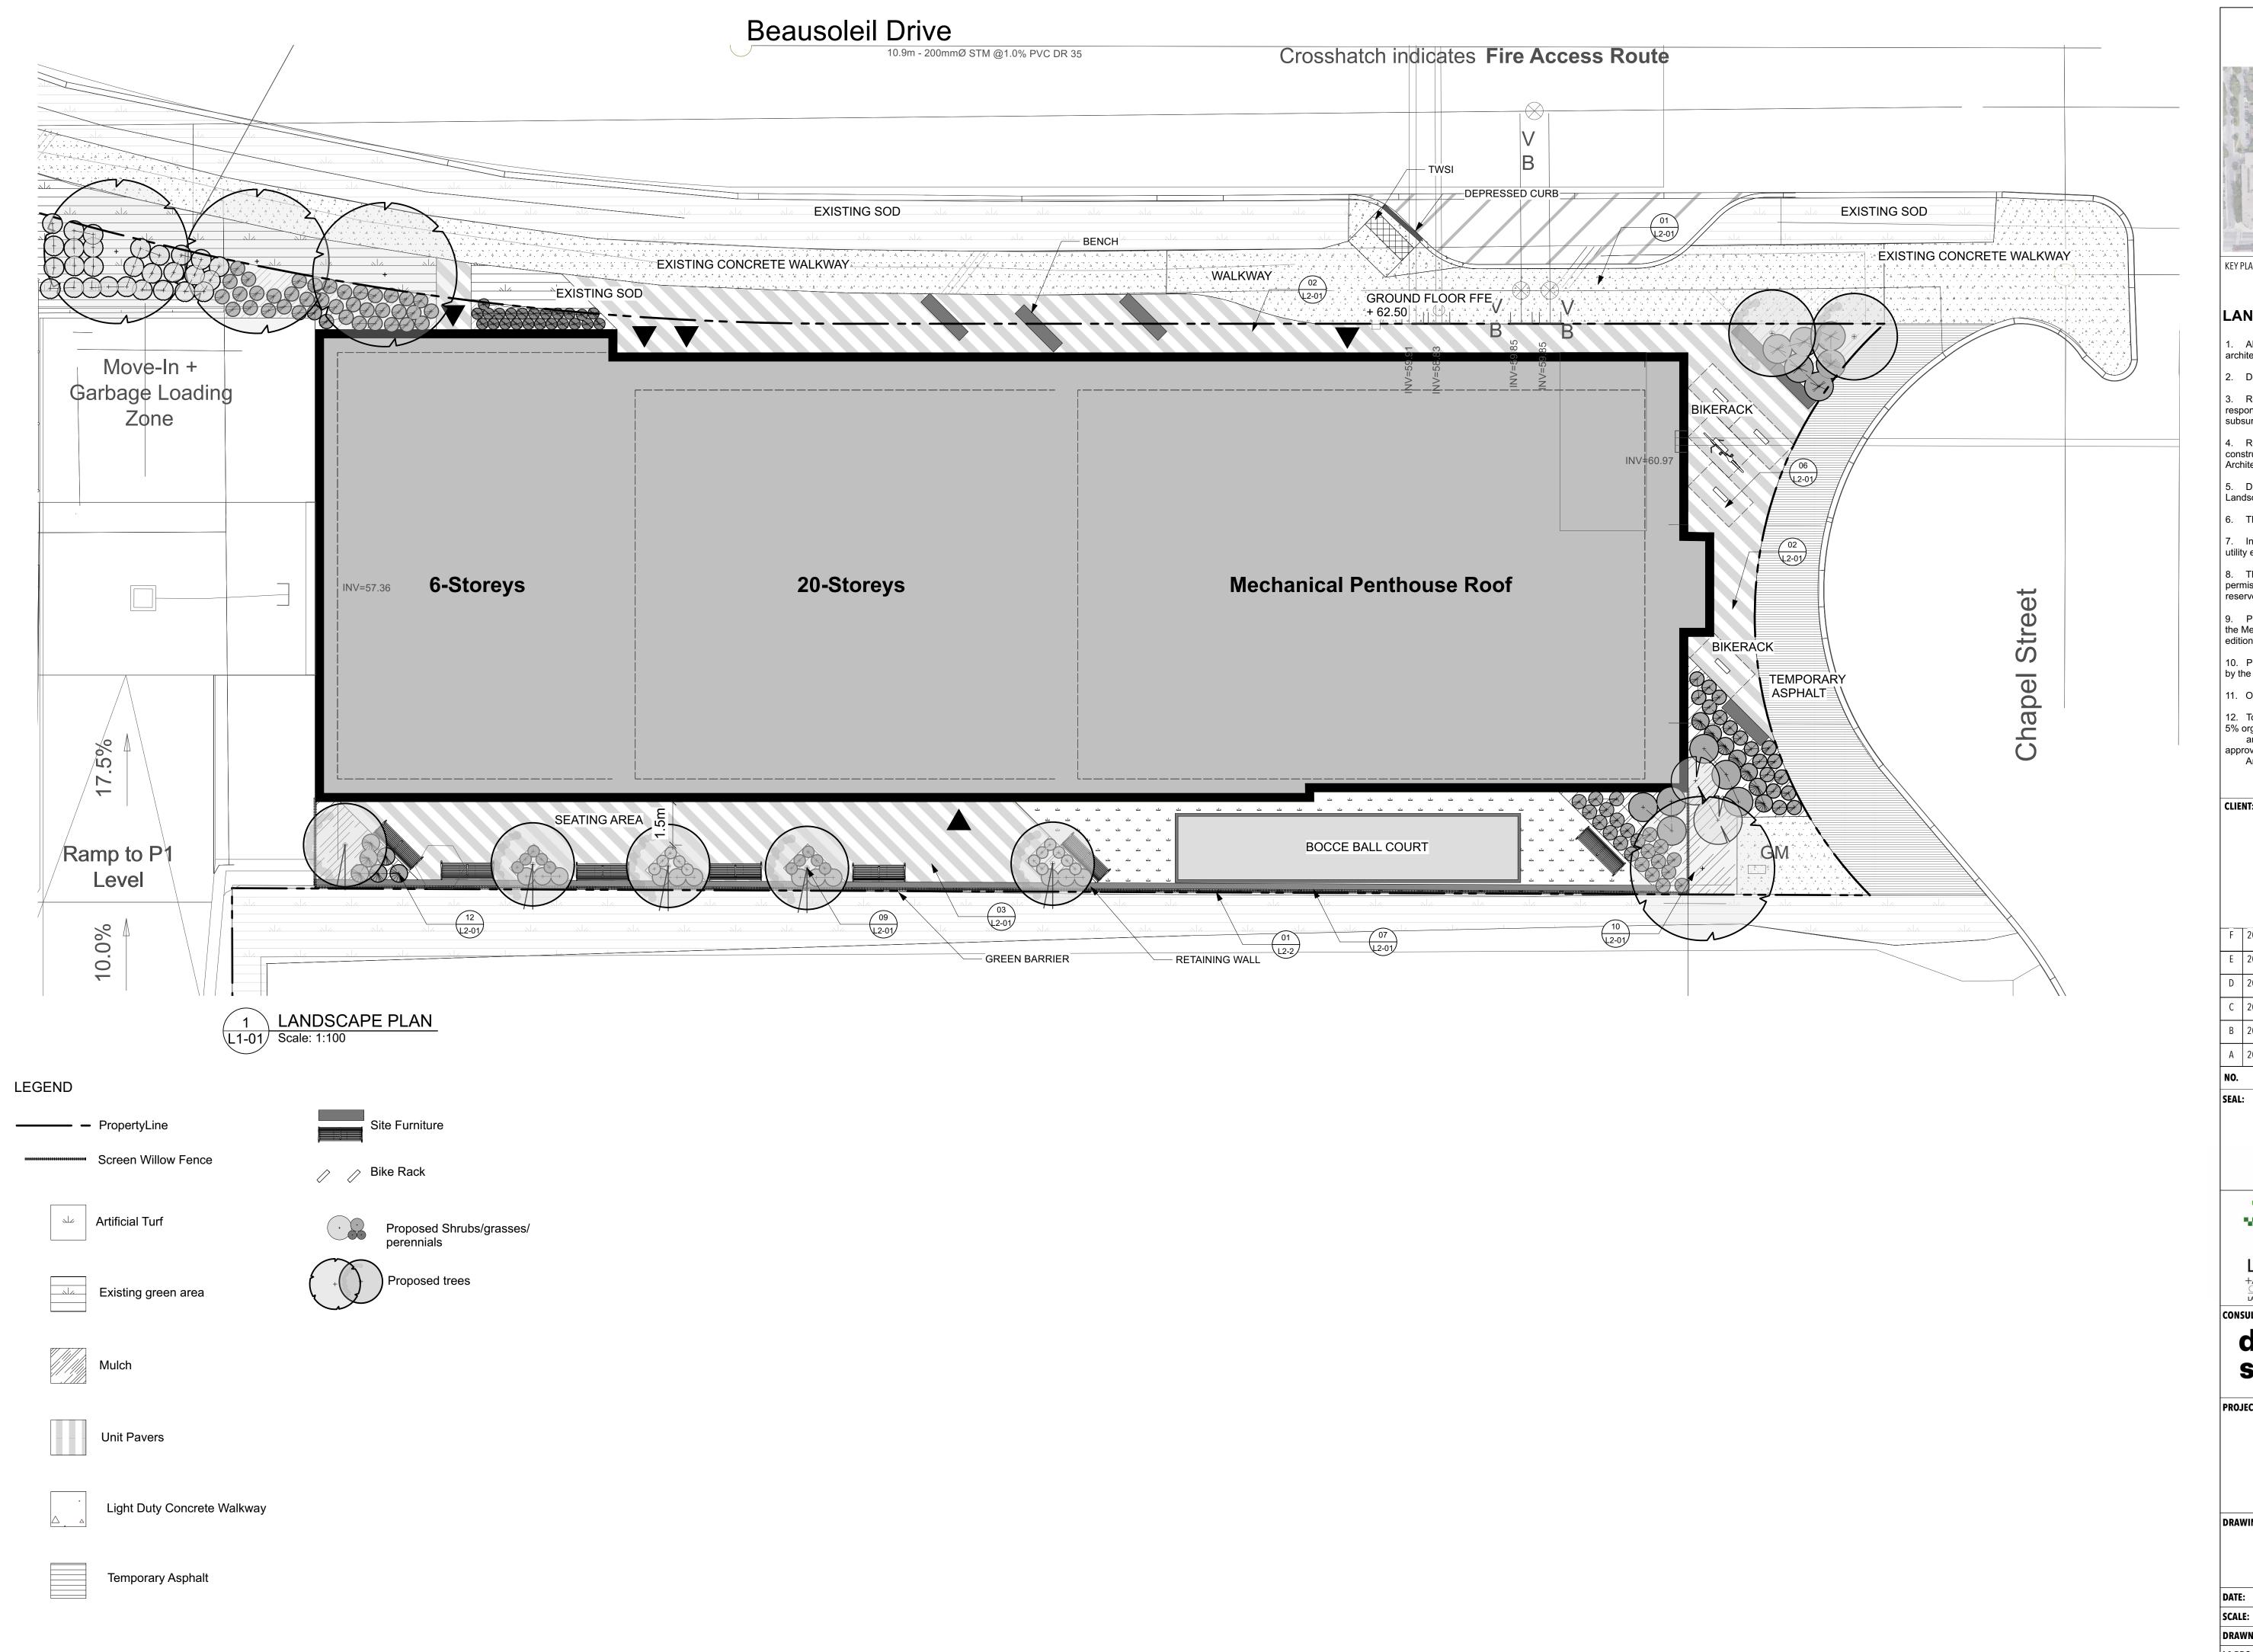



KEY PLAN, NTS

LANDSCAPE NOTES

1. All general site information and conditions compiled from architect's and engineer's plans and surveys.

2. Do not scale this drawing.

Report any discrepancies prior to commencing work. No responsibility is born by the Landscape Architect for unknown subsurface conditions.

4. Reinstate all areas and items damaged as a result of construction activities to the satisfaction of the Landscape

5. Drawing may not be used for construction until signed by Landscape Architect as issued for construction.

6. The accuracy of the position of utilities is not guaranteed.

7. Individual utility co. must be contacted for confirmation of utility existence and location prior to digging. 8. This drawing is an instrument of service and requires the permission of the Landscape Architect for use. Copyright is reserved by the Landscape Architect, David M. Lashley.

9. Plant material shall be No.1 Grade and shall comply with the Metric Guide Specifications for Nursery stock (latest edition), published by Canadian Nursery Trades Association.

10. Plant substitutions shall not be permitted unless approved by the Landscape Architect.

11. Obtain approval of planting prior to digging.

12. Topsoil shall be garden sirl mixture sandy loam with min.5% organic matter and peat moss added at ratio of 1:10, topsoil to be approved by Landscape




F 2023-12-11 ISSUED FOR SITE PLAN CONTROL-RESUBMISSION

2023-08-25 ISSUED FOR 100% DESIGN DEVELOPMENT

2023-05-18 ISSUED FOR REZONING & SITE PLAN CONTROL-RS #1

B 2023-05-12 ISSUED FOR 100% SCHEMATIC DESIGN

A 2023-03-22 ISSUED FOR REZONING AND SITE PLAN CONTROL

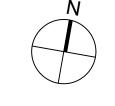






OCH 200/201 FREIL STREET

200/201 FREIL STREET, OTTAWA, ONTARIO

LANDSCAPE PLAN

2023-03-14 **DRAWING NO.:** AS NOTED DRAWN BY: LA PROJECT NO.:

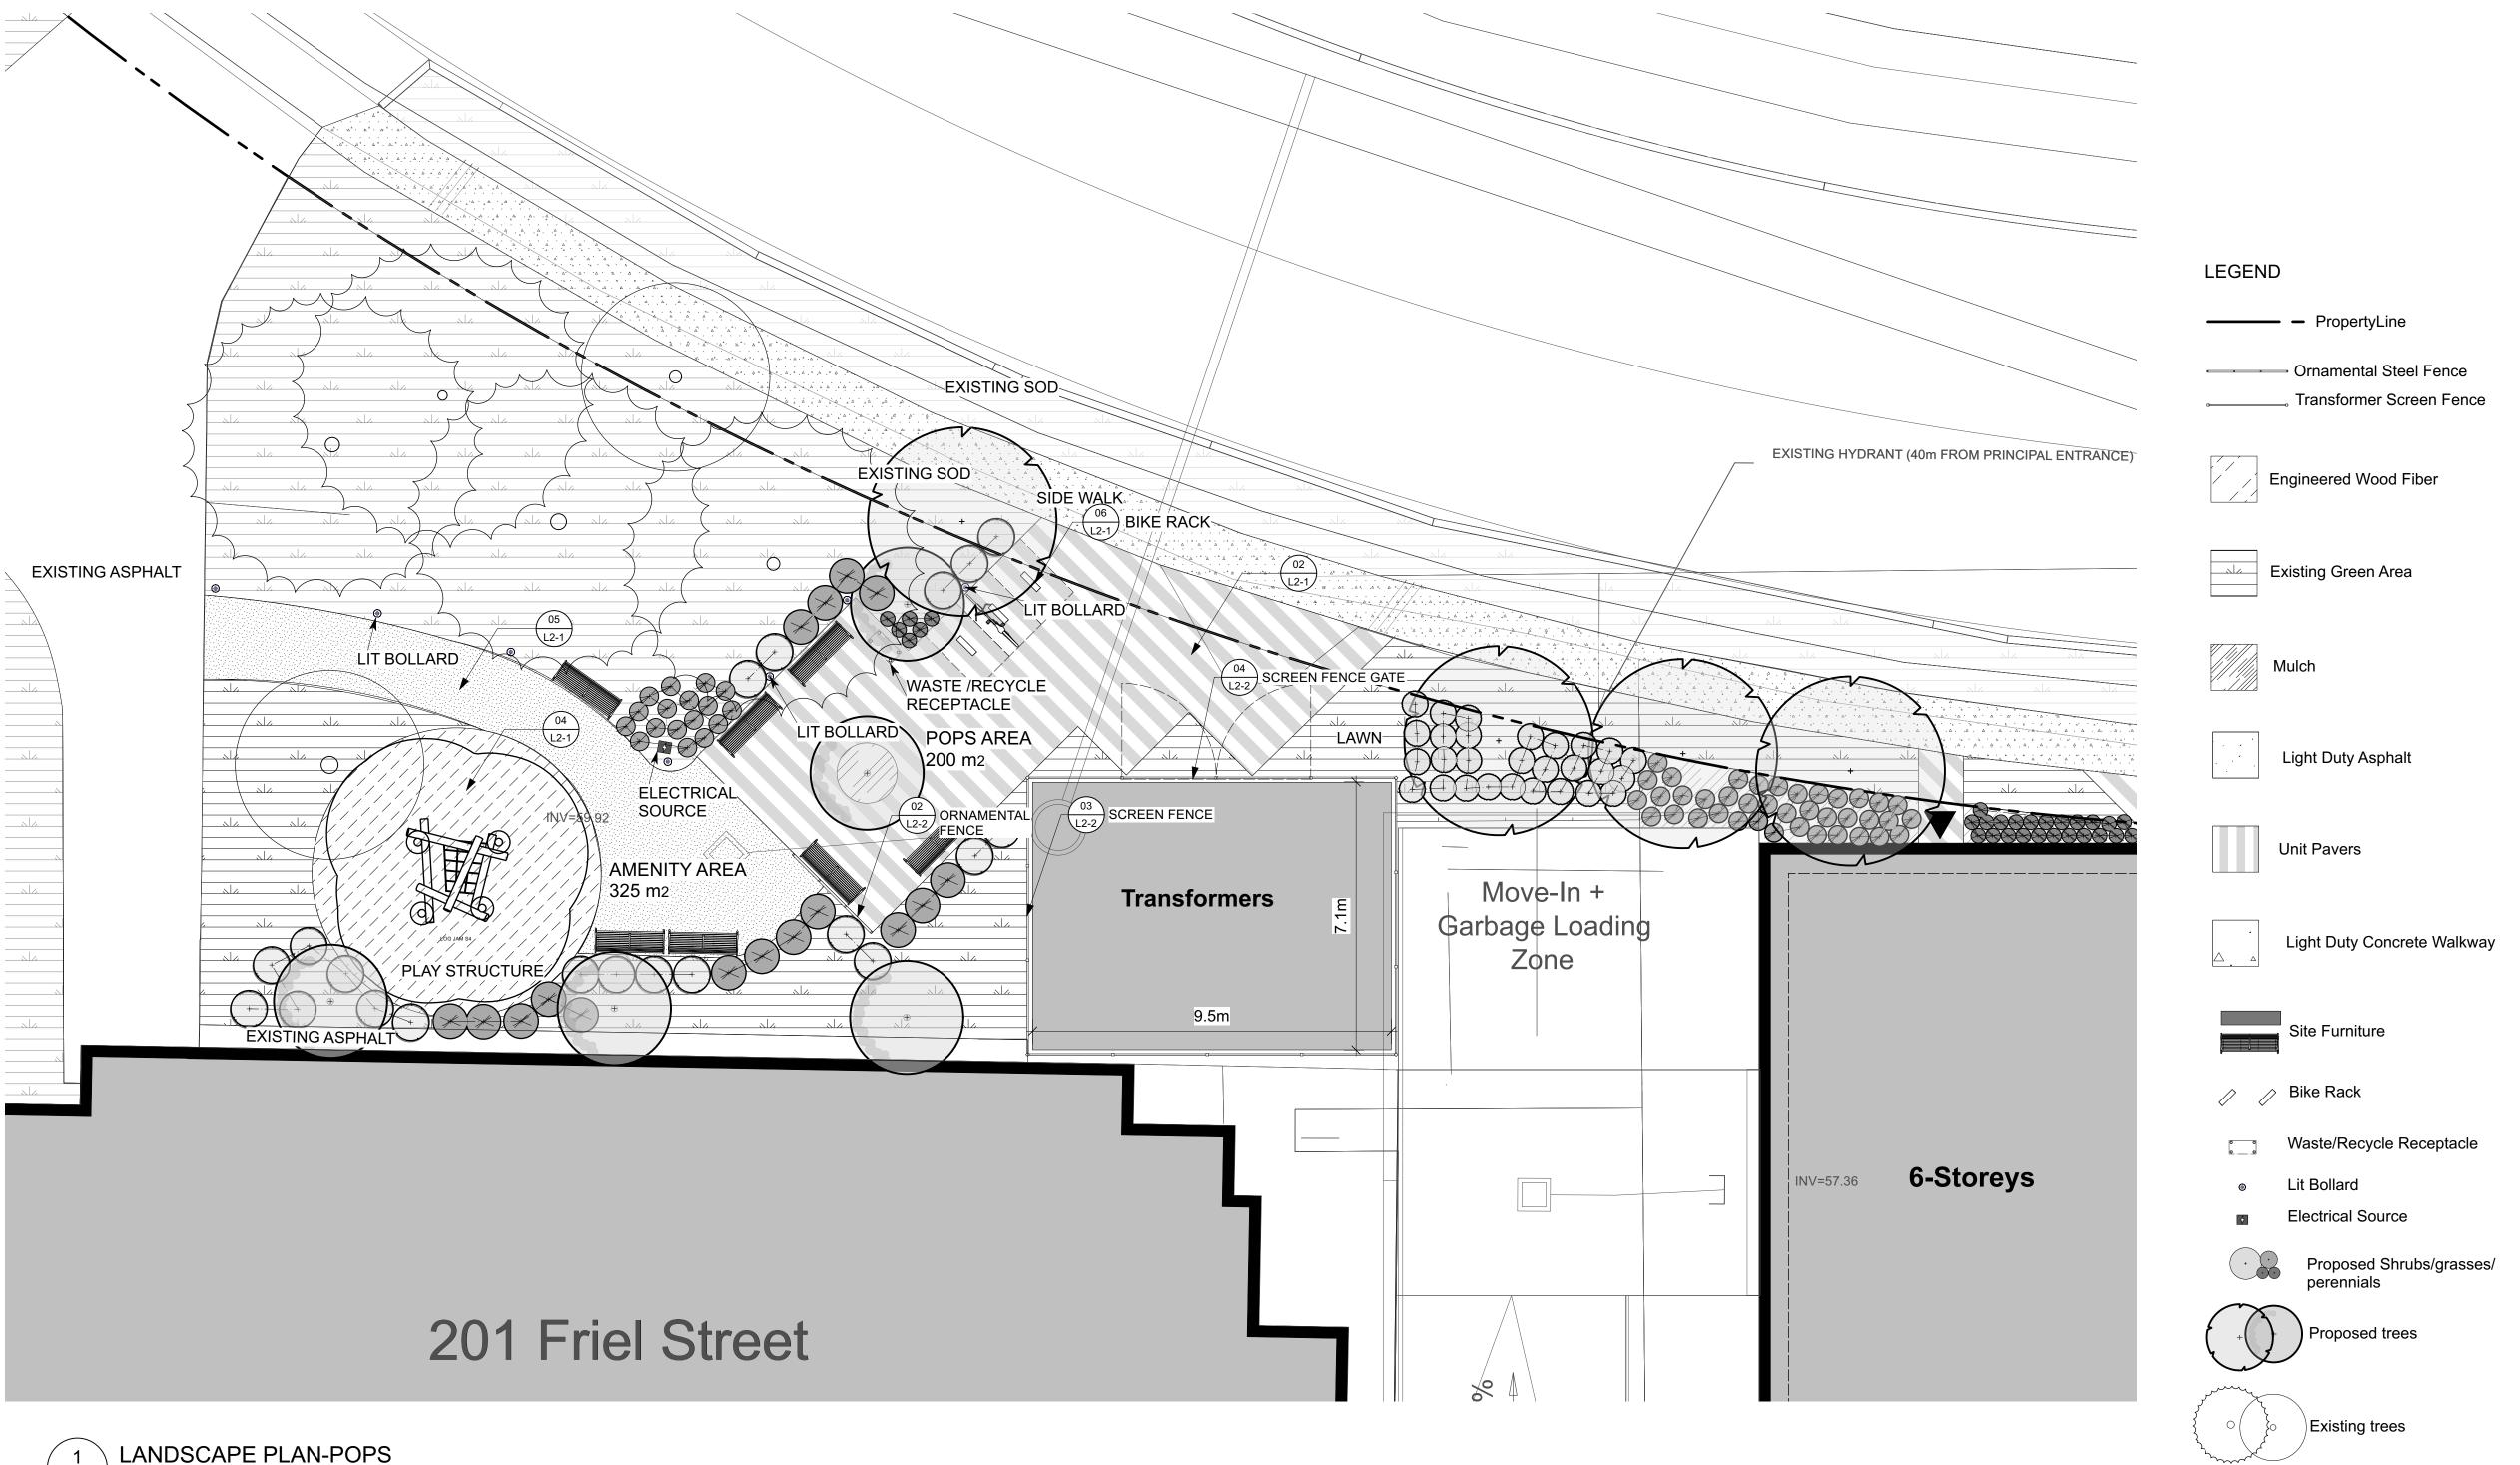

1 LANDSCAPE PLAN-POPS L1-02 Scale: 1:100



KEY PLAN, NTS

LANDSCAPE NOTES

1. All general site information and conditions compiled from architect's and engineer's plans and surveys.

2. Do not scale this drawing.

Report any discrepancies prior to commencing work. No responsibility is born by the Landscape Architect for unknown subsurface conditions.

4. Reinstate all areas and items damaged as a result of construction activities to the satisfaction of the Landscape

5. Drawing may not be used for construction until signed by Landscape Architect as issued for construction.

6. The accuracy of the position of utilities is not guaranteed. 7. Individual utility co. must be contacted for confirmation of utility existence and location prior to digging.

8. This drawing is an instrument of service and requires the permission of the Landscape Architect for use. Copyright is reserved by the Landscape Architect, David M. Lashley.

9. Plant material shall be No.1 Grade and shall comply with the Metric Guide Specifications for Nursery stock (latest edition), published by Canadian Nursery Trades Association.

10. Plant substitutions shall not be permitted unless approved by the Landscape Architect.

11. Obtain approval of planting prior to digging.

12. Topsoil shall be garden sirl mixture sandy loam with min. 5% organic matter and peat moss added at ratio of 1:10, topsoil to be

approved by Landscape Architect.




F 2023-12-11 ISSUED FOR SITE PLAN CONTROL-RESUBMISSION

2023-05-18 ISSUED FOR REZONING & SITE PLAN CONTROL-RS #1

B 2023-05-12 ISSUED FOR 100% SCHEMATIC DESIGN

A 2023-03-22 ISSUED FOR REZONING AND SITE PLAN CONTROL

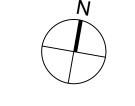







OCH 200/201 FREIL STREET

200/201 FREIL STREET, OTTAWA,

LANDSCAPE PLAN-POPS

LA PROJECT NO.:

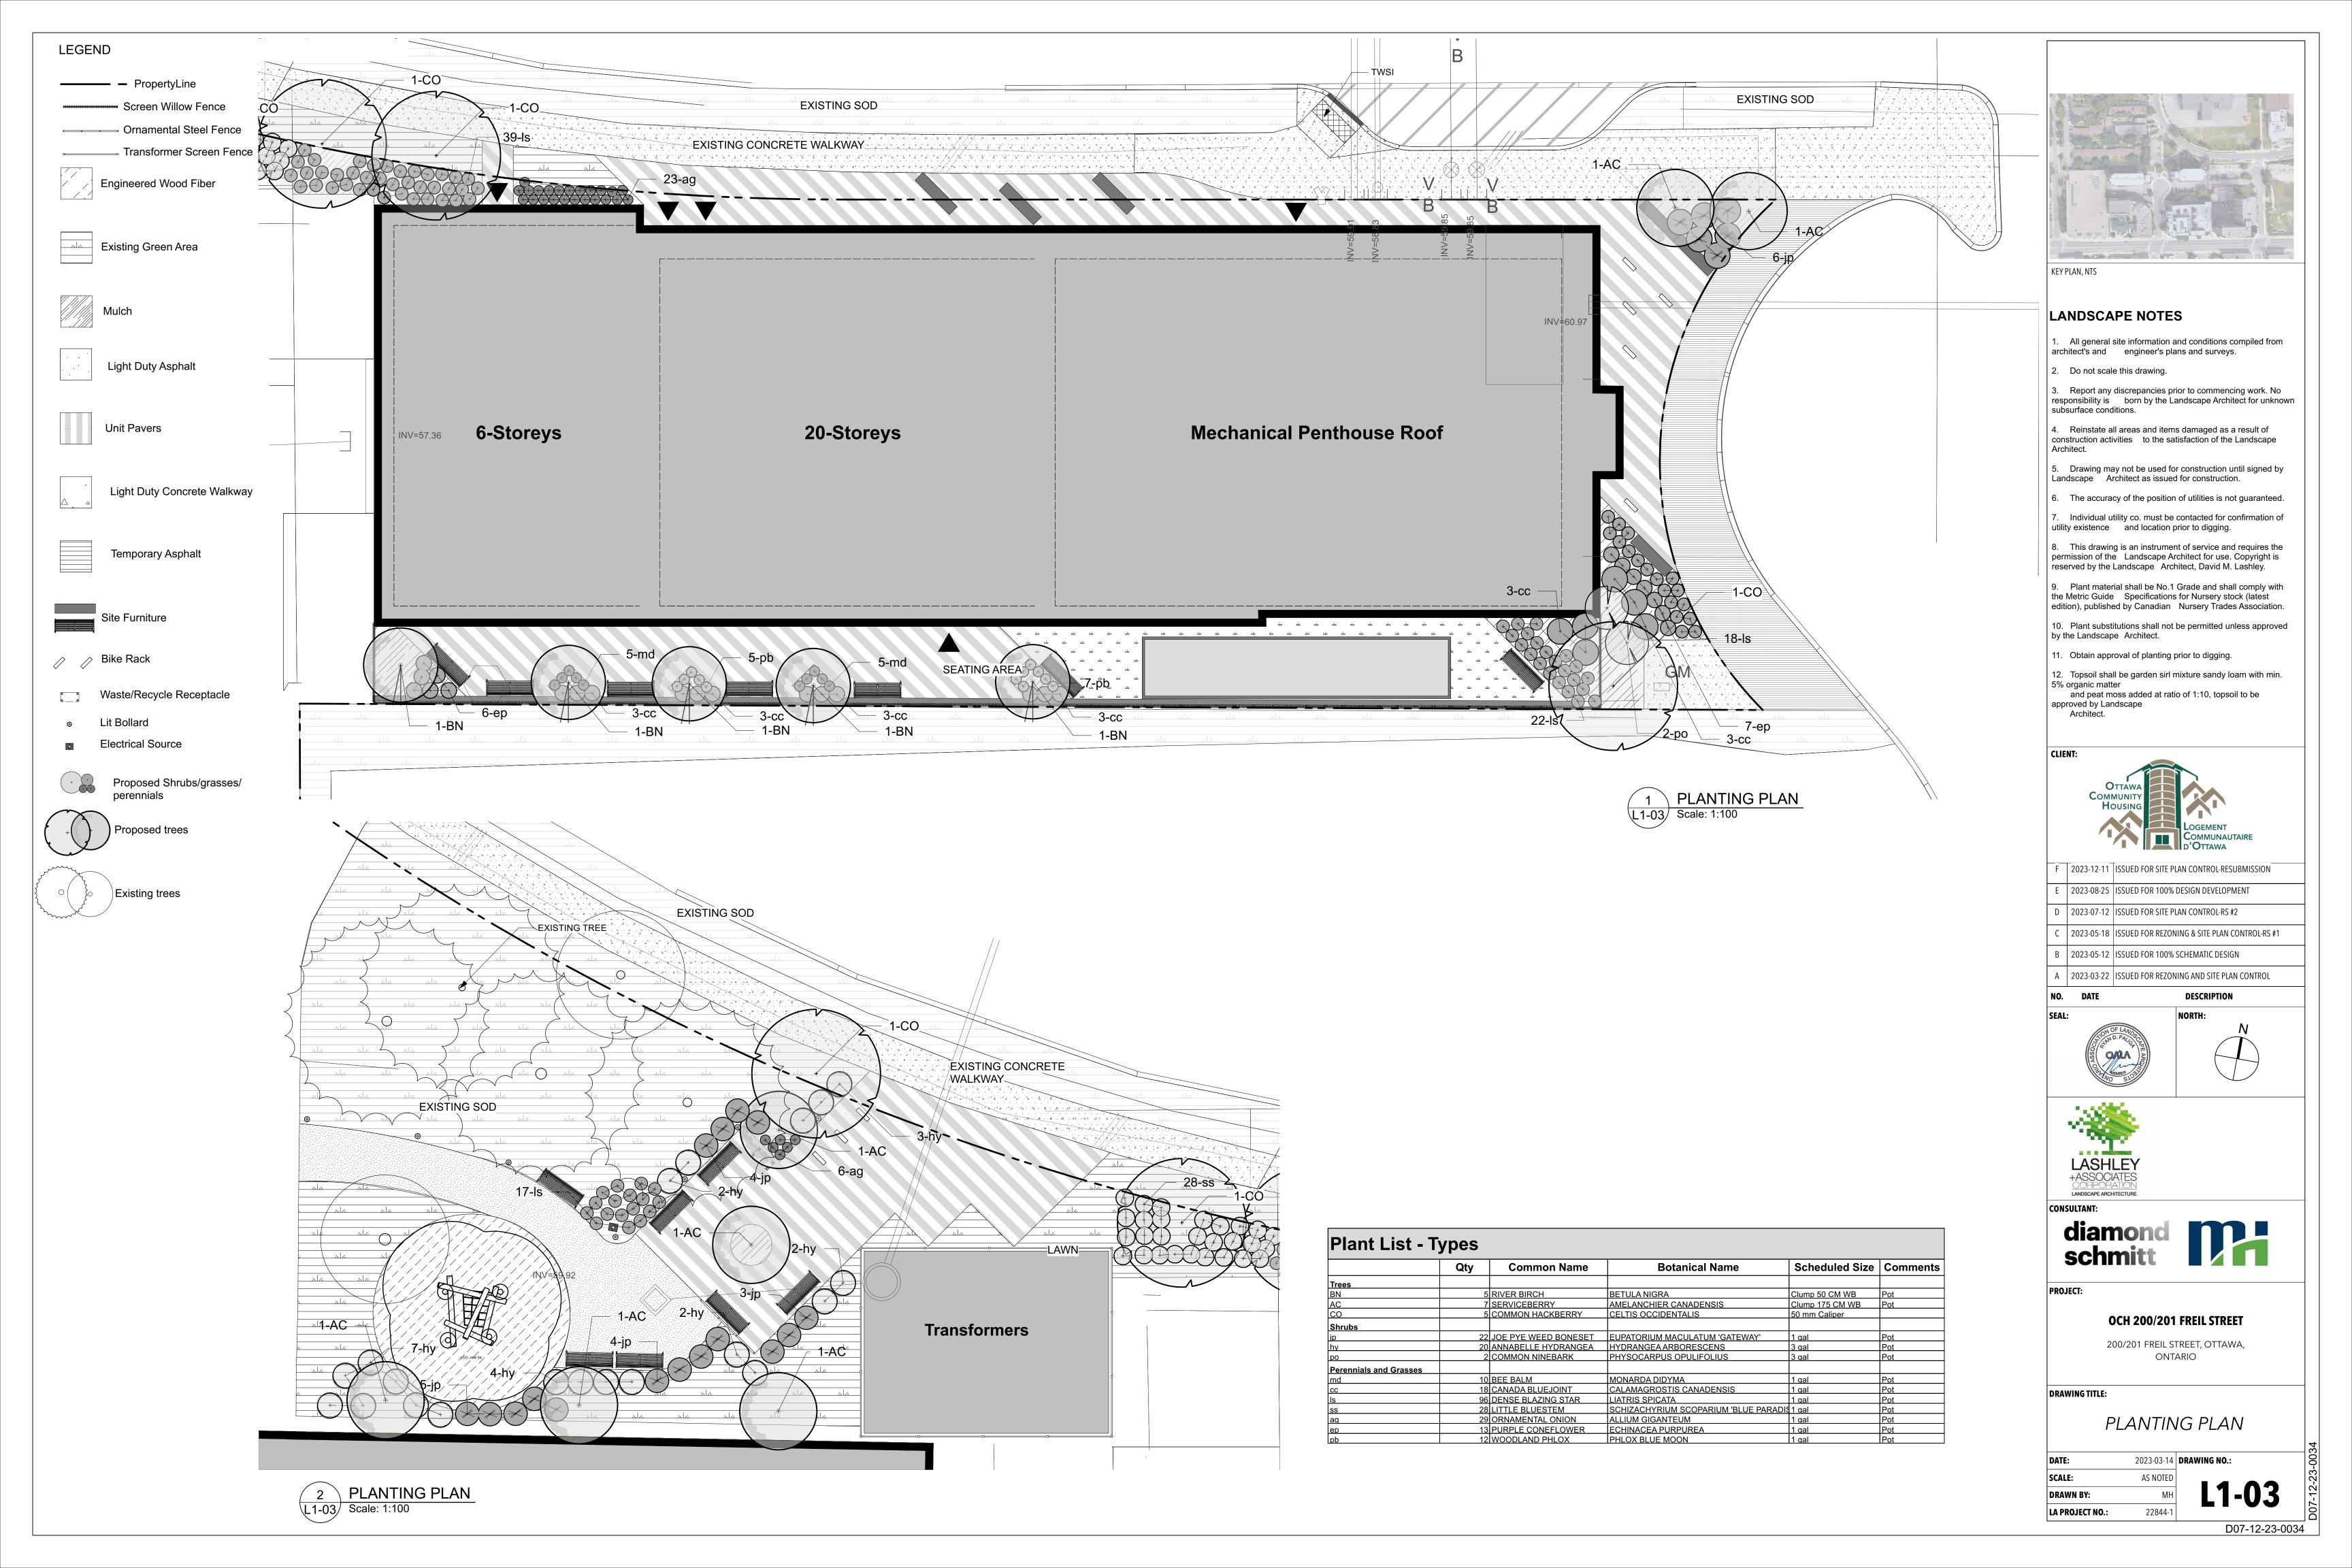

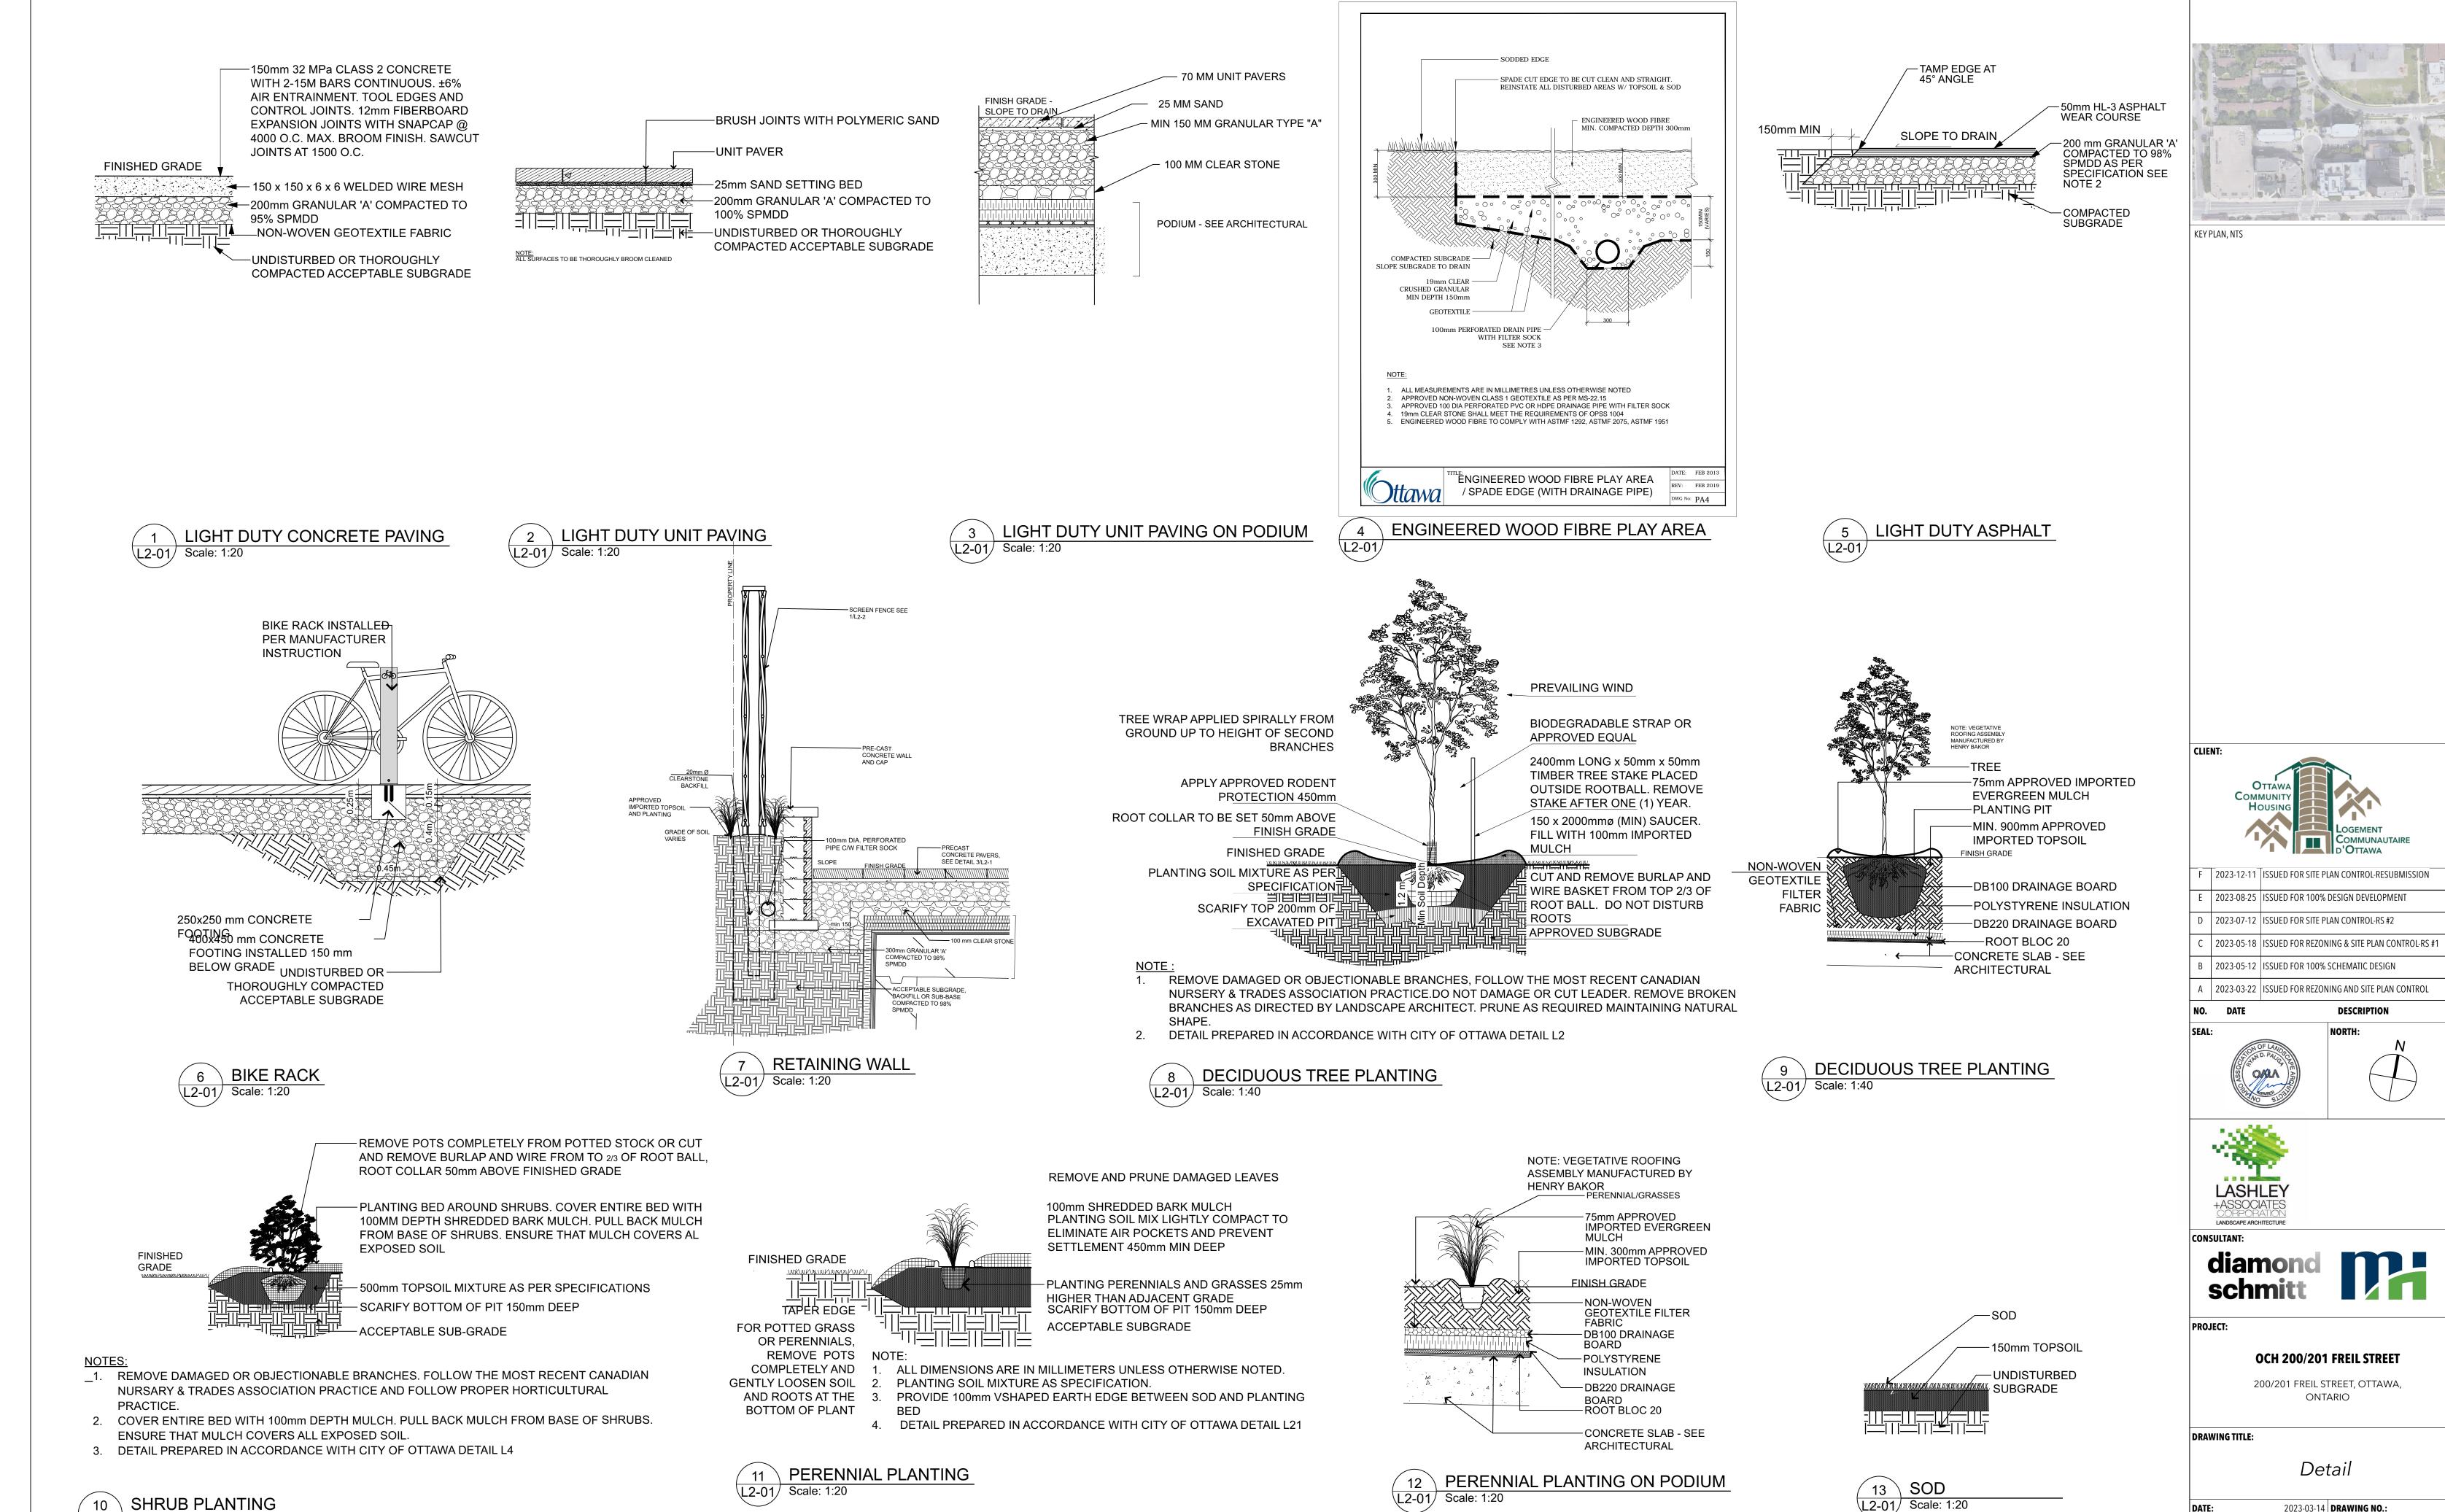

L2-01 Scale: 1:30

2023-03-14 **DRAWING NO.:**

D07-12-23-0034

DESCRIPTION

ONTARIO

Detail

AS NOTED


22844-1


SCALE:

DRAWN BY:

LA PROJECT NO.:


L2-01 Scale: 1:20

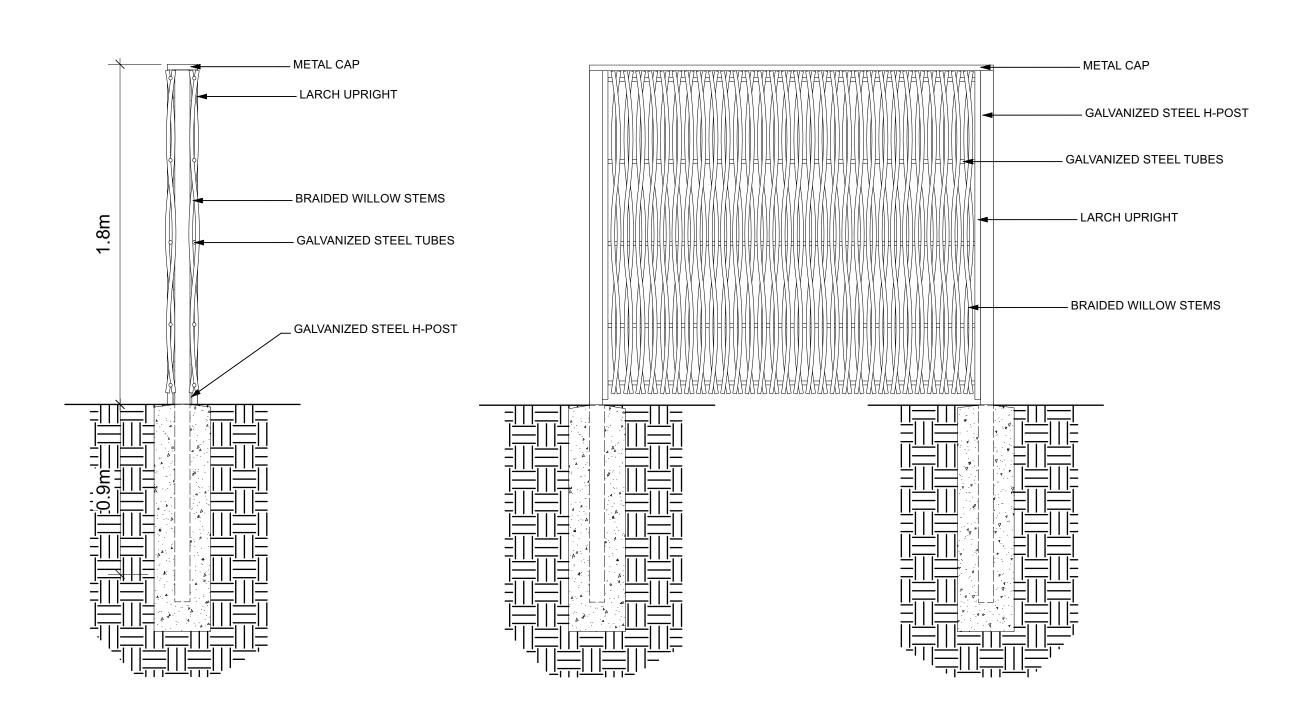


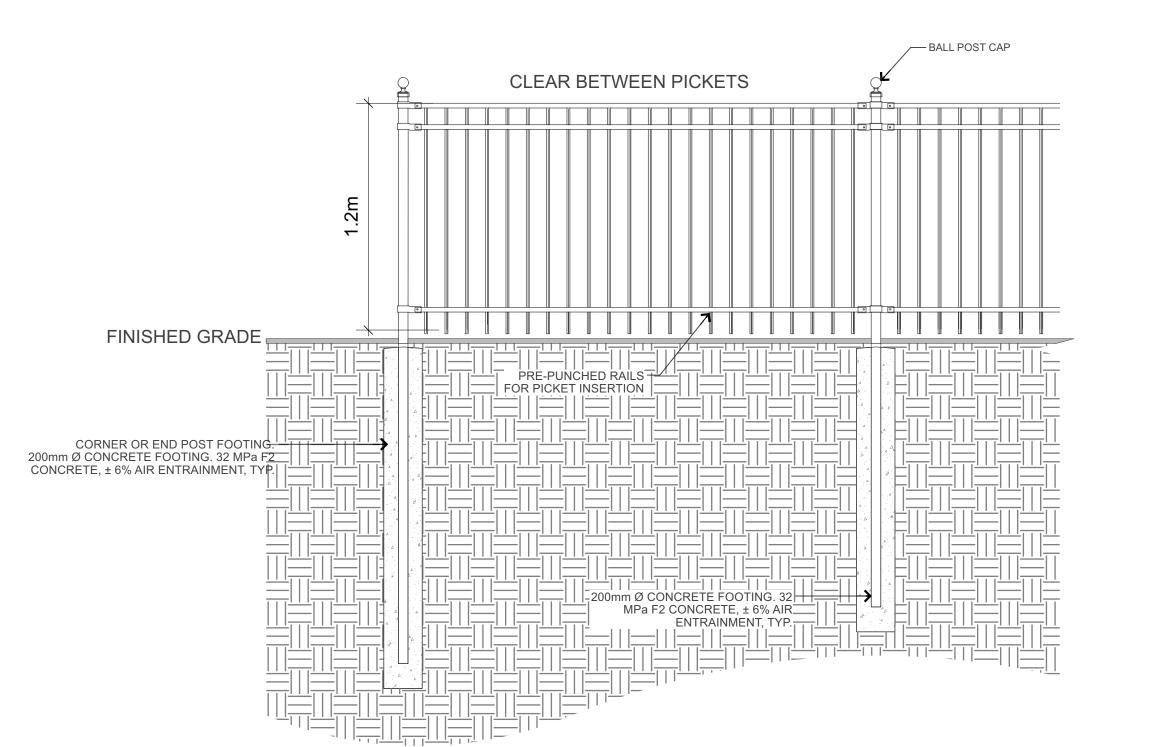

1 SCREEN WILLOW FENCE L2-02 Scale: 1:20

ORNAMENTAL STEEL FENCE
L2-02 Scale: 1:20

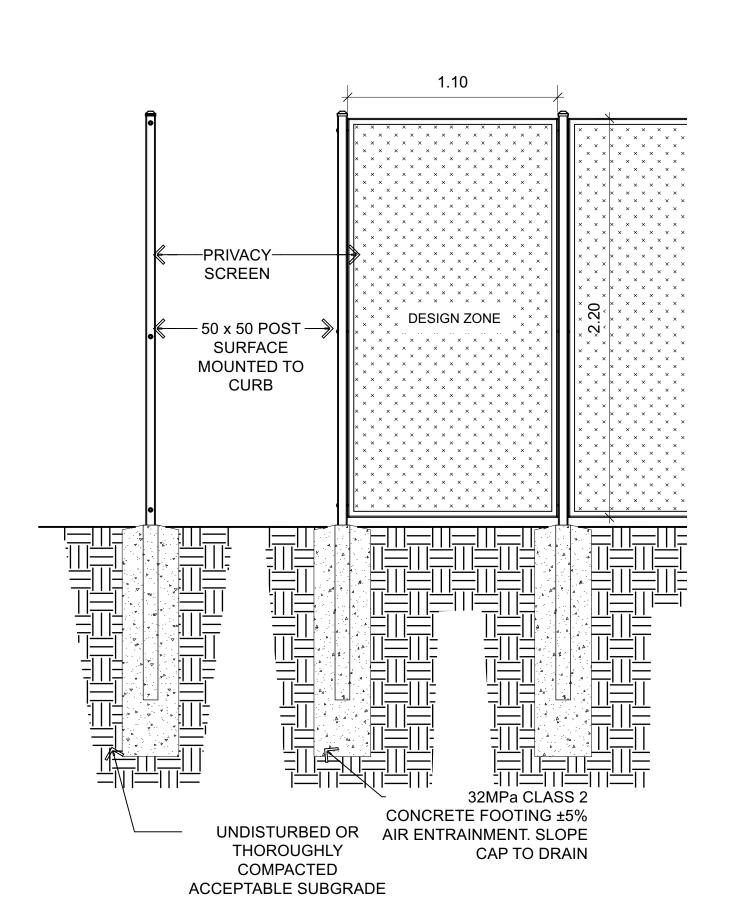

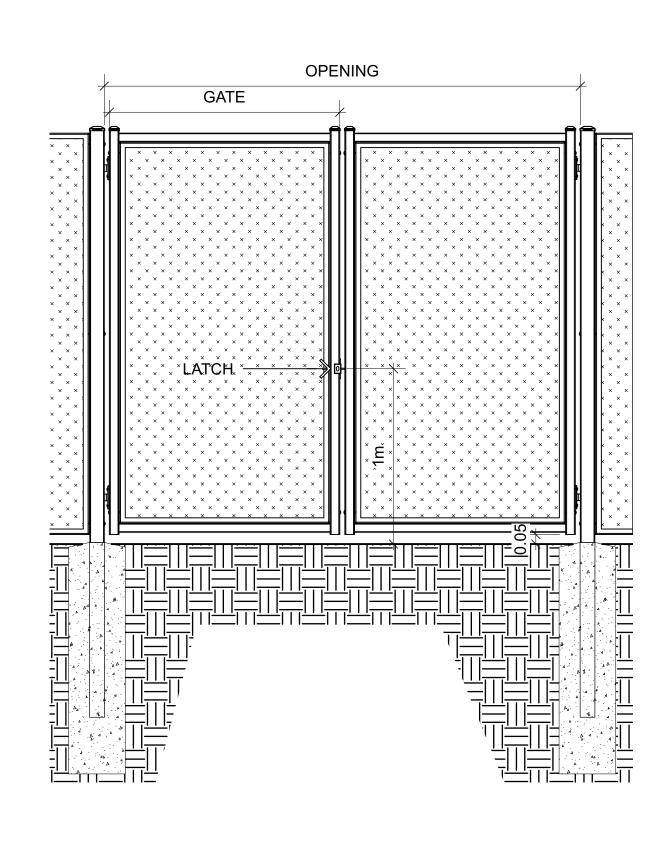









- 2023-12-11 ISSUED FOR SITE PLAN CONTROL-RESUBMISSION
- 2023-08-25 ISSUED FOR 100% DESIGN DEVELOPMENT
- D | 2023-07-12 | ISSUED FOR SITE PLAN CONTROL-RS #2
- 2023-05-18 ISSUED FOR REZONING & SITE PLAN CONTROL-RS #1
- B 2023-05-12 ISSUED FOR 100% SCHEMATIC DESIGN

A 2023-03-22 ISSUED FOR REZONING AND SITE PLAN CONTROL NO. DATE DESCRIPTION

OALA





LANDSCAPE ARCHITECTURE

OCH 200/201 FREIL STREET

200/201 FREIL STREET, OTTAWA, ONTARIO

DRAWING TITLE:

Detail

DATE:	2023-03-14	DRAWING NO.:
SCALE:	AS NOTED	
DRAWN BY:	МН	L2-02
LA PROJECT NO.:	22844-1	