

NEW SITE PLAN LEGEND	
	EXISTING BUILDING TO REMAIN
	DEMOLISH EXISTING BUILDING AND OBJECTS
	EXISTING BUILDING NOT IN CONTRACT
	NEW ADDITION BUILDING
	EXISTING ASPHALT TO REMAIN
	NEW ASPHALT
	EXISTING CONCRETE SIDEWALK TO REMAIN
	NEW CONCRETE SIDEWALK
	EXISTING CRUSHED STONE PARCKING TO REMAIN
	NEW GRANULAR PER LANDSCAPING
	EXISTING PLANTING TO REMAIN
	NEW PLANTING
\(\psi\) \(\	NEW GRASS
	EXISTING SAND PLAYGROUND TO REMAIN
	NEW SAND DLAYCDOLIND

NEW SAND PLAYGROUND

MUD SLAB PER CIVIL. (TEMPORARY CONSTRUCTION)

PROPERTY LINE

ROAD SETBACK

EXISTING FENCE TO REMAIN

——x——x—— NEW FENCE

TEMPORARY FENCE FOR PERIOD OF CONSTRUCTION

—TP— TREE PROTECTION PER LANDSCAPING —wtr——wtr——wtr— EXISTING WATER SUPPLY TO REMAIN

——wtr——wtr—— NEW WATER SUPPLY

REMAIN (BELOW GRADE) NEW ELECTRICAL SERVICE (BELOW GRADE)

EXISTING ELECTRICAL SERVICE TO

**BUILDING ENTRANCE / EXIT** LIGHT STAND - EXISTING

⊕ Ls LIGHT STAND - NEW MANHOLE - EXISTING

> MANHOLE - NEW UTILITY POLE - EXISTING

UTILITY POLE - NEW TREE - EXISTING

TREE - NEW

80 TEMPORARY CONSTRUCTION PERIMETER BARRIER PER 81 RELOCATE EXISTING PRECAST STORAGE UNITS AT NEW POSITION AS SHOWN. REPLACE EXISTING SOIL WITH COMPACTED GRANULAR B TO FROST PROTECTION DEPTH PER GEOTECHNICAL REPORT. PROVIDE 200mm DEEP COMPACTED GRANULAR A BED UNDER PRECAST UNITS

NEW WASTE BIN STORAGE COMPLETED WITH 1829mm HIGH ENCLOSURE AND 1067mm WIDE ACCESS GATE.

83 NEW TREE PER LANDSCAPING

#### **SITE PLAN KEYNOTES:**

- 1 EXISTING SKATING RING TO REMAIN
- 2 EXISTING SOCCER FIELD TO REMAIN
- 3 EXISTING BASEBALL DIAMOND TO REMAIN
- 4 EXISTING COVERED DECK TO REMAIN
- 5 EXISTING PORCH STRUCTURES AND FENCE TO REMAIN
- 6 EXISTING ROOF OVERHANG ABOVE TO REMAIN
- EXISTING DRILLED WELL TO REMAIN. VERIFY LOCATION ON SITE. PROTECT WELL PER CIVIL. REGRADE ADJACENT
- SURFACE PER CIVIL. 8 EXISTING ASPHALT PAVING TO REMAIN
- 9 EXISTING CURB TO REMAIN
- | 10 | EXISTING ASPHALT SIDEWALK TO REMAIN
- 11 EXISTING SEPTIC TANK TO REMAIN
- 12 EXISTING SEPTIC DRAIN FIELD TO REMAIN. ELIMINATE AUTOMOBILE AND EQUIPMENT MOVEMENT OVER THIS
- 13 PARKING SPACES RESERVED FOR SOCCER TEAMS DURING
- CONSTRUCTION 14 EXISTING GRAVEL PARKING TO REMAIN
- 15 EXISTING ACCESSIBLE CONCRETE CURB RAMP AND DEPRESSED CURB TO REMAIN
- 16 EXISTING HOSE BIB TO REMAIN. ENSURE RUNNING WATER FOR HOCKEY RING DURING CONSTRUCTION.
- 18 EXISTING BENCH TO REMAIN

17 EXISTING PLAYGROUND TO REMAIN

- 19 EXISTING SEPTIC FIELD AND SANITARY SERVICE. SHOWN LOCATIONS ARE APPROXIMATE. VERIFY LOCATIONS ON
- 20 PORTION OF EXISTING LUMBER FENCE TO REMAIN. COORDINATE EXTENT ON SITE.
- 21 PORTION OF EXISTING ASPHALT SIDEWALK TO REMAIN
- 22 PORTION OF EXISTING CONCRETE CURB TO REMAIN
- 23 PORTION OF EXISTING ASPHALT PAVING TO REMAIN
- 51 REQUIRED STRUCTURE SETBACK
- 52 NEW CONCRETE PAVING PER LANDSCAPING
- NEW GRANULAR PER LANDSCAPING
- 54 NEW ROOF OVERHANG ABOVE
- 55 NEW HEAT PUMP AND CONDENSING UNITS PER MECHANICAL ON CONCRETE PAD. SURROUND BY LINK FENCE WITH LOCKABLE ACCESS GATE.
- NEW TOP SOIL AND GRASS AT AREA AFFECTED BY
- CONSTRUCTION AND PER LANDSCAPING NEW ACCESS ROUTE FOR FIRE DEPARTMENT (SHOWN
- 12000mm MIN. NEW HEAVY DUTY GRAVEL PAVEMENT STRUCTURE DESIGNED TO SUPPORT FIREFIGHTING EQUIPMENT AND

DASHED). CLEAR WIDTH 6000mm MIN., CENTERLINE RADIUS

- PERMIT ACCESSIBILITY UNDER ALL CLIMATIC CONDITIONS PER CIVIL
- NEW ASPHALT HEAVY DUTY PAVEMENT STRUCTURE DESIGNED TO SUPPORT FIRE FIGHTING EQUIPMENT PER
- 60 EXTEND DRIVEWAY PER CIVIL AS REQUIRED. VERIFY EXTENT OF EXISTING DRIVEWAY ON SITE.
- 61 EXTEND CULVERT PER CIVIL AS REQUIRED. VERIFY EXTENT OF EXISTING CULVERT ON SITE. 62 TEMPORARY FENCING COMPLETED WITH ACCESS GATES
- 63 NEW POST AND ACCESSIBLE PARKING SIGN.
- 64 NEW SANITARY SEWAGE PER CIVIL

FOR PERIOD OF CONSTRUCTION

- 65 NEW PLANTING PER LANDSCAPING
- 66 INSTALL SALVAGED BICYCLE RACKS. ADJUST AS REQUIRED.
- 67 INSTALL SALVAGED SWINGS PER LANDSCAPING
- INSTALL SALVAGED PLAY STRUCTURES PER LANDSCAPING
- 69 NEW PLAY GROUND EXTENSION PER LANDSCAPING
- 70 AREA FOR FUTURE SEPTIC FIELD EXPANSION PER LANDSCAPING
- 71 POND PER CIVIL
- | 72 | TEMPORARY CONSTRUCTION. MUD MAT PER CIVIL ON TOP OF EXISTING ASPHALT SITE ENTRANCE.
- 73 NEW HOLDING TANKS FOR FIRE PROTECTION PER CIVIL C/W FIRE SERVICE CONNECTIONS AND ROUND ACCESS
- 74 COVERED DRAINAGE PIPE PER CIVIL
- NEW POST AND SIGN C/W WORDING: " 6 METER WIDE FIRE ROUTE WITHIN PARKING AISLE. NO PARKING ON FIRE
- NEW POST AND SIGN C/W WORDING: " END OF FIRE
- SNOW STORAGE AREA
- PROVIDE NEW CONCRETE CURB AS REQUIRED FOR NEW ACCESSIBLE PARKING CONSTRUCTION. REINSTATE ASPHALT PAVING AND BASE COURSES. MATCH EXISTING CONCRETE CURB AND EXISTING PAVING ASSEMBLIES AT SIDEWALK AND PARKING SPOTS. MAKE ALL JUNCTION SMOOTH AND IN STRAIGHT LINES
- 79 PROVIDE NEW CONTRASTING PAINTING AT FACE OF ASPHALT WITHIN 1500mm ACCESS AISLE. REINSTATE PAVING MARKINGS CONTAINING INTERNATIONAL SYMBOL OF ACCESSIBILITY.

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**CITY OF OTTAWA** 

OTTAWA

ONTARIO, CANADA

PROJECT

CLIENT

**CORKERY COMMUNITY** HALL EXPANSION


3447 OLD ALMONTE RD., CARP, ON KOA 1L0 TITLE

**SITE PLAN** 

PROJECT NO: 2020-0640 DRAWN: APPROVED: SCALE: As indicated

DATE PRINTED: 2023-06-12 4:50:28 PM REV

DRAWING NO.

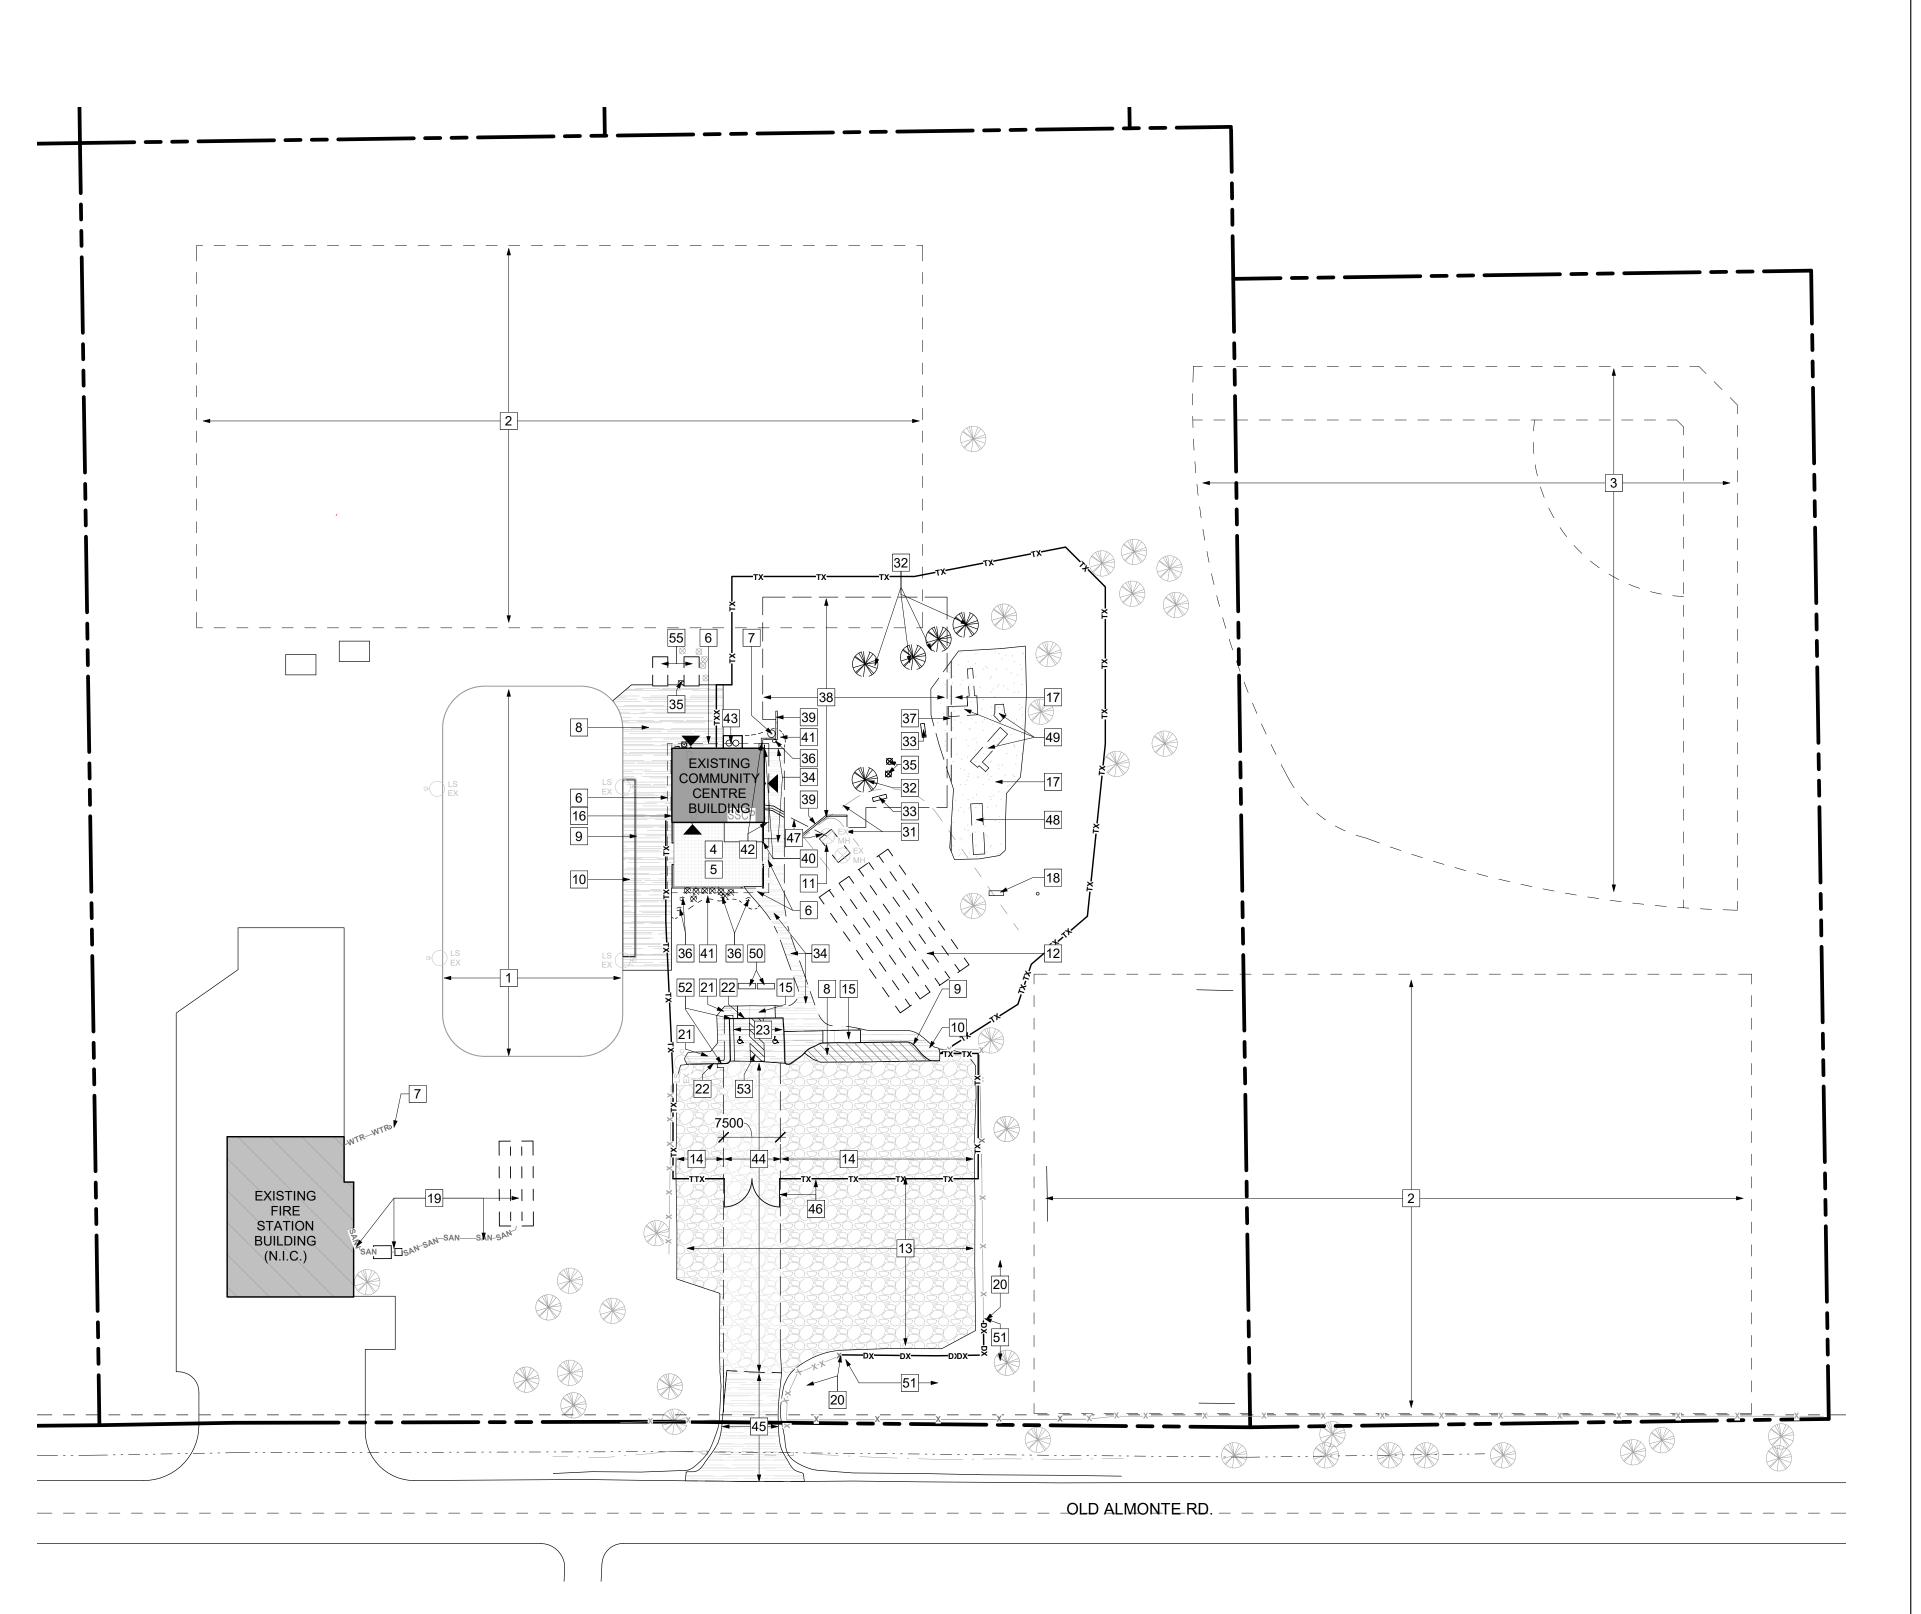

### 1 SITE PLAN - DEMOLITION

#### **DEMOLITION SITE PLAN KEYNOTES:**

- 1 EXISTING SKATING RING TO REMAIN
- 2 EXISTING SOCCER FIELD TO REMAIN
- 3 EXISTING BASEBALL DIAMOND TO REMAIN
- 4 EXISTING COVERED DECK TO REMAIN
- 5 EXISTING PORCH STRUCTURES AND FENCE TO REMAIN
- 6 EXISTING ROOF OVERHANG ABOVE TO REMAIN
- 7 EXISTING DRILLED WELL TO REMAIN. PROTECT WELL PER
- 8 EXISTING ASPHALT PAVING TO REMAIN
- 9 EXISTING CURB TO REMAIN
- 10 EXISTING ASPHALT SIDEWALK TO REMAIN

14 EXISTING GRAVEL PARKING TO REMAIN

- 11 EXISTING SEPTIC TANK TO REMAIN EXISTING SEPTIC DRAIN FIELD TO REMAIN. ELIMINATE
- AUTOMOBILE AND EQUIPMENT MOVEMENT OVER THIS
- 13 PARKING SPACES RESERVED FOR SOCCER TEAMS DURING CONSTRUCTION
- 15 EXISTING ACCESSIBLE CONCRETE CURB RAMP AND DEPRESSED CURB TO REMAIN
- 16 EXISTING HOSE BIB TO REMAIN. ENSURE RUNNING WATER FOR HOCKEY RING DURING CONSTRUCTION.
- 17 EXISTING PLAYGROUND TO REMAIN
- 18 EXISTING BENCH TO REMAIN
- 19 EXISTING SEPTIC FIELD AND SANITARY SERVICE. SHOWN LOCATIONS ARE APPROXIMATE. VERIFY LOCATIONS ON
- 20 PORTION OF EXISTING LUMBER FENCE TO REMAIN. COORDINATE EXTENT ON SITE.
- 21 PORTION OF EXISTING ASPHALT SIDEWALK TO REMAIN PORTION OF EXISTING CONCRETE CURB TO REMAIN
- 23 PORTION OF EXISTING ASPHALT PAVING TO REMAIN
- 31 REQUIRED STRUCTURE SETBACK
- 32 REMOVE EXISTING TREE
- REMOVE EXISTING BENCH. REPAIR, CLEAN AND STORE FOR RE-USE AT NEW CONSTRUCTION
- REMOVE EXISTING ASPHALT PAVING AND BASE COURSES AS REQUIRED FOR NEW CONSTRUCTION. CUT ASPHALT IN STRAIGHT LINE.
- 35 REMOVE EXISTING SHRUBS
- 36 REMOVE EXISTING BOULDER
- REMOVE PORTION OF EXISTING PLAYGROUND AS REQUIRED FOR FOUNDATION EXCAVATION AND NEW LANDSCAPING. MINIMIZE REMOVAL ON SITE.
- 38 EXCAVATE AS REQUIRED FOR FOUNDATION CONSTRUCTION PER GEOTECHNICAL. CONSIDER EXTENT OF EXCAVATION SLOPES PER GEOTECHNICAL.
- 39 NEW SHORING AS REQUIRED TO PROTECT EXISTING WATER WELL / SANITARY TANK FOR PERIOD OF WORK. REMOVE UPPER PORTION OF SHORING FOR PROPER LANDSCAPING WHEN SAFE FOR WELL AT THE END OF CONSTRUCTION.
- PROTECT EXISTING FOUNDATION FOR PERIOD OF WORK. PROVIDE ADEQUATE UNDERPINNING AND SHORING AS
- 41 REMOVE EXISTING PLANTING AS REQUIRED FOR EXCAVATION.
- 42 REMOVE EXISTING ROOF AS REQUIRED FOR NEW CONSTRUCTION.

AND ALL ASSOCIATED COMPONENTS

- REMOVE PROPANE TANKS SURROUNDED BY LINK FENCE
- VERIFY EXISTING GRAVEL THICKNESS ON SITE. REMOVE EXISTING GRAVEL AND SOIL IF REQUIRED TO ACCOMMODATE NEW HEAVY DUTY GRAVEL ACCESS ROUTE ASSEMBLY.
- VERIFY EXISTING ROAD ASSEMBLY ON SIDE. REMOVE EXISTING ASPHALT PAVING, ASSOCIATED BASE COURSES AND SOIL IF REQUIRED FOR NEW ACCESS ROUTE HEAVY DUTY PAVING STRUCTURE.
- TEMPORARY FENCING COMPLETED WITH ACCESS GATES FOR PERIOD OF CONSTRUCTION
- 47 REMOVE EXISTING SANITARY MAIN FROM EXISTING BUILDING TO EXISTING SEPTIC TANK TO REMAIN
- REMOVE EXISTING SWING. INSPECT, REPAIR, CLEAN AND STORE FOR RE-USE AT NEW CONSTRUCTION
- 49 REMOVE EXISTING PLAY STRUCTURE. INSPECT, REPAIR,

CLEAN AND STORE FOR RE-USE AT NEW CONSTRUCTION

50 REMOVE EXISTING BICYCLE RACKS. INSPECT, REPAIR,

AFFECTED AREAS.


- CLEAN AND STORE FOR RE-USE AT NEW CONSTRUCTION 51 REMOVE EXISTING LUMBER FENCE AND POSTS. COORDINATE ON SITE EXTENT OF REMOVAL TO THE NEAREST POST. FILL AND COMPACT THE HOLES AFTER POST REMOVAL. REINSTATE TOP SOIL AND SEED GRASS AT
- 52 REMOVE PORTION OF EXISTING CURB AND ASPHALT PAVING AND BASE COURSES AS REQUIRED FOR NEW CURB CONSTRUCTION. CUT ASPHALT IN STRAIGHT LINE. MINIMIZE
- 753 REMOVE EXISTING PAINTING FROM THE FACE OF ASPHALT. PROTECT EXISTING TO REMAIN ASPHALT
- ACCURATELY REMOVE EXISTING PRECAST STORAGE UNIT FOR RELOCATION TO NEW POSITION. REMOVE EXISTING BEDDING AND FOUNDATION UNDER THE EXISTING PRECAST UNIT AS REQUIRED FOR NEW GRADING.

#### SITE PLAN GENERAL NOTES

- A. DO NOT SCALE THIS DRAWING B. REPORT ANY DISCREPANCIES PRIOR TO COMMENCING WORK. NO RESPONSIBILITY IS BORN BY THE CONSULTANT FOR
- UNKNOWN SUBSURFACE CONDITIONS C. CONTRACTOR TO CHECK AND VERIFY ALL DIMENSIONS ON SITE AND REPORT ANY ERRORS AND/OR OMISSIONS TO THE
- CONSULTANT D. REINSTATE ALL AREAS AND ITEMS DAMAGED AS A RESULT OF CONSTRUCTION ACTIVITIES TO THE SATISFACTION OF THE
- CONSULTANT E. CONTRACTOR TO LAYOUT PLANTING BEDS. PATHWAYS ETC. TO APPROVAL OF CONSULTANT PRIOR TO ANY JOB
- **EXCAVATION** . THE ACCURACY OF THE POSITION OF UTILITIES IS NOT GUARANTEED - CONTRACTOR TO VERIFY PRIOR TO
- G. INDIVIDUAL UTILITY COMPANY MUST BE CONTACTED FOR CONFIRMATION OF UTILITY EXISTENCE AND LOCATION PRIOR
- TO DIGGING H. ALL DISTURBED AREAS TO BE RESTORED TO ORIGINAL

### CONDITION OR BETTER UNLESS OTHERWISE NOTED

#### **DEMOLITION SITE PLAN LEGEND**

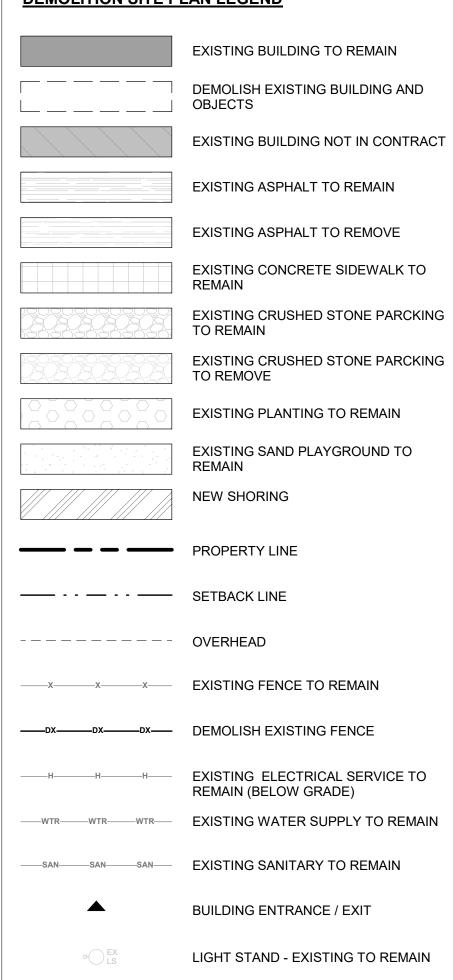

MANHOLE - EXISTING TO REMAIN

TREE - EXISTING TO REMAIN

SHRUB - EXISTING OT REMAIN

TREE - DEMOLITION

SHRUB - DEMOLITION

UTILITY POLE - EXISTING TO REMAIN

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# **CITY OF OTTAWA**

OTTAWA ONTARIO, CANADA

PROJECT

TITLE

### **CORKERY COMMUNITY** HALL EXPANSION

3447 OLD ALMONTE RD., CARP, ON K0A 1L0

# **DEMOLITION SITE PLAN**


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DRAWING NO.

D101



NEW NON-CORROSIVE PRE-FINISHED METAL FASCIA

OF WATER WELL

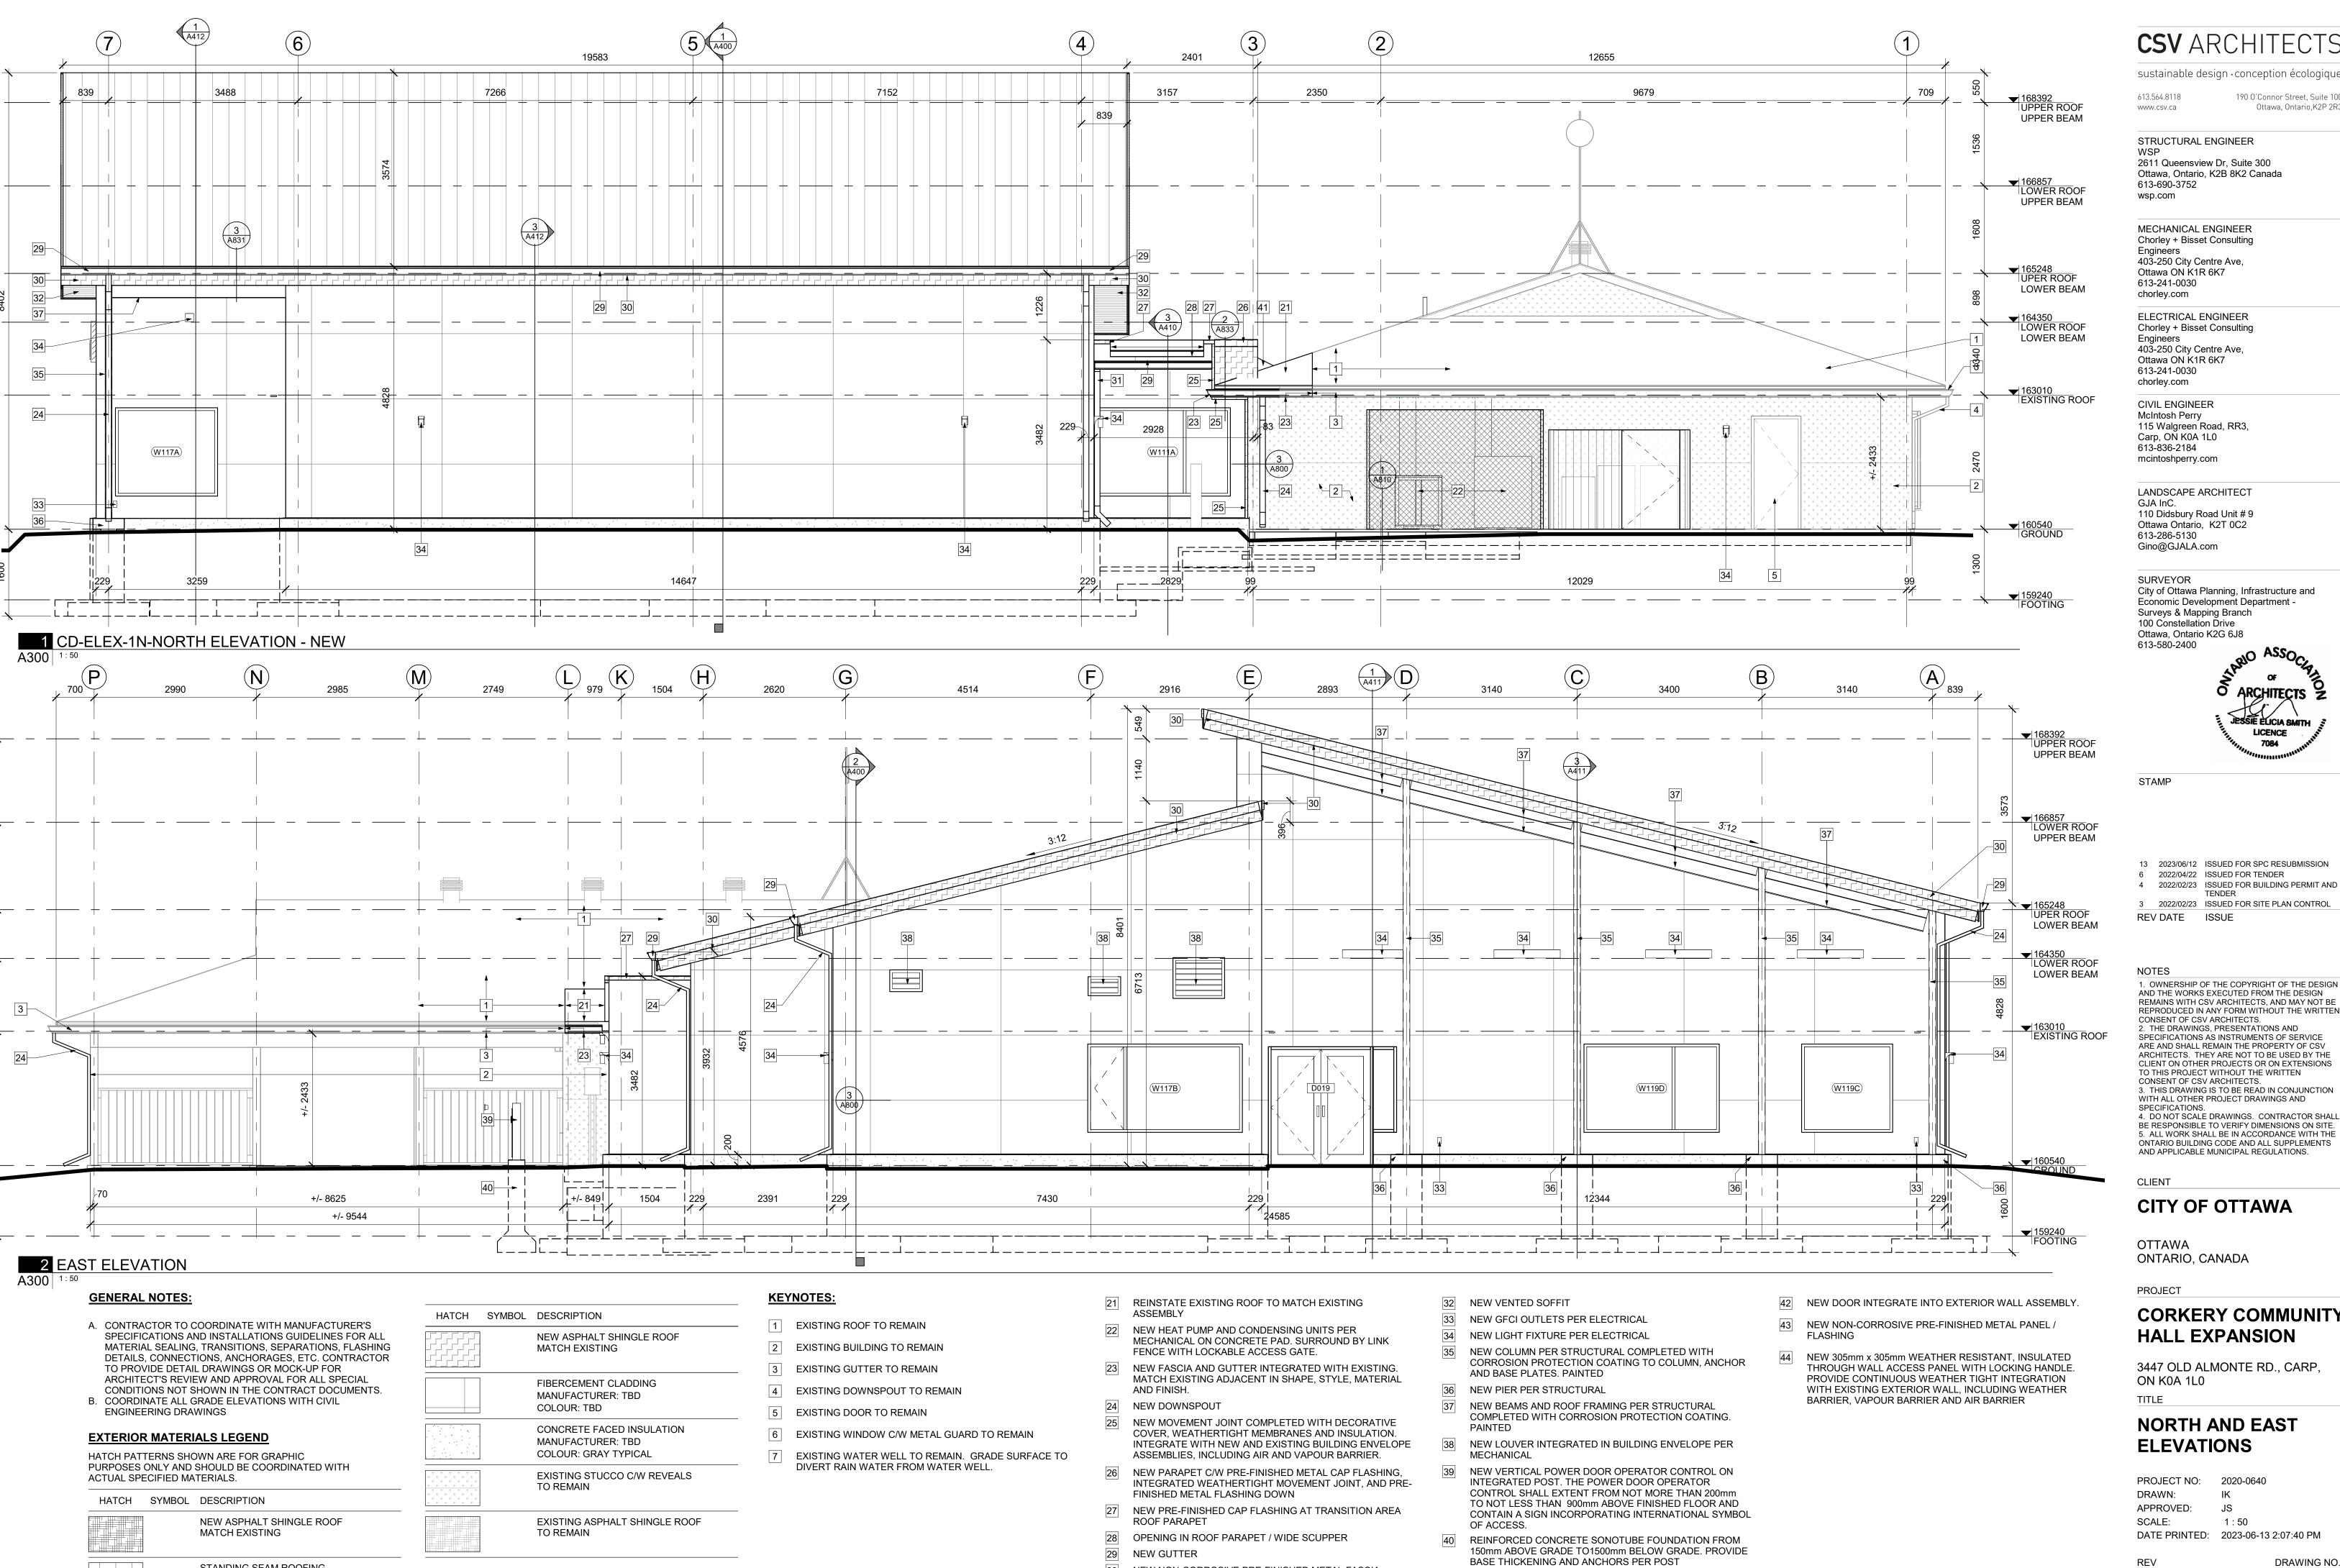NEW DOWNSPOUT. EXTEND ALONG WALL AND DIVERT OUT

MANUFACTURER.

NEW ROOF CRICKET

STANDING SEAM ROOFING

MANUFACTURER: TBD

COLOUR: TBD

**CSV** ARCHITECTS

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# **CORKERY COMMUNITY** HALL EXPANSION


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## **NORTH AND EAST ELEVATIONS**

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A300



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#### CITY OF OTTAWA

OTTAWA ONTARIO, CANADA

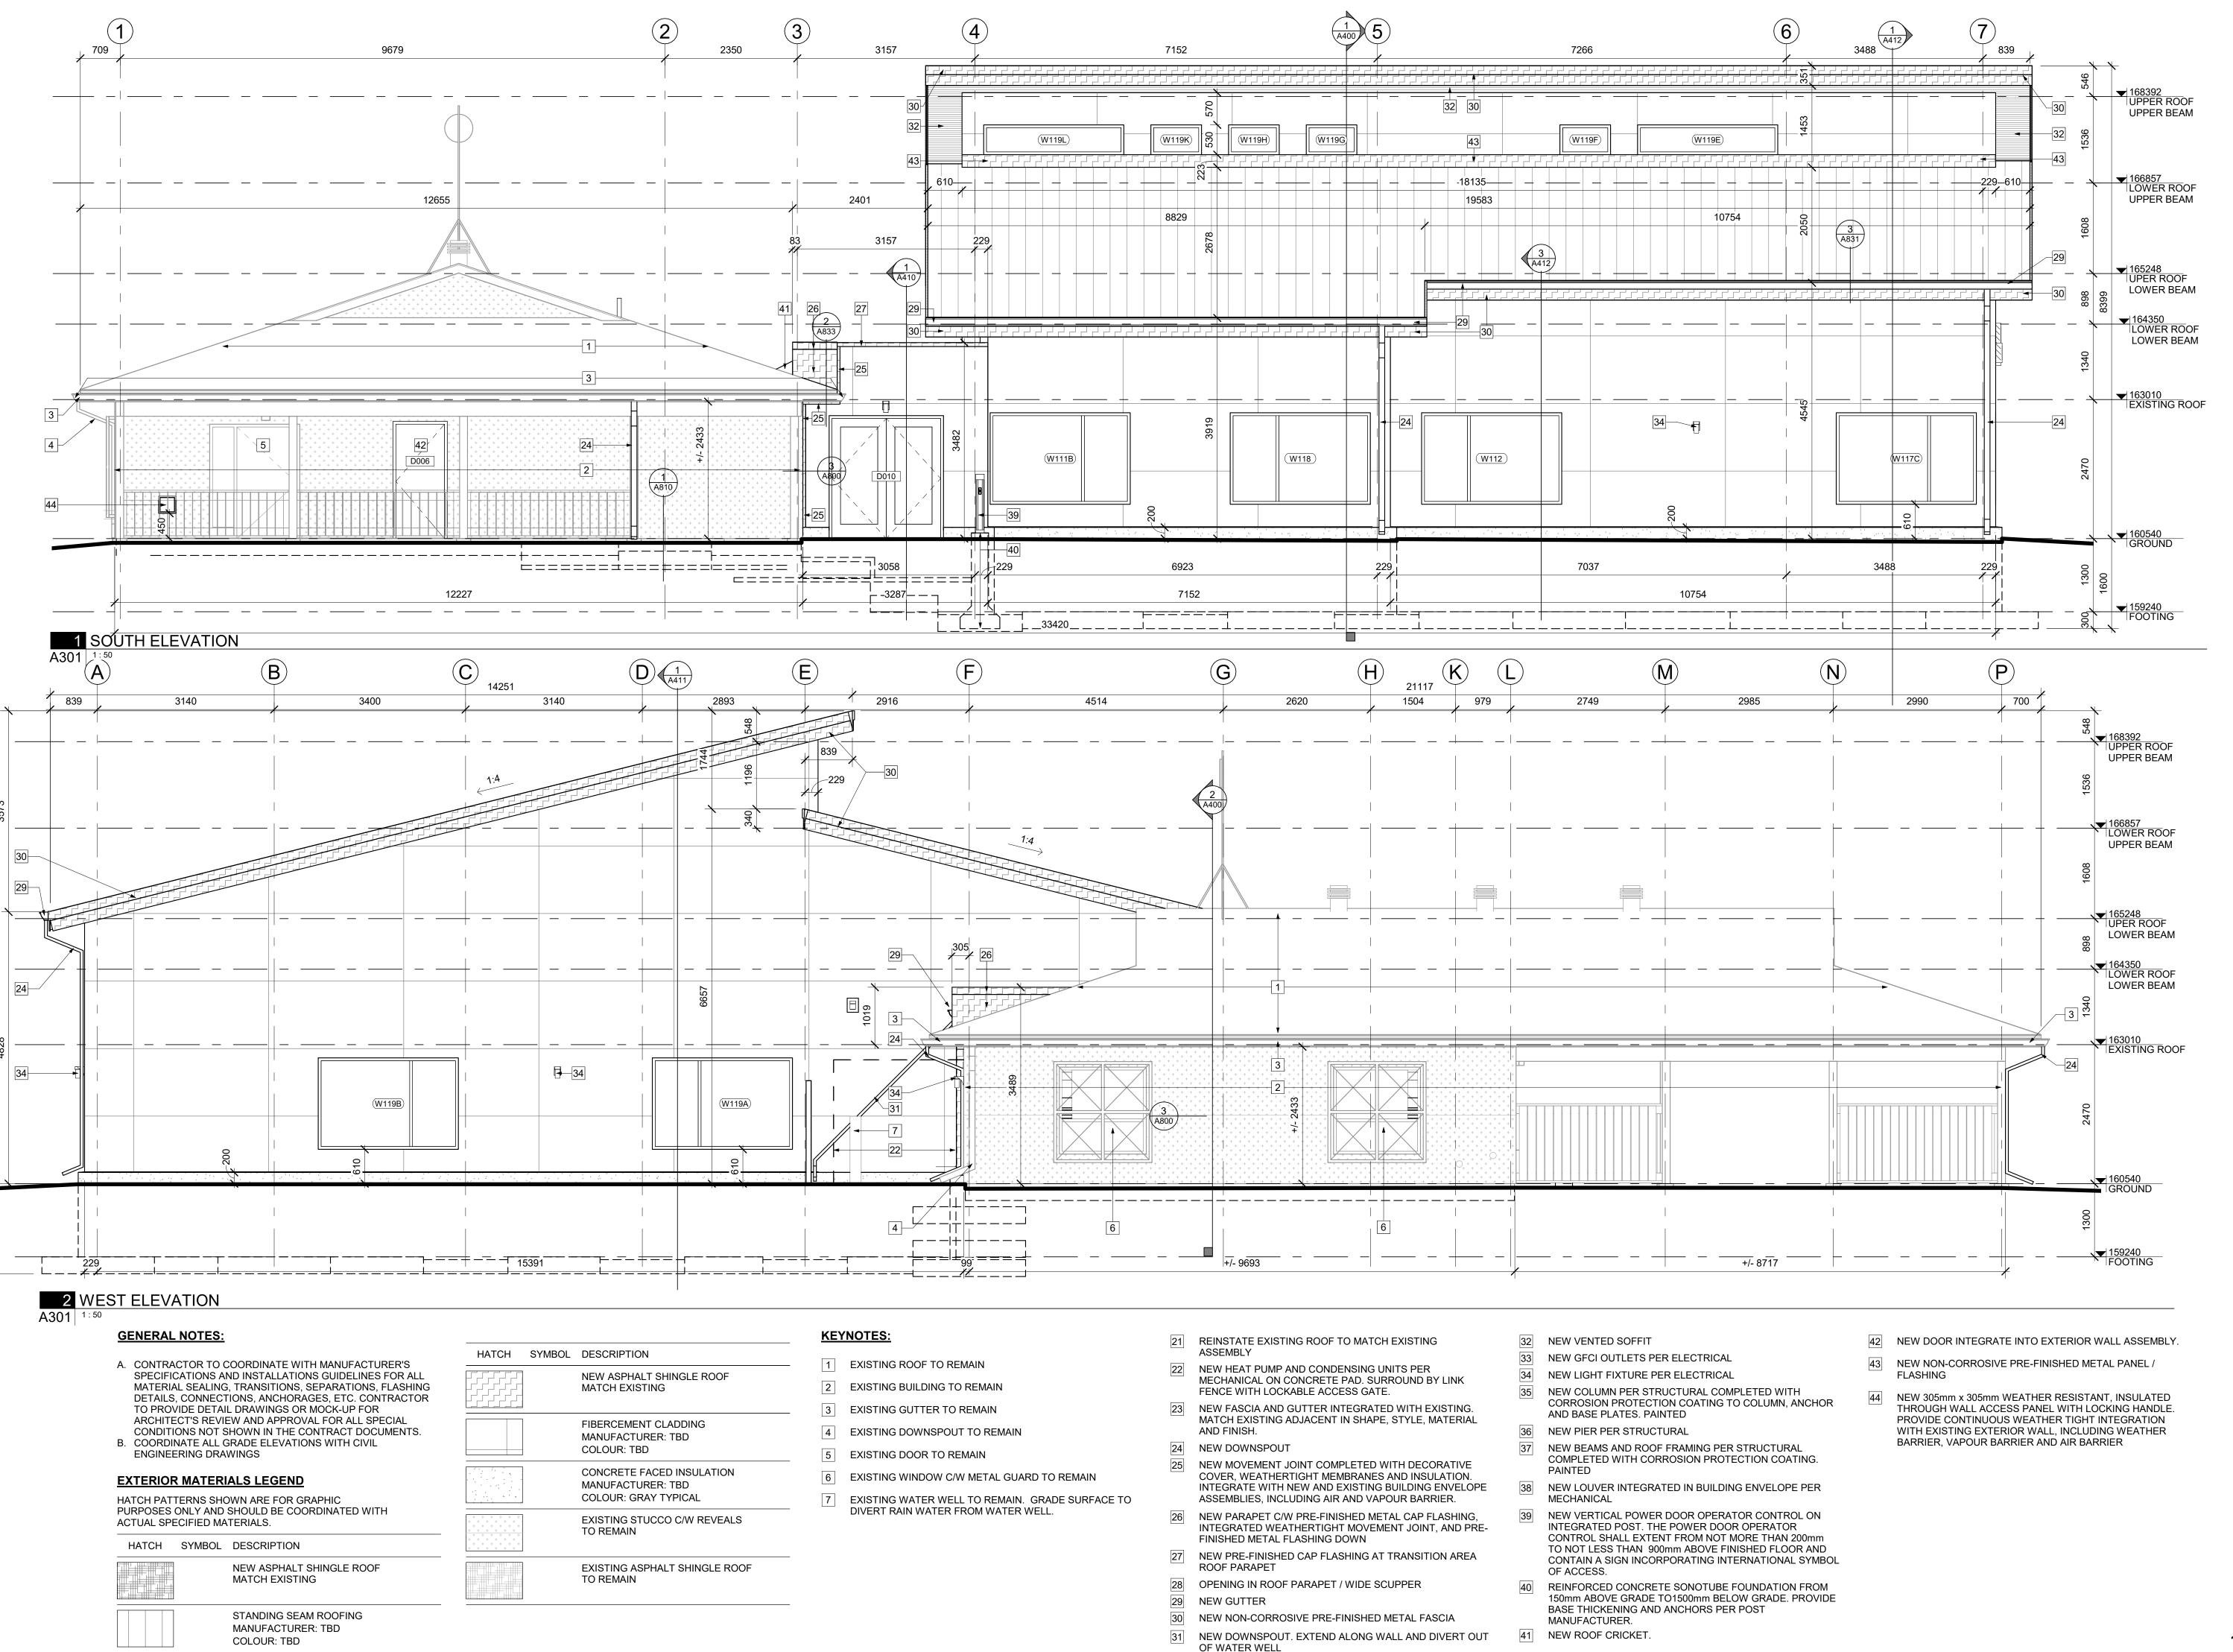PROJECT

TITLE

# CORKERY COMMUNITY HALL EXPANSION

3447 OLD ALMONTE RD., CARP, ON K0A 1L0

# SOUTH AND WEST ELEVATIONS

PROJECT NO: 2020-0640
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APPROVED: JS
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A301

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