

# 1 PROPOSED SITE PLAN

LEGAL DESCRIPTION	
1. ALL OF BLOCKS N, O, & P AND PART OF BLOCK Q	REGISTERED
PLAN 4M-153 AND PART OF LOT 5 CONCESSION 2	
FRONT)	(TUBE/TO
GEOGRAPHIC TOWNSHIP OF GLOUCESTER	

CITY OF OTTAWA 2. TOPOGRAPHIC SKETCH OF PART OF BLOCK O REGISTERED PLAN 4M-153 CITY OF OTTAWA

**GROSS FLOOR AREA** 

**BUILDING HEIGHT** 

SCHEDULE 1

SCHEDULE 2

ZONE

4926m<sup>2</sup>

18m / 6 STOREYS

R5B (H18)

AREA C

N/A

REFERENCE SURVEY:

1. TOPOGRAPHIC PLAN OF SURVEY PREPARED BY FARLEY, SMITH & DENIS SURVEYING LTD, DATED DEC. 04/20 2. TOPOGRAPHIC SKETCH PREPARED BY FARLEY, SMITH & DENIS

MUNICIPAL ADDRESS: 1 FINCH PRIVATE, OTTAWA, ON

SURVEYING LTD. 2023

)	ZONING PROVISION	REQUIRED	PROVIDED	PARKING QUEING + LOADI	NG RE	<u>EQUIRED</u>	PROVI
	MIN. LOT WIDTH	N/A	34.5m	RESIDENTIAL SPACES		54	54
	MIN. LOT AREA	1400m <sup>2</sup>	2541m <sup>2</sup>	VISITOR SPACES		9	9
	MIN. FRONT YARD SETBACK	3.0m	N/A	ACCESSIBLE PARKING			2
	MIN. CORNER YARD SETBACK	N/A	N/A	BICYCLE PARKING		45	77
	MIN. REAR YARD SETBACK	7.5m	7.6m				
	MIN. INTERIOR YARD SETBACK	7.5m	7.6m	GARBAGE COLLECTION:  • GARBAGE 11yard: 3x4 Yd. bins  • GMP 0.81 yds			
	MAX. HEIGHT	18m	18m		x4 Yd. bins		
	AMENITY AREA	270m <sup>2</sup> + TBD	79.3m <sup>2</sup> Interior 191m <sup>2</sup> Exterior	<ul><li>FIBER 2.8 yds</li><li>COMPOST 1x240L C</li></ul>	art		
	LANDSCAPED AREA	762.3m <sup>2</sup>	1302m <sup>2</sup>				
	MINIMUM SETBACK OF WALL OF RESIDENTIAL BUILDING TO PRIVATE WAY	1.8m	1.8m				
	MINIMUM SEPARATION AREA BETWEEN BUILDINGS IN A PLANNED UNIT DEVELOPMENT	3.0m	4.0m				

#### **NEW SITE PLAN GENERAL NOTES:**

- A. ALL GENERAL SITE INFORMATION AND CONDITIONS COMPILED FROM EXISTING PLANS AND SURVEYS
- B. DO NOT SCALE THIS DRAWING C. REPORT ANY DISCREPANCIES PRIOR TO COMMENCING WORK. NO RESPONSIBILITY IS BORN BY THE CONSULTANT FOR UNKNOWN SUBSURFACE CONDITIONS D. CONTRACTOR TO CHECK AND VERIFY ALL DIMENSIONS ON
- SITE AND REPORT ANY ERRORS AND/OR OMISSIONS TO THE . REINSTATE ALL AREAS AND ITEMS DAMAGED AS A RESULT OF
- CONSTRUCTION ACTIVITIES TO THE SATISFACTION OF THE CONTRACTOR TO LAYOUT PLANTING BEDS, PATHWAYS ETC.
- TO APPROVAL OF CONSULTANT PRIOR TO ANY JOB **EXCAVATION** G. THE ACCURACY OF THE POSITION OF UTILITIES IS NOT
- GUARANTEED CONTRACTOR TO VERIFY PRIOR TO **EXCAVATION** H. INDIVIDUAL UTILITY COMPANY MUST BE CONTACTED FOR
- CONFIRMATION OF UTILITY EXISTENCE AND LOCATION PRIOR
- ALL DISTURBED AREAS TO BE RESTORED TO ORIGINAL CONDITION OR BETTER UNLESS OTHERWISE NOTED PROVIDE TEMPORARY HOARDING AND FACING AROUND
- CONSTRUCTION SITE FOR PERIOD OF WORK K. PROTECT EXISTING TREES FROM DAMAGE FOR PERIOD OF

#### **NEW SITE PLAN KEYNOTES:**

- 1 EXISTING HYDRO KIOSK
- 2 EXISTING HYDRO METERS AT WOODEN BOX
- 3 EXISTING BUILDING ABOVE
- 4 EXISTING CURB TO REMAIN
- 5 EXISTING PARKING PAVING TO REMAIN
- 6 EXISTING SIDEWALK TO REMAIN
- 30 NEW CURB
- 31 NEW CANOPY OVERHANG ABOVE (DASHED)
- 32 NEW COLUMN
- 33 NEW BOLLARD LIGHT PER LANDSCAPING
- 35 NEW TRANSFORMER AND SWITCH PER ELECTRICAL
- ADJUSTS UNDERGROUND HYDRO LINES PER ELECTRICAL
- NEW CATCH BASING. ADJUST STORM WATER LINE AS
- 38 FIRE ROUTE
- 40 NEW DROPPED CURB AND SIDEWALK RAMP
- 42 NEW BIKE PACKING SPACES
- 44 SNOW STORAGE AREA
- 45 AIR WELL COMPLETED WITH GRATING
- GEOTECHNICAL. REINSTATE ASPHALT PAVING AND BASE COURSES. ASPHALT PAVEMENT PER GEOTECHNICAL. PROVIDE GUARDS TO PROTECT AREA OF WORK FROM VEHICULAR AND PUBLIC ACCESS DURING CONSTRUCTION.

DEVELOPMENT #D07-12-23-0063

PLAN #18989

- 48 NEW LANDSCAPING WALL
- 49 NEW SWALE PER CIVIL

#### **NEW SITE PLAN LEGEND:**

	EXISTING BUILDING
	PROPOSED BUILDING
+ + + + + + + + + + + + + + + + + + +	NEW ASPHALT PAVING
	EXISTING ASPHALT PAVING EXIST
\(\psi\) \(\	NEW GRASS
	NEW CONCRETE SIDEWALK
	NEW CONCRETE PAD
	NEW PAVER TYPE 1
	NEW PAVER TYPE 2
	EXISTING CEDAR HEDGE
	SNOW STORAGE AREA

**EMERGENCY EXIT** SERVICE DOORS

**BUILDING MAIN ENTRANCE** PROPERTY LINE

PARCEL MAIN BOUNDARY LINE - - - PARCEL STANDARD BOUNDARY LINE

— — — — SET BACK LINE ——x——x—— NEW FENCE PER LANDSCAPE

——CLFE——CLFE——CLFE—— EXISTING CHAIN LINK FENCE ——BFE——BFE——BFE— EXISTING BOARD FENCE

——wtr——wtr—— NEW WATER ——SANE——SANE—— EXISTING SANITARY

——WTRE——WTRE—— EXISTING WATER

——UBE——UBE—— EXISTING BELL SERVICE

——GE——GE—— EXISTING GAS

——G——G—— NEW GAS

•O<sub>LS</sub>

-O<sub>FH</sub>

(BELOW GRADE)

CATCH BASIN

LIGHT STANDARD

FIRE HYDRANT

MANHOLE

UTILITY POLE

WATER VALVE

CATCH BASIN EXISTING

LIGHT STANDARD EXISTING

FIRE HYDRANT EXISTING

MANHOLE EXISTING

UTILITY POLE EXISTING

WATER VALVE EXISTING

GAS VALVE EXISTING

SIAMESE CONNECTION

**NEW SIGN** 

DROPPED CURB

**EXISTING TREE** 

EXISTING SIGN TO REMAIN

NEW TREE PER LANDSCAPING

NEW SHRUB PER LANDSCAPING

NEW LANDSCAPE CATCH BASIN

NEW CURB INTAKE CATCH BASIN

WATER VALVE CHAMBER EXISTING

——san——san—— NEW SANITARY ——STE——STE——STE—— EXISTING STORM

——st——st—— NEW STORM ——HUE——HUE——HUE—— EXISTING ELECTRICAL SERVICE

(BELOW GRADE) ——HU——HU——HU—— NEW ELECTRICAL SERVICE (BELOW GRADE)

REQUIRED

39 NEW PARKING

41 NEW DROPPED CURB AND ACCESSIBLE CURB RAMP C/W COLOUR CONTRASTING TACTILE ATTENTION INDICATOR INTEGRATED IN DETECTABLE WARNING SURFACE AT ENTRY INTO VEHICULAR ROUTE

43 NEW ASPHALT SIDEWALK

46 NEW ASPHALT PAVING ALONG NEW CURB

47 PROVIDE COMPACTED TRENCH BACKFILL PER

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CLIENT

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PROJECT **OCH SHEARWATER APARTMENTS** 

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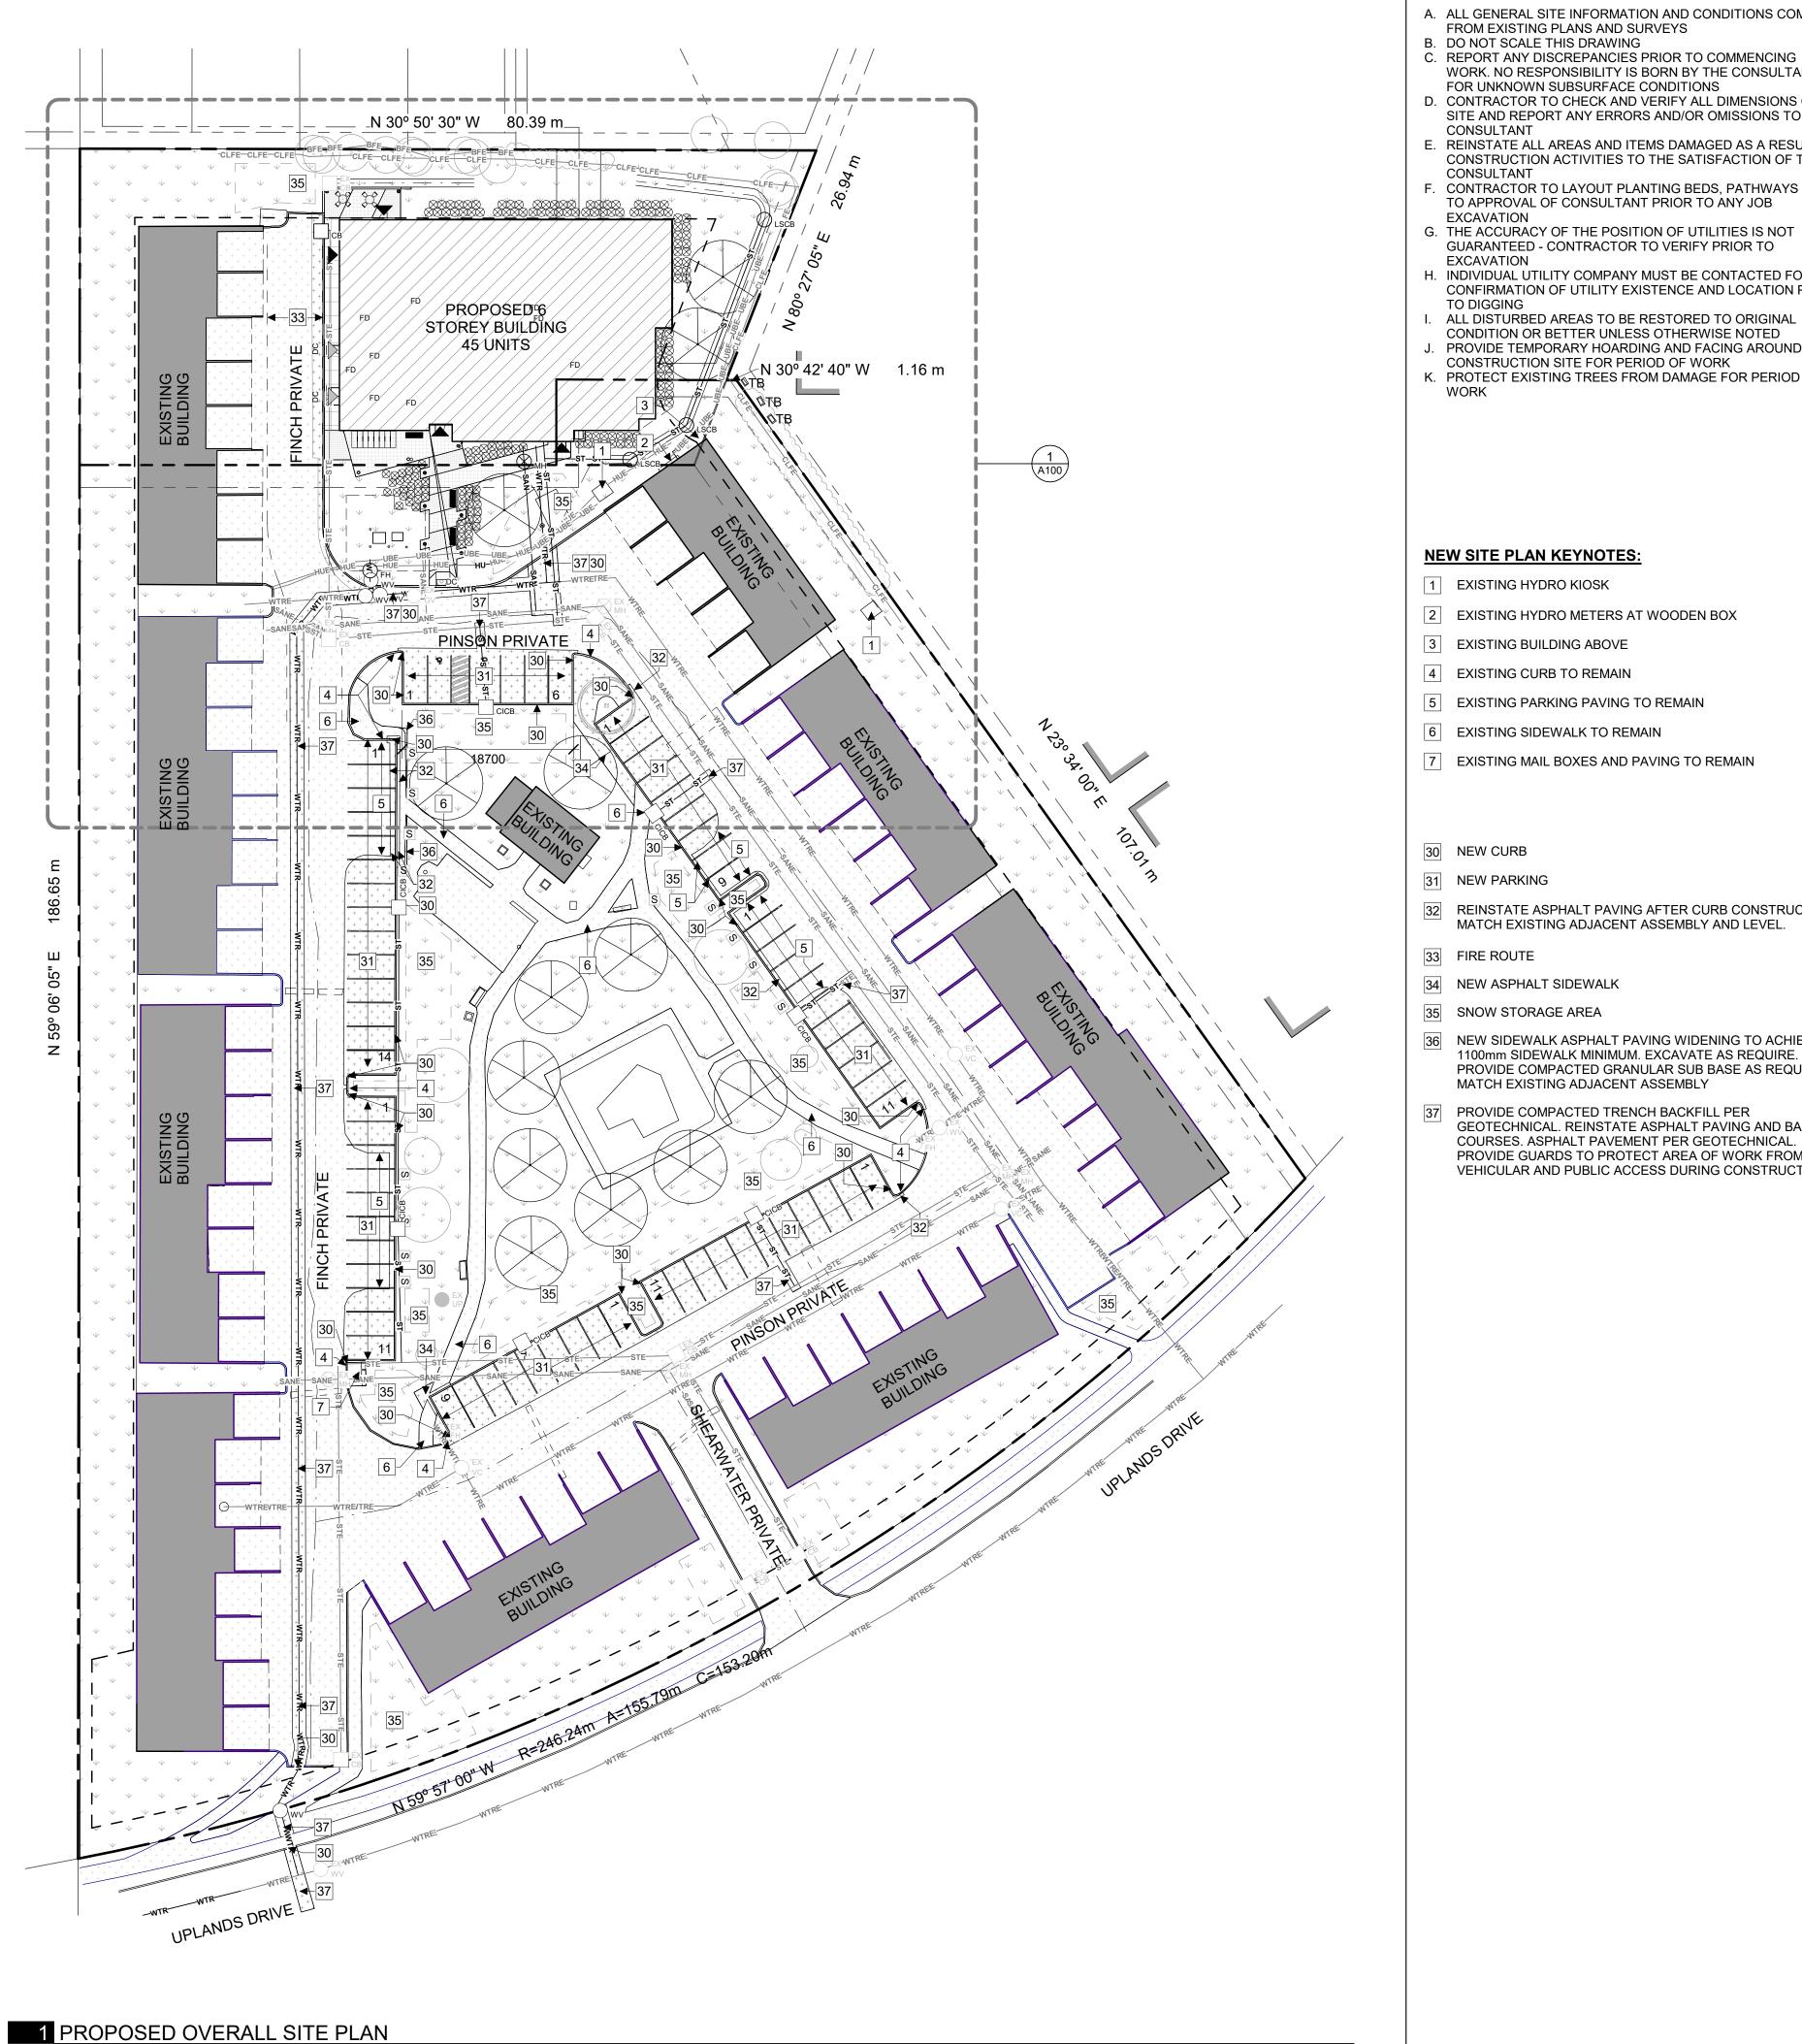
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APPROVED: JS SCALE: 1:200 DATE PRINTED: 10/12/2023 4:07:51 PM

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A100 1/2 001A



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### **NEW SITE PLAN KEYNOTES:**

- 1 EXISTING HYDRO KIOSK
- 2 EXISTING HYDRO METERS AT WOODEN BOX
- 3 EXISTING BUILDING ABOVE
- 5 EXISTING PARKING PAVING TO REMAIN
- 6 EXISTING SIDEWALK TO REMAIN
- 7 EXISTING MAIL BOXES AND PAVING TO REMAIN
- 30 NEW CURB
- 31 NEW PARKING
- 32 REINSTATE ASPHALT PAVING AFTER CURB CONSTRUCTION.
- 34 NEW ASPHALT SIDEWALK
- 35 SNOW STORAGE AREA
- 36 NEW SIDEWALK ASPHALT PAVING WIDENING TO ACHIEVE 1100mm SIDEWALK MINIMUM. EXCAVATE AS REQUIRE.
- COURSES. ASPHALT PAVEMENT PER GEOTECHNICAL. PROVIDE GUARDS TO PROTECT AREA OF WORK FROM VEHICULAR AND PUBLIC ACCESS DURING CONSTRUCTION

EXISTING BUILDING TO REMAIN REMOVE EXISTING BUILDING NEW ASPHALT PAVING **NEW GRASS** NEW CONCRETE SIDEWALK NEW CONCRETE PAD NEW PAVER TYPE 1 **NEW PAVER TYPE 1** EXISTING CEDAR HEDGE SNOW STORAGE AREA

— — — — — SET BACK LINE

STE—STE—EXISTING STORM

——st—— NEW STORM

——HU——HU—— NEW ELECTRICAL SERVICE

 $\bullet$ 

-<del>O</del>FH

 $\bigcirc$ LSCB

(BELOW GRADE)

(BELOW GRADE)

(BELOW GRADE)

CATCH BASIN

CATCH BASIN EXISTING

LIGHT STANDARD EXISTING

FIRE HYDRANT EXISTING

LIGHT STANDARD

FIRE HYDRANT

MANHOLE TO

UTILITY POLE

WATER VALVE

MANHOLE EXISTING

UTILITY POLE EXISTING

WATER VALVE EXISTING

GAS VALVE EXISTING

SIAMESE CONNECTION

EXISTING SIGN TO REMAIN

NEW TREE PER LANDSCAPING

DROPPED CURB

**NEW SIGN** 

**NEW SHRUB** 

**EXISTING TREE** 

WATER VALVE CHAMBER EXISTING

NEW LANDSCAPE CATCH BASIN

NEW CURB INTAKE CATCH BASIN

MATCH EXISTING ADJACENT ASSEMBLY AND LEVEL.

33 FIRE ROUTE

PROVIDE COMPACTED GRANULAR SUB BASE AS REQUIRED. MATCH EXISTING ADJACENT ASSEMBLY

37 PROVIDE COMPACTED TRENCH BACKFILL PER GEOTECHNICAL. REINSTATE ASPHALT PAVING AND BASE

**DEMOLITION SITE PLAN LEGEND:** EXISTING ASPHALT PAVING TO REMAIN **EMERGENCY EXIT** SERVICE DOORS MAIN ENTRANCE PROPERTY LINE —— — — PARCEL MAIN BOUNDARY LINE —— — — PARCEL STANDARD BOUNDARY LINE NEW FENCE PER LANDSCAPING ——CLFE——CLFE—— EXISTING CHAIN LINK FENCE BFE—BFE—EXISTING BOARD FENCE ——wtr——wtr—— NEW WATER 

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PROJECT

**OCH SHEARWATER APARTMENTS** 

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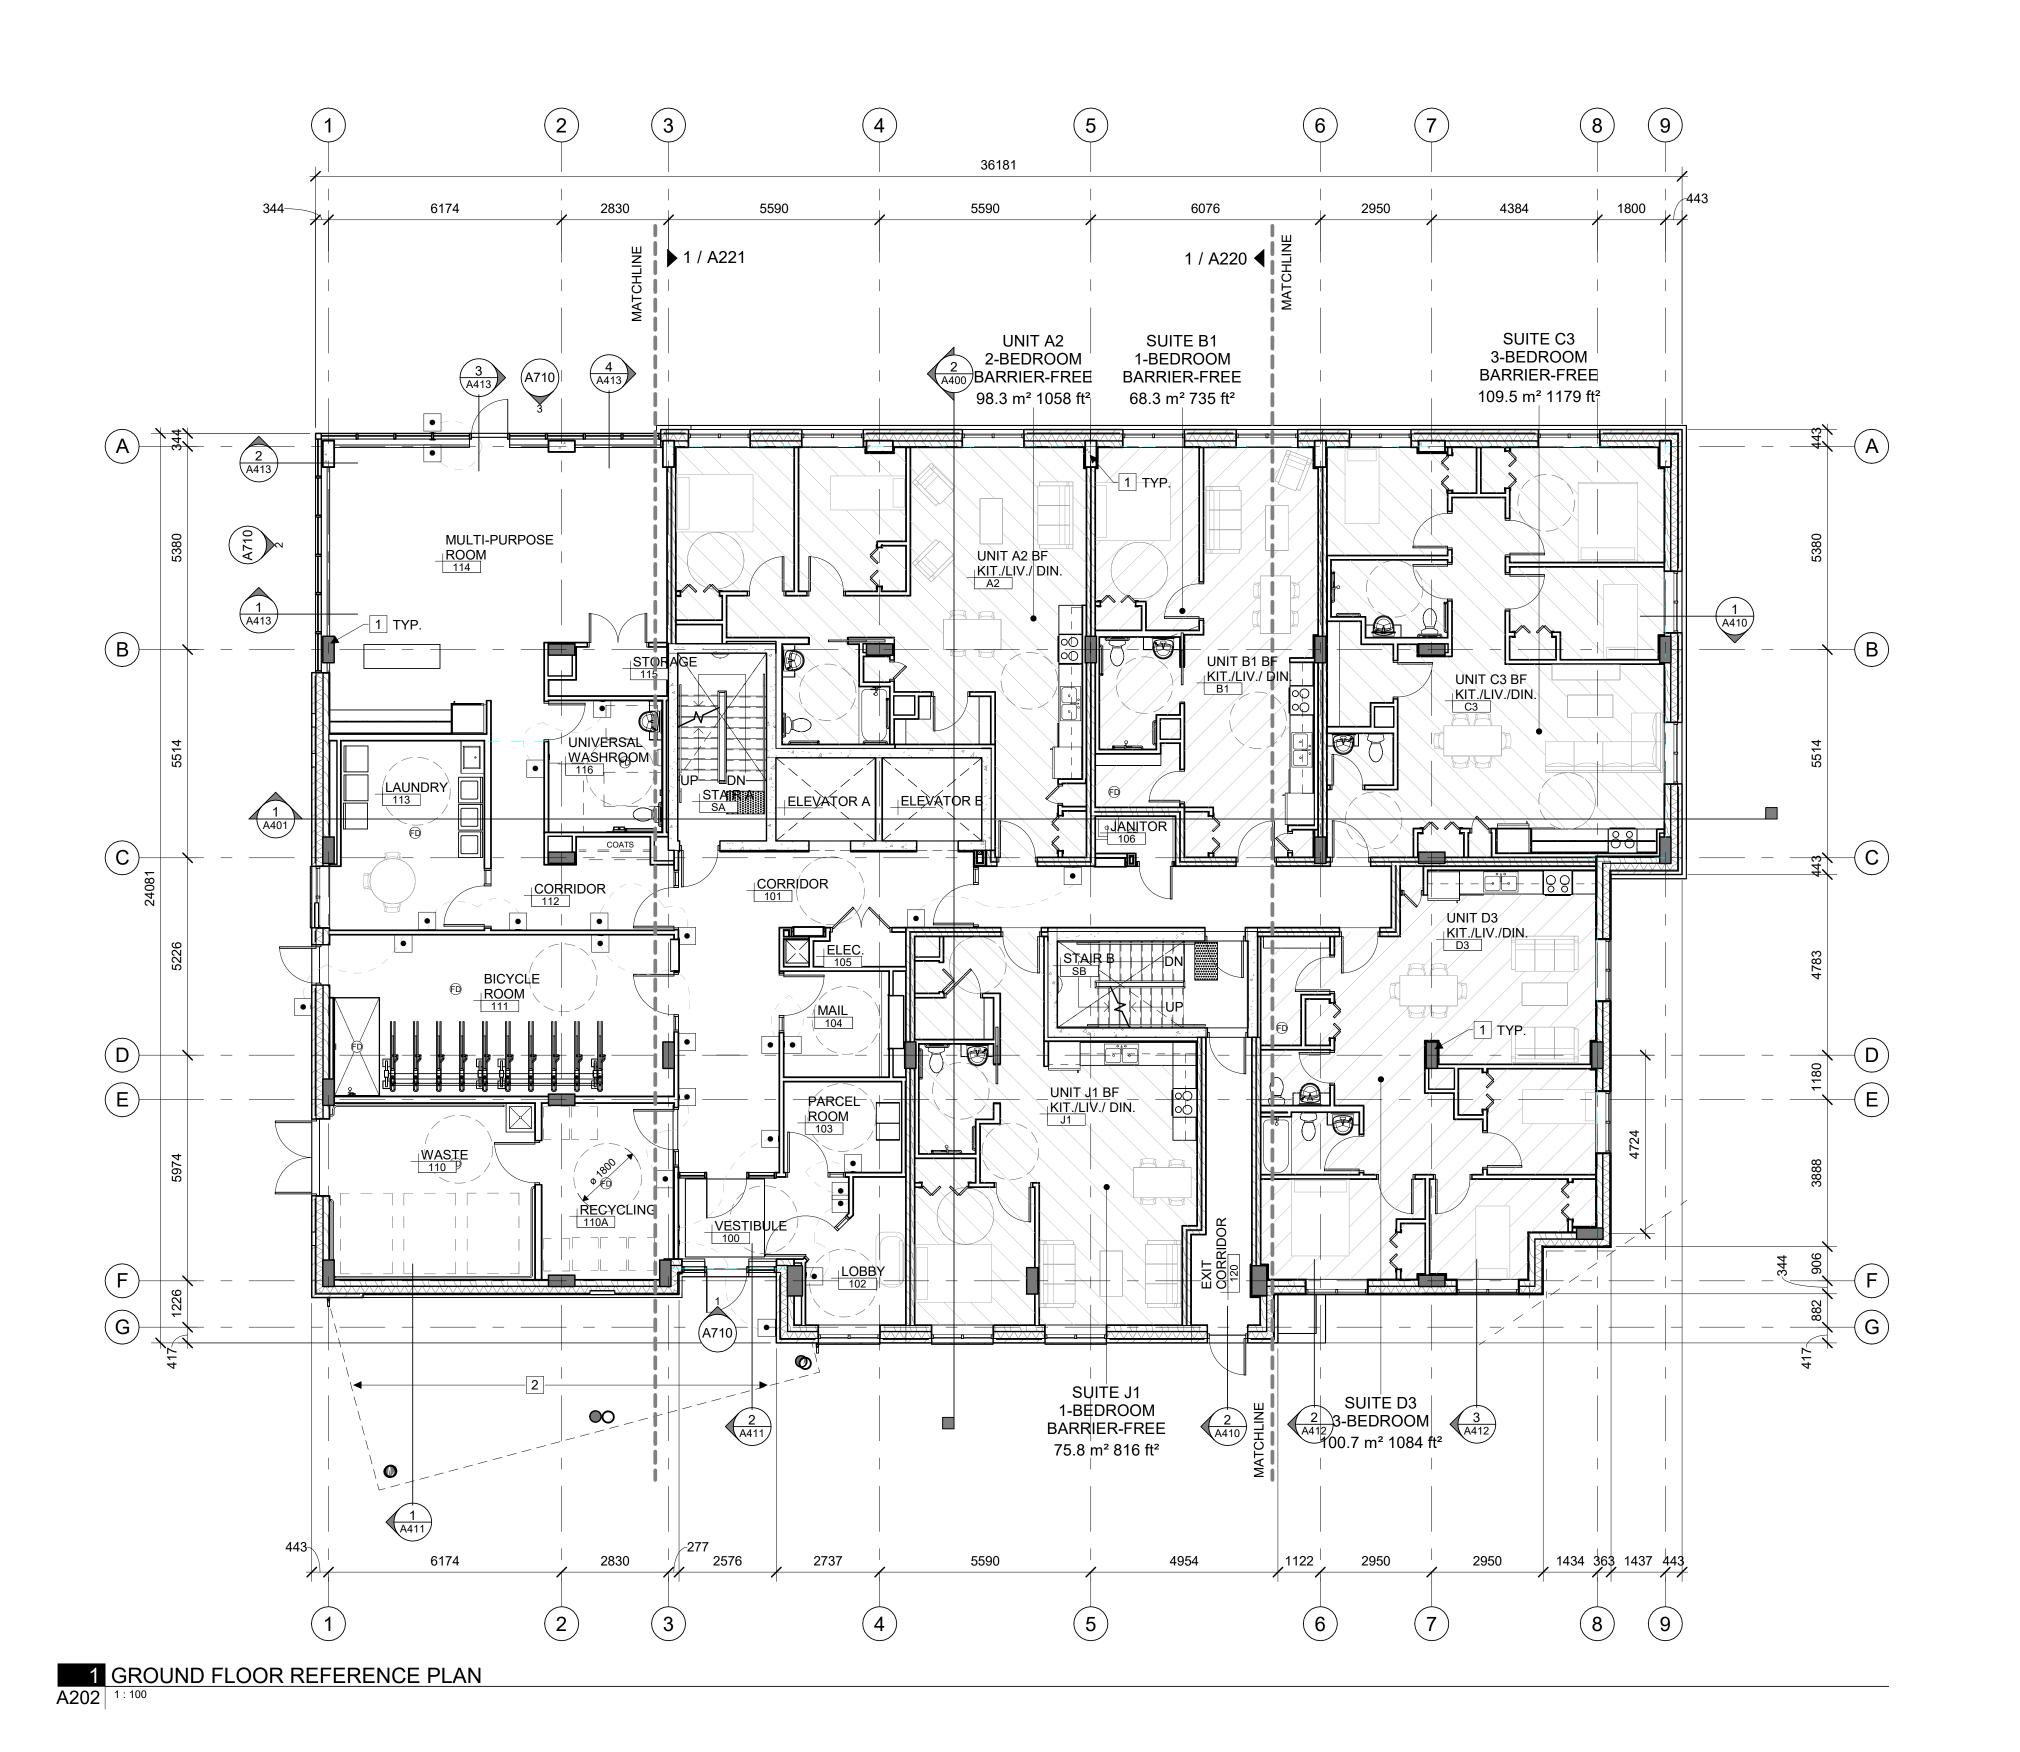
**PROPOSED OVERALL** SITE PLAN

PROJECT NO: 2022-1430 DRAWN: AL / LCB / IK APPROVED: JS SCALE: 1:400 DATE PRINTED: 10/12/2023 4:08:12 PM

REV DRAWING NO. ຕໍ່

A101 F

DEVELOPMENT #D07-12-23-0063 PLAN #18989



#### **GENERAL REFERENCE PLAN NOTES:**

- A. ALL WINDOWS ARE DIMENSIONED TO CENTERLINE OF WINDOW OPENING, UNLESS OTHERWISE NOTED.
- OPENING, INCLUDING SIDELIGHT FRAMING, UNLESS OTHERWISE NOTED

B. ALL DOORS ARE DIMENSIONED TO CENTERLINE OF DOOR

- C. ALL EXTERIOR WALLS ARE DIMENSIONED TO EXTERIOR FACE
- OF CLADDING, UNLESS OTHERWISE NOTED D. ALL INTERIOR DIMENSIONS ARE DIMENSIONED FROM
- INTERIOR FINISHED FACES OF EXTERIOR WALLS, UNLESS OTHERWISE NOTED E. ALL INTERIOR WALLS ARE DIMENSIONED TO CENTERLINE OF PARTITION, UNLESS OTHERWISE NOTED, CONSIDER OFFSET
- FROM PARTITION CENTERLINE TO STUD FRAMING CENTER BASED ON WALL ASSEMBLY.
- F. MOVABLE FURNITURE BY OTHERS

#### **REFERENCE PLAN KEYNOTES:**

- 1 COLUMN PER STRUCTURAL
- 2 CANOPY ABOVE

REFERENCE PLAN LEGEND:

STRUCTURAL ELEMENTS

DOOR ACTUATOR BUTTON

BARRIER-FREE CLEARANCE

DOOR ACTUATOR OPERABLE DOOR

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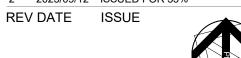
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TITLE


## **GROUND FLOOR REFERENCE PLAN**

PROJECT NO: 2022-1430 DRAWN: AL / LCB / IK APPROVED: JS 1:100

DATE PRINTED: 10/12/2023 4:08:20 PM

DRAWING NO. ຕໍ່

A202

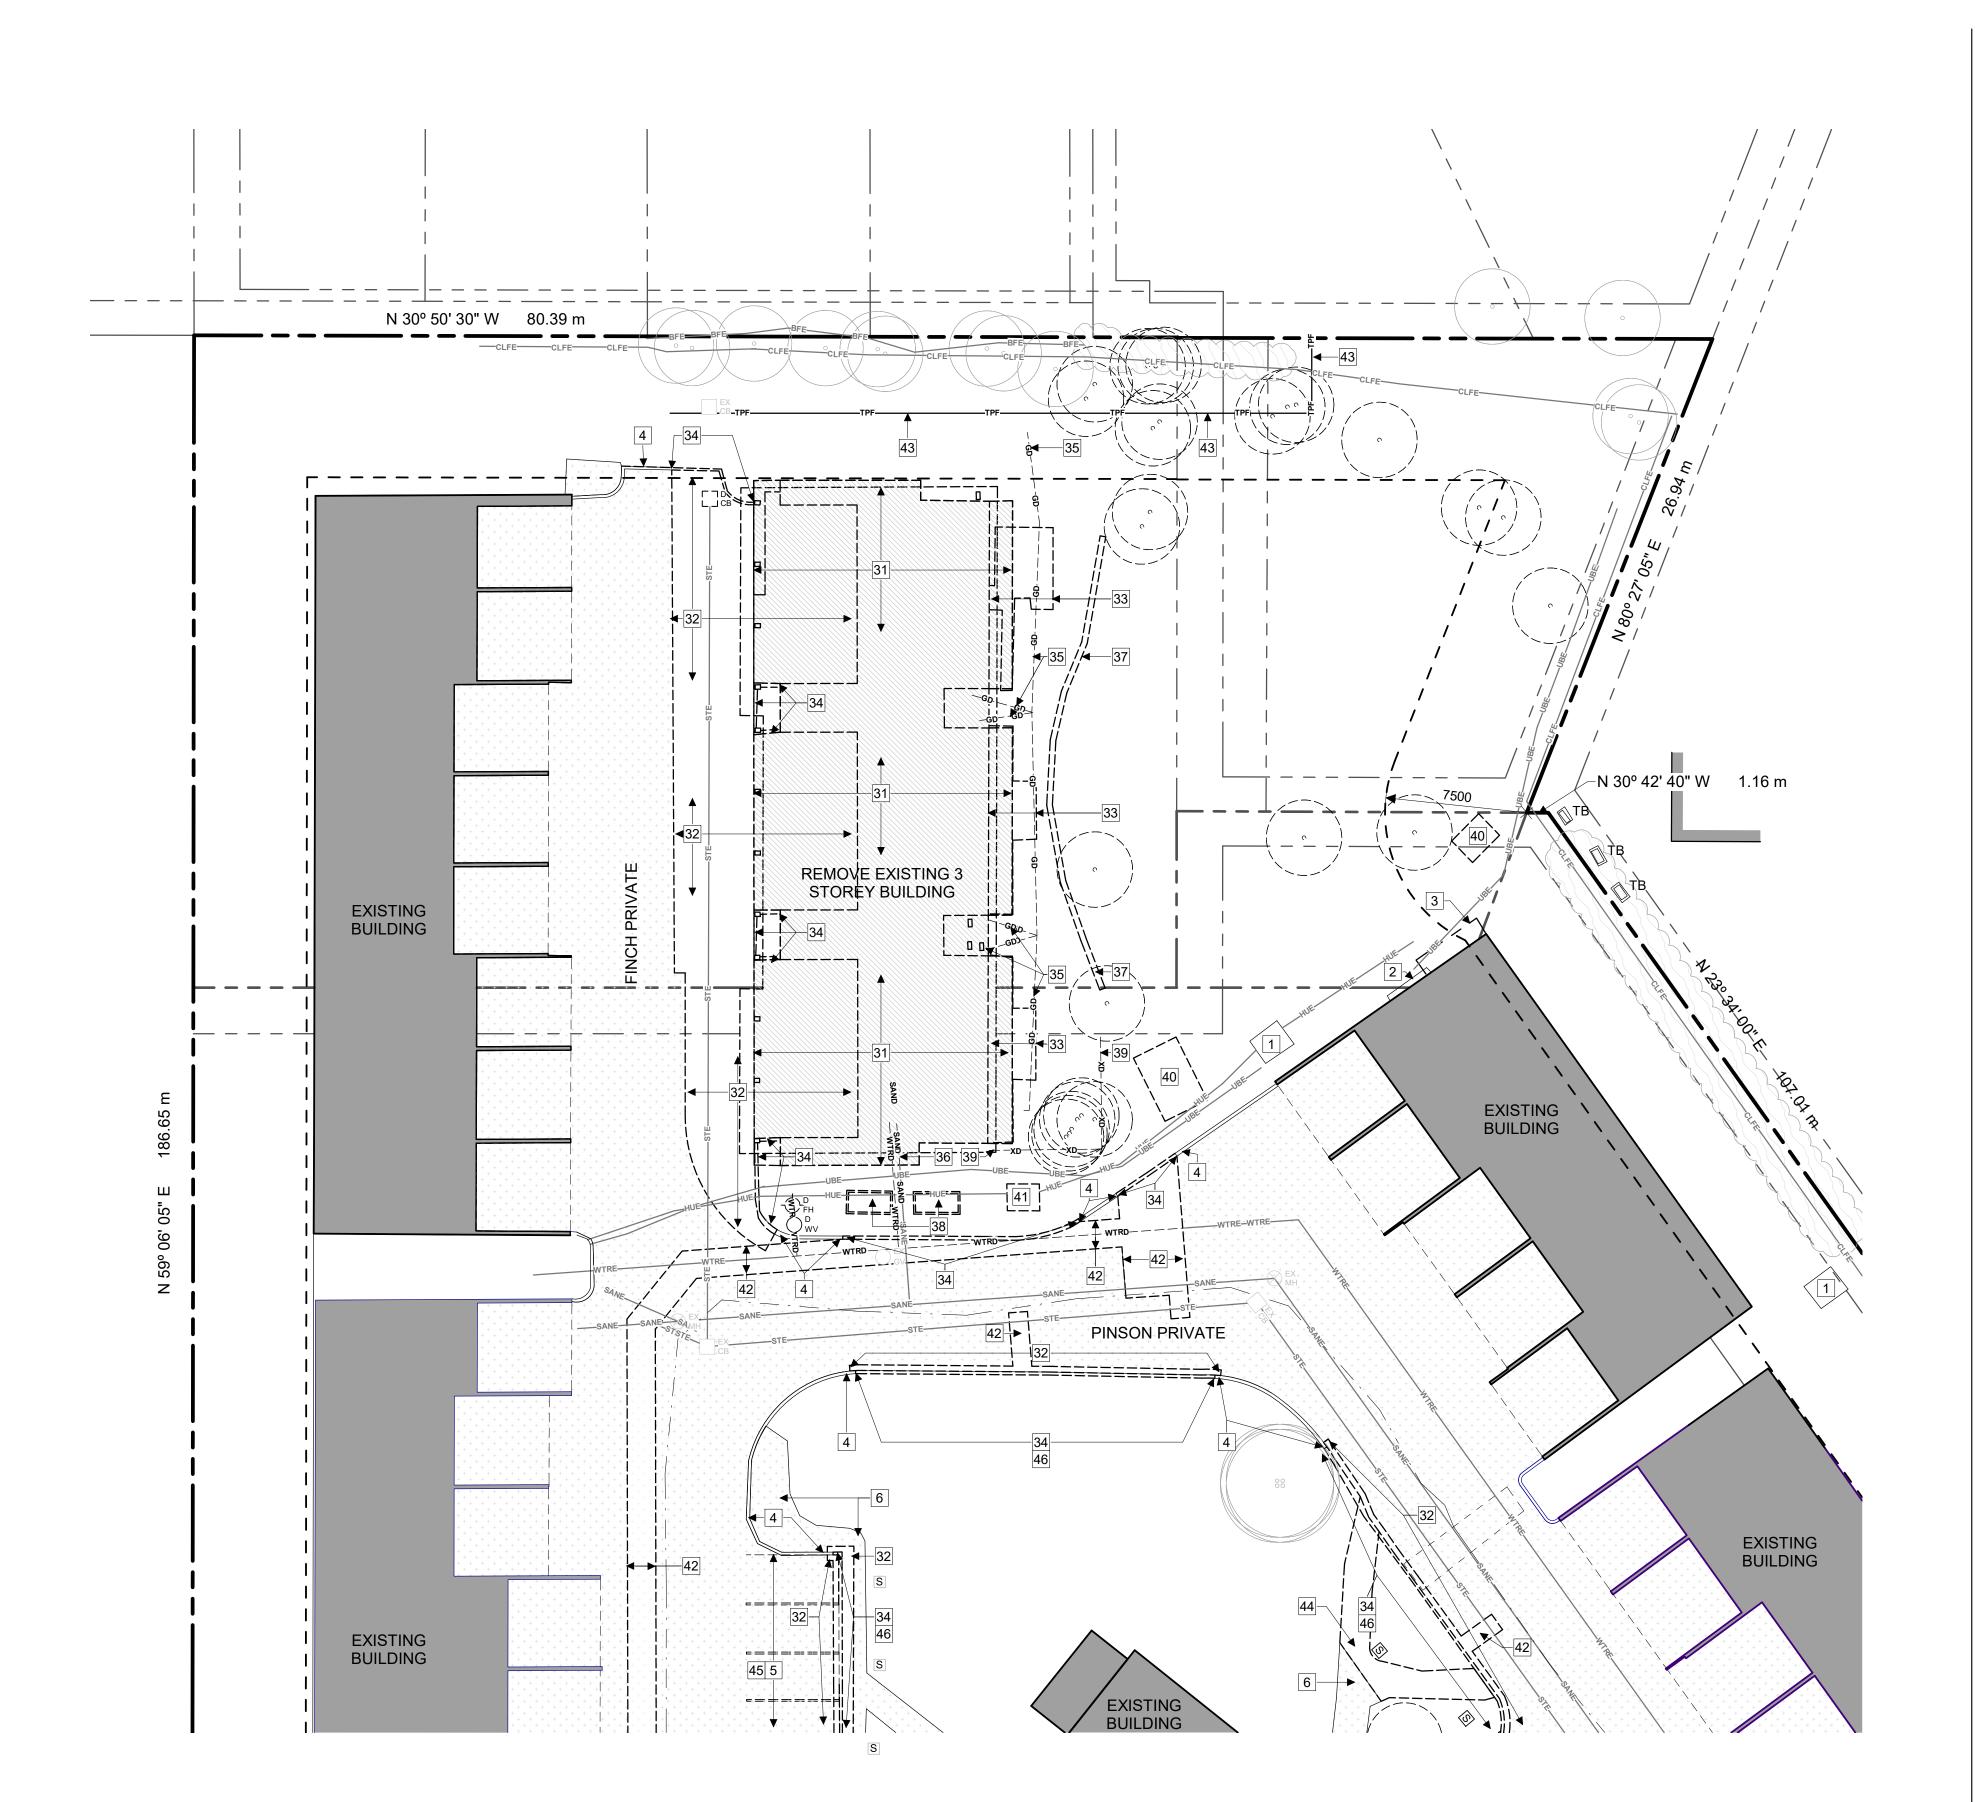

1 DEMOLITION SITE PLAN

#### **DEMOLITION SITE PLAN LEGEND: DEMOLITION SITE PLAN GENERAL NOTES:** A. ALL GENERAL SITE INFORMATION AND CONDITIONS COMPILED EXISTING BUILDING TO REMAIN FROM EXISTING PLANS AND SURVEYS rmmmmmmmm, B. DO NOT SCALE THIS DRAWING REMOVE EXISTING BUILDING C. REPORT ANY DISCREPANCIES PRIOR TO COMMENCING WORK. NO RESPONSIBILITY IS BORN BY THE CONSULTANT FOR UNKNOWN SUBSURFACE CONDITIONS DEMOLISHED OBJECTS D. CONTRACTOR TO CHECK AND VERIFY ALL DIMENSIONS ON L\_\_\_\_\_\_ SITE AND REPORT ANY ERRORS AND/OR OMISSIONS TO THE EXISTING ASPHALT PAVING TO REMAIN . REINSTATE ALL AREAS AND ITEMS DAMAGED AS A RESULT OF CONSTRUCTION ACTIVITIES TO THE SATISFACTION OF THE EXISTING CEDAR HEDGE CONTRACTOR TO LAYOUT PLANTING BEDS, PATHWAYS ETC. TO APPROVAL OF CONSULTANT PRIOR TO ANY JOB PROPERTY LINE **EXCAVATION** G. THE ACCURACY OF THE POSITION OF UTILITIES IS NOT — — — PARCEL MAIN BOUNDARY LINE GUARANTEED - CONTRACTOR TO VERIFY PRIOR TO **EXCAVATION** H. INDIVIDUAL UTILITY COMPANY MUST BE CONTACTED FOR —— — — PARCEL STANDARD BOUNDARY LINE CONFIRMATION OF UTILITY EXISTENCE AND LOCATION PRIOR — — — — — SET BACK LINE ALL DISTURBED AREAS TO BE RESTORED TO ORIGINAL CONDITION OR BETTER UNLESS OTHERWISE NOTED PROVIDE TEMPORARY HOARDING AND FACING AROUND CONSTRUCTION SITE FOR PERIOD OF WORK K. PROTECT EXISTING TREES FROM DAMAGE FOR PERIOD OF ——BFE——BFE——BFE—— EXISTING BOARD FENCE ——TPF——TPF——TPF——TREE PROTECTION FENCE **DEMOLITION SITE PLAN KEYNOTES:** ——WTRE——WTRE—— EXISTING WATER 1 EXISTING HYDRO KIOSK ——SANE——SANE—— EXISTING SANITARY 2 EXISTING HYDRO METERS AT WOODEN BOX 3 EXISTING BUILDING ABOVE 4 EXISTING CURB TO REMAIN -----STE-----STE----- EXISTING STORM 5 EXISTING PARKING PAVING TO REMAIN ——HUE——HUE——HUE—— EXISTING ELECTRICAL SERVICE 6 EXISTING SIDEWALK TO REMAIN (BELOW GRADE) ——UBE——UBE—— EXISTING BELL SERVICE (BELOW GRADE) ——GE——GE—— EXISTING GAS — — GD- — — GD- — GAS TO DEMOLISH CATCH BASIN TO DEMOLISH CATCH BASIN EXISTING LIGHT STANDARD TO DEMOLISH 31 REMOVE EXISTING 3 STOREY DWELLING UNITS BUILDING LIGHT STANDARD EXISTING C/W VINYL AND WOOD SIDING, FOUNDATIONS, BALCONIES AND OVERHANGS, PROTECT ACCESS TO THE ADJACENT PROPERTIES AND HOUSING DURING DEMOLITION AND FIRE HYDRANT TO DEMOLISH CONSTRUCTION. FIRE HYDRANT EXISTING 32 REMOVE PORTION OF EXISTING ASPHALT PAVING 33 REMOVE EXISTING PATIO MANHOLE TO DEMOLISH 34 REMOVE EXISTING CURB MANHOLE EXISTING 35 REMOVE EXISTING GAS LINE AND ASSOCIATED **EQUIPMENT** UTILITY POLE TO DEMOLISH 36 REMOVE PORTION OF EXISTING SANITARY SEWAGE UTILITY POLE EXISTING 37 REMOVE EXISTING RETAINING WALL WATER VALVE CHAMBER EXISTING 38 REMOVE EXISTING PLANTER WATER VALVE EXISTING 39 REMOVE EXISTING BOARD FENCE 40 REMOVE EXISTING SHED WATER VALVE TO DEMOLISH 41 REMOVE EXISTING HYDRO KIOSK EXISTING SIGN TO REMAIN REMOVE EXISTING ASPHALT PAVING AND BASE COURSES, AND EXCAVATE AS REQUIRED FOR NEW SERVICE EXISTING SIGN TO REMOVE TRENCHES. CUT EXISTING ASPHALT PAVING IN STRAIGHT LINES FOR REMOVAL. PROTECT EXISTING ASPHALT ASSEMBLIES. PROVIDE GUARDS TO PROTECT AREA OF WORK FROM VEHICULAR AND PUBLIC ACCESS DURING TREE TO DEMOLISH DEMOLITION AND CONSTRUCTION. PROVIDE TREE PROTECTION FENCE FOR TIME OF DEMOLITION AND NEW CONSTRUCTION EXISTING SHRUB REMOVE PORTION OF EXISTING SIDEWALK AS REQUIRED FOR NEW CONSTRUCTION

45 REMOVE EXISTING PARKING SPOT LAYOUT PAINTING

CONSTRUCTION. PROTECT AND REINSTATE TOP SOIL AND

46 EXCAVATE AS REQUIRED FOR NEW PARKING

VEGETATION AT ADJACENT AREAS.

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QUASAR

Meintosh Derry

BE RESPONSIBLE TO VERIFY DIMENSIONS ON SITE. 5. ALL WORK SHALL BE IN ACCORDANCE WITH THE ONTARIO BUILDING CODE AND ALL SUPPLEMENTS AND APPLICABLE MUNICIPAL REGULATIONS.

CLIENT

**EXISTING TREE** 

## **OTTAWA COMMUNITY** HOUSING

OTTAWA ONTARIO, CANADA

PROJECT

## **OCH SHEARWATER APARTMENTS**

1 FINCH PRIVATE, OTTAWA, ON


TITLE

## **DEMOLITION SITE PLAN**

PROJECT NO: 2022-1430 DRAWN: IK / LB APPROVED: JS SCALE: 1:200

DATE PRINTED: 10/12/2023 4:08:23 PM REV DRAWING NO. ຕໍ່

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#### **DEMOLITION SITE PLAN GENERAL NOTES:**

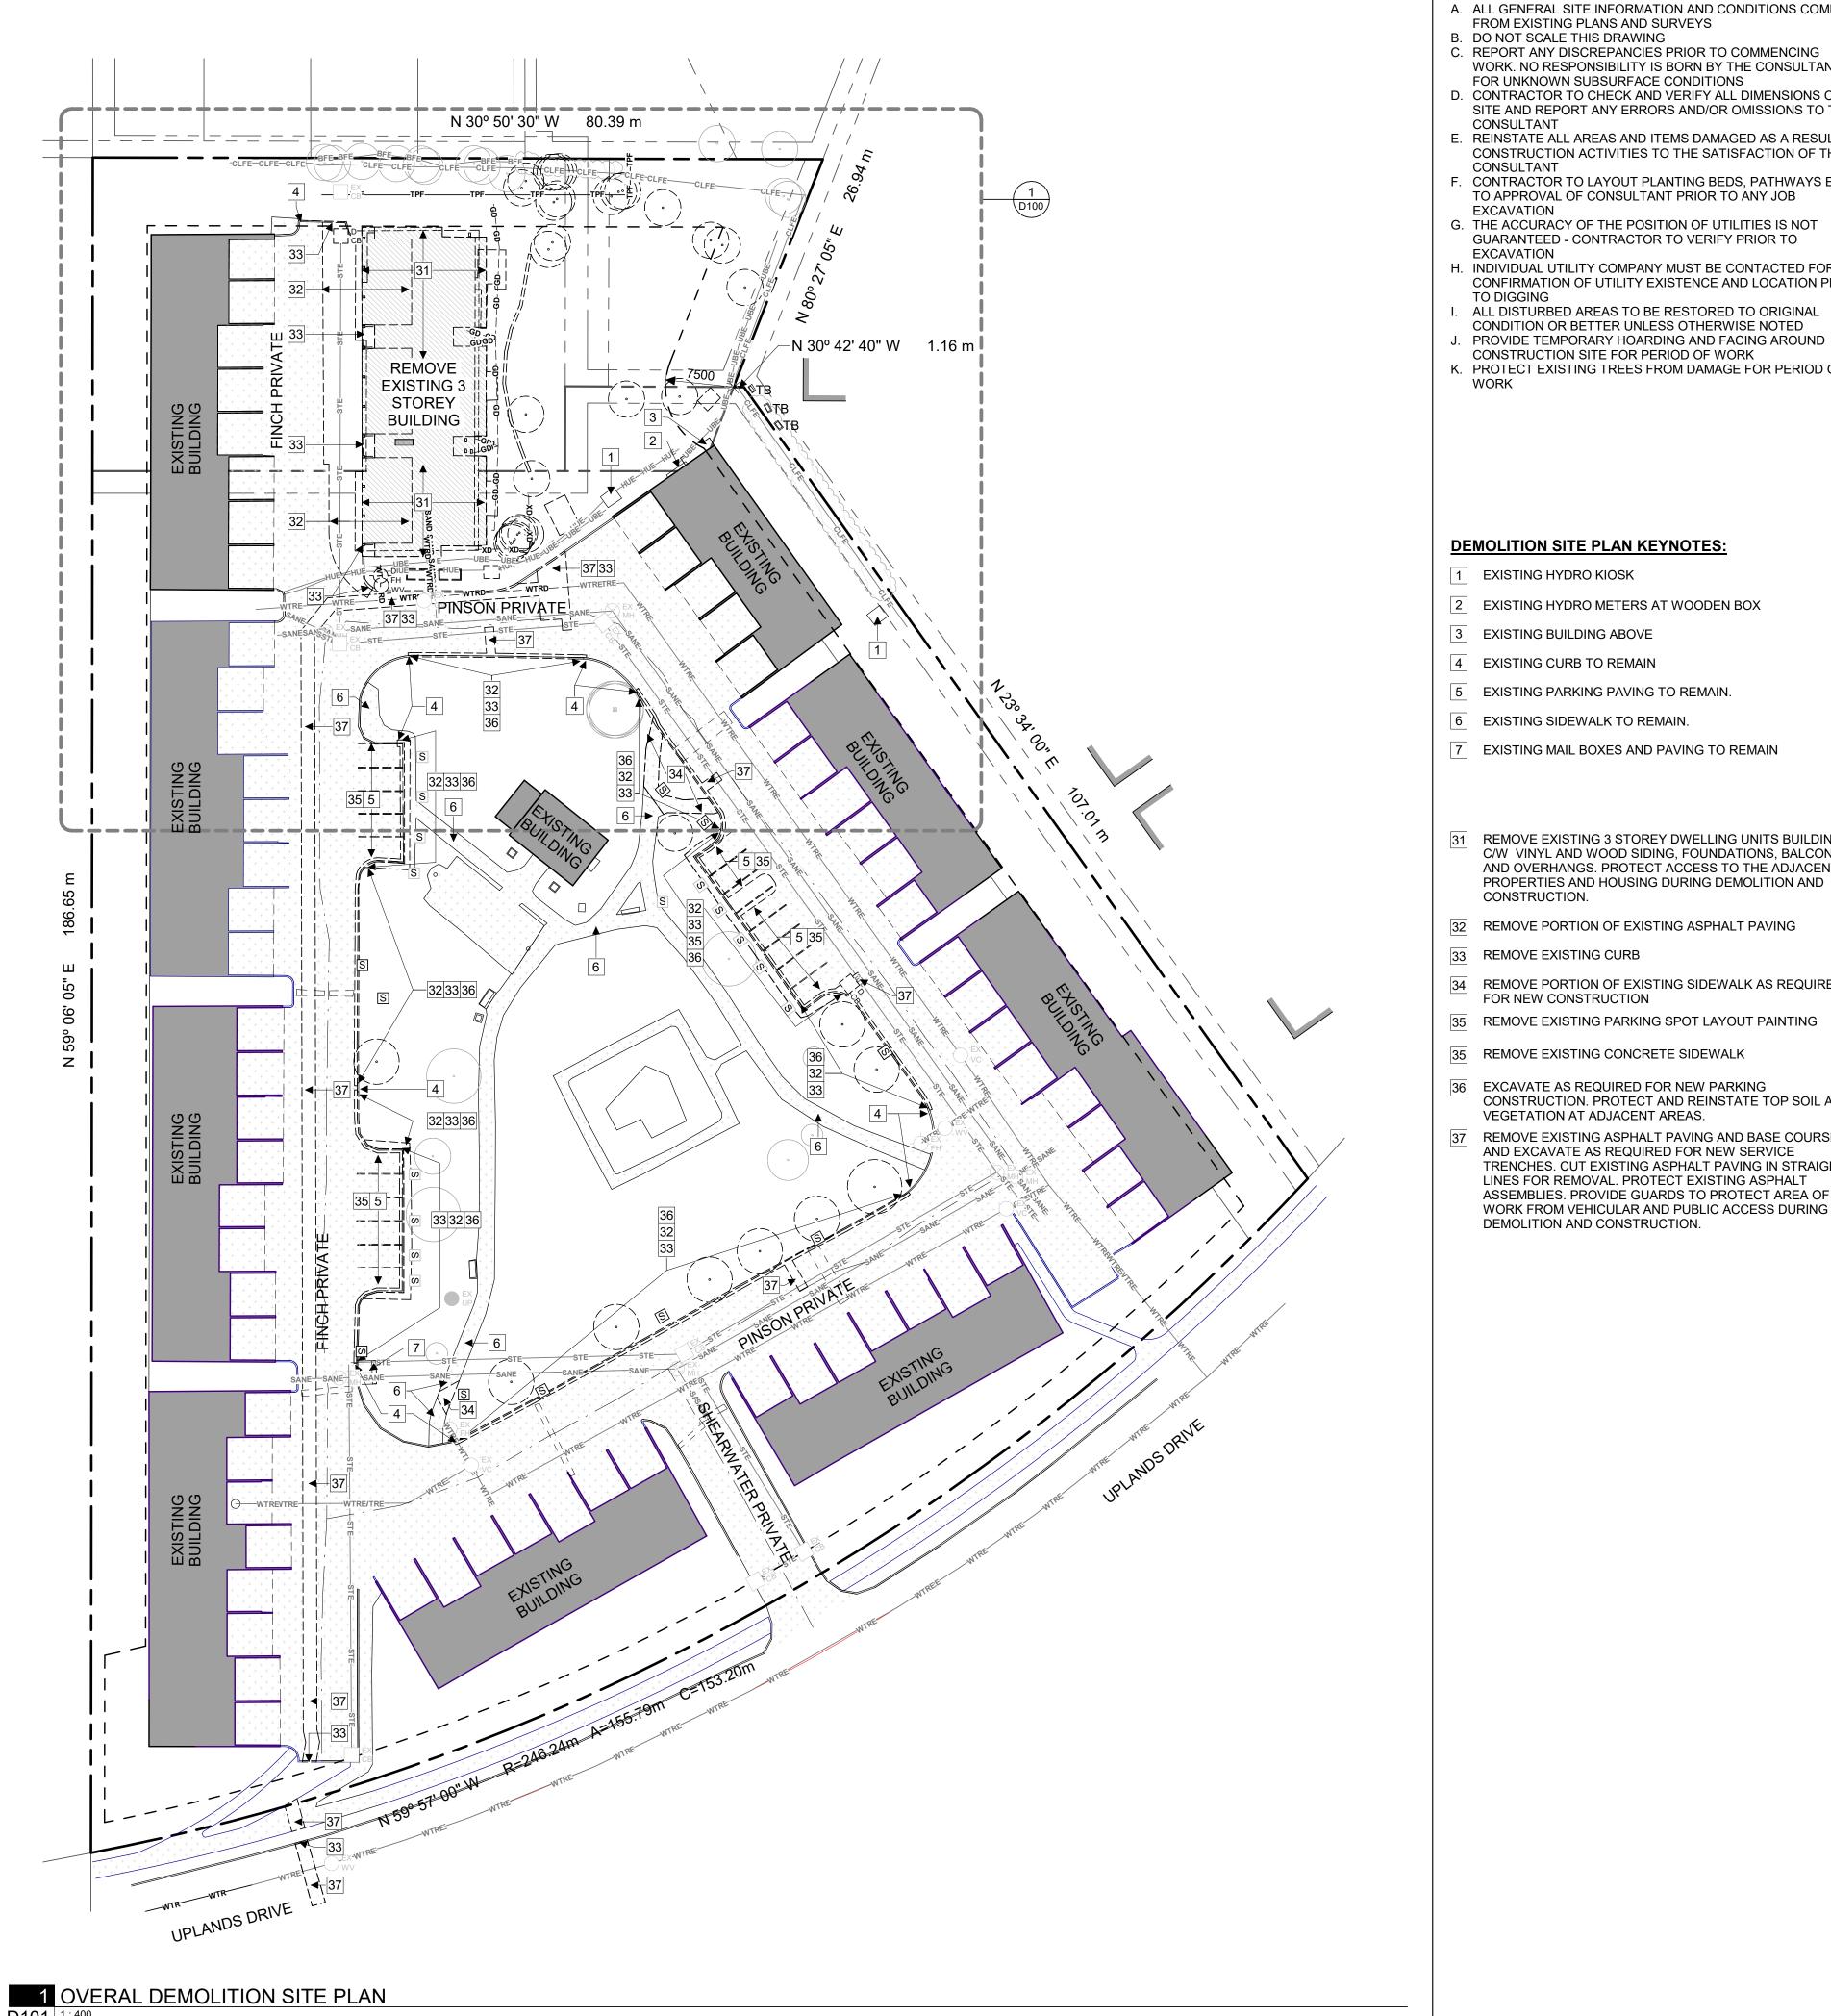- A. ALL GENERAL SITE INFORMATION AND CONDITIONS COMPILED FROM EXISTING PLANS AND SURVEYS B. DO NOT SCALE THIS DRAWING
- C. REPORT ANY DISCREPANCIES PRIOR TO COMMENCING WORK. NO RESPONSIBILITY IS BORN BY THE CONSULTANT FOR UNKNOWN SUBSURFACE CONDITIONS D. CONTRACTOR TO CHECK AND VERIFY ALL DIMENSIONS ON SITE AND REPORT ANY ERRORS AND/OR OMISSIONS TO THE
- CONSULTANT . REINSTATE ALL AREAS AND ITEMS DAMAGED AS A RESULT OF CONSTRUCTION ACTIVITIES TO THE SATISFACTION OF THE
- CONTRACTOR TO LAYOUT PLANTING BEDS, PATHWAYS ETC. TO APPROVAL OF CONSULTANT PRIOR TO ANY JOB
- **EXCAVATION** G. THE ACCURACY OF THE POSITION OF UTILITIES IS NOT GUARANTEED - CONTRACTOR TO VERIFY PRIOR TO
- H. INDIVIDUAL UTILITY COMPANY MUST BE CONTACTED FOR CONFIRMATION OF UTILITY EXISTENCE AND LOCATION PRIOR
- ALL DISTURBED AREAS TO BE RESTORED TO ORIGINAL CONDITION OR BETTER UNLESS OTHERWISE NOTED
- CONSTRUCTION SITE FOR PERIOD OF WORK K. PROTECT EXISTING TREES FROM DAMAGE FOR PERIOD OF

## **DEMOLITION SITE PLAN KEYNOTES:**

- 1 EXISTING HYDRO KIOSK
- 2 EXISTING HYDRO METERS AT WOODEN BOX
- 3 EXISTING BUILDING ABOVE
- 4 EXISTING CURB TO REMAIN
- 5 EXISTING PARKING PAVING TO REMAIN.
- 6 EXISTING SIDEWALK TO REMAIN.
- 7 EXISTING MAIL BOXES AND PAVING TO REMAIN
- 31 REMOVE EXISTING 3 STOREY DWELLING UNITS BUILDING C/W VINYL AND WOOD SIDING, FOUNDATIONS, BALCONIES AND OVERHANGS. PROTECT ACCESS TO THE ADJACENT PROPERTIES AND HOUSING DURING DEMOLITION AND CONSTRUCTION.
- 32 REMOVE PORTION OF EXISTING ASPHALT PAVING
- 33 REMOVE EXISTING CURB
- 34 REMOVE PORTION OF EXISTING SIDEWALK AS REQUIRED FOR NEW CONSTRUCTION
- 35 REMOVE EXISTING PARKING SPOT LAYOUT PAINTING
- 35 REMOVE EXISTING CONCRETE SIDEWALK
- 36 EXCAVATE AS REQUIRED FOR NEW PARKING CONSTRUCTION. PROTECT AND REINSTATE TOP SOIL AND VEGETATION AT ADJACENT AREAS.
- 37 REMOVE EXISTING ASPHALT PAVING AND BASE COURSES, AND EXCAVATE AS REQUIRED FOR NEW SERVICE TRENCHES. CUT EXISTING ASPHALT PAVING IN STRAIGHT LINES FOR REMOVAL. PROTECT EXISTING ASPHALT ASSEMBLIES. PROVIDE GUARDS TO PROTECT AREA OF WORK FROM VEHICULAR AND PUBLIC ACCESS DURING DEMOLITION AND CONSTRUCTION.

DEMOLITION SITE PLAN LEGEND:					
	EXISTING BUILDING TO REMAIN				
	REMOVE EXISTING BUILDING				
	DEMOLISHED OBJECTS				
	EXISTING ASPHALT PAVING TO REMAIN				
7000000	EXISTING CEDAR HEDGE				
	PROPERTY LINE				
	PARCEL MAIN BOUNDARY LINE				
	PARCEL STANDARD BOUNDARY LINE				
	SET BACK LINE				
CLFECLFE	EXISTING CHAIN LINK FENCE				
BFEBFE	EXISTING BOARD FENCE				
XDXD	FENCE TO DEMOLISH				
TPFTPF	TREE PROTECTION FENCE				
WTRE	EXISTING WATER				
SANESANE	EXISTING SANITARY				

---GD-----GD--- GAS TO DEMOLISH

GE—GE—EXISTING GAS

-- sand --- sand -- SANITARY TO DEMOLISH

——UBE———UBE—— EXISTING BELL SERVICE

———HUE—— EXISTING ELECTRICAL SERVICE (BELOW GRADE)

(BELOW GRADE)

CATCH BASIN TO DEMOLISH

STE—STE—EXISTING STORM

CATCH BASIN EXISTING

LIGHT STANDARD TO DEMOLISH LIGHT STANDARD EXISTING

FIRE HYDRANT TO DEMOLISH

FIRE HYDRANT EXISTING

MANHOLE TO DEMOLISH

MANHOLE EXISTING

UTILITY POLE TO DEMOLISH

UTILITY POLE EXISTING

WATER VALVE CHAMBER EXISTING

WATER VALVE EXISTING

GAS VALVE EXISTING

**EXISTING SIGN TO REMAIN** 

EXISTING SIGN TO REMOVE

TREE TO DEMOLISH

EXISTING SHRUB **EXISTING TREE** 

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CLIENT

## **OTTAWA COMMUNITY** HOUSING

OTTAWA ONTARIO, CANADA

PROJECT

#### **OCH SHEARWATER APARTMENTS**

1 FINCH PRIVATE, OTTAWA, ON

TITLE

## **OVERAL SITE PLAN DEMOLITION**

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