

#### LEGEND - LANDSCAPE

— — — PROPERTY LIMIT

TREE PROTECTION FENCE

PROPOSED CONCRETE

RIVERSTONE

PROPOSED PLANTING BED - SEE SHEET L6 FOR DETAILS

SEED MIX A - SEE SEED MIX APPLICATION NOTE ON SHEET L6

SEED MIX B - SEE SEED MIX APPLICATION NOTE ON SHEET L6


> SEED MIX C - SEE SEED MIX APPLICATION NOTE ON SHEETS L2-L5

PROPOSED WET SHRUB MIX, PROPOSED DRY SHRUB MIX,

REFER TO SHEET L6

PROPOSED DECIDUOUS TREE

REFER TO SHEET L6

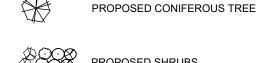


PROPOSED SHRUBS



EXISTING TREE TO REMAIN



CRITICAL ROOT ZONE (CRZ) FOR TREES WITH DBH GREATER THAN 10cm

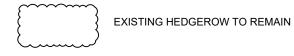



CITY DETAILS

Found on Sheet L7.

D5. Bike Layout

D7. Reforestation

D8. Riverstone

Volume No. 2 Standard Detail Drawings.

SC5. Sidewalk Construction Joints

D1. Standard Deciduous Tree Planting

D2. Standard Coniferous Tree Planting

D3. Shrub and Perennial Planting

D4. Tree Protection Fence

D6. Site furniture installation

NOVATECH DETAILS

SC4. Typical Concrete Sidewalk in Boulevard

**FOR REVIEW ONLY** 

Related details from City of Ottawa Standard Tender Documents

(SEE PLANT LIST)

- SPECIES

# SEED MIX AND APPLICATION

For areas steeper than 3:1, Contractor to apply erosion control blanket. Erosion control blanket to be machine woven mats made from natural wood, coco or cotton fiber, or combination depending on manufacturer, with stitching between two photo-degradable natural organic fiber nettings. Submit products for approval by Consultant. OPSS 804 applies except as may be amended and extended herein.

In addition to the specified seed mixes, all applications are to include a nurse crop as noted.

NURSE CROP 40% Oats (Avena sativa)

45% Barley (Hordeum vulgare) 15% Canada Wild Rye (Elymus canadensis) Seeding Rate: 15kg/hectare

SEED MIX C

(613) 254-9643

(613) 254-5867

www.novatech-eng.com

# TREE PROTECTION

Implement the following protection measures for retained trees, DETAIL SHEET # NOVATECH OR CITY Implement the following protection measures for retained trees both on site and on adjacent sites, prior to any work activity, including tree removal. Maintain tree protection fence in place including tree removal. Maintain tree protection fence in place and in good condition for the duration of site works:

- 1. The Landscape Architect or Certified Arborist is to determine the location of the tree protection fencing and detail it on any associated plans for the site (e.g. tree conservation report,
- tree disclosure report, etc.). 2. Under the guidance of a Landscape Architect or Certified Arborist, erect a fence at the critical root zone (CRZ) of trees. Diameter at breast height (DBH) is the trunk diameter measured at 1.3m height on the tree trunk. The CRZ is calculated as DBH x 10. Refer to the Tree Protection Fence
- 3. Refer to the Tree Protection Plan for fence location. City Forestry Staff are to approve both the plan and the installed fence prior to work commencement.
- 4. Do not place any material or equipment within 2m of the CRZ of any tree, including outhouses. 5. Do not attach any signs, notices, or posters to any tree.
- 6. Do not disturb, raise, or lower the existing grade within the CRZ without approval. 7. Only tunnel or bore when digging within the CRZ of a tree. Hand work only where required within the CRZ; absolutely no
- machinery permitted. 8. Do not damage the root system, trunk, or branches, or any
- 9. Do not extend hard surface or significantly change landscaping.
- 10. Ensure that exhaust fumes from all equipment are directed away from any tree canopy.
- 11. When trees marked for removal overlap with the CRZ of trees marked for preservation: cut roots at the edge of the CRZ and grind down stumps after tree removals, do not pull out stumps. Ensure there is not root pulling or disturbance of the
- ground within the CRZ. 12. Prior to work taking place, notify and consult the Landscape Architect and City Forestry Staff if roots must be cut. Roots 20mm or larger should be cut at right angles with clean, sharp horticultural tools without tearing, crushing, or pulling. Refer to
- City of Ottawa Specification S.P. F-8011 Tree Protection, Excavation of Root Zone. 13. If damaged or objectionable branches are observed, consult the Landscape Architect, before any work is conducted. Do
- not prune leaders. Do not prune more than 1/4 of crown. 14. Set up a water and fertilizing program, if trees are being affected by site works, to the satisfaction of the Landscape
- 15. The Landscape Architect is to prescribe mitigation measures construction. Measures may include the placement of plywood, wood chips, or steel plating over the roots for protection. City Forestry Staff are to approve said measures
- prior to fence movement. 16. City of Ottawa By-law: Protects municipal trees and municipal natural areas in the City of Ottawa and trees on private property in the urban area of the City of Ottawa (2020-340).

#### PLANTING

- 1. Plant material to be No. 1 Grade and is to comply with Canadian Standards for Nursery Stock (latest edition)
- published by the Canadian Nursery Landscape Association. 2. Use structurally sound plant material with strong fibrous root system free of disease, defects, and injuries. Use trees with straight trunks, well and characteristically branched for species. Obtain approval from consultant of plant material at source prior to digging. All trees and shrubs to be container grown, potted, W/B or B/B, as indicated on Plant List. Bare
- root plants are only acceptable for certain species and as approved by the Landscape Architect. 3. Plant material substitutions are not be permitted without the written approval from the Consultant, with 48 hours notice,
- prior to shipping plant material. 4. Plant locations are schematic / approximate only. Contractor is to stake out locations on site for approval by the
- Landscape Architect prior to installation. 5. The illustrated number of plants shown in the Planting Plan supersedes the estimated number in the Plant List. Contractor to report any discrepancies to the Landscape
- Architect prior to installation. Contractor will assume full responsibility if the Landscape Architect is not notified. Ensure trees are thoroughly watered following planting. Monitor material and ensure adequate moisture until
- acceptance. 7. In heavy clay or poorly drained soils, set root ball with root collar 75-100mm higher than finished grade.
- 8. Approved topsoil depths are as follows: a. Plant Beds - **450mm** continuous depth. Applies to shrubs, perennials, vines, and groundcovers.
- b. Sod/ Seed Areas 100mm depth. Sod to be No. 1 Kentucky Bluegrass Sod grown from minimum mixture of 3 Kentucky Bluegrass cultivars. Quality and source are to comply with Canadian Standards for Nursery Stock, Section 17, (latest edition) published by the
- Canadian Nursery Landscape Nursery Landscape Association. 10. Apply the following mineral fertilizer unless soil tests show
- other requirements: a. Plant Beds - (8-32-16), i.e. 8% Nitrogen, 32% Phosphorus, 16% Potash per manufacturer specifications.
- b. Sod Areas (8-32-16), i.e. 8% Nitrogen, 32% Phosphorus, 16% Potash at a rate of 350kg/ha. 11. Where applicable, for any plant areas with a mix of species/ cultivars notes, Contractor is to cluster like plants in groups of

3-5 and evenly distribute these in the noted area.

CUSTOM NATIVE PARKING ISLAND SEED MIX BY DLF Seeding Rate: 25kg/hectare

Suite 200, 240 Michael Cowpland Drive

Facsimile

Website

Engineers, Planners & Landscape Architect

Ottawa, Ontario, Canada K2M 1P6

LOCATION CITY of OTTAWA 105 HUNTMAR DRIVE - WAREHOUSE DEVELOPMENT 🦰

DRAWING NAME LANDSCAPE PLAN

122151 REV # 5 122151-L2

UNDERGROUND AND OVERGROUND UTILITIES AND

STRUCTURES IS NOT NECESSARILY SHOWN ON

THE ACCURACY OF THE POSITION OF SUCH

LOCATION OF ALL SUCH UTILITIES AND

DAMAGE TO THEM.

THE CONTRACT DRAWINGS, AND WHERE SHOWN,

UTILITIES AND STRUCTURES IS NOT GUARANTEED.

BEFORE STARTING WORK, DETERMINE THE EXACT


STRUCTURES AND ASSUME ALL LIABILITY FOR


Owner: Rosefellow c/o Julian Nini 750 Marcel-Laurin, Suite 210 Saint-Laurent, QC H4M 2M4 Phone: (514) 532-1080

NOT FOR CONSTRUCTION

1:400 REISSUED FOR SITE PLAN APPROVAL SEP 15/23 R AUG 4/23 ISSUED FOR SITE PLAN APPROVAL REVISED PER CITY COMMENTS MAY 31/23 REVISED PER CITY COMMENTS MAR 30/23 ISSUED FOR CITY OF OTTAWA REVIEW DEC 16/22 DATE REVISION

SCALE

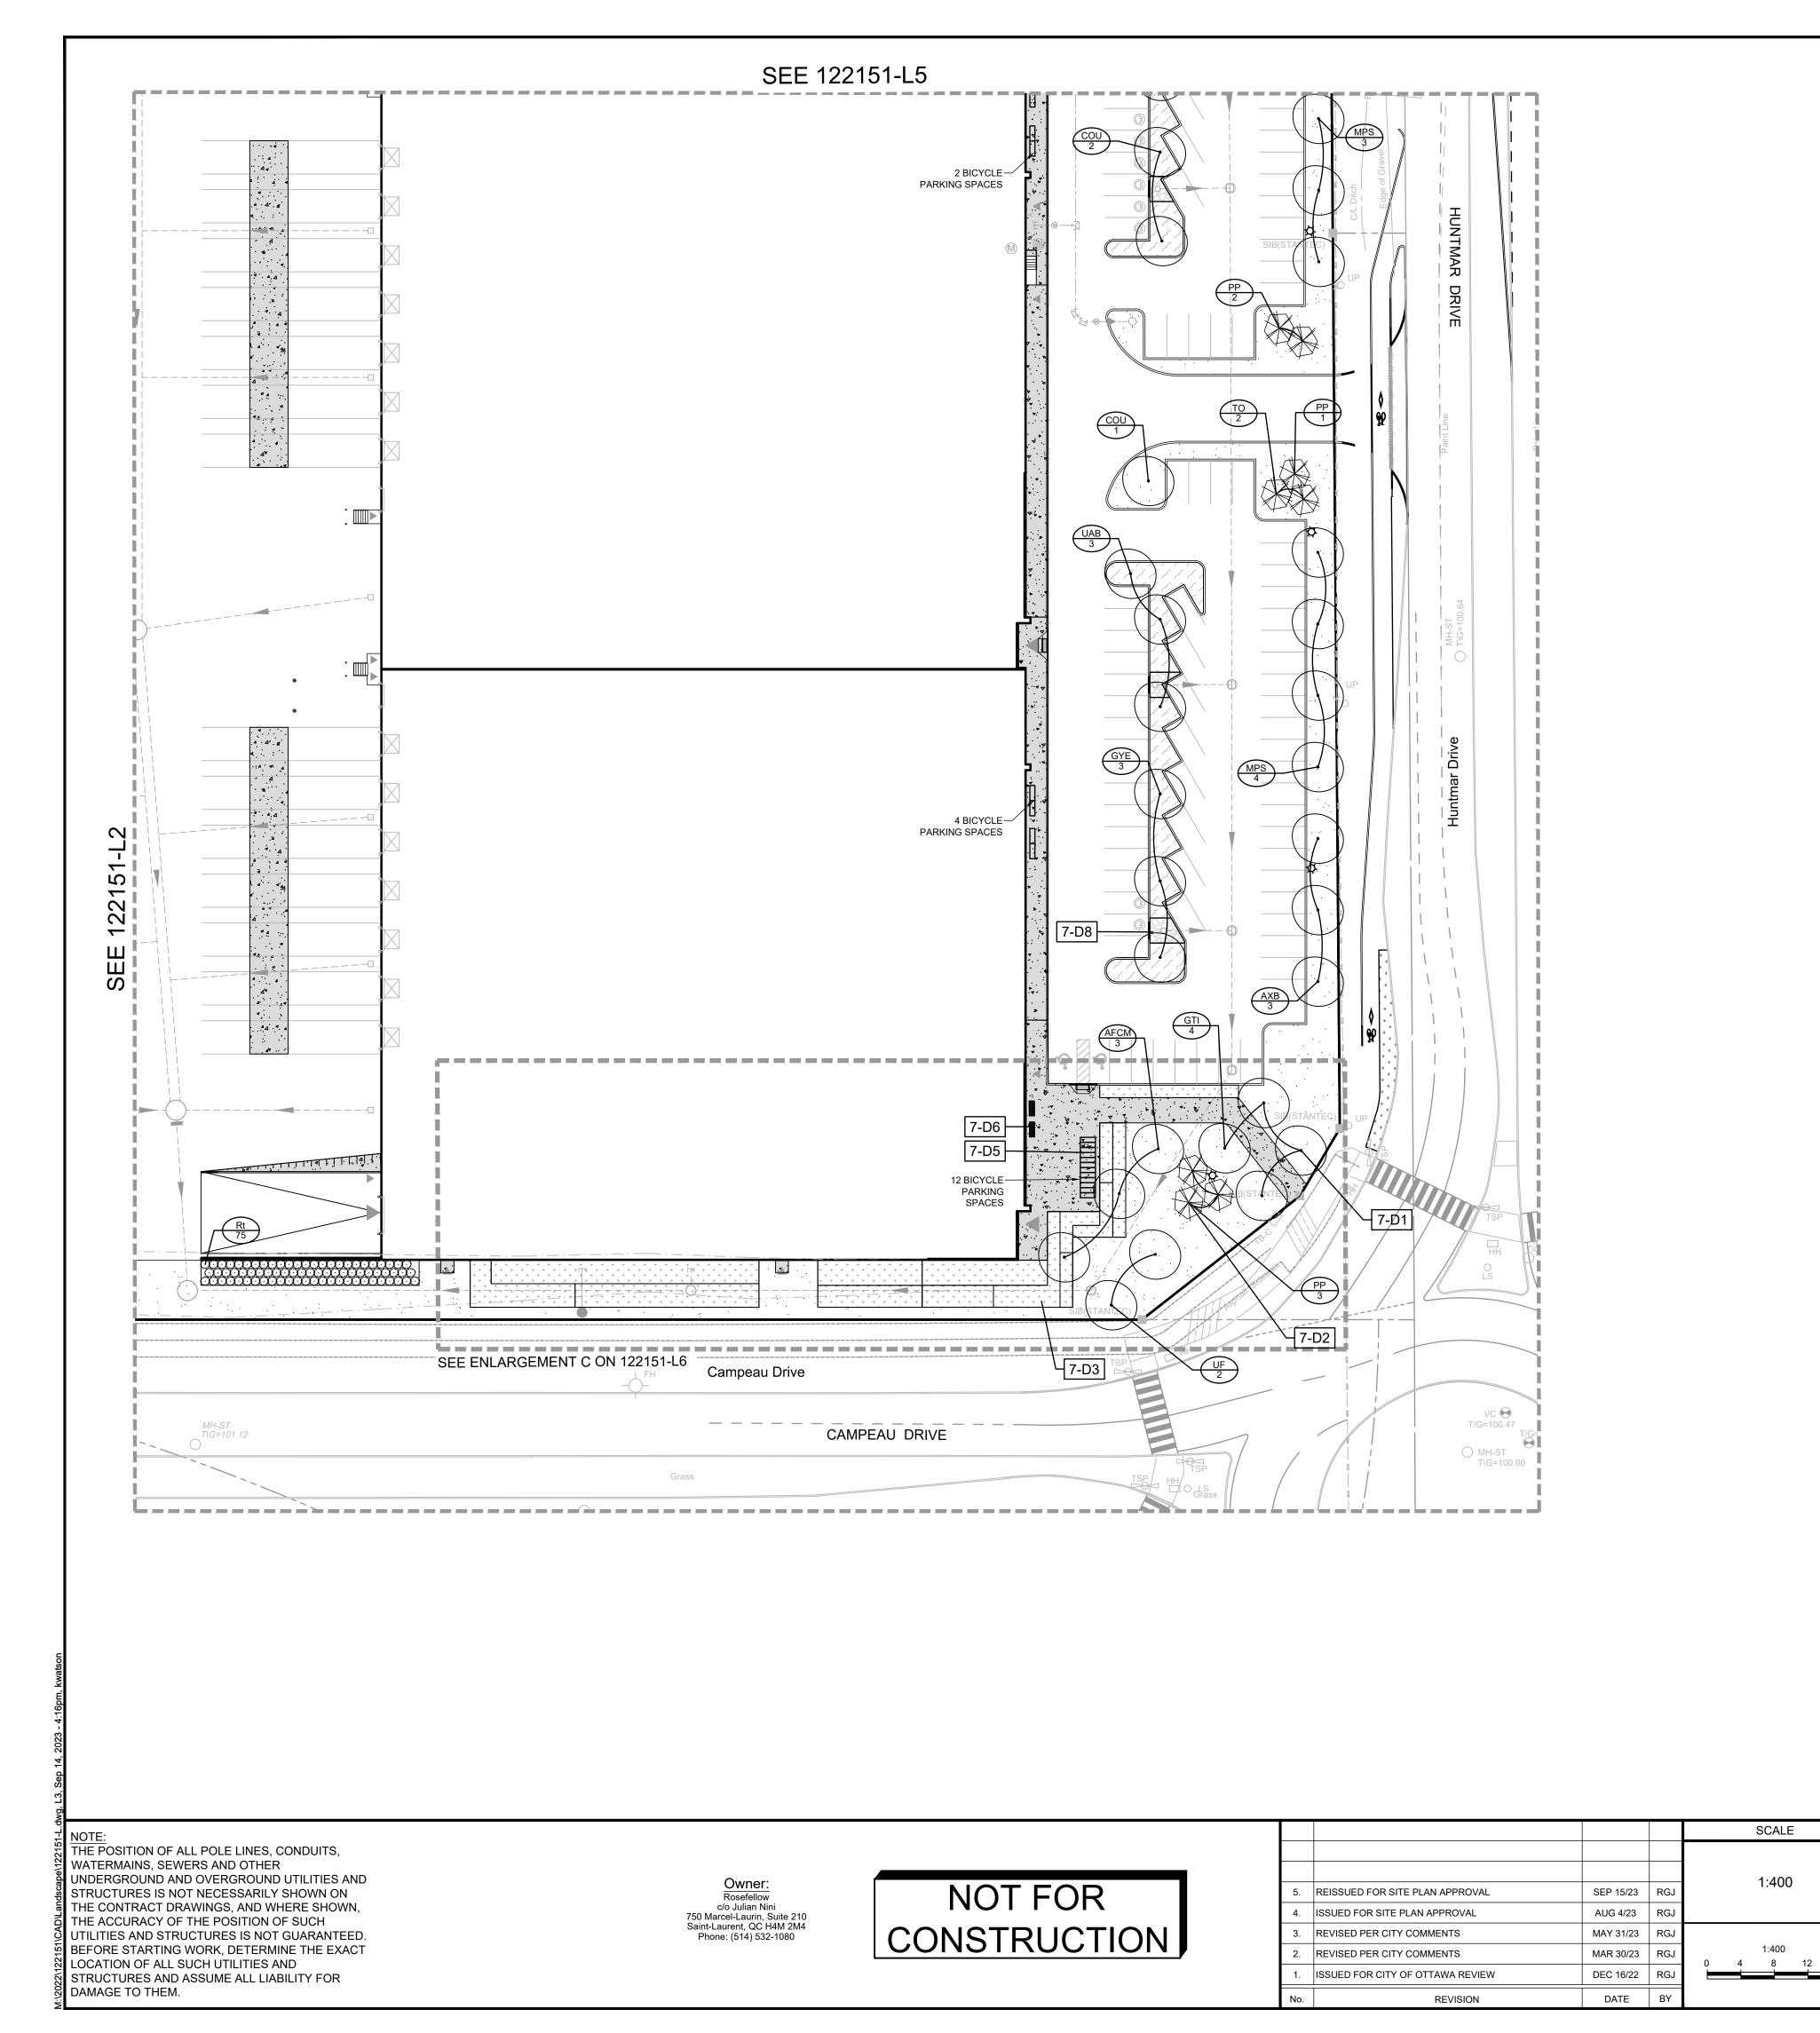

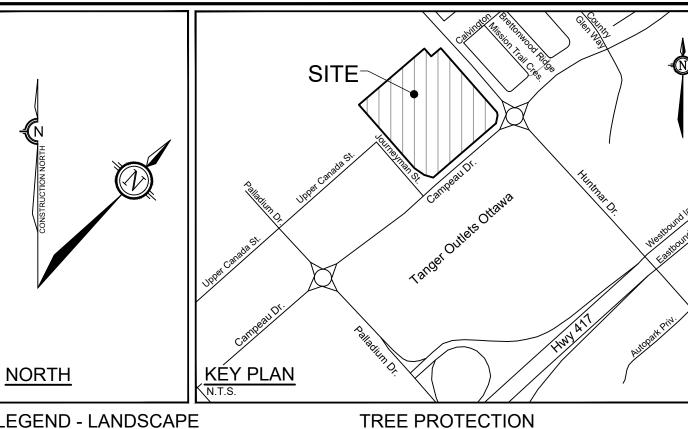

Implement the following protection measures for retained trees,

in good condition for the duration of site works:

fence prior to work commencement.

of any tree, including outhouses.

CRZ without approval.

machinery permitted.

away from any tree canopy.

ground within the CRZ.

Excavation of Root Zone.

prior to fence movement.

PLANTING

landscaping.

tree disclosure report, etc.).

including tree removal. Maintain tree protection fence in place and

1. The Landscape Architect or Certified Arborist is to determine the location of the tree protection fencing and detail it on any associated plans for the site (e.g. tree conservation report,

2. Under the guidance of a Landscape Architect or Certified

3. Refer to the Tree Protection Plan for fence location. City Forestry Staff are to approve both the plan and the installed

5. Do not attach any signs, notices, or posters to any tree.

6. Do not disturb, raise, or lower the existing grade within the

7. Only tunnel or bore when digging within the CRZ of a tree.

8. Do not damage the root system, trunk, or branches, or any

10. Ensure that exhaust fumes from all equipment are directed

11. When trees marked for removal overlap with the CRZ of trees

12. Prior to work taking place, notify and consult the Landscape Architect and City Forestry Staff if roots must be cut. Roots 20mm or larger should be cut at right angles with clean, sharp

City of Ottawa Specification S.P. F-8011 Tree Protection,

13. If damaged or objectionable branches are observed, consult

the Landscape Architect, before any work is conducted. Do

not prune leaders. Do not prune more than 1/4 of crown. 14. Set up a water and fertilizing program, if trees are being affected by site works, to the satisfaction of the Landscape

15. The Landscape Architect is to prescribe mitigation measures

construction. Measures may include the placement of

plywood, wood chips, or steel plating over the roots for protection. City Forestry Staff are to approve said measures

16. City of Ottawa By-law: Protects municipal trees and municipal

property in the urban area of the City of Ottawa (2020-340).

published by the Canadian Nursery Landscape Association.

source prior to digging. All trees and shrubs to be container grown, potted, W/B or B/B, as indicated on Plant List. Bare root plants are only acceptable for certain species and as

2. Use structurally sound plant material with strong fibrous root system free of disease, defects, and injuries. Use trees with straight trunks, well and characteristically branched for species. Obtain approval from consultant of plant material at

3. Plant material substitutions are not be permitted without the

written approval from the Consultant, with 48 hours notice,

4. Plant locations are schematic / approximate only. **Contractor** 

Contractor to report any discrepancies to the Landscape

Architect prior to installation. Contractor will assume full

responsibility if the Landscape Architect is not notified. 6. Ensure trees are thoroughly watered following planting.

Monitor material and ensure adequate moisture until

7. In heavy clay or poorly drained soils, set root ball with root

Sod to be No. 1 Kentucky Bluegrass Sod grown from

Canadian Nursery Landscape Nursery Landscape

10. Apply the following mineral fertilizer unless soil tests show

a. Plant Beds - (8-32-16), i.e. 8% Nitrogen, 32%

b. Sod Areas - (8-32-16), i.e. 8% Nitrogen, 32%

Phosphorus, 16% Potash at a rate of 350kg/ha. 11. Where applicable, for any plant areas with a mix of species/

3-5 and evenly distribute these in the noted area.

Phosphorus, 16% Potash per manufacturer specifications.

cultivars notes, Contractor is to cluster like plants in groups of

a. Plant Beds - **450mm** continuous depth. Applies to

minimum mixture of 3 Kentucky Bluegrass cultivars. Quality and source are to comply with Canadian Standards for

Nursery Stock, Section 17, (latest edition) published by the

collar 75-100mm higher than finished grade.

shrubs, perennials, vines, and groundcovers.

b. Sod/ Seed Areas - 100mm depth.

Approved topsoil depths are as follows:

is to stake out locations on site for approval by the

5. The illustrated number of plants shown in the Planting Plan

supersedes the estimated number in the Plant List.

natural areas in the City of Ottawa and trees on private

1. Plant material to be No. 1 Grade and is to comply with Canadian Standards for Nursery Stock (latest edition)

approved by the Landscape Architect.

Landscape Architect prior to installation.

prior to shipping plant material.

acceptance.

Association

other requirements:

marked for preservation: cut roots at the edge of the CRZ and grind down stumps after tree removals, do not pull out

stumps. Ensure there is not root pulling or disturbance of the

horticultural tools without tearing, crushing, or pulling. Refer to

9. Do not extend hard surface or significantly change

Hand work only where required within the CRZ; absolutely no

4. Do not place any material or equipment within 2m of the CRZ

Arborist, erect a fence at the critical root zone (CRZ) of trees. Diameter at breast height (DBH) is the trunk diameter measured at 1.3m height on the tree trunk. The CRZ is

calculated as DBH x 10. Refer to the Tree Protection Fence

#### LEGEND - LANDSCAPE

DETAIL SHEET # NOVATECH OR CITY Implement the following protection measures for retained trees both on site and on adjacent sites, prior to any work activity, including tree removal. Maintain tree protection fence in place

— — — PROPERTY LIMIT

TREE PROTECTION FENCE

PROPOSED CONCRETE

RIVERSTONE

PROPOSED PLANTING BED - SEE SHEET L6 FOR DETAILS

SEED MIX A - SEE SEED MIX APPLICATION NOTE ON SHEET L6

SEED MIX B - SEE SEED MIX APPLICATION NOTE ON SHEET L6

> SEED MIX C - SEE SEED MIX APPLICATION NOTE ON SHEETS L2-L5

PROPOSED WET SHRUB MIX, REFER TO SHEET L6 PROPOSED DRY SHRUB MIX, REFER TO SHEET L6

PROPOSED DECIDUOUS TREE

PROPOSED SHRUBS

PROPOSED CONIFEROUS TREE

EXISTING TREE TO REMAIN

CRITICAL ROOT ZONE (CRZ) FOR TREES WITH DBH GREATER THAN 10cm

EXISTING HEDGEROW TO REMAIN

- SPECIES (SEE PLANT LIST)

#### CITY DETAILS SEED MIX AND APPLICATION

Related details from City of Ottawa Standard Tender Documents For areas steeper than 3:1, Contractor to apply erosion control Volume No. 2 Standard Detail Drawings. blanket. Erosion control blanket to be machine woven mats made from natural wood, coco or cotton fiber, or combination depending SC4. Typical Concrete Sidewalk in Boulevard on manufacturer, with stitching between two photo-degradable Sidewalk Construction Joints natural organic fiber nettings. Submit products for approval by

> In addition to the specified seed mixes, all applications are to include a nurse crop as noted.

Consultant. OPSS 804 applies except as may be amended and

NURSE CROP 40% Oats (Avena sativa) 45% Barley (Hordeum vulgare) 15% Canada Wild Rye (Elymus canadensis) Seeding Rate: 15kg/hectare

extended herein.

SEED MIX C CUSTOM NATIVE PARKING ISLAND SEED MIX BY DLF Seeding Rate: 25kg/hectare

PARKING LOT - PLANT LIST

NOVATECH DETAILS

D1. Standard Deciduous Tree Planting

D2. Standard Coniferous Tree Planting

D3. Shrub and Perennial Planting

D4. Tree Protection Fence

D6. Site furniture installation

Found on Sheet L7.

D5. Bike Layout

D7. Reforestation

D8. Riverstone

Deciduous Shrubs Rt 75 Rhus typhina

FOR REVIEW ONLY

60cm Ht | PT | 100cm O.C Staghorn Sumac

Engineers, Planners & Landscape Architect

LOCATION CITY of OTTAWA 105 HUNTMAR DRIVE - WAREHOUSE DEVELOPMENT

DRAWING NAME LANDSCAPE PLAN

122151 REV # 5

122151-L3 #18906

Facsimile


Suite 200, 240 Michael Cowpland Drive


Ottawa, Ontario, Canada K2M 1P6

(613) 254-9643

(613) 254-5867

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— — — PROPERTY LIMIT

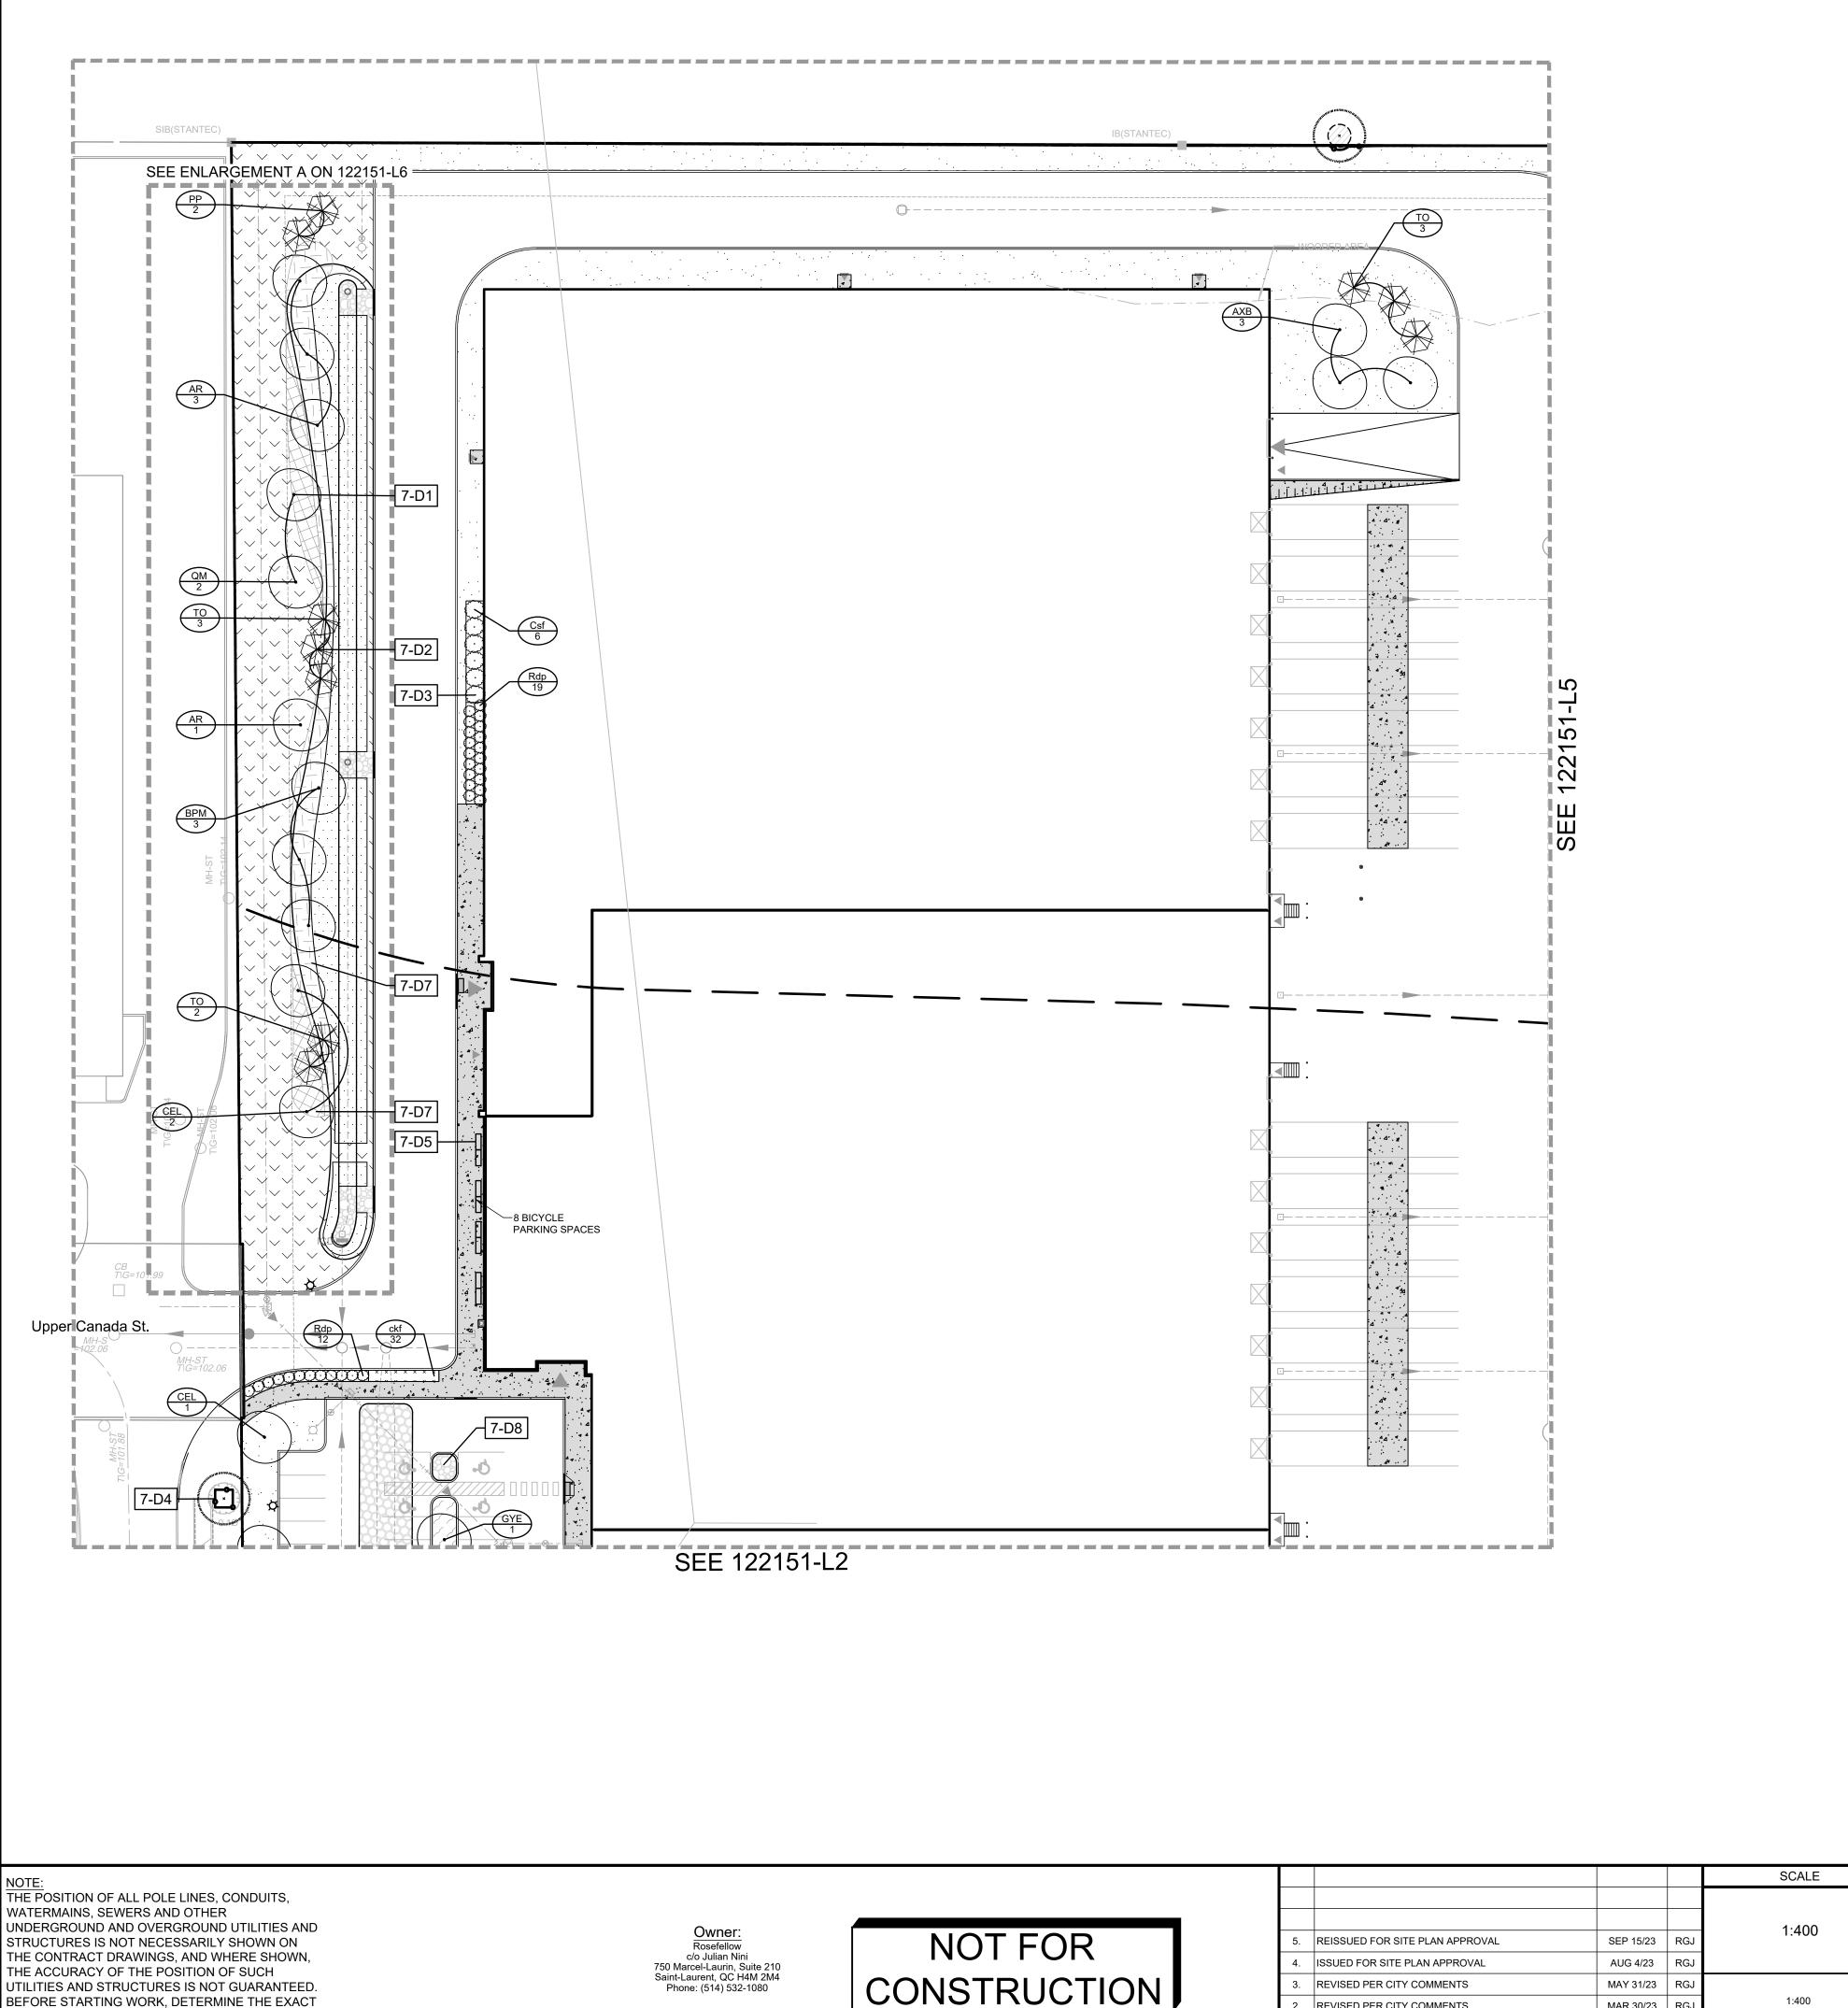TREE PROTECTION FENCE

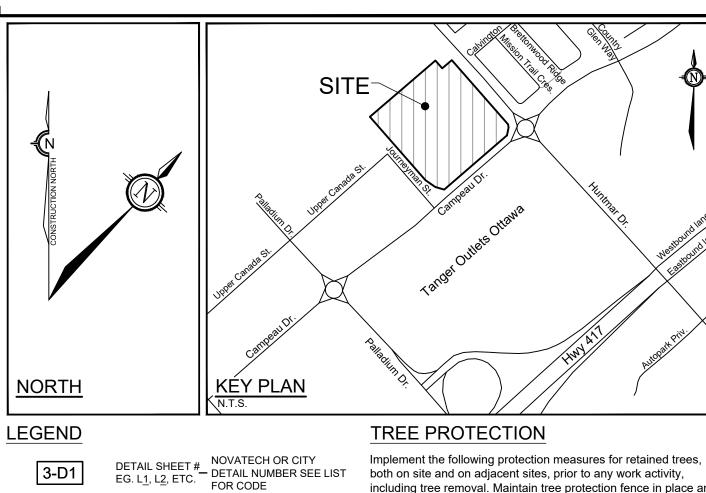PROPOSED CONCRETE

RIVERSTONE

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SEED MIX A - SEE SEED MIX APPLICATION NOTE ON SHEET L6

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SEED MIX C - SEE SEED MIX APPLICATION NOTE ON SHEETS L2-L5

PROPOSED WET SHRUB MIX,

REFER TO SHEET L6 PROPOSED DRY SHRUB MIX, REFER TO SHEET L6

PROPOSED DECIDUOUS TREE

PROPOSED CONIFEROUS TREE

PROPOSED SHRUBS

EXISTING TREE TO REMAIN

CRITICAL ROOT ZONE (CRZ) FOR TREES WITH DBH GREATER THAN 10cm

EXISTING HEDGEROW TO REMAIN

- SPECIES (SEE PLANT LIST) 

## SEED MIX AND APPLICATION

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SEED MIX C CUSTOM NATIVE PARKING ISLAND SEED MIX BY DLF Seeding Rate: 25kg/hectare

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www.novatech-eng.com

# PARKING LOT - PLANT LIST

CITY DETAILS

Found on Sheet L7.

D5. Bike Layout

D7. Reforestation

D8. Riverstone

Volume No. 2 Standard Detail Drawings.

SC5. Sidewalk Construction Joints

NOVATECH DETAILS

D1. Standard Deciduous Tree Planting

D2. Standard Coniferous Tree Planting

D3. Shrub and Perennial Planting

D4. Tree Protection Fence

D6. Site furniture installation

SC4. Typical Concrete Sidewalk in Boulevard

Deciduous Shrubs 60cm Ht PT 200cm O. Csf 6 Cornus sericea 'Flaviramea' Yellow Twig Dogwood Rdp 31 Rosa 'Dwarf Pavement' 60cm Ht | PT | 120cm O. Ornamental Grasses 1g PT 60cm O.C ckf | 32 | Calamagrostis acutiflora 'Karl Foerster' Karl Foerster Feather Reed Grass

Facsimile

Arborist, erect a fence at the critical root zone (CRZ) of trees. Diameter at breast height (DBH) is the trunk diameter measured at 1.3m height on the tree trunk. The CRZ is calculated as DBH x 10. Refer to the Tree Protection Fence

> 3. Refer to the Tree Protection Plan for fence location. City Forestry Staff are to approve both the plan and the installed fence prior to work commencement. 4. Do not place any material or equipment within 2m of the CRZ

> including tree removal. Maintain tree protection fence in place and

1. The Landscape Architect or Certified Arborist is to determine

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the location of the tree protection fencing and detail it on any associated plans for the site (e.g. tree conservation report,

in good condition for the duration of site works:

tree disclosure report, etc.).

of any tree, including outhouses. 5. Do not attach any signs, notices, or posters to any tree. 6. Do not disturb, raise, or lower the existing grade within the CRZ without approval.

7. Only tunnel or bore when digging within the CRZ of a tree.

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9. Do not extend hard surface or significantly change landscaping.

10. Ensure that exhaust fumes from all equipment are directed away from any tree canopy. 11. When trees marked for removal overlap with the CRZ of trees

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13. If damaged or objectionable branches are observed, consult the Landscape Architect, before any work is conducted. Do not prune leaders. Do not prune more than 1/4 of crown. 14. Set up a water and fertilizing program, if trees are being

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# PLANTING

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system free of disease, defects, and injuries. Use trees with straight trunks, well and characteristically branched for species. Obtain approval from consultant of plant material at source prior to digging. All trees and shrubs to be container grown, potted, W/B or B/B, as indicated on Plant List. Bare root plants are only acceptable for certain species and as

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Monitor material and ensure adequate moisture until acceptance. 7. In heavy clay or poorly drained soils, set root ball with root

collar 75-100mm higher than finished grade. Approved topsoil depths are as follows:

a. Plant Beds - **450mm** continuous depth. Applies to shrubs, perennials, vines, and groundcovers.

b. Sod/ Seed Areas - 100mm depth. 9. Sod to be No. 1 Kentucky Bluegrass Sod grown from minimum mixture of 3 Kentucky Bluegrass cultivars. Quality and source are to comply with Canadian Standards for

Nursery Stock, Section 17, (latest edition) published by the Canadian Nursery Landscape Nursery Landscape Association 10. Apply the following mineral fertilizer unless soil tests show

other requirements: a. Plant Beds - (8-32-16), i.e. 8% Nitrogen, 32%

Phosphorus, 16% Potash per manufacturer specifications. b. Sod Areas - (8-32-16), i.e. 8% Nitrogen, 32% Phosphorus, 16% Potash at a rate of 350kg/ha.

Where applicable, for any plant areas with a mix of species/ cultivars notes, Contractor is to cluster like plants in groups of 3-5 and evenly distribute these in the noted area.


LOCATION OF ALL SUCH UTILITIES AND

DAMAGE TO THEM.

STRUCTURES AND ASSUME ALL LIABILITY FOR

CONSTRUCTION

					CHECKED	
5.	REISSUED FOR SITE PLAN APPROVAL	SEP 15/23	RGJ	1:400	RGJ	
4.	ISSUED FOR SITE PLAN APPROVAL	AUG 4/23	RGJ		TB	
3.	REVISED PER CITY COMMENTS	MAY 31/23	RGJ		CHECKED	
2.	REVISED PER CITY COMMENTS	MAR 30/23	RGJ	1:400 0 4 8 12 16	ĸW	
1.	ISSUED FOR CITY OF OTTAWA REVIEW	DEC 16/22	RGJ	0 4 0 12 10	APPROVED	
No.	REVISION	DATE	BY		RGJ	

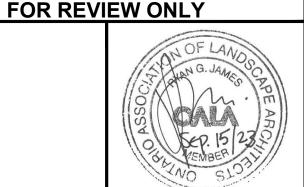




CITY of OTTAWA DRAWING NAME LANDSCAPE PLAN

LOCATION

105 HUNTMAR DRIVE - WAREHOUSE DEVELOPMENT 🦰

122151

REV # 5

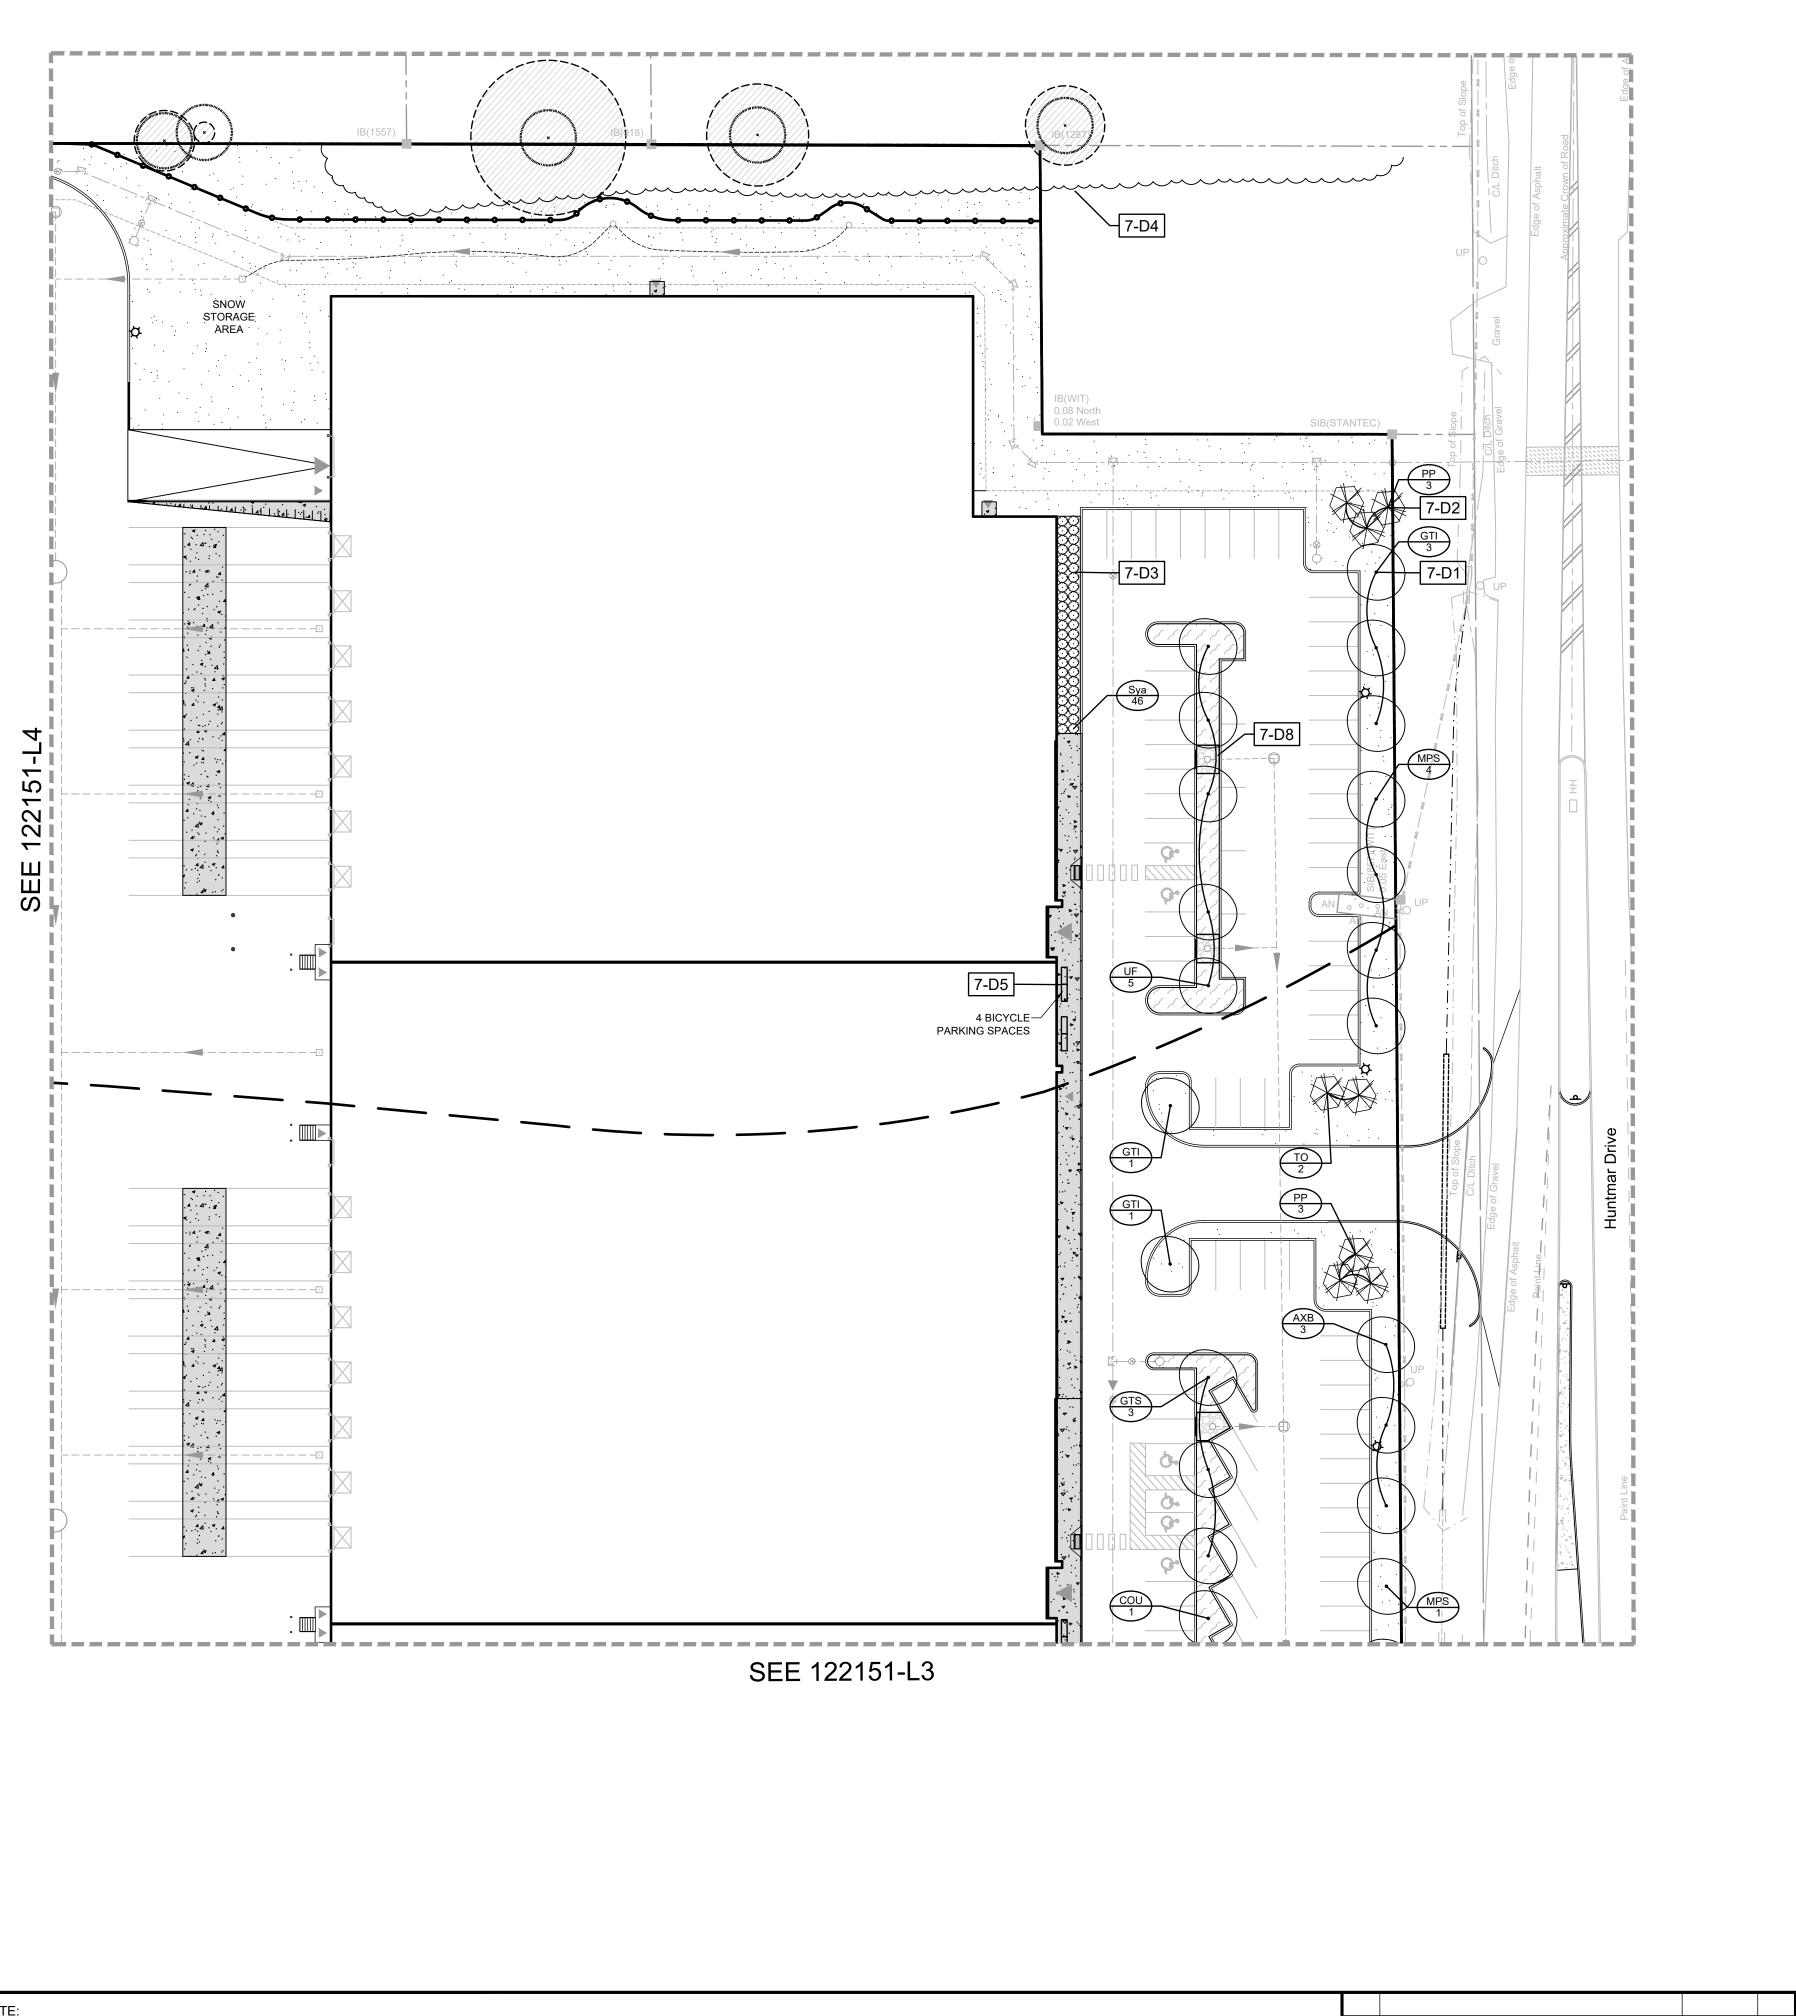

c/o Julian Nini

750 Marcel-Laurin, Suite 210 Saint-Laurent, QC H4M 2M4 Phone: (514) 532-1080

THE POSITION OF ALL POLE LINES, CONDUITS,

UNDERGROUND AND OVERGROUND UTILITIES AND

STRUCTURES IS NOT NECESSARILY SHOWN ON

THE ACCURACY OF THE POSITION OF SUCH

LOCATION OF ALL SUCH UTILITIES AND


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THE CONTRACT DRAWINGS, AND WHERE SHOWN,

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STRUCTURES AND ASSUME ALL LIABILITY FOR

WATERMAINS, SEWERS AND OTHER



Implement the following protection measures for retained trees,
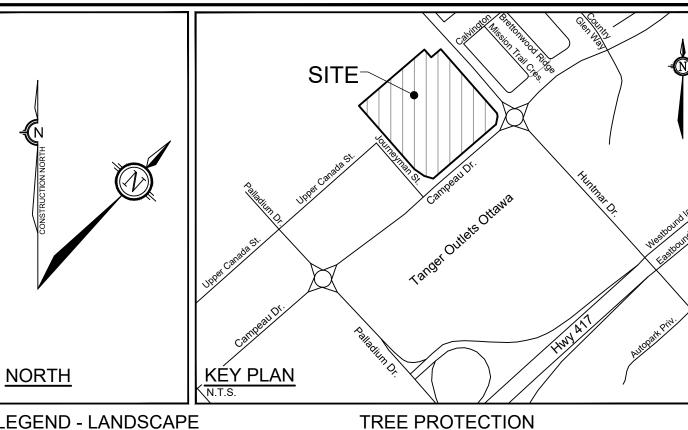
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2. Under the guidance of a Landscape Architect or Certified

3. Refer to the Tree Protection Plan for fence location. City Forestry Staff are to approve both the plan and the installed

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and source are to comply with Canadian Standards for

Canadian Nursery Landscape Nursery Landscape

sod is not typically graphically shown on plans.

Phosphorus, 16% Potash at a rate of 350kg/ha. 12. Where applicable, for any plant areas with a mix of species/

3-5 and evenly distribute these in the noted area.

10. Install a 1.2m sod strip adjacent to all hard surfaces. Note,

Apply the following mineral fertilizer unless soil tests show

a. Plant Beds - (8-32-16), i.e. 8% Nitrogen, 32% Phosphorus, 16% Potash per manufacturer specifications. b. Sod Areas - (8-32-16), i.e. 8% Nitrogen, 32%

cultivars notes, Contractor is to cluster like plants in groups of

Ensure trees are thoroughly watered following planting.

Monitor material and ensure adequate moisture until

is to stake out locations on site for approval by the

5. The illustrated number of plants shown in the Planting Plan supersedes the estimated number in the Plant List. Contractor to report any discrepancies to the Landscape

natural areas in the City of Ottawa and trees on private property in the urban area of the City of Ottawa (2020-340).

1. Plant material to be No. 1 Grade and is to comply with Canadian Standards for Nursery Stock (latest edition)

approved by the Landscape Architect.

Landscape Architect prior to installation.

collar 75-100mm higher than finished grade.

shrubs, perennials, vines, and groundcovers.

9. Sod to be No. 1 Kentucky Bluegrass Sod grown from

b. Sod/ Seed Areas - 100mm depth.

Approved topsoil depths are as follows:

prior to shipping plant material.

the Landscape Architect, before any work is conducted. Do

marked for preservation: cut roots at the edge of the CRZ and

20mm or larger should be cut at right angles with clean, sharp

horticultural tools without tearing, crushing, or pulling. Refer to

9. Do not extend hard surface or significantly change

4. Do not place any material or equipment within 2m of the CRZ

the location of the tree protection fencing and detail it on any associated plans for the site (e.g. tree conservation report,

Arborist, erect a fence at the critical root zone (CRZ) of trees. Diameter at breast height (DBH) is the trunk diameter measured at 1.3m height on the tree trunk. The CRZ is

calculated as DBH x 10. Refer to the Tree Protection Fence

both on site and on adjacent sites, prior to any work activity, including tree removal. Maintain tree protection fence in place and

in good condition for the duration of site works:

fence prior to work commencement.

of any tree, including outhouses.

CRZ without approval.

machinery permitted.

away from any tree canopy.

ground within the CRZ.

Excavation of Root Zone.

prior to fence movement.

PLANTING

acceptance.

Association.

other requirements:

landscaping.

tree disclosure report, etc.).

#### LEGEND - LANDSCAPE

DETAIL SHEET # NOVATECH OR CITY
EG. L<u>1</u>, L<u>2</u>, ETC. DETAIL NUMBER SEE LIST
FOR CODE

— — — PROPERTY LIMIT

TREE PROTECTION FENCE

PROPOSED CONCRETE

RIVERSTONE

PROPOSED PLANTING BED - SEE SHEET L6 FOR DETAILS

SEED MIX A - SEE SEED MIX APPLICATION NOTE ON SHEET L6

PROPOSED WET SHRUB MIX,

SEED MIX B - SEE SEED MIX APPLICATION NOTE ON SHEET L6

> SEED MIX C - SEE SEED MIX APPLICATION NOTE ON SHEETS L2-L5

REFER TO SHEET L6 PROPOSED DRY SHRUB MIX, REFER TO SHEET L6

PROPOSED DECIDUOUS TREE

PROPOSED CONIFEROUS TREE

PROPOSED SHRUBS

EXISTING TREE TO REMAIN

CRITICAL ROOT ZONE (CRZ) FOR TREES WITH DBH GREATER THAN 10cm

EXISTING HEDGEROW TO REMAIN

- SPECIES

(SEE PLANT LIST) 

## SEED MIX AND APPLICATION

Related details from City of Ottawa Standard Tender Documents For areas steeper than 3:1, Contractor to apply erosion control blanket. Erosion control blanket to be machine woven mats made from natural wood, coco or cotton fiber, or combination depending on manufacturer, with stitching between two photo-degradable natural organic fiber nettings. Submit products for approval by Consultant. OPSS 804 applies except as may be amended and extended herein.

> In addition to the specified seed mixes, all applications are to include a nurse crop as noted.

NURSE CROP 40% Oats (Avena sativa) 45% Barley (Hordeum vulgare) 15% Canada Wild Rye (Elymus canadensis) Seeding Rate: 15kg/hectare

SEED MIX C CUSTOM NATIVE PARKING ISLAND SEED MIX BY DLF Seeding Rate: 25kg/hectare

(613) 254-9643

(613) 254-5867

www.novatech-eng.com

## PARKING LOT - PLANT LIST

FOR REVIEW ONLY

Deciduous Shrubs Sya 46 Symphoricarpos albus

CITY DETAILS

Found on Sheet L7.

D5. Bike Layout

D7. Reforestation

D8. Riverstone

Volume No. 2 Standard Detail Drawings.

SC5. Sidewalk Construction Joints

NOVATECH DETAILS

D1. Standard Deciduous Tree Planting

D2. Standard Coniferous Tree Planting

D3. Shrub and Perennial Planting

D4. Tree Protection Fence

D6. Site furniture installation

Typical Concrete Sidewalk in Boulevard

Snowberry

Engineers, Planners & Landscape Architect

LOCATION CITY of OTTAWA

50cm Ht PT 90cm O.C

105 HUNTMAR DRIVE - WAREHOUSE DEVELOPMENT 🦰

LANDSCAPE PLAN

122151 REV # 5 122151-L5

SCALE 1:400 NOT FOR REISSUED FOR SITE PLAN APPROVAL SEP 15/23 RG AUG 4/23 ISSUED FOR SITE PLAN APPROVAL CONSTRUCTION REVISED PER CITY COMMENTS MAY 31/23 REVISED PER CITY COMMENTS MAR 30/23 ISSUED FOR CITY OF OTTAWA REVIEW DEC 16/22

REVISION

DATE


#18906

Ottawa, Ontario, Canada K2M 1P6

Suite 200, 240 Michael Cowpland Drive


Facsimile

DRAWING NAME

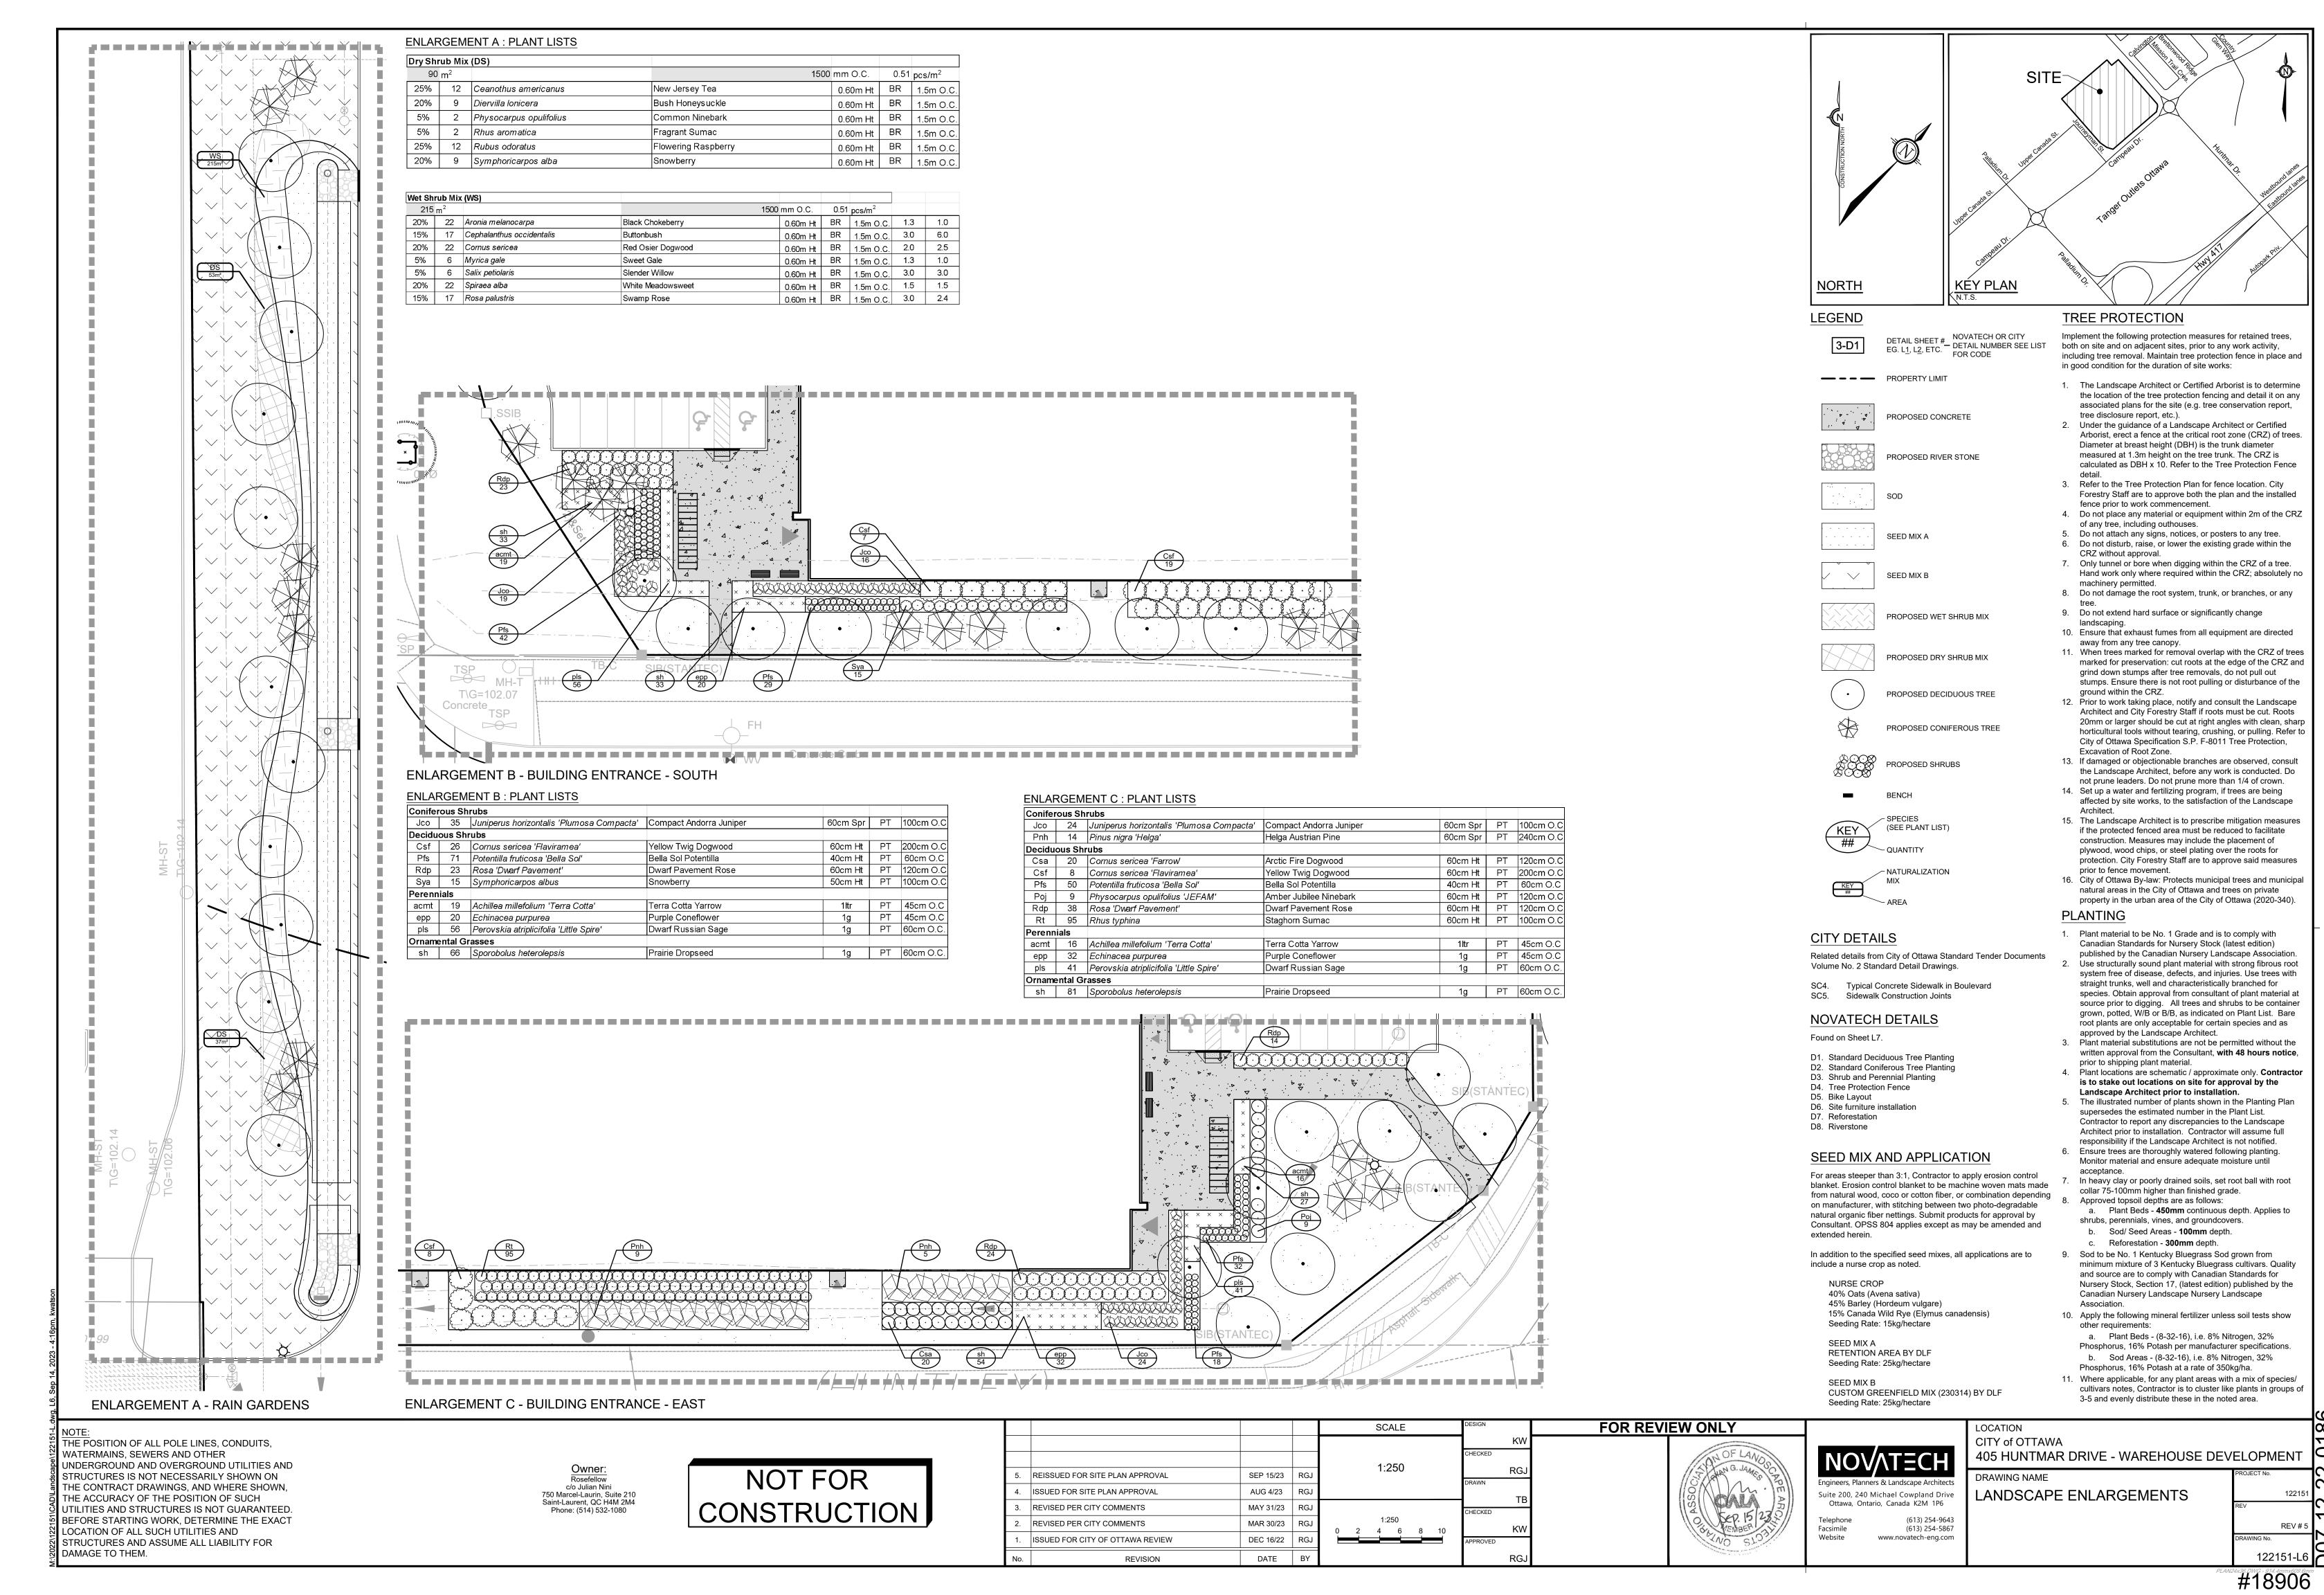

122151

REV # 5

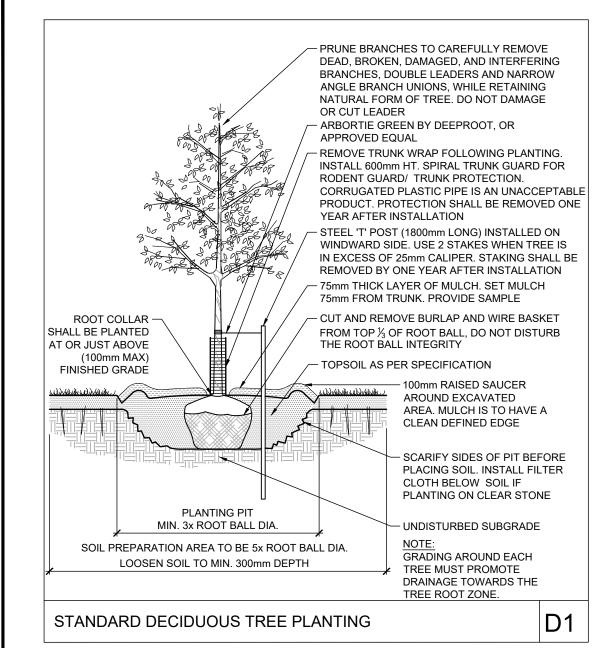

1200 TYP.

SEE PLAN

1200 TYP

└─ ONE (1) BIKE

FASTEN ALL SITE FURNISHINGS TO SURFACE

**BIKE LAYOUT** 

WITH STAINLESS STEEL ANTI-VANDAL ANCHORS.

PARKING SPACE

(600 x 1800mm)

SEE PLAN

→ WALKWAY →

ACCESS

900 MIN. FROM

ADJACENT

**OBSTRUCTION OR** 

EDGE OF SURFACE


- BIKE RACK,


SEE PLAN FOR


SEE PRODUCT INFORMATION


QUANTITY AND ORIENTATION


FOR MAKE AND MODEL,

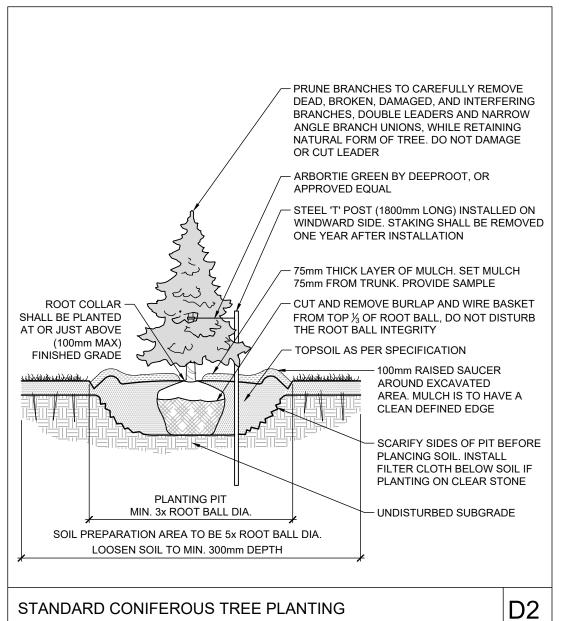


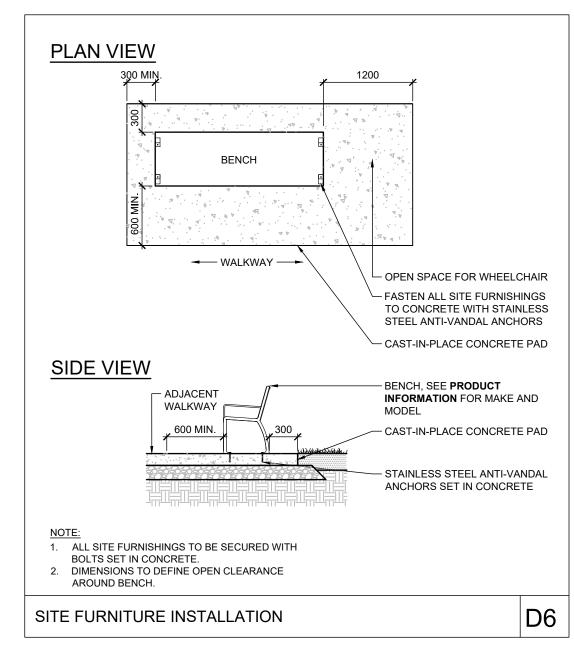

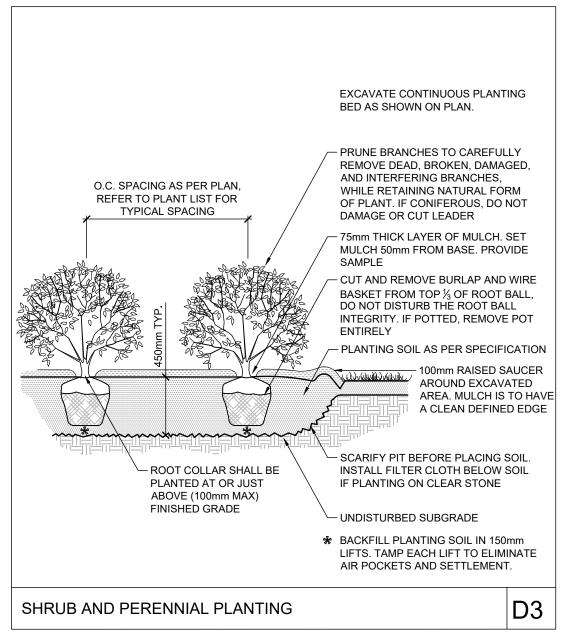

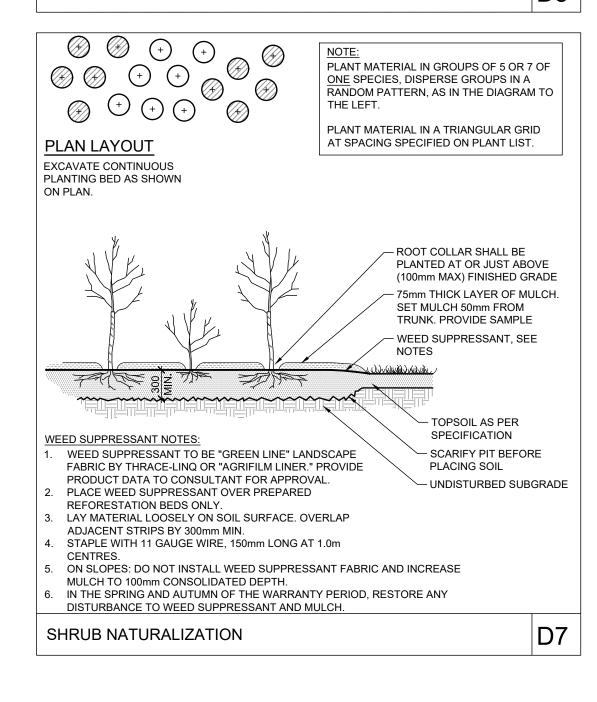

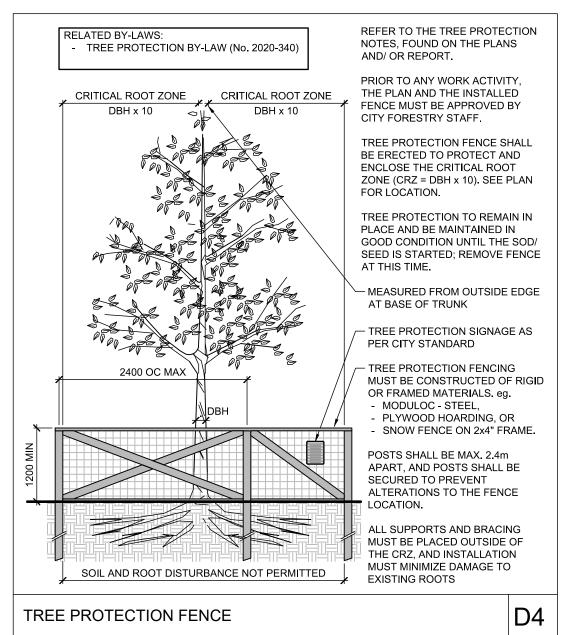

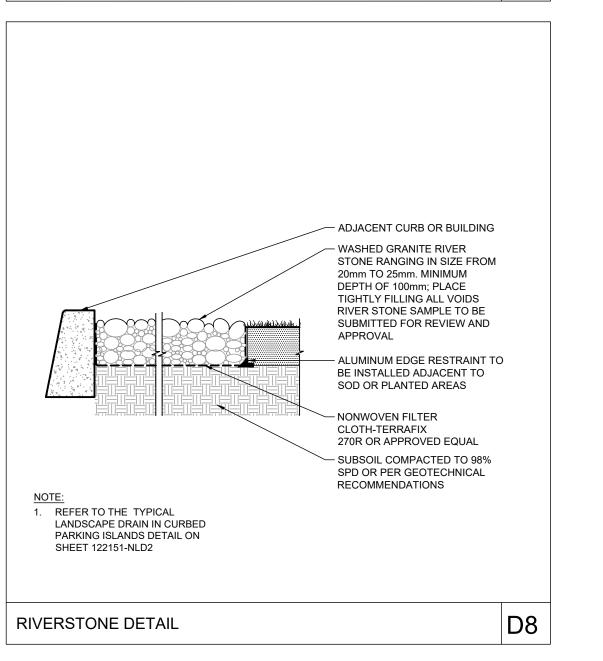


NOTE:
THE POSITION OF ALL POLE LINES, CONDUITS,
WATERMAINS, SEWERS AND OTHER
UNDERGROUND AND OVERGROUND UTILITIES AND
STRUCTURES IS NOT NECESSARILY SHOWN ON
THE CONTRACT DRAWINGS, AND WHERE SHOWN,
THE ACCURACY OF THE POSITION OF SUCH
UTILITIES AND STRUCTURES IS NOT GUARANTEED.
BEFORE STARTING WORK, DETERMINE THE EXACT
LOCATION OF ALL SUCH UTILITIES AND
STRUCTURES AND ASSUME ALL LIABILITY FOR
DAMAGE TO THEM.

Owner:
Rosefellow
c/o Julian Nini
750 Marcel-Laurin, Suite 210
Saint-Laurent, QC H4M 2M4
Phone: (514) 532-1080

NOT FOR CONSTRUCTION

					SCALE	DESIGN	
						KV	٧
						CHECKED	
	5.	REISSUED FOR SITE PLAN APPROVAL	SEP 15/23	RGJ		RG DRAWN	J
	4.	ISSUED FOR SITE PLAN APPROVAL	AUG 4/23	RGJ		KV	V
	3.	REVISED PER CITY COMMENTS	MAY 31/23	RGJ	CHECK	CHECKED	v
	2.	REVISED PER CITY COMMENTS	MAR 30/23	RGJ		KV	v
	1.	ISSUED FOR CITY OF OTTAWA REVIEW	DEC 16/22	RGJ		APPROVED	
	No.	REVISION	DATE	BY		RG	J

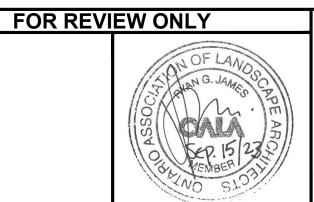

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Telephone (613) 254-9643
Facsimile (613) 254-5867

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Website

LOCATION
CITY of OTTAWA
405 HUNTMAR DRIVE - WAREHOUSE DEVELOPMENT

DRAWING NAME
LANDSCAPE DETAILS

PROJECT NO.

122151
REV

REV # 5

122151-L7