


ID	Qty	Botanical Name	Common Name	Sched. Size	Remarks
		TREES			
CaW	2	Caragana arborescens 'Walker' (Std	Walker Siberian Peashrub (Standard)	125cm STEM	WB, specimen
		SHRUBS			
lv	4	Ilex verticillata	Winterberry	2 gallon pot	Potted
JcPP	17	Juniperus communis 'Pencil Point'	Pencil Point Juniper	125cm ht	Potted
PpG	2	Picea pungens 'Glauca Globosa'	Globe Blue Spruce	100cm ht	Potted
PpS	1	Picea pungens 'Sester Dwarf'	Sester Dwarf Blue Spruce	125cm ht	specimen
PmP	1	Pinus mugo 'Pumilo'	Dwarf Mugho Pine	125cm ht	1.5m o.c.
SbG	7	Spiraea bumalda 'Goldflame'	Goldflame Spirea	50cm ht	0.9m o.c.
Vd	1	Viburnum dentatum	Arrowwood	125cm ht	Bare root
		PERENNIALS			
PvB	73	Perennial Mix B	Sun-Shade varieties for high exposure	rieties for high exposure 150mm pot	
PvHM	16	Panicum virgatum 'Heavy Metal'	Heavy Metal Switch Grass		Potted
		GROUNDCOVERS			
PvG	341	LiveRoof Sedums	LiveRoof Highrise Groundcover Mix		

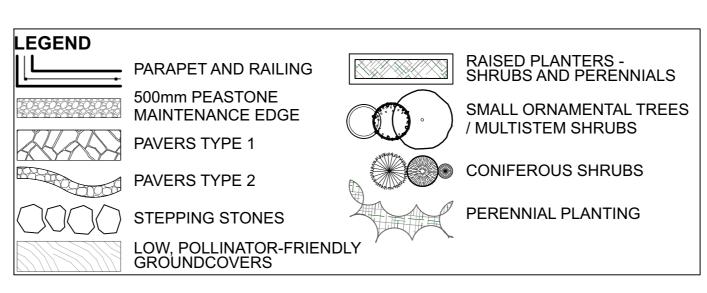

NOTE:

THIS PLAN IS ISSUED FOR SITE PLAN **CONTROL SUBMISSION ONLY.** ADDITIONAL DETAILING AND SPECIFICATIONS ARE REQUIRED PRIOR TO TENDERING OR CONSTRUCTION.



INTEGRATED DESIGN ENGINEERING + ARCHITECTURE

> 595 BYRON AVE OTTAWA, ONT. K1A 4C4 T 613.728.0008. E info@integrateddesign.ca

Ruhland & Associates Ltd


GENERAL NOTES

.1 All general site information and conditions compiled from existing plans, surveys and consultant's field notes. Report all discrepancies prior to any work. No responsibility is born by the Consultant for unknown subsurface


- .2 The location of the utilities is approximate only, and the exact location should be determined by consulting the municipal authorities and utility companies concerned. The Contractor shall prove the location of utilities and shall be responsible for adequate protection
- from damage.

 3 All dimensions shown are to be verified on site prior to any construction. No deviations are to be made from the layouts as shown on this plan without prior consultation with the Landscape Architect and Owner.
- .4 Obtain approval of the Consultant(s) for granular base and layout of all pavement areas prior to construction.
- .5 Stake planting locations and receive approval of Landscape Architect, prior to excavation of any planting pits. No substitutions of plant material shall be made without prior approval of the Landscape Architect.
- .6 Where clay is encountered proper drainage must be ensured in tree/shrub pits, prior to planting. Have method approved by Landscape
- .7 Maintain positive surface runoff through the entire construction period..8 Reinstate all areas and items damaged as a result of construction activities.

6					
5					
4					
3	Issued for Site Pla	2023/08/31			
2	Issued for Site Pla	an Application	2023/06/30		
1	Issued for Site Pla	an Application	2022/12/21		
NUMBER/ NUMÉRO	MILESTONE / FAIT SAILLANT		DATE: (Y/M/D) (A/M/J)		
ARCHIT	ECT	CONSULTANT			

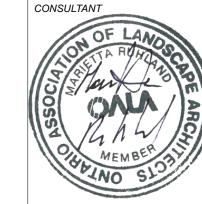



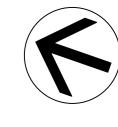

PROJECT / LOCATION


4-Storey Mixed Use Building 8743169 Canada Ltd

2663 Innes Road Ottawa, Ontario

22-1704

ROOF LOUNGE PLAN / SOIL VOLUMES & CANOPY COVERAGE

CANOLLOVENAGE		
DATE: DESIGNED BY / CONCU PAR	CHECKED BY / VERIFIE PAR	
A.A. / T.F.	M.R.	
DRAWN BY / DESSINE PAR	SCALE / ECHELLE	
T.F.	SHEET NO	

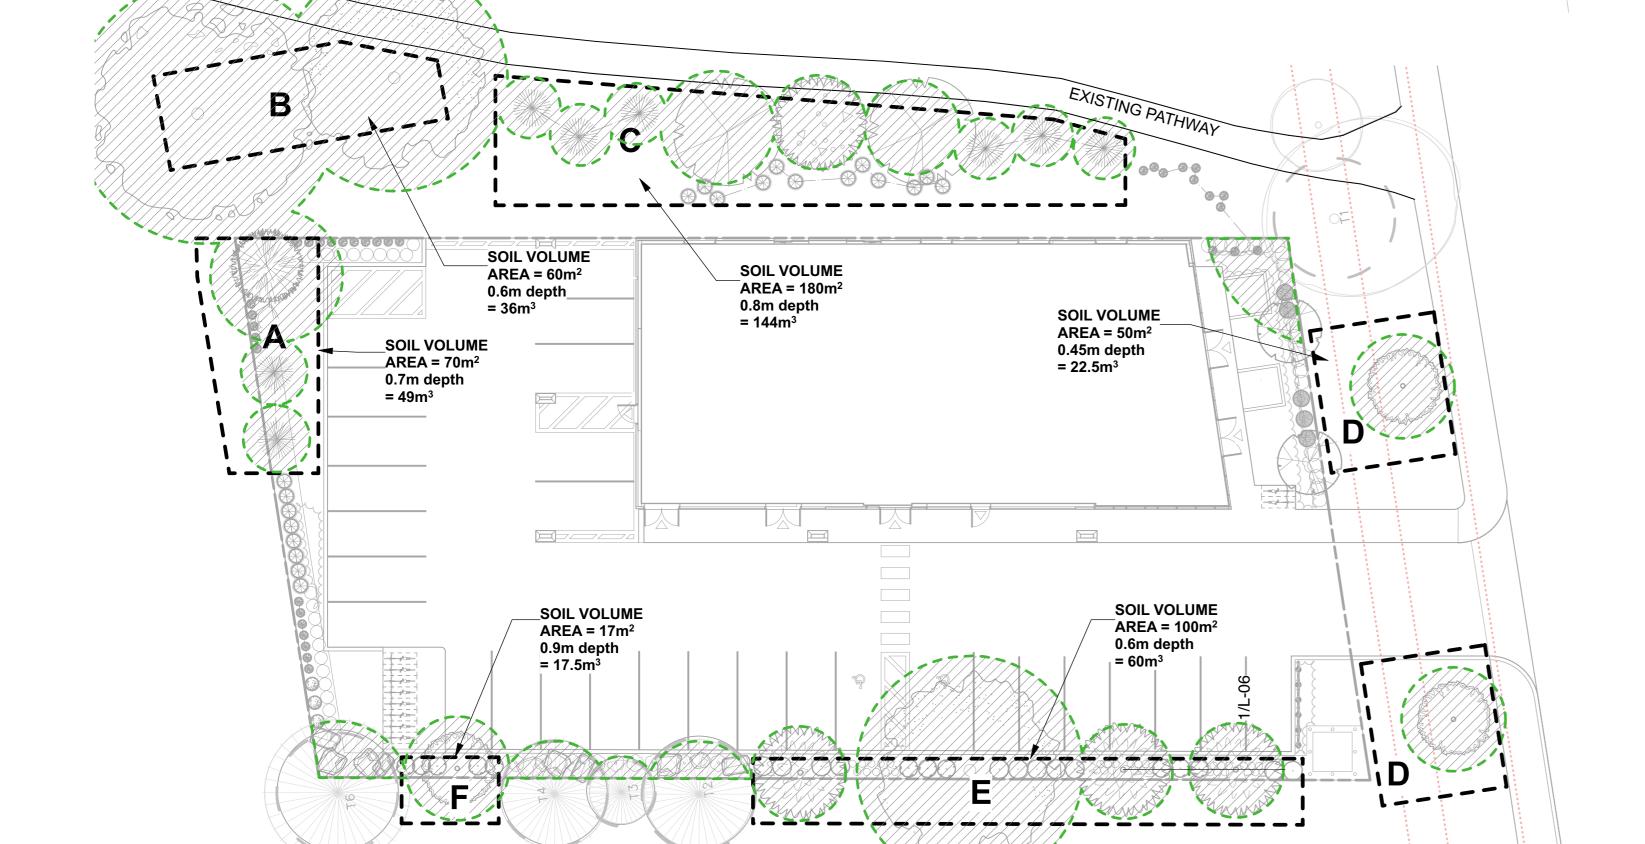

SOIL VOLUMES AND CANOPY COVERAGE

Scale: 1:200



Total Tree Canopy Coverage: 715m² Total Property Area: 1590m²

Percentage of Tree Canopy Coverage: 45%

SOIL VOLUME MATRIX:

SOIL VOLUME CALCULATIONS - Tree quantity and size soil volume area and depth	Tree Quantity	OTTAWA Target Soil Volume (m³)	Design Soil Volume	Soil Adequacy percentage
AREA A - 3 conifers plant bed (65 sq m x 0.9 metre deep)	3	54.0	58.5	108.33%
AREA B - 1 large, 1 medium, 6 conifers, 3 sm plant bed (250 sq m x 0.9 metre deep)	all trees	189.0	225.0	119.05%
AREA C - 1 medium tree, 3 small trees plant bed (91 sq m x 0.9 metre deep)	4	63.0	81.9	130.00%
AREA D - 1 small tree (in multi-tree area) plant bed (16.5 sq m x 0.9 metre deep)	1	15.0	15.0	100.00%
AREA E - 1 small tree (in Innes Road ROW) plant bed (16.5 sq m x 0.9 metre deep)	1	15.0	15.0	100.00%

Due to clay soils, tree volumes are calculated according to City of Ottawa guide for one size up from actual proposed tree.