


### EXISTING TREE LIST

KEY	QTY	BOTANICAL NAME	COMMON NAME	SIZE	CONDITION	REMARKS
<b>TREES</b>						
AN	*	Acer negundo	Manitoba Maple	100-200mm DBH	Poor-Good	See plan
AS	*	Acer saccharinum	Silver Maple	100-250mm DBH	Good	To remain
PD	*	Populus deltoides	Eastern Cottonwood	100-200mm DBH	Good	To remain
RT	*	Rhus typhina	Staghorn Sumac	100-150mm DBH	Dead-poor	See plan
PR	*	Prunus sp.	Cherry	100-150mm DBH	Good	To remain
PT	*	Populus tremuloides	Trembling Aspen	100-150mm DBH	Good	To remain
PG	4	Picea glauca	White Spruce	300-500mm DBH	Good	To remain
PA	3	Picea abies	Norway Spruce	400-500mm DBH	Poor-Good	To remain


### PROPOSED PLANT LIST

KEY	QTY	BOTANICAL NAME	COMMON NAME	SIZE	CONDITION	REMARKS
<b>TREES</b>						
RM	2	Acer rubrum	Freeman's Maple	60mm ø	B&B	Single leader
SM	2	Acer saccharum	Sugar Maple	60mm ø	B&B	
SB	3	Amelanchier canadensis	Serviceberry	60mm ø	B&B	
WS	3	Picea glauca	White Spruce	1.8m ht.	B&B	

- #### GENERAL NOTES:
- It is the responsibility of the appropriate contractor or official to report any errors, omissions or discrepancies on this plan with actual site conditions to the Landscape Architect before proceeding with construction.
  - The contractor is to notify all utility companies and authorities prior to any excavation and ascertain locations of underground services.
  - The contractor is to reinstate all areas and items damaged as a result of construction activity.
  - The contractor is to comply with all pertinent codes and by-laws.
  - The contractor is to maintain a positive surface run-off throughout the entire construction period.
  - The Landscape Architect is not responsible for subsurface conditions.
  - The contractor is to identify all existing trees to remain on site with the Landscape Architect prior to construction.
  - The contractor is to stake the proposed location of all plant material in conjunction with the Landscape Architect prior to excavation.
  - Minimum distances for selected deciduous trees are as follows:
    - Building Foundations 7.5m
    - Sidewalks 1.5m
    - Public Streets 2.5m
    - Underground Infrastructure 2.0m
  - All trees within 1m of underground utility trenches are to be excavated by hand.
  - Remove all protective wrapping from tree trunks after installation.
  - Staking of trees shall only be performed if necessary.
  - Ensure that mulch is pulled back a min. distance of 75mm from base of tree trunk.

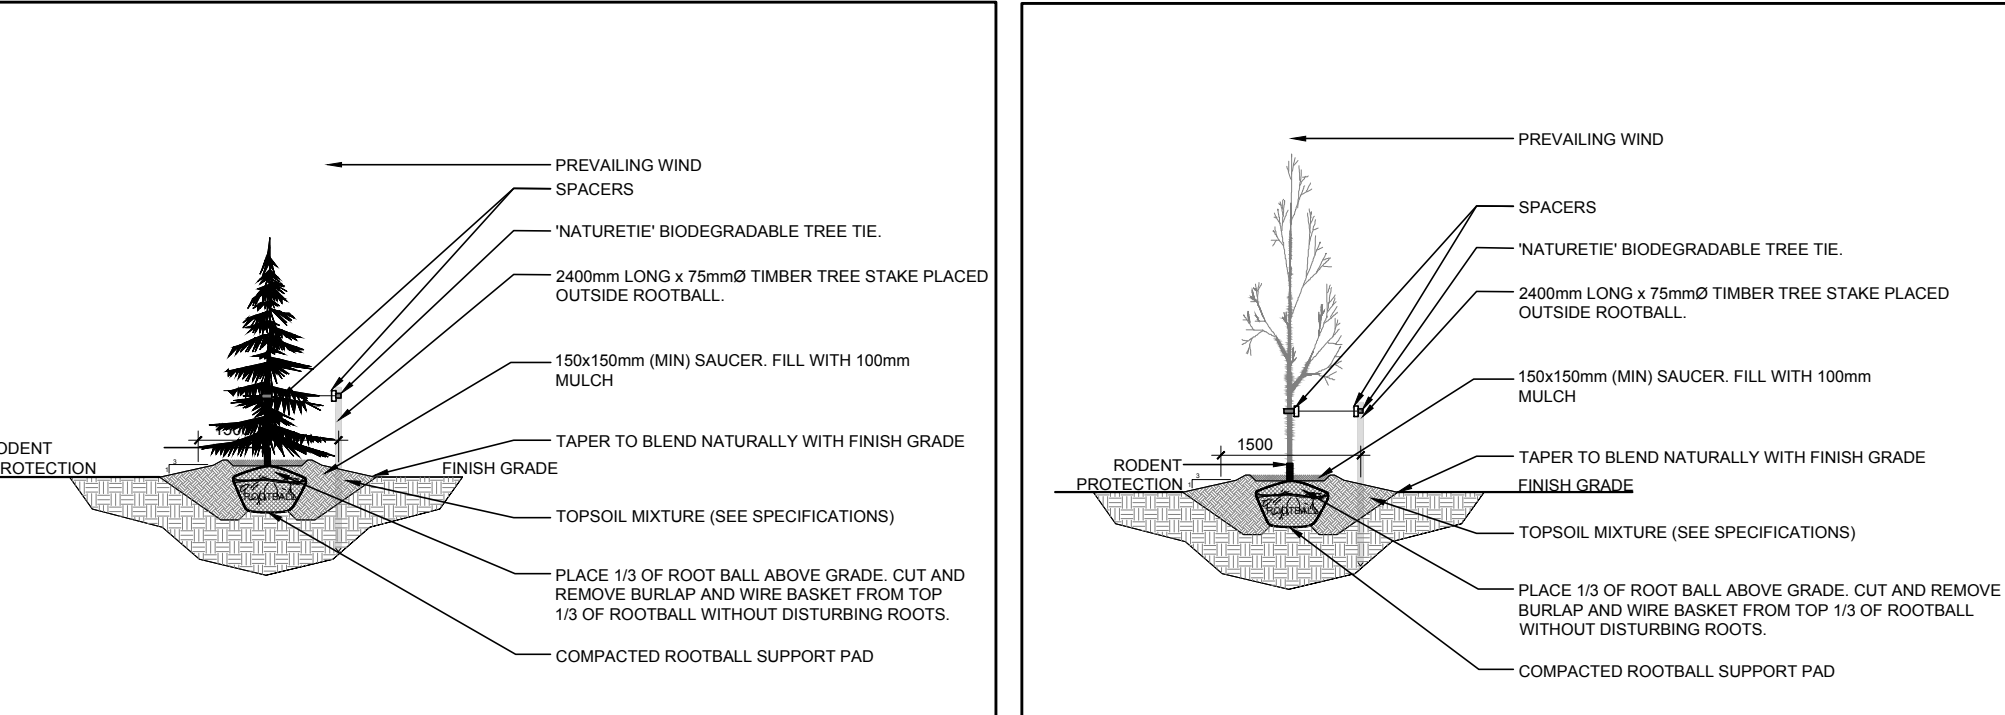

2 CONIFEROUS TREE PLANTING SCALE: NTS  
 3 DECIDUOUS TREE PLANTING SCALE: NTS

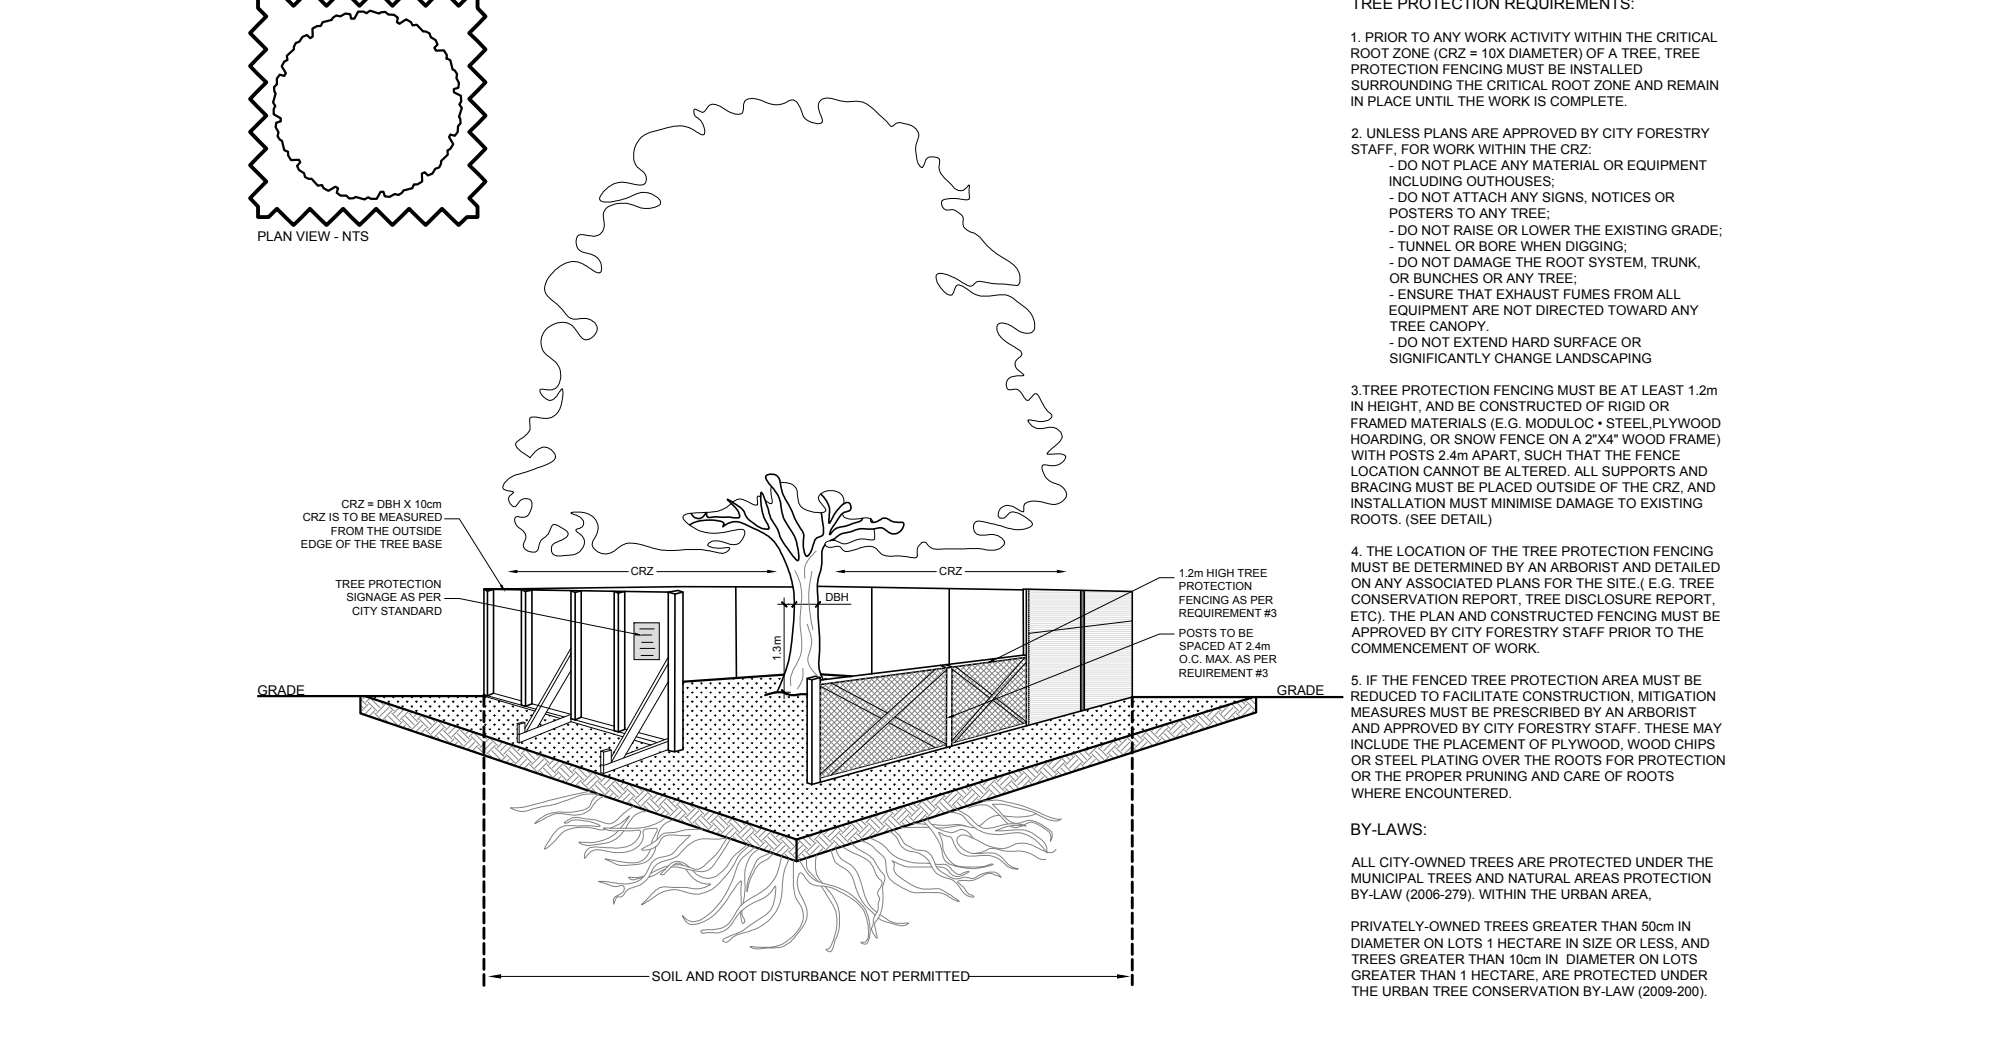

4 TREE PROTECTION FENCE SCALE: NTS

CLIENT: **Stoked Industries INC**  
 14 Knoll Terrace, Nepean ON  
 K2J 2K6

CONSULTANTS: **ES ARCHITECT**  
 11 Hogan Drive | Arrnprior | ON | K1Y 0H8  
 613.203.3760

CIVIL ENGINEERS: **D.B. GRAY ENGINEERING INC.**  
 700 LONG POINT CIRCLE,  
 OTTAWA ON K1T 4E9  
 Tel: (613) 425-8044

- #### LEGEND
- EXISTING TREE TO REMAIN
  - GROUP OF EXISTING TREES TO REMAIN
  - GROUP OF EXISTING TREES TO BE REMOVED
  - PROPOSED DECIDUOUS TREE
  - PROPOSED CONIFEROUS TREE
  - PROPOSED SEEDED GRASS AREA
  - EXISTING LANDSCAPE AREA TO REMAIN UNDISTURBED
  - PROPOSED TREE PROTECTION FENCE
  - PROPOSED COMPOSTED PINE MULCH

No.	Issue	Date	DR	CK
7	REVISED PER CITY COMMENTS	08/14/2023	ML	JL
6	ISSUED FOR SITE PLAN CONTROL	06/03/2023	ML	JL
5	SCALE CHANGED TO 1:250	07/19/2021	ML	JL
4	REVISED PER CITY COMMENTS	06/14/2021	ML	JL
3	ISSUED FOR COORDINATION	05/14/2021	ML	JL
2	ISSUED FOR DISCUSSION AND REVIEW	03/29/2021	ML	JL
1	ISSUED FOR DISCUSSION AND REVIEW	03/19/2021	ML	JL

**JAMES B. LENNOX & ASSOCIATES INC.**  
 LANDSCAPE ARCHITECTS  
 3332 CARLING AVE. OTTAWA, ONTARIO K2H 5A8  
 Tel. (613) 722-5168 Fax. (866) 343-3942

PROJECT: **STOKED INDUSTRIES OFFICE & WAREHOUSE**  
 2167 McGEE SIDE ROAD, OTTAWA ON

DRAWING: **TREE CONSERVATION REPORT & LANDSCAPE PLAN**

SCALE: AS SHOWN  
 START DATE: MARCH 2021  
 PROJECT NO.: 21MIS2167

PROJECT NORTH:

DRAWING NO.: **L.1**

PLOT SIZE ARCH-D

1 TREE CONSERVATION REPORT & LANDSCAPE PLAN SCALE 1:250

