

### LEGEND - LANDSCAPE

— — — PROPERTY LIMIT

TREE PROTECTION FENCE

PROPOSED CONCRETE

RIVERSTONE

PROPOSED PLANTING BED

SEED MIX A - SEE SEED MIX APPLICATION NOTE ON SHEET L6


SEED MIX B - SEE SEED MIX APPLICATION NOTE ON SHEET L6

> SEED MIX C - SEE SEED MIX APPLICATION NOTE ON SHEETS L2-L5

PROPOSED WET SHRUB MIX, REFER TO SHEET L6


PROPOSED DRY SHRUB MIX, REFER TO SHEET L6

PROPOSED DECIDUOUS TREE

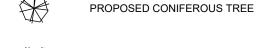

PROPOSED SHRUBS

EXISTING TREE TO REMAIN EXISTING HEDGEROW TO REMAIN

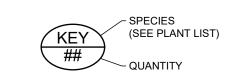

CITY DETAILS Related details from City of Ottawa Standard Tender Documents Volume No. 2 Standard Detail Drawings.

SC4. Typical Concrete Sidewalk in Boulevard SC5. Sidewalk Construction Joints

### NOVATECH DETAILS

Found on Sheet L7.

D1. Standard Deciduous Tree Planting D2. Standard Coniferous Tree Planting D3. Shrub and Perennial Planting

**FOR REVIEW ONLY** 

- D4. Tree Protection Fence D5. Bike Layout
- D6. Site furniture installation
- D7. Reforestation D8. Riverstone

## SEED MIX AND APPLICATION

For areas steeper than 3:1, Contractor to apply erosion control blanket. Erosion control blanket to be machine woven mats made from natural wood, coco or cotton fiber, or combination depending on manufacturer, with stitching between two photo-degradable natural organic fiber nettings. Submit products for approval by Consultant. OPSS 804 applies except as may be amended and extended herein.

In addition to the specified seed mixes, all applications are to include a nurse crop as noted.

NURSE CROP 40% Oats (Avena sativa)

45% Barley (Hordeum vulgare) 15% Canada Wild Rye (Elymus canadensis) Seeding Rate: 15kg/hectare

SEED MIX C CUSTOM NATIVE PARKING ISLAND SEED MIX BY DLF Seeding Rate: 25kg/hectare

### TREE PROTECTION

DETAIL SHEET # NOVATECH OR CITY Implement the following protection measures for retained trees both on site and on adjacent sites, prior to any work activity, including tree removal. Maintain tree protection fence in place Implement the following protection measures for retained trees, including tree removal. Maintain tree protection fence in place and in good condition for the duration of site works:

- 1. The Landscape Architect or Certified Arborist is to determine the location of the tree protection fencing and detail it on any associated plans for the site (e.g. tree conservation report, tree disclosure report, etc.).
- 2. Under the guidance of a Landscape Architect or Certified Arborist, erect a fence at the critical root zone (CRZ) of trees. Diameter at breast height (DBH) is the trunk diameter measured at 1.3m height on the tree trunk. The CRZ is calculated as DBH x 10. Refer to the Tree Protection Fence
- 3. Refer to the Tree Protection Plan for fence location. City Forestry Staff are to approve both the plan and the installed fence prior to work commencement.
- 4. Do not place any material or equipment within 2m of the CRZ of any tree, including outhouses. 5. Do not attach any signs, notices, or posters to any tree.
- 6. Do not disturb, raise, or lower the existing grade within the CRZ without approval. 7. Only tunnel or bore when digging within the CRZ of a tree.
- Hand work only where required within the CRZ; absolutely no machinery permitted. 8. Do not damage the root system, trunk, or branches, or any
- 9. Do not extend hard surface or significantly change
- landscaping. 10. Ensure that exhaust fumes from all equipment are directed away from any tree canopy.
- 11. When trees marked for removal overlap with the CRZ of trees marked for preservation: cut roots at the edge of the CRZ and grind down stumps after tree removals, do not pull out stumps. Ensure there is not root pulling or disturbance of the
- ground within the CRZ. 12. Prior to work taking place, notify and consult the Landscape Architect and City Forestry Staff if roots must be cut. Roots 20mm or larger should be cut at right angles with clean, sharp horticultural tools without tearing, crushing, or pulling. Refer to
- City of Ottawa Specification S.P. F-8011 Tree Protection, Excavation of Root Zone. 13. If damaged or objectionable branches are observed, consult
- the Landscape Architect, before any work is conducted. Do not prune leaders. Do not prune more than 1/4 of crown. 14. Set up a water and fertilizing program, if trees are being affected by site works, to the satisfaction of the Landscape
- 15. The Landscape Architect is to prescribe mitigation measures construction. Measures may include the placement of
- plywood, wood chips, or steel plating over the roots for protection. City Forestry Staff are to approve said measures prior to fence movement.
- 16. City of Ottawa By-law: Protects municipal trees and municipal natural areas in the City of Ottawa and trees on private property in the urban area of the City of Ottawa (2020-340).

### PLANTING

- 1. Plant material to be No. 1 Grade and is to comply with
- Canadian Standards for Nursery Stock (latest edition) published by the Canadian Nursery Landscape Association. 2. Use structurally sound plant material with strong fibrous root system free of disease, defects, and injuries. Use trees with straight trunks, well and characteristically branched for species. Obtain approval from consultant of plant material at source prior to digging. All trees and shrubs to be container grown, potted, W/B or B/B, as indicated on Plant List. Bare
- root plants are only acceptable for certain species and as approved by the Landscape Architect. 3. Plant material substitutions are not be permitted without the written approval from the Consultant, with 48 hours notice,
- prior to shipping plant material. 4. Plant locations are schematic / approximate only. Contractor is to stake out locations on site for approval by the Landscape Architect prior to installation.
- 5. The illustrated number of plants shown in the Planting Plan supersedes the estimated number in the Plant List. Contractor to report any discrepancies to the Landscape Architect prior to installation. Contractor will assume full
- responsibility if the Landscape Architect is not notified. Ensure trees are thoroughly watered following planting. Monitor material and ensure adequate moisture until acceptance.
- 7. In heavy clay or poorly drained soils, set root ball with root collar 75-100mm higher than finished grade.
- 8. Approved topsoil depths are as follows: a. Plant Beds - **450mm** continuous depth. Applies to shrubs, perennials, vines, and groundcovers.
- b. Sod/ Seed Areas 100mm depth. Sod to be No. 1 Kentucky Bluegrass Sod grown from minimum mixture of 3 Kentucky Bluegrass cultivars. Quality and source are to comply with Canadian Standards for
- Nursery Stock, Section 17, (latest edition) published by the Canadian Nursery Landscape Nursery Landscape Association.
- 10. Apply the following mineral fertilizer unless soil tests show other requirements:
- a. Plant Beds (8-32-16), i.e. 8% Nitrogen, 32% Phosphorus, 16% Potash per manufacturer specifications. b. Sod Areas - (8-32-16), i.e. 8% Nitrogen, 32% Phosphorus, 16% Potash at a rate of 350kg/ha.
- 11. Where applicable, for any plant areas with a mix of species/ cultivars notes, Contractor is to cluster like plants in groups of 3-5 and evenly distribute these in the noted area.

THE POSITION OF ALL POLE LINES, CONDUITS, WATERMAINS, SEWERS AND OTHER UNDERGROUND AND OVERGROUND UTILITIES AND STRUCTURES IS NOT NECESSARILY SHOWN ON THE CONTRACT DRAWINGS, AND WHERE SHOWN. THE ACCURACY OF THE POSITION OF SUCH UTILITIES AND STRUCTURES IS NOT GUARANTEED. BEFORE STARTING WORK, DETERMINE THE EXACT LOCATION OF ALL SUCH UTILITIES AND STRUCTURES AND ASSUME ALL LIABILITY FOR

DAMAGE TO THEM.

Owner: Rosefellow c/o Julian Nini 750 Marcel-Laurin, Suite 210 Saint-Laurent, QC H4M 2M4 Phone: (514) 532-1080

NOT FOR CONSTRUCTION

				SCALE	
					KW
					CHECKED
				1:400	RGJ
4.	ISSUED FOR SITE PLAN APPROVAL	AUG 4/23	RGJ		DRAWN
3.	REVISED PER CITY COMMENTS	MAY 31/23	RGJ		CHECKED
2.	REVISED PER CITY COMMENTS	MAR 30/23	RGJ	1:400 0 4 8 12 16	KW
1.	ISSUED FOR CITY OF OTTAWA REVIEW	DEC 16/22	RGJ		APPROVED
No.	REVISION	DATE	BY		RGJ





Facsimile

(613) 254-9643

(613) 254-5867


www.novatech-eng.com

CITY of OTTAWA 105 HUNTMAR DRIVE - WAREHOUSE DEVELOPMENT

DRAWING NAME LANDSCAPE PLAN

LOCATION

122151 REV # 4 122151-L2

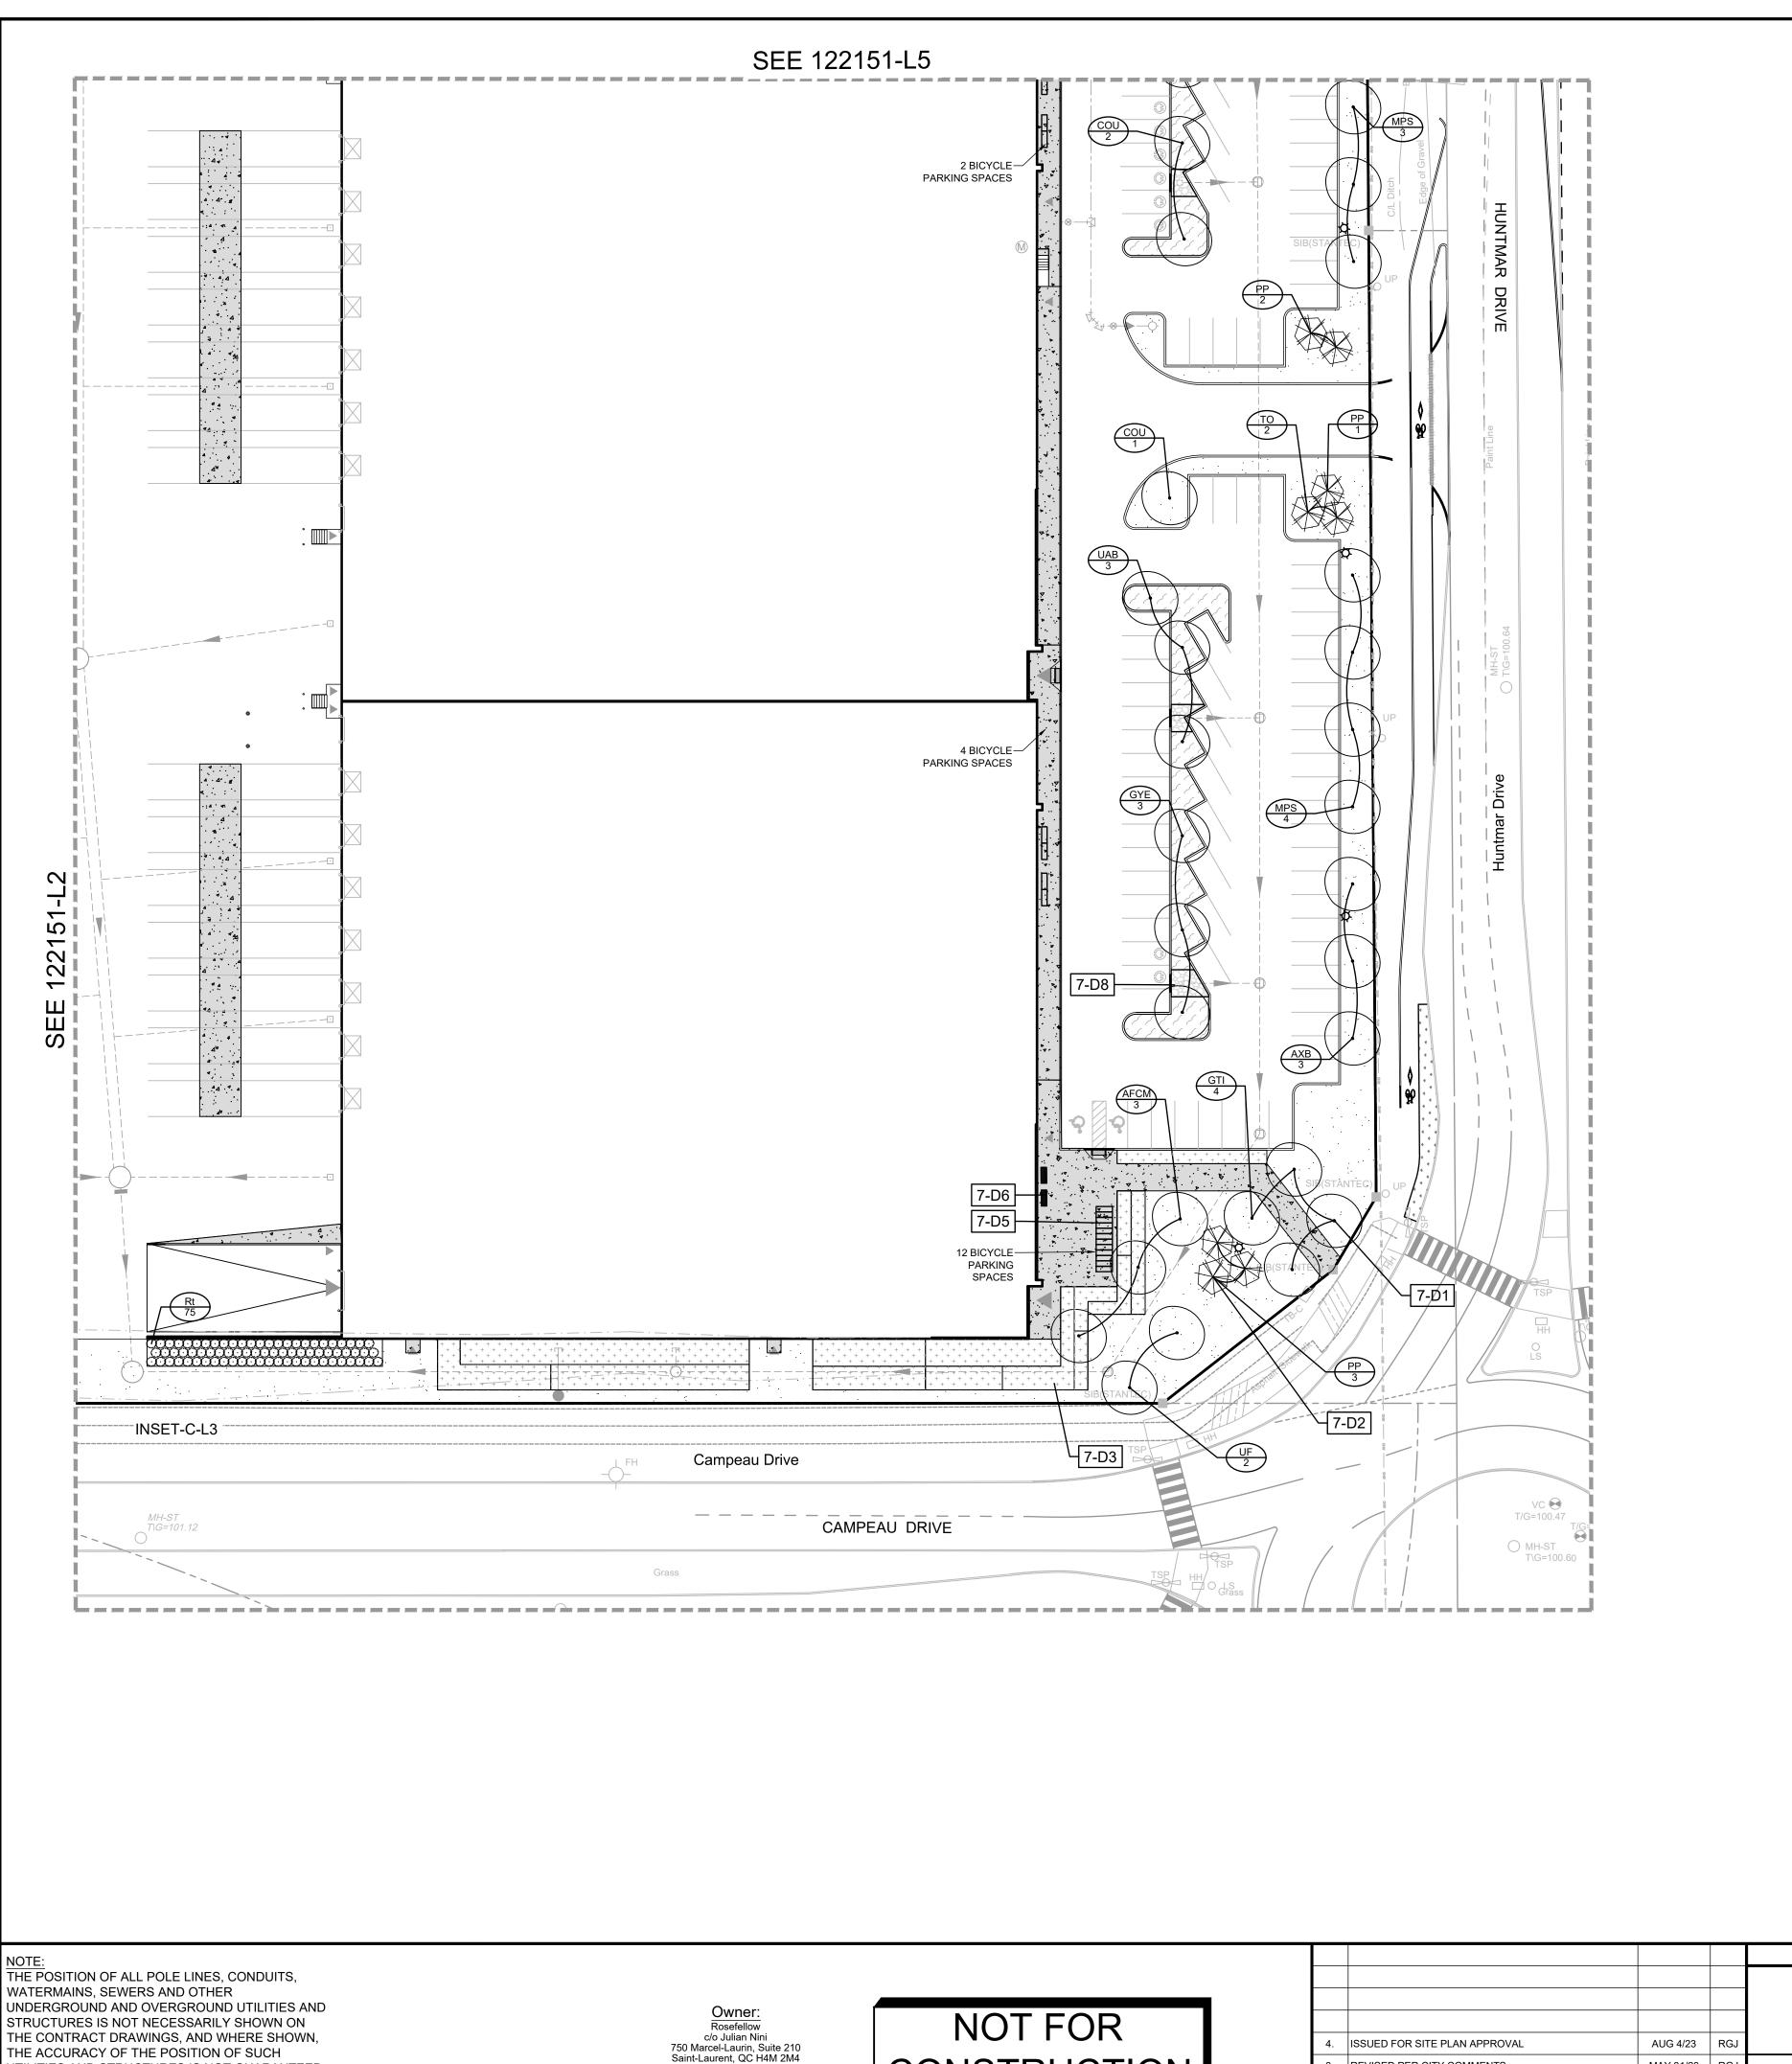

Phone: (514) 532-1080


THE ACCURACY OF THE POSITION OF SUCH

LOCATION OF ALL SUCH UTILITIES AND

DAMAGE TO THEM.

UTILITIES AND STRUCTURES IS NOT GUARANTEED. BEFORE STARTING WORK, DETERMINE THE EXACT

STRUCTURES AND ASSUME ALL LIABILITY FOR

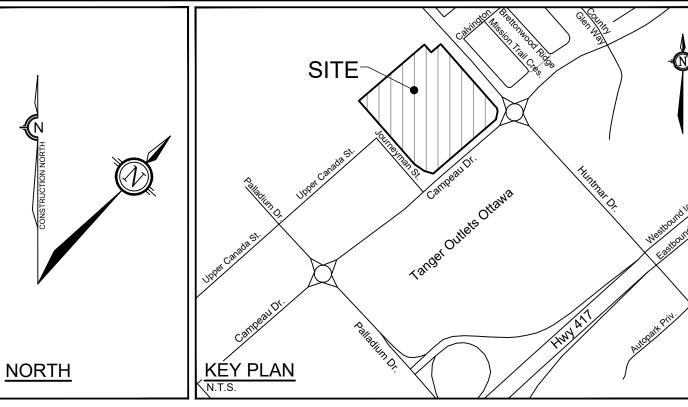

TREE PROTECTION

tree disclosure report, etc.).

in good condition for the duration of site works:

fence prior to work commencement.

of any tree, including outhouses.

CRZ without approval.

machinery permitted.

away from any tree canopy.

ground within the CRZ.

Excavation of Root Zone.

prior to fence movement.

PLANTING

landscaping.

Implement the following protection measures for retained trees,

including tree removal. Maintain tree protection fence in place and

1. The Landscape Architect or Certified Arborist is to determine the location of the tree protection fencing and detail it on any associated plans for the site (e.g. tree conservation report,

Arborist, erect a fence at the critical root zone (CRZ) of trees. Diameter at breast height (DBH) is the trunk diameter measured at 1.3m height on the tree trunk. The CRZ is

calculated as DBH x 10. Refer to the Tree Protection Fence

2. Under the guidance of a Landscape Architect or Certified

3. Refer to the Tree Protection Plan for fence location. City Forestry Staff are to approve both the plan and the installed

5. Do not attach any signs, notices, or posters to any tree. 6. Do not disturb, raise, or lower the existing grade within the

7. Only tunnel or bore when digging within the CRZ of a tree.

8. Do not damage the root system, trunk, or branches, or any

10. Ensure that exhaust fumes from all equipment are directed

11. When trees marked for removal overlap with the CRZ of trees

grind down stumps after tree removals, do not pull out stumps. Ensure there is not root pulling or disturbance of the

12. Prior to work taking place, notify and consult the Landscape Architect and City Forestry Staff if roots must be cut. Roots 20mm or larger should be cut at right angles with clean, sharp

City of Ottawa Specification S.P. F-8011 Tree Protection,

13. If damaged or objectionable branches are observed, consult

the Landscape Architect, before any work is conducted. Do

not prune leaders. Do not prune more than 1/4 of crown. 14. Set up a water and fertilizing program, if trees are being affected by site works, to the satisfaction of the Landscape

15. The Landscape Architect is to prescribe mitigation measures

construction. Measures may include the placement of

plywood, wood chips, or steel plating over the roots for protection. City Forestry Staff are to approve said measures

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property in the urban area of the City of Ottawa (2020-340).

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4. Plant locations are schematic / approximate only. **Contractor** is to stake out locations on site for approval by the

5. The illustrated number of plants shown in the Planting Plan

supersedes the estimated number in the Plant List.

Contractor to report any discrepancies to the Landscape

Architect prior to installation. Contractor will assume full

responsibility if the Landscape Architect is not notified. 6. Ensure trees are thoroughly watered following planting.

Monitor material and ensure adequate moisture until

Sod to be No. 1 Kentucky Bluegrass Sod grown from

Canadian Nursery Landscape Nursery Landscape

10. Apply the following mineral fertilizer unless soil tests show

a. Plant Beds - (8-32-16), i.e. 8% Nitrogen, 32%

b. Sod Areas - (8-32-16), i.e. 8% Nitrogen, 32%

Phosphorus, 16% Potash at a rate of 350kg/ha. 11. Where applicable, for any plant areas with a mix of species/

3-5 and evenly distribute these in the noted area.

Phosphorus, 16% Potash per manufacturer specifications.

cultivars notes, Contractor is to cluster like plants in groups of

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a. Plant Beds - **450mm** continuous depth. Applies to

minimum mixture of 3 Kentucky Bluegrass cultivars. Quality and source are to comply with Canadian Standards for

Nursery Stock, Section 17, (latest edition) published by the

approved by the Landscape Architect.

Landscape Architect prior to installation.

collar 75-100mm higher than finished grade.

shrubs, perennials, vines, and groundcovers.

b. Sod/ Seed Areas - 100mm depth.

Approved topsoil depths are as follows:

prior to shipping plant material.

acceptance.

Association

other requirements:

natural areas in the City of Ottawa and trees on private

1. Plant material to be No. 1 Grade and is to comply with Canadian Standards for Nursery Stock (latest edition)

marked for preservation: cut roots at the edge of the CRZ and

horticultural tools without tearing, crushing, or pulling. Refer to

9. Do not extend hard surface or significantly change

Hand work only where required within the CRZ; absolutely no

4. Do not place any material or equipment within 2m of the CRZ

### LEGEND - LANDSCAPE

DETAIL SHEET # NOVATECH OR CITY Implement the following protection measures for retained trees both on site and on adjacent sites, prior to any work activity, including tree removal. Maintain tree protection fence in place

— — — PROPERTY LIMIT

TREE PROTECTION FENCE

PROPOSED CONCRETE

RIVERSTONE

PROPOSED PLANTING BED

SEED MIX A - SEE SEED MIX APPLICATION NOTE ON SHEET L6

SEED MIX B - SEE SEED MIX APPLICATION NOTE ON SHEET L6

SEED MIX C - SEE SEED MIX APPLICATION NOTE ON SHEETS L2-L5

PROPOSED WET SHRUB MIX, REFER TO SHEET L6

PROPOSED DRY SHRUB MIX, REFER TO SHEET L6

PROPOSED DECIDUOUS TREE

PROPOSED CONIFEROUS TREE

PROPOSED SHRUBS

EXISTING TREE TO REMAIN EXISTING HEDGEROW TO REMAIN

(SEE PLANT LIST)

- SPECIES

SEED MIX AND APPLICATION

extended herein.

include a nurse crop as noted.

40% Oats (Avena sativa)

45% Barley (Hordeum vulgare)

Seeding Rate: 15kg/hectare

Seeding Rate: 25kg/hectare

NURSE CROP

SEED MIX C

Facsimile

For areas steeper than 3:1, Contractor to apply erosion control

on manufacturer, with stitching between two photo-degradable

natural organic fiber nettings. Submit products for approval by

In addition to the specified seed mixes, all applications are to

CUSTOM NATIVE PARKING ISLAND SEED MIX BY DLF

15% Canada Wild Rye (Elymus canadensis)

Consultant. OPSS 804 applies except as may be amended and

blanket. Erosion control blanket to be machine woven mats made

from natural wood, coco or cotton fiber, or combination depending

CITY DETAILS Related details from City of Ottawa Standard Tender Documents Volume No. 2 Standard Detail Drawings.

SC4. Typical Concrete Sidewalk in Boulevard Sidewalk Construction Joints

### NOVATECH DETAILS

Found on Sheet L7.

- D1. Standard Deciduous Tree Planting D2. Standard Coniferous Tree Planting D3. Shrub and Perennial Planting
- D4. Tree Protection Fence D5. Bike Layout
- D6. Site furniture installation
- D7. Reforestation D8. Riverstone

Deciduous Shrubs

### PARKING LOT - PLANT LIST

Rt 75 Rhus typhina Staghorn Sumac FOR REVIEW ONLY

ngineers, Planners & Landscape Architect Suite 200, 240 Michael Cowpland Drive Ottawa, Ontario, Canada K2M 1P6

(613) 254-9643

(613) 254-5867

www.novatech-eng.com

LOCATION CITY of OTTAWA 105 HUNTMAR DRIVE - WAREHOUSE DEVELOPMENT

DRAWING NAME LANDSCAPE PLAN

60cm Ht | PT | 100cm O.C


122151 REV # 4


SCALE 1:400 ISSUED FOR SITE PLAN APPROVAL AUG 4/23 CONSTRUCTION REVISED PER CITY COMMENTS MAY 31/23 REVISED PER CITY COMMENTS MAR 30/23 ISSUED FOR CITY OF OTTAWA REVIEW DEC 16/22

DATE

REVISION

122151-L3 #18906

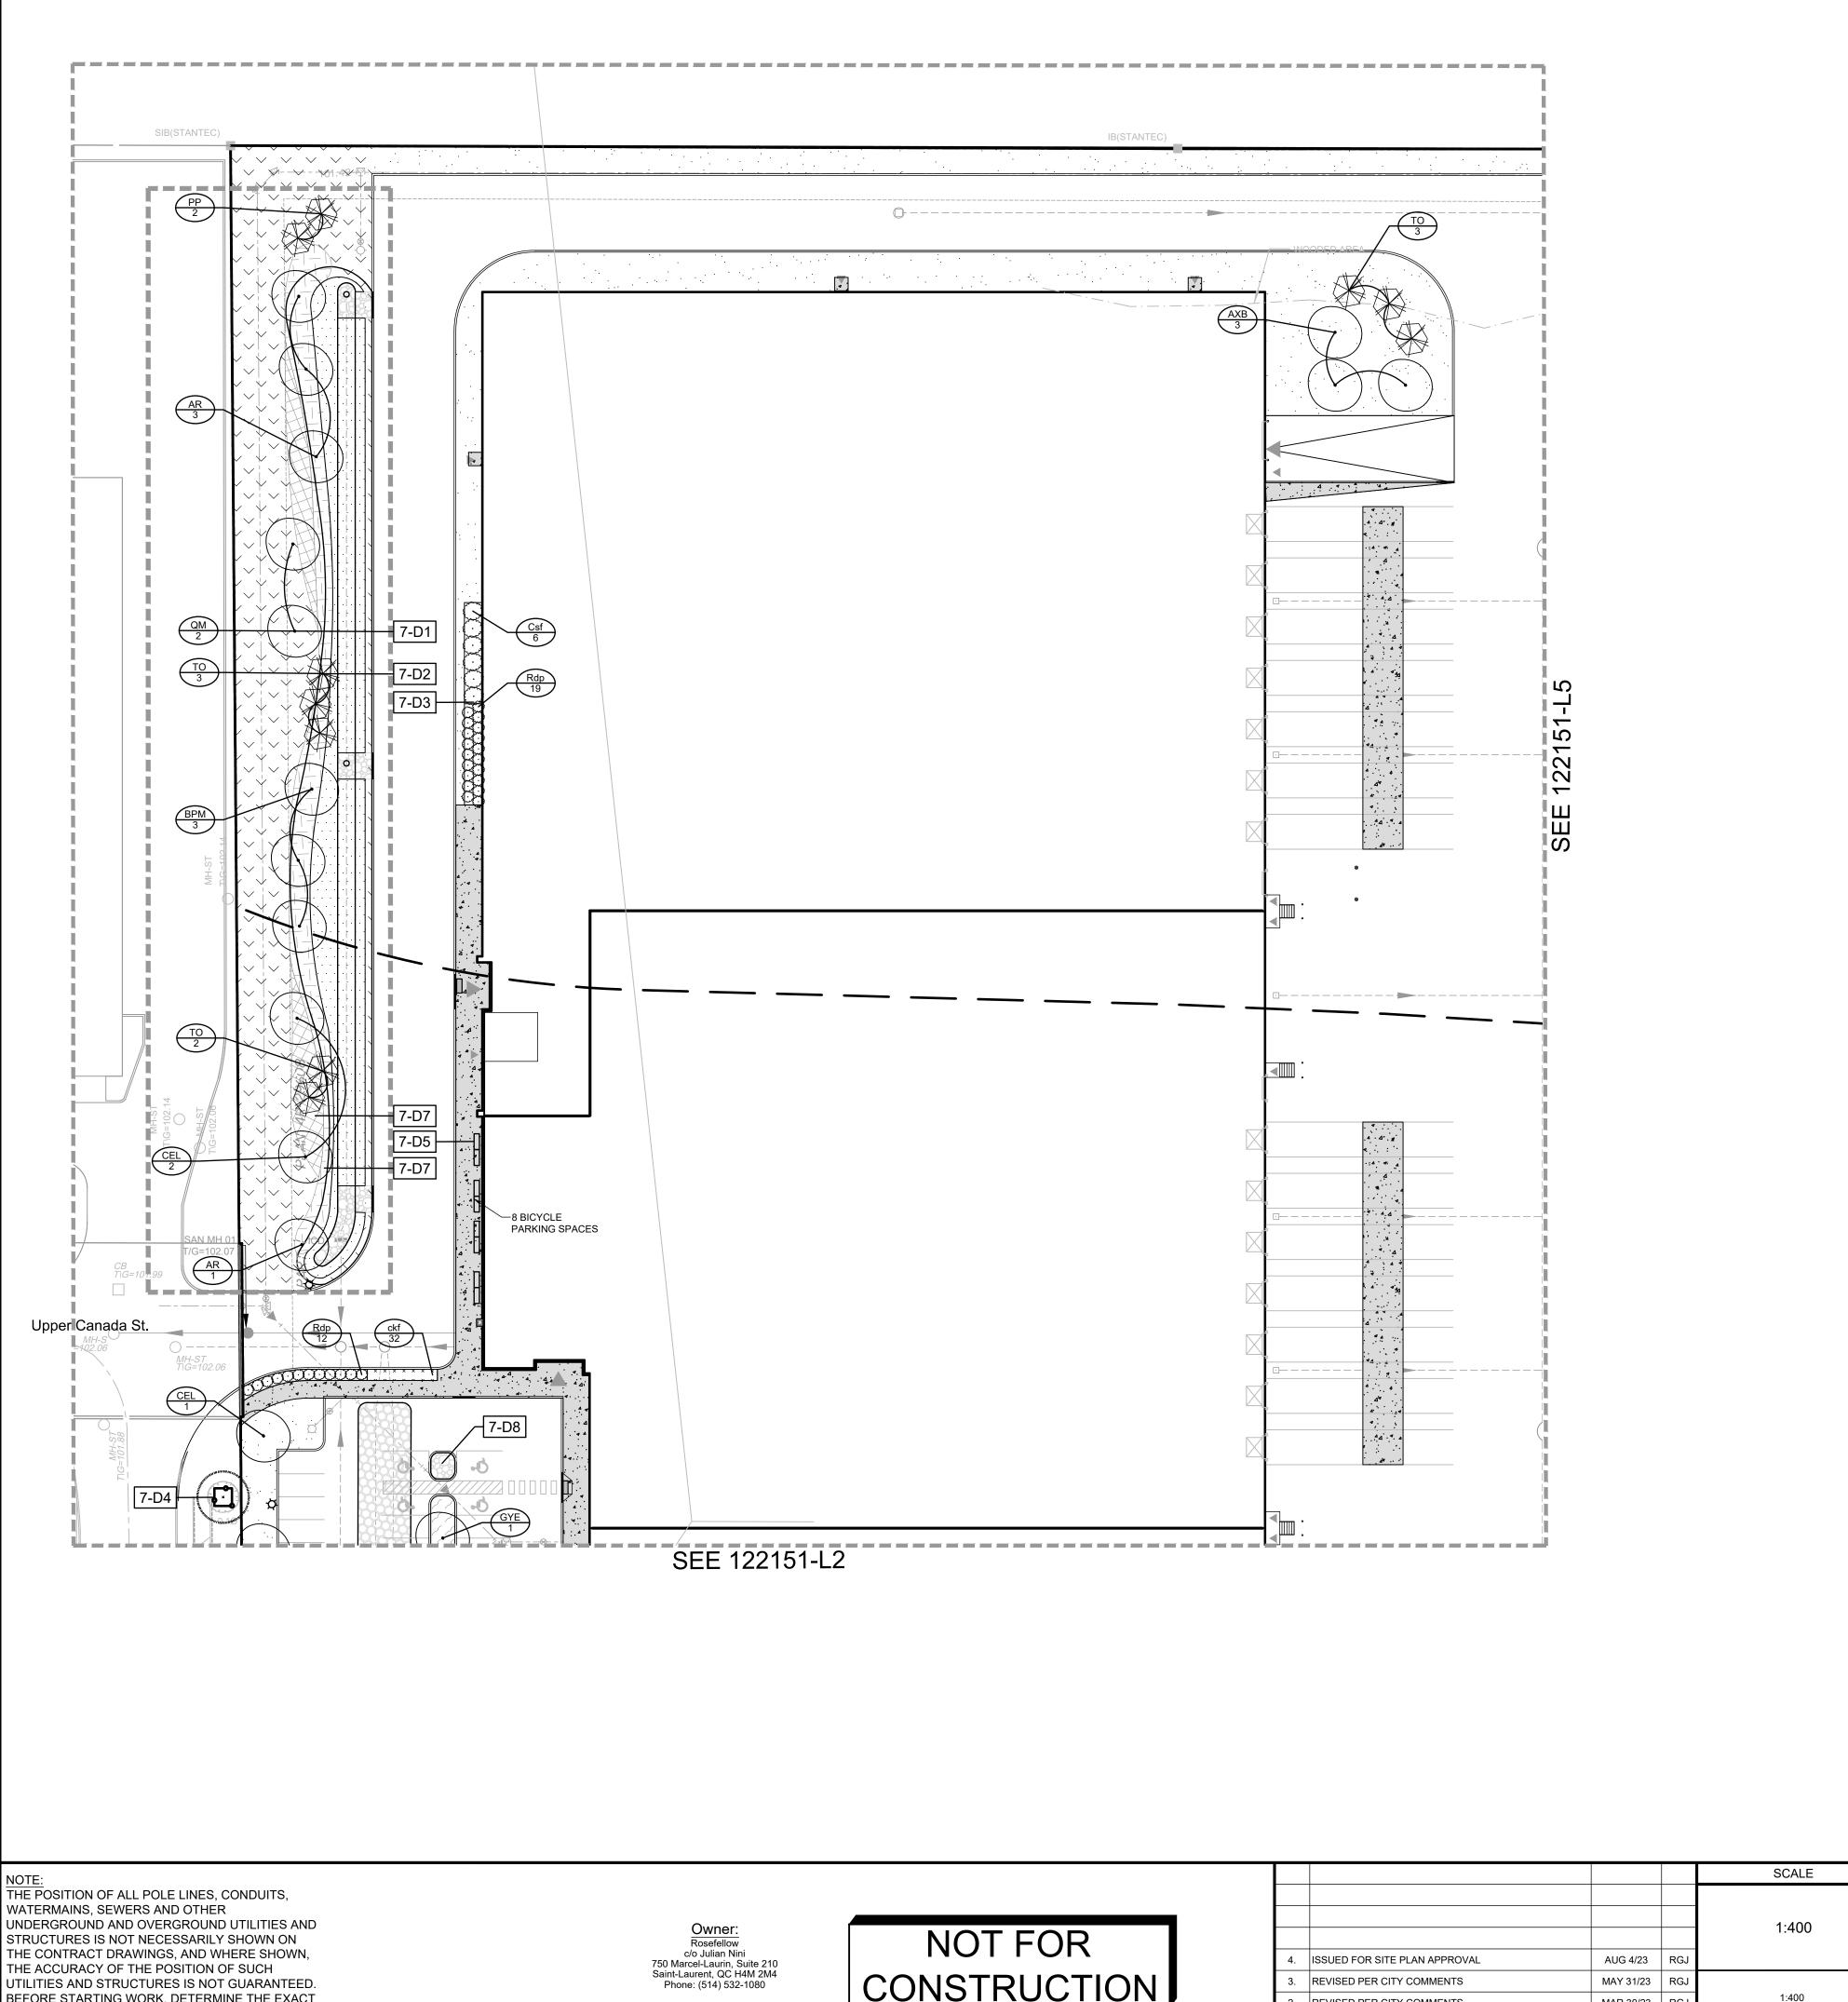

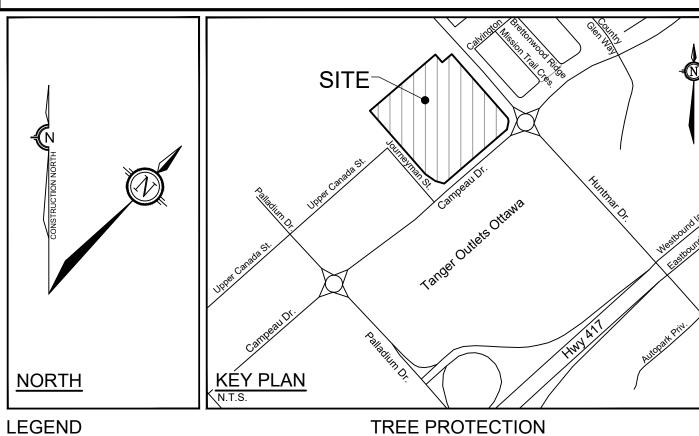

Implement the following protection measures for retained trees,

in good condition for the duration of site works:

fence prior to work commencement.

of any tree, including outhouses.

CRZ without approval.

machinery permitted.

away from any tree canopy.

ground within the CRZ.

Excavation of Root Zone.

prior to fence movement.

PLANTING

landscaping.

tree disclosure report, etc.).

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City of Ottawa Specification S.P. F-8011 Tree Protection,

13. If damaged or objectionable branches are observed, consult

the Landscape Architect, before any work is conducted. Do

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Ensure trees are thoroughly watered following planting.

Monitor material and ensure adequate moisture until

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and source are to comply with Canadian Standards for

collar 75-100mm higher than finished grade.

shrubs, perennials, vines, and groundcovers. b. Sod/ Seed Areas - 100mm depth.

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Canadian Nursery Landscape Nursery Landscape

10. Apply the following mineral fertilizer unless soil tests show

8. Approved topsoil depths are as follows:

supersedes the estimated number in the Plant List. Contractor to report any discrepancies to the Landscape

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prior to shipping plant material.

marked for preservation: cut roots at the edge of the CRZ and grind down stumps after tree removals, do not pull out stumps. Ensure there is not root pulling or disturbance of the

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PROPOSED CONCRETE

RIVERSTONE

PROPOSED PLANTING BED

SEED MIX A - SEE SEED MIX APPLICATION NOTE ON SHEET L6

SEED MIX B - SEE SEED MIX APPLICATION NOTE ON SHEET L6

SEED MIX C - SEE SEED MIX APPLICATION NOTE ON SHEETS L2-L5

REFER TO SHEET L6 PROPOSED DRY SHRUB MIX, REFER TO SHEET L6


PROPOSED DECIDUOUS TREE

PROPOSED WET SHRUB MIX,

PROPOSED CONIFEROUS TREE

PROPOSED SHRUBS

EXISTING TREE TO REMAIN EXISTING HEDGEROW TO REMAIN

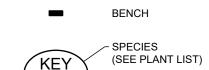

### CITY DETAILS

Related details from City of Ottawa Standard Tender Documents Volume No. 2 Standard Detail Drawings.

SC4. Typical Concrete Sidewalk in Boulevard SC5. Sidewalk Construction Joints

### NOVATECH DETAILS

Found on Sheet L7.

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- D3. Shrub and Perennial Planting D4. Tree Protection Fence D5. Bike Layout D6. Site furniture installation
- D7. Reforestation D8. Riverstone

### PARKING LOT - PLANT LIST

Deciduous Shrubs Csf 6 Cornus sericea 'Flaviramea' Yellow Twig Dogwood Rdp 31 Rosa 'Dwarf Pavement' Ornamental Grasses ckf | 32 | Calamagrostis acutiflora 'Karl Foerster' Karl Foerster Feather Reed Grass

SEED MIX AND APPLICATION

For areas steeper than 3:1, Contractor to apply erosion control blanket. Erosion control blanket to be machine woven mats made from natural wood, coco or cotton fiber, or combination depending on manufacturer, with stitching between two photo-degradable natural organic fiber nettings. Submit products for approval by Consultant. OPSS 804 applies except as may be amended and extended herein.

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NURSE CROP 40% Oats (Avena sativa) 45% Barley (Hordeum vulgare) 15% Canada Wild Rye (Elymus canadensis) Seeding Rate: 15kg/hectare

SEED MIX C CUSTOM NATIVE PARKING ISLAND SEED MIX BY DLF Seeding Rate: 25kg/hectare

(613) 254-9643

(613) 254-5867

www.novatech-eng.com

a. Plant Beds - (8-32-16), i.e. 8% Nitrogen, 32% Phosphorus, 16% Potash per manufacturer specifications. b. Sod Areas - (8-32-16), i.e. 8% Nitrogen, 32%

Association.

other requirements:

acceptance.

Phosphorus, 16% Potash at a rate of 350kg/ha. 60cm Ht PT 200cm O. Where applicable, for any plant areas with a mix of species/ cultivars notes, Contractor is to cluster like plants in groups of 60cm Ht | PT | 120cm O. 3-5 and evenly distribute these in the noted area.


WATERMAINS, SEWERS AND OTHER UNDERGROUND AND OVERGROUND UTILITIES AND STRUCTURES IS NOT NECESSARILY SHOWN ON

BEFORE STARTING WORK, DETERMINE THE EXACT LOCATION OF ALL SUCH UTILITIES AND STRUCTURES AND ASSUME ALL LIABILITY FOR

DAMAGE TO THEM.

CONSTRUCTION

				3 G/ KLL	i
					KW
					CHECKED
				1:400	RGJ
4.	ISSUED FOR SITE PLAN APPROVAL	AUG 4/23	RGJ		DRAWN TB
3.	REVISED PER CITY COMMENTS	MAY 31/23	RGJ		CHECKED
2.	REVISED PER CITY COMMENTS	MAR 30/23	RGJ	1:400 0 4 8 12 16	KW
1.	ISSUED FOR CITY OF OTTAWA REVIEW	DEC 16/22	RGJ	0 4 3 12 10	APPROVED
No.	REVISION	DATE	BY		RG.I

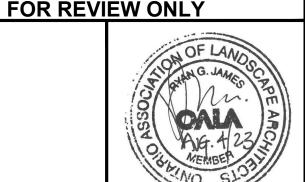

# ngineers, Planners & Landscape Architect Suite 200, 240 Michael Cowpland Drive Ottawa, Ontario, Canada K2M 1P6

Facsimile


DRAWING NAME

1g PT 60cm O.C

LOCATION

CITY of OTTAWA 105 HUNTMAR DRIVE - WAREHOUSE DEVELOPMENT

LANDSCAPE PLAN

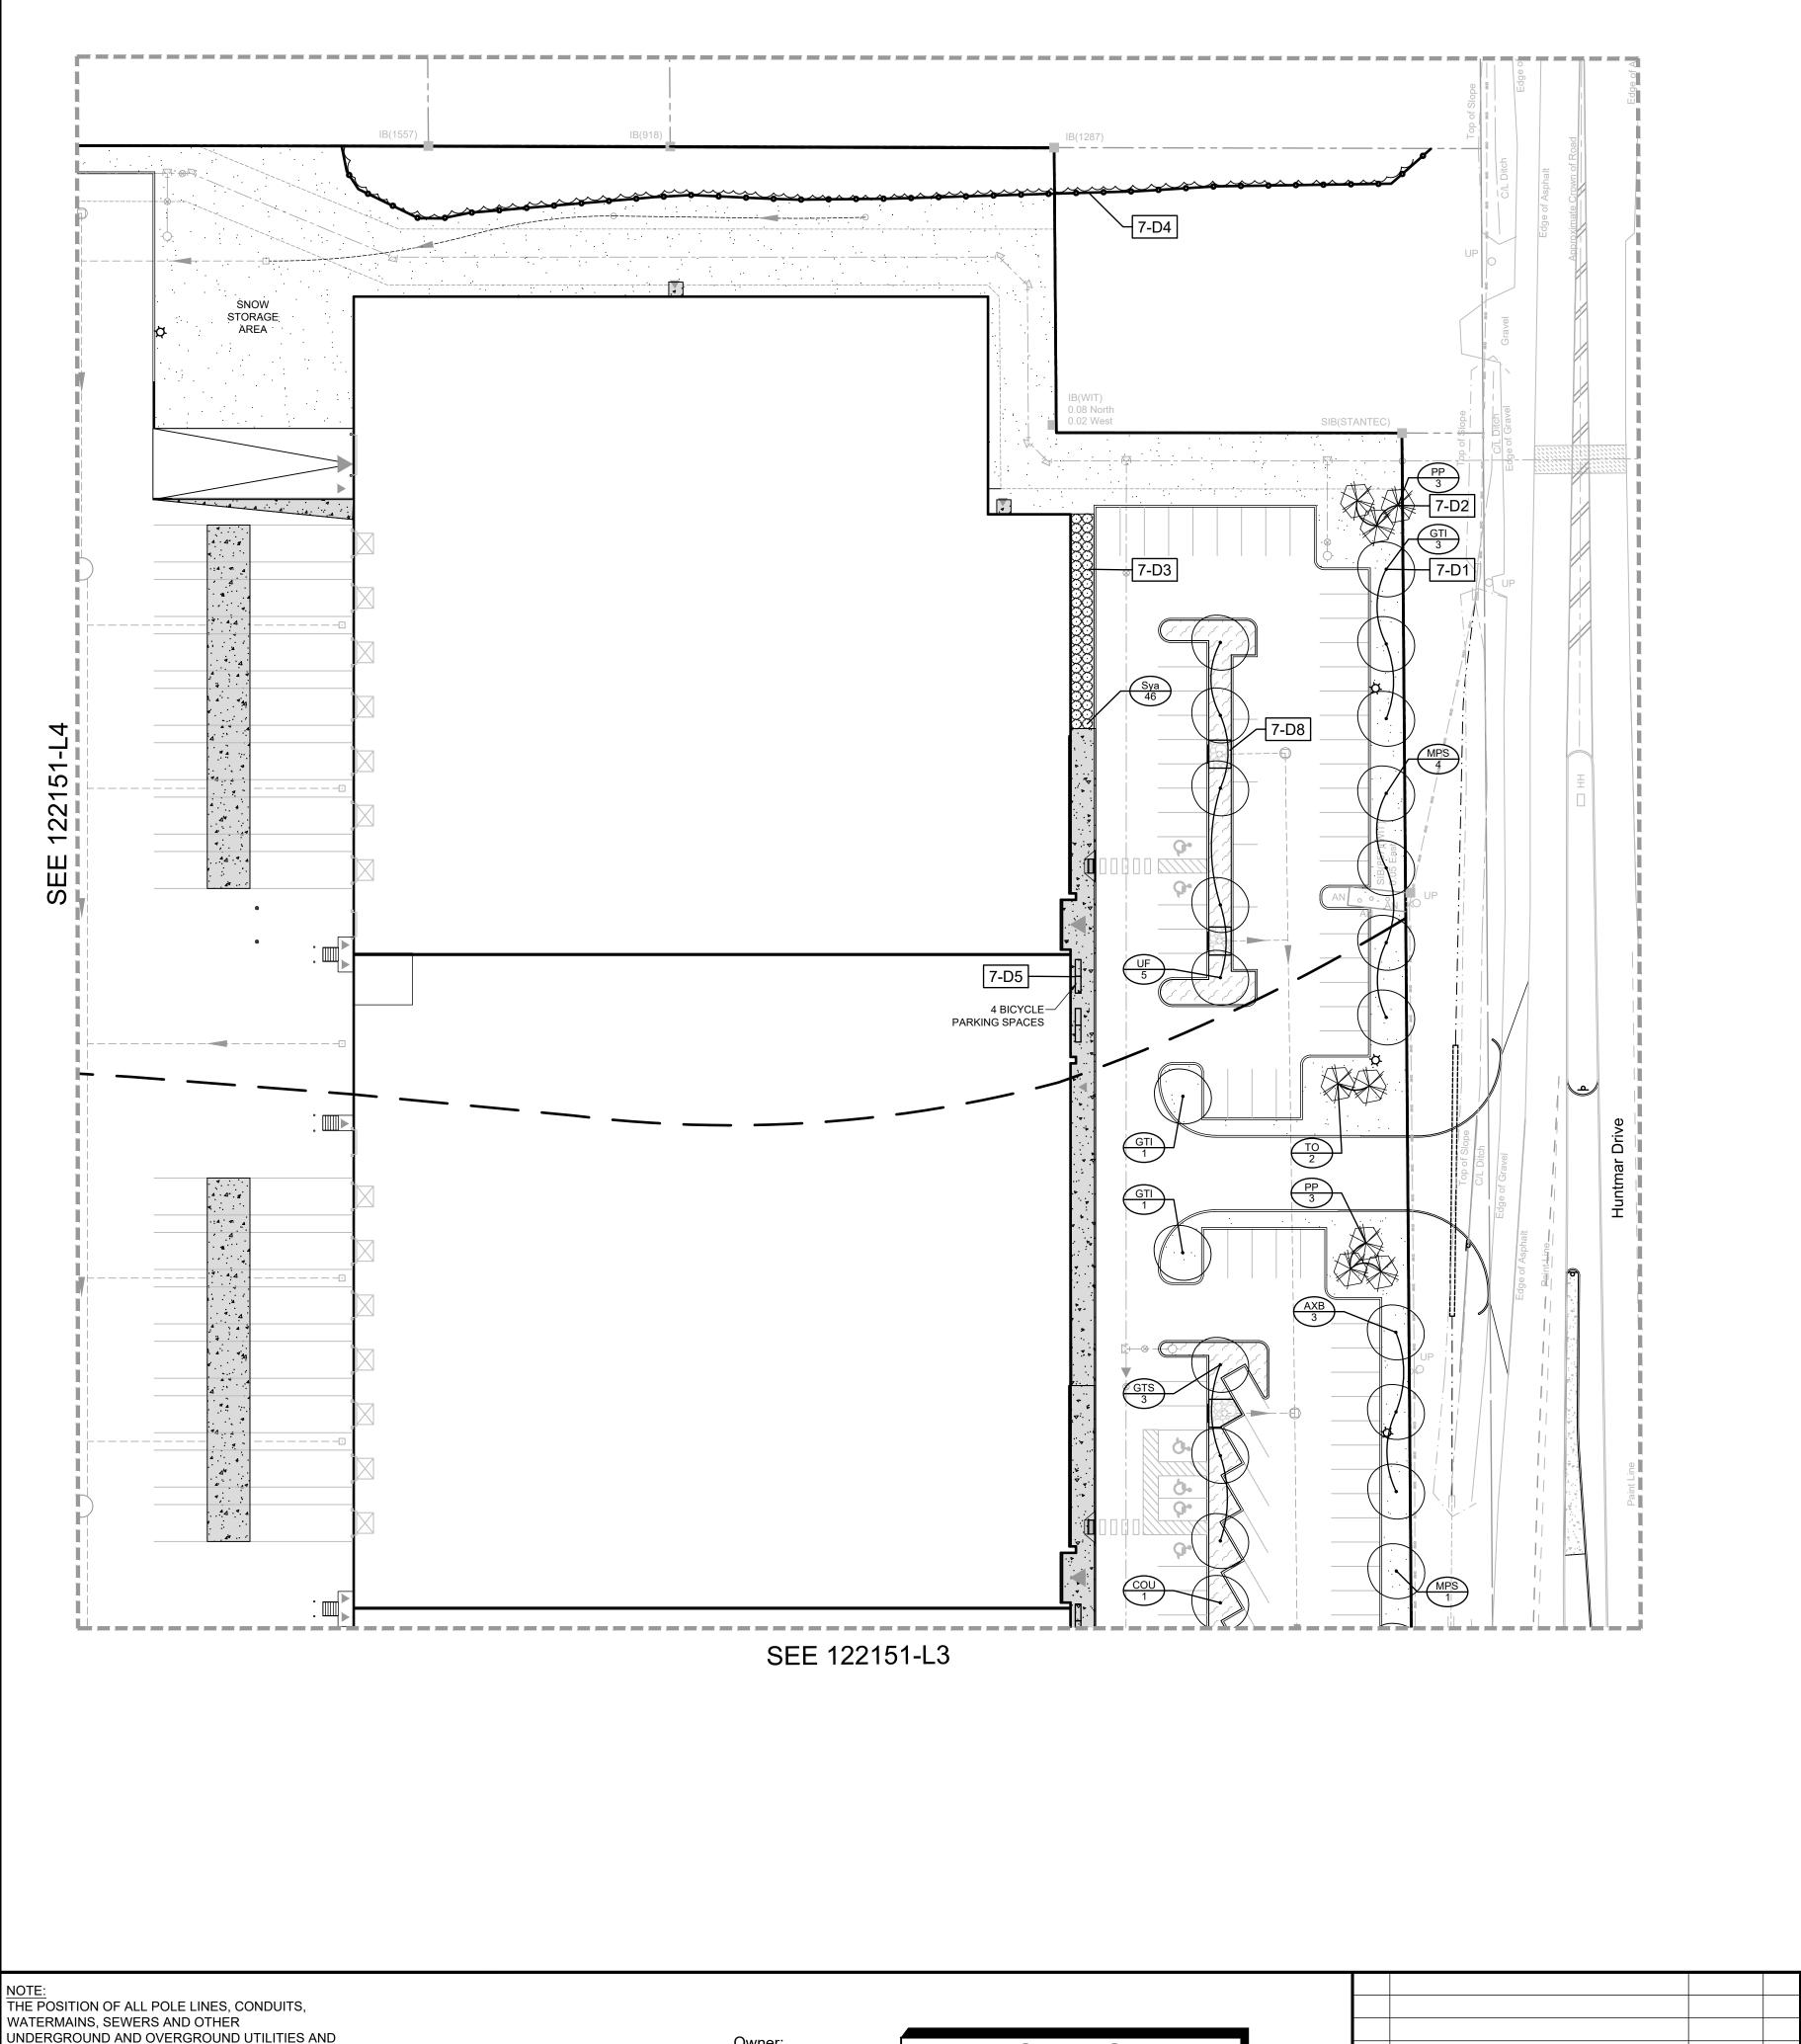

c/o Julian Nini

750 Marcel-Laurin, Suite 210 Saint-Laurent, QC H4M 2M4 Phone: (514) 532-1080

STRUCTURES IS NOT NECESSARILY SHOWN ON

THE ACCURACY OF THE POSITION OF SUCH


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not prune leaders. Do not prune more than 1/4 of crown. 14. Set up a water and fertilizing program, if trees are being affected by site works, to the satisfaction of the Landscape

15. The Landscape Architect is to prescribe mitigation measures

construction. Measures may include the placement of

plywood, wood chips, or steel plating over the roots for protection. City Forestry Staff are to approve said measures

16. City of Ottawa By-law: Protects municipal trees and municipal

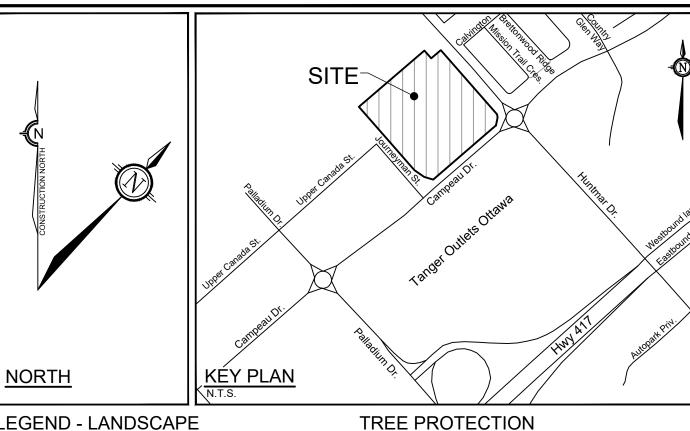natural areas in the City of Ottawa and trees on private property in the urban area of the City of Ottawa (2020-340).

2. Use structurally sound plant material with strong fibrous root system free of disease, defects, and injuries. Use trees with straight trunks, well and characteristically branched for species. Obtain approval from consultant of plant material at source prior to digging. All trees and shrubs to be container

grown, potted, W/B or B/B, as indicated on Plant List. Bare

root plants are only acceptable for certain species and as

3. Plant material substitutions are not be permitted without the written approval from the Consultant, with 48 hours notice,

4. Plant locations are schematic / approximate only. **Contractor** is to stake out locations on site for approval by the

Architect prior to installation. Contractor will assume full responsibility if the Landscape Architect is not notified.

In heavy clay or poorly drained soils, set root ball with root

a. Plant Beds - **450mm** continuous depth. Applies to

minimum mixture of 3 Kentucky Bluegrass cultivars. Quality

Nursery Stock, Section 17, (latest edition) published by the

and source are to comply with Canadian Standards for

Canadian Nursery Landscape Nursery Landscape

sod is not typically graphically shown on plans.

Phosphorus, 16% Potash at a rate of 350kg/ha. 12. Where applicable, for any plant areas with a mix of species/

3-5 and evenly distribute these in the noted area.

10. Install a 1.2m sod strip adjacent to all hard surfaces. Note,

Apply the following mineral fertilizer unless soil tests show

a. Plant Beds - (8-32-16), i.e. 8% Nitrogen, 32% Phosphorus, 16% Potash per manufacturer specifications. b. Sod Areas - (8-32-16), i.e. 8% Nitrogen, 32%

cultivars notes, Contractor is to cluster like plants in groups of

Ensure trees are thoroughly watered following planting.

Monitor material and ensure adequate moisture until

5. The illustrated number of plants shown in the Planting Plan supersedes the estimated number in the Plant List. Contractor to report any discrepancies to the Landscape

1. Plant material to be No. 1 Grade and is to comply with Canadian Standards for Nursery Stock (latest edition) published by the Canadian Nursery Landscape Association.

approved by the Landscape Architect.

Landscape Architect prior to installation.

collar 75-100mm higher than finished grade.

shrubs, perennials, vines, and groundcovers.

9. Sod to be No. 1 Kentucky Bluegrass Sod grown from

b. Sod/ Seed Areas - 100mm depth.

Approved topsoil depths are as follows:

prior to shipping plant material.

acceptance.

Association.

other requirements:

marked for preservation: cut roots at the edge of the CRZ and grind down stumps after tree removals, do not pull out stumps. Ensure there is not root pulling or disturbance of the

20mm or larger should be cut at right angles with clean, sharp

horticultural tools without tearing, crushing, or pulling. Refer to

9. Do not extend hard surface or significantly change

Hand work only where required within the CRZ; absolutely no

4. Do not place any material or equipment within 2m of the CRZ

the location of the tree protection fencing and detail it on any associated plans for the site (e.g. tree conservation report,

Arborist, erect a fence at the critical root zone (CRZ) of trees. Diameter at breast height (DBH) is the trunk diameter measured at 1.3m height on the tree trunk. The CRZ is

calculated as DBH x 10. Refer to the Tree Protection Fence

both on site and on adjacent sites, prior to any work activity, including tree removal. Maintain tree protection fence in place and

in good condition for the duration of site works:

fence prior to work commencement.

of any tree, including outhouses.

CRZ without approval.

machinery permitted.

away from any tree canopy.

ground within the CRZ.

Excavation of Root Zone.

prior to fence movement.

PLANTING

landscaping.

tree disclosure report, etc.).

### LEGEND - LANDSCAPE

DETAIL SHEET # NOVATECH OR CITY
EG. L<u>1</u>, L<u>2</u>, ETC. DETAIL NUMBER SEE LIST
FOR CODE

— — — PROPERTY LIMIT

TREE PROTECTION FENCE

PROPOSED CONCRETE

RIVERSTONE

PROPOSED PLANTING BED

SEED MIX A - SEE SEED MIX APPLICATION NOTE ON SHEET L6

SEED MIX B - SEE SEED MIX APPLICATION NOTE ON SHEET L6

SEED MIX C - SEE SEED MIX APPLICATION NOTE ON SHEETS L2-L5

PROPOSED WET SHRUB MIX, REFER TO SHEET L6 PROPOSED DRY SHRUB MIX, REFER TO SHEET L6

PROPOSED DECIDUOUS TREE

PROPOSED CONIFEROUS TREE

PROPOSED SHRUBS

EXISTING TREE TO REMAIN EXISTING HEDGEROW TO REMAIN

- SPECIES (SEE PLANT LIST)

SEED MIX AND APPLICATION

extended herein.

include a nurse crop as noted.

40% Oats (Avena sativa)

45% Barley (Hordeum vulgare)

Seeding Rate: 15kg/hectare

Seeding Rate: 25kg/hectare

NURSE CROP

SEED MIX C

For areas steeper than 3:1, Contractor to apply erosion control

on manufacturer, with stitching between two photo-degradable

natural organic fiber nettings. Submit products for approval by

In addition to the specified seed mixes, all applications are to

15% Canada Wild Rye (Elymus canadensis)

CUSTOM NATIVE PARKING ISLAND SEED MIX BY DLF

Consultant. OPSS 804 applies except as may be amended and

blanket. Erosion control blanket to be machine woven mats made

from natural wood, coco or cotton fiber, or combination depending

Related details from City of Ottawa Standard Tender Documents Volume No. 2 Standard Detail Drawings.

Typical Concrete Sidewalk in Boulevard SC5. Sidewalk Construction Joints

# NOVATECH DETAILS

Found on Sheet L7.

CITY DETAILS

- D1. Standard Deciduous Tree Planting D2. Standard Coniferous Tree Planting
- D3. Shrub and Perennial Planting D4. Tree Protection Fence
- D5. Bike Layout D6. Site furniture installation
- D7. Reforestation D8. Riverstone

### PARKING LOT - PLANT LIST

FOR REVIEW ONLY

Deciduous Shrubs Sya 46 Symphoricarpos albus

SCALE

DATE

ngineers, Planners & Landscape Architect Suite 200, 240 Michael Cowpland Drive

(613) 254-9643

(613) 254-5867

CITY of OTTAWA

50cm Ht PT 90cm O.C

LOCATION

105 HUNTMAR DRIVE - WAREHOUSE DEVELOPMENT 🦰 DRAWING NAME

LANDSCAPE PLAN

122151 REV # 4


1:400 NOT FOR ISSUED FOR SITE PLAN APPROVAL AUG 4/23 CONSTRUCTION REVISED PER CITY COMMENTS MAY 31/23 REVISED PER CITY COMMENTS MAR 30/23 ISSUED FOR CITY OF OTTAWA REVIEW DEC 16/22


REVISION

Ottawa, Ontario, Canada K2M 1P6 Facsimile www.novatech-eng.com

Snowberry

122151-L5 #18906

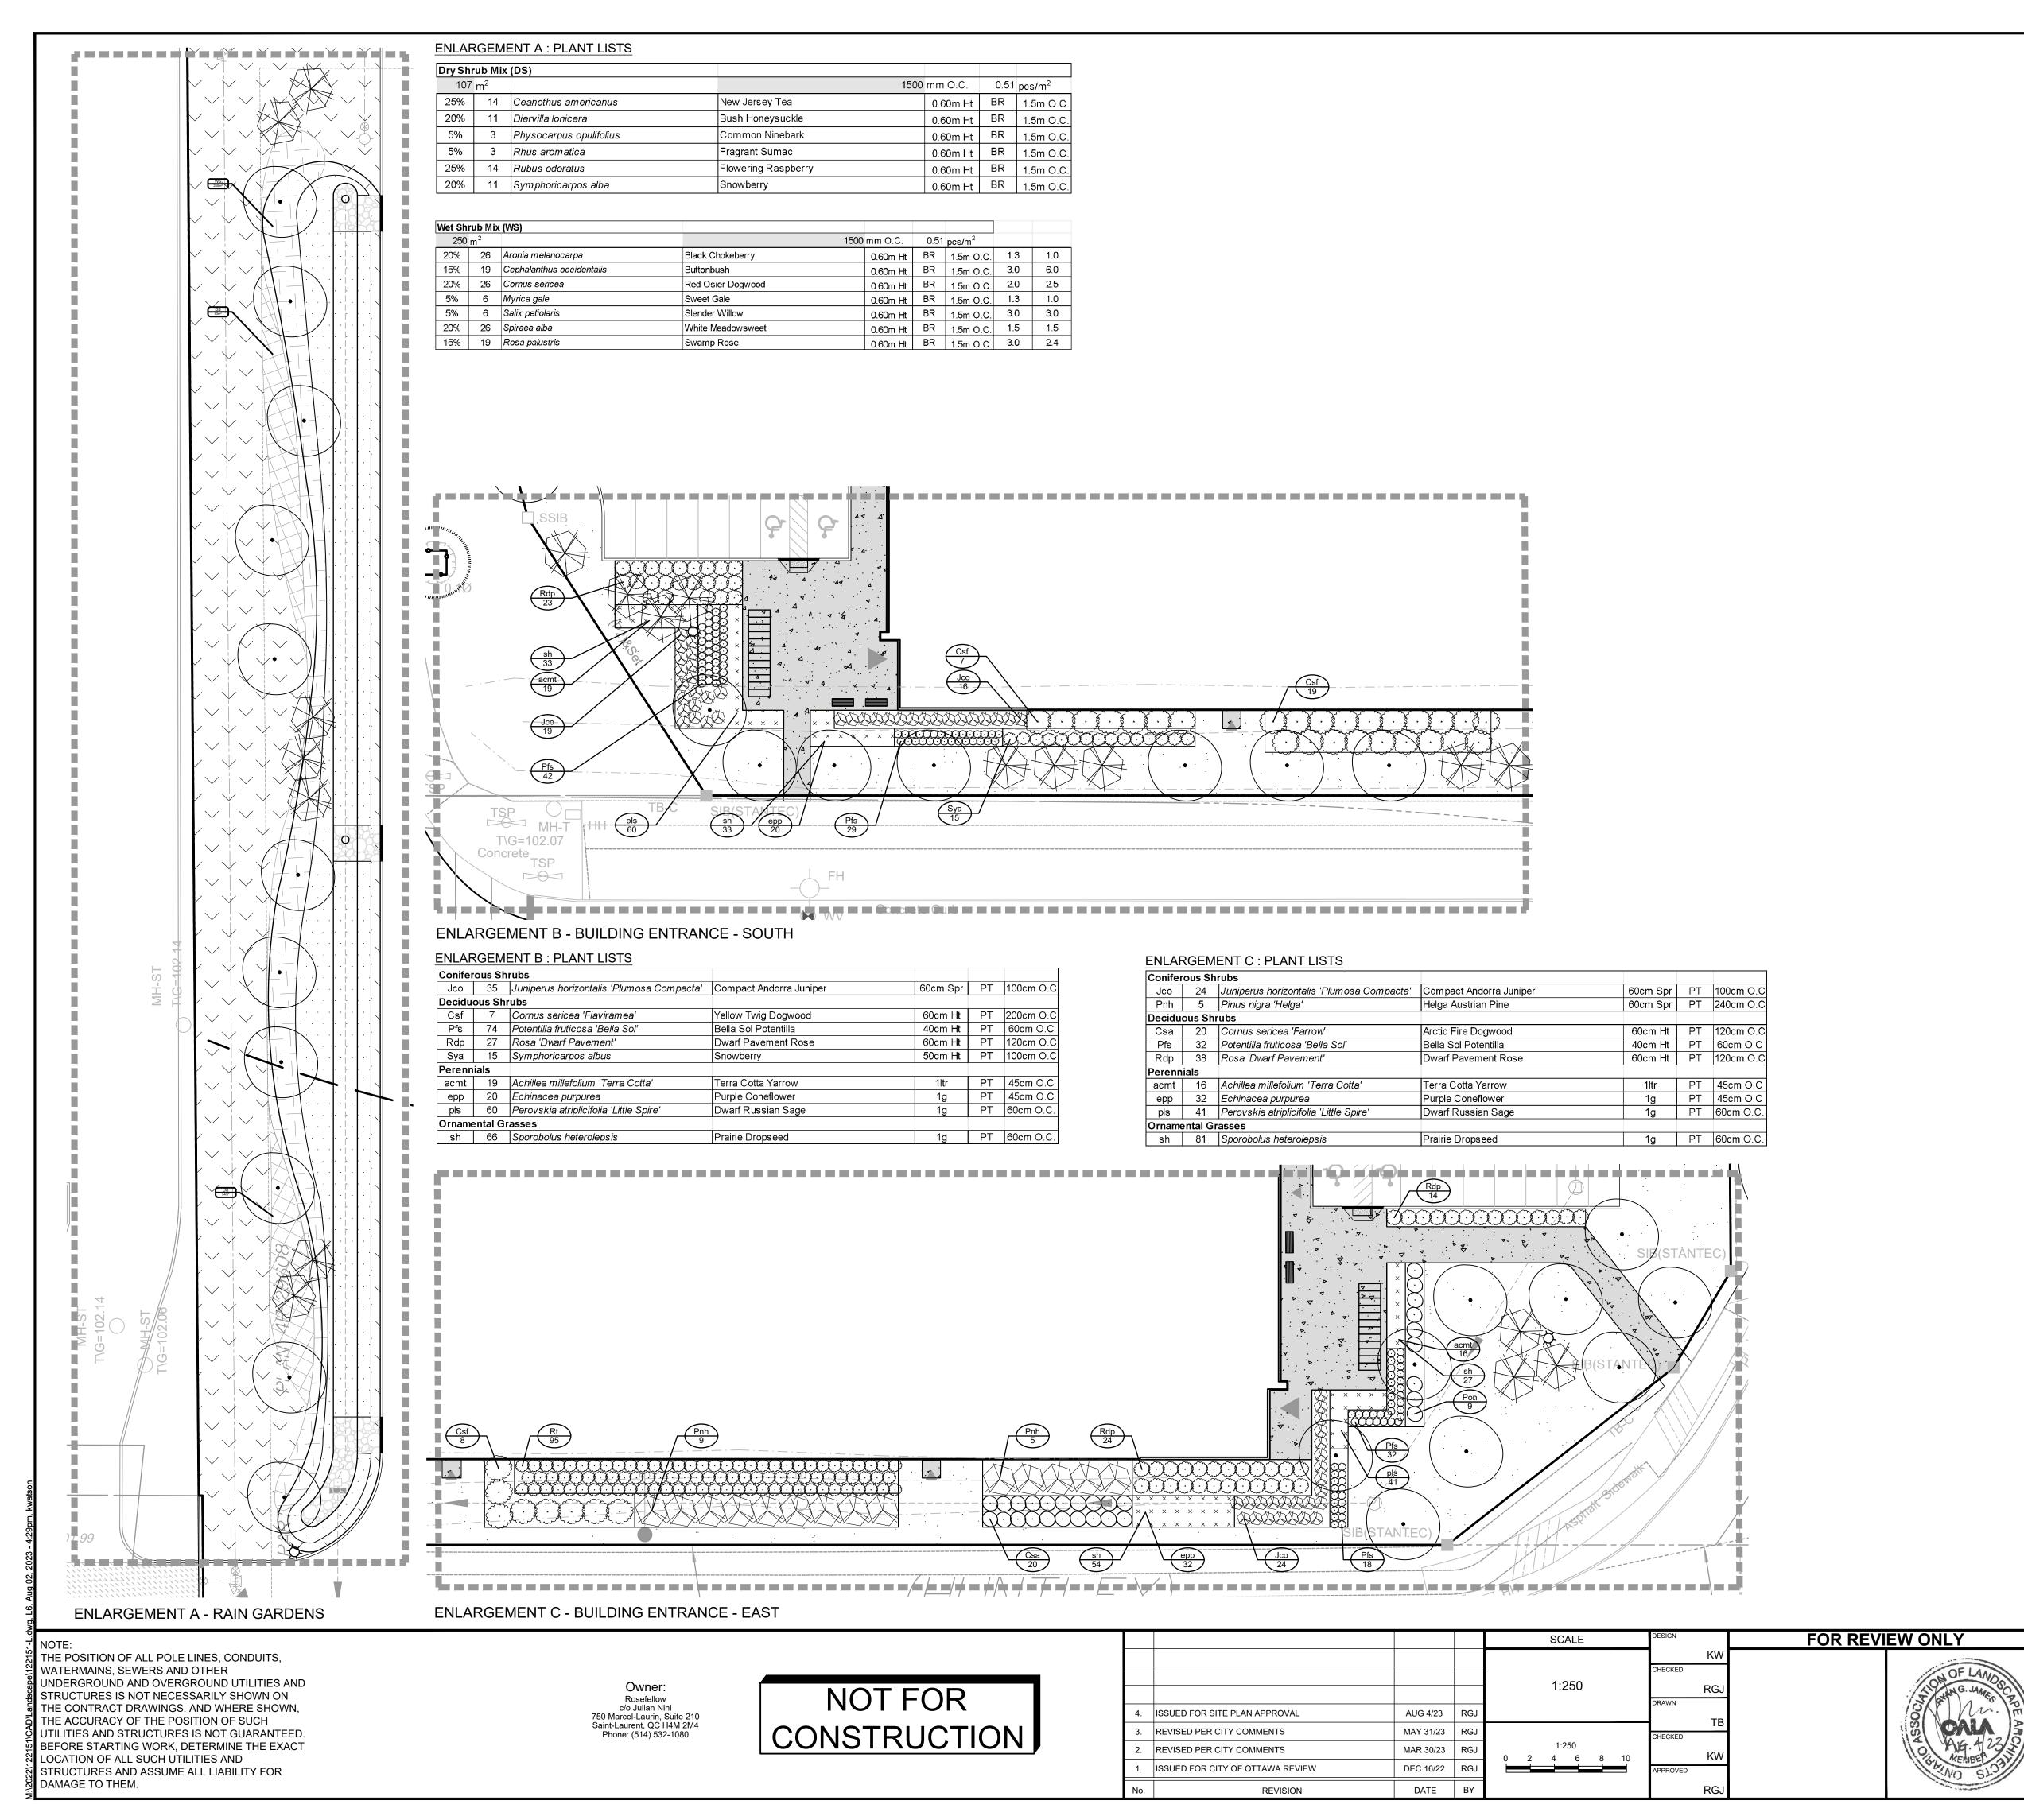

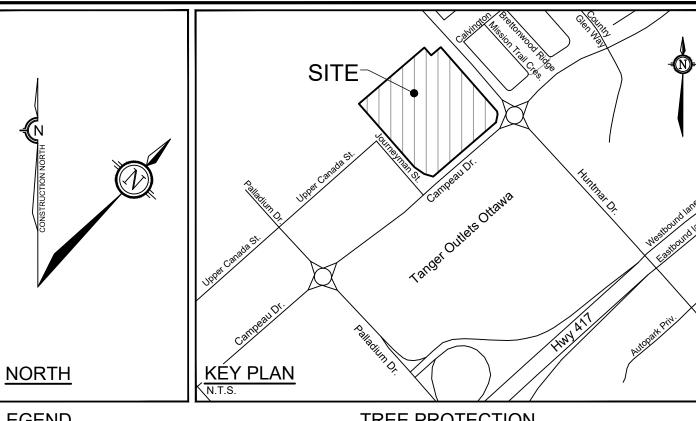

### LEGEND

— PROPERTY LIMIT

PROPOSED CONCRETE

PROPOSED RIVER STONE

SEED MIX A

SEED MIX B

PROPOSED WET SHRUB MIX

PROPOSED DRY SHRUB MIX

PROPOSED DECIDUOUS TREE

PROPOSED CONIFEROUS TREE

PROPOSED SHRUBS

##

- NATURALIZATION

### CITY DETAILS

Related details from City of Ottawa Standard Tender Documents Volume No. 2 Standard Detail Drawings.

Typical Concrete Sidewalk in Boulevard Sidewalk Construction Joints

### NOVATECH DETAILS

Found on Sheet L7.

D1. Standard Deciduous Tree Planting D2. Standard Coniferous Tree Planting

D3. Shrub and Perennial Planting D4. Tree Protection Fence D5. Bike Layout

D6. Site furniture installation D7. Reforestation D8. Riverstone

### SEED MIX AND APPLICATION

For areas steeper than 3:1, Contractor to apply erosion control blanket. Erosion control blanket to be machine woven mats made from natural wood, coco or cotton fiber, or combination depending on manufacturer, with stitching between two photo-degradable natural organic fiber nettings. Submit products for approval by Consultant. OPSS 804 applies except as may be amended and extended herein.

In addition to the specified seed mixes, all applications are to include a nurse crop as noted.

(613) 254-9643

(613) 254-5867

www.novatech-eng.com

NURSE CROP 40% Oats (Avena sativa) 45% Barley (Hordeum vulgare) 15% Canada Wild Rye (Elymus canadensis) Seeding Rate: 15kg/hectare

SEED MIX A RETENTION AREA BY DLF Seeding Rate: 25kg/hectare

SEED MIX B CUSTOM GREENFIELD MIX (230314) BY DLF Seeding Rate: 25kg/hectare

Facsimile

### TREE PROTECTION

DETAIL SHEET # SOVATECH OR CITY Implement the following protection measures for retained trees both on site and on adjacent sites, prior to any work activity, including tree removal. Maintain tree protection fence in place Implement the following protection measures for retained trees, including tree removal. Maintain tree protection fence in place and in good condition for the duration of site works:

- 1. The Landscape Architect or Certified Arborist is to determine the location of the tree protection fencing and detail it on any associated plans for the site (e.g. tree conservation report,
- tree disclosure report, etc.). 2. Under the guidance of a Landscape Architect or Certified Arborist, erect a fence at the critical root zone (CRZ) of trees. Diameter at breast height (DBH) is the trunk diameter measured at 1.3m height on the tree trunk. The CRZ is
- calculated as DBH x 10. Refer to the Tree Protection Fence 3. Refer to the Tree Protection Plan for fence location. City Forestry Staff are to approve both the plan and the installed
- fence prior to work commencement. 4. Do not place any material or equipment within 2m of the CRZ of any tree, including outhouses.
- 5. Do not attach any signs, notices, or posters to any tree. 6. Do not disturb, raise, or lower the existing grade within the CRZ without approval. 7. Only tunnel or bore when digging within the CRZ of a tree.
- Hand work only where required within the CRZ; absolutely no machinery permitted. 8. Do not damage the root system, trunk, or branches, or any
- 9. Do not extend hard surface or significantly change
- landscaping.
- 10. Ensure that exhaust fumes from all equipment are directed away from any tree canopy. 11. When trees marked for removal overlap with the CRZ of trees
- marked for preservation: cut roots at the edge of the CRZ and grind down stumps after tree removals, do not pull out stumps. Ensure there is not root pulling or disturbance of the ground within the CRZ.
- 12. Prior to work taking place, notify and consult the Landscape Architect and City Forestry Staff if roots must be cut. Roots 20mm or larger should be cut at right angles with clean, sharp horticultural tools without tearing, crushing, or pulling. Refer to City of Ottawa Specification S.P. F-8011 Tree Protection,
- Excavation of Root Zone. 13. If damaged or objectionable branches are observed, consult the Landscape Architect, before any work is conducted. Do not prune leaders. Do not prune more than 1/4 of crown.
- 14. Set up a water and fertilizing program, if trees are being affected by site works, to the satisfaction of the Landscape
- 15. The Landscape Architect is to prescribe mitigation measures construction. Measures may include the placement of plywood, wood chips, or steel plating over the roots for protection. City Forestry Staff are to approve said measures prior to fence movement.
- 16. City of Ottawa By-law: Protects municipal trees and municipal natural areas in the City of Ottawa and trees on private property in the urban area of the City of Ottawa (2020-340).

### PLANTING

1. Plant material to be No. 1 Grade and is to comply with Canadian Standards for Nursery Stock (latest edition) published by the Canadian Nursery Landscape Association


- Use structurally sound plant material with strong fibrous root system free of disease, defects, and injuries. Use trees with straight trunks, well and characteristically branched for species. Obtain approval from consultant of plant material at source prior to digging. All trees and shrubs to be container grown, potted, W/B or B/B, as indicated on Plant List. Bare root plants are only acceptable for certain species and as approved by the Landscape Architect.
- 3. Plant material substitutions are not be permitted without the written approval from the Consultant, with 48 hours notice, prior to shipping plant material.
- 4. Plant locations are schematic / approximate only. Contractor is to stake out locations on site for approval by the Landscape Architect prior to installation. 5. The illustrated number of plants shown in the Planting Plan
- supersedes the estimated number in the Plant List. Contractor to report any discrepancies to the Landscape Architect prior to installation. Contractor will assume full responsibility if the Landscape Architect is not notified. Ensure trees are thoroughly watered following planting. Monitor material and ensure adequate moisture until
- In heavy clay or poorly drained soils, set root ball with root collar 75-100mm higher than finished grade. Approved topsoil depths are as follows:
- a. Plant Beds **450mm** continuous depth. Applies to shrubs, perennials, vines, and groundcovers. b. Sod/ Seed Areas - 100mm depth.
- c. Reforestation 300mm depth. Sod to be No. 1 Kentucky Bluegrass Sod grown from minimum mixture of 3 Kentucky Bluegrass cultivars. Quality and source are to comply with Canadian Standards for
- Nursery Stock, Section 17, (latest edition) published by the Canadian Nursery Landscape Nursery Landscape Association. 10. Apply the following mineral fertilizer unless soil tests show
- other requirements: a. Plant Beds - (8-32-16), i.e. 8% Nitrogen, 32% Phosphorus, 16% Potash per manufacturer specifications.
- b. Sod Areas (8-32-16), i.e. 8% Nitrogen, 32% Phosphorus, 16% Potash at a rate of 350kg/ha. 11. Where applicable, for any plant areas with a mix of species/
- cultivars notes, Contractor is to cluster like plants in groups of 3-5 and evenly distribute these in the noted area.

**CITY of OTTAWA** 05 HUNTMAR DRIVE - WAREHOUSE DEVELOPMENT DRAWING NAME ngineers, Planners & Landscape Architect LANDSCAPE ENLARGEMENTS Suite 200, 240 Michael Cowpland Drive Ottawa, Ontario, Canada K2M 1P6

LOCATION

122151 REV # 4 122151-L6

#18906

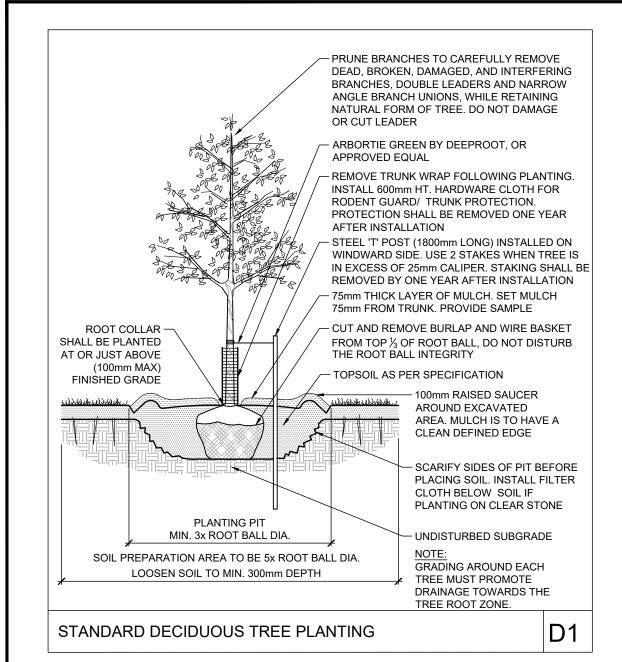

1200 TYP.

SEE PLAN

1200 TYP

└─ ONE (1) BIKE

FASTEN ALL SITE FURNISHINGS TO SURFACE

**BIKE LAYOUT** 

WITH STAINLESS STEEL ANTI-VANDAL ANCHORS.

PARKING SPACE

(600 x 1800mm)

SEE PLAN

→ WALKWAY →

ACCESS

900 MIN. FROM

ADJACENT

**OBSTRUCTION OR** 

EDGE OF SURFACE


- BIKE RACK,


SEE PLAN FOR


SEE PRODUCT INFORMATION


QUANTITY AND ORIENTATION


FOR MAKE AND MODEL,

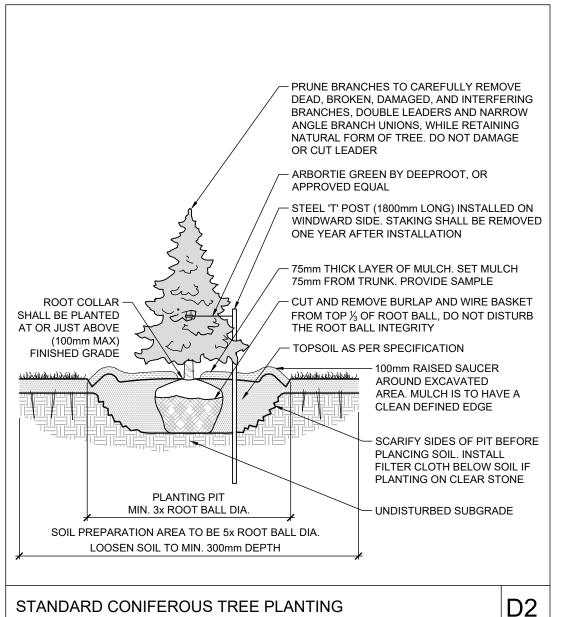


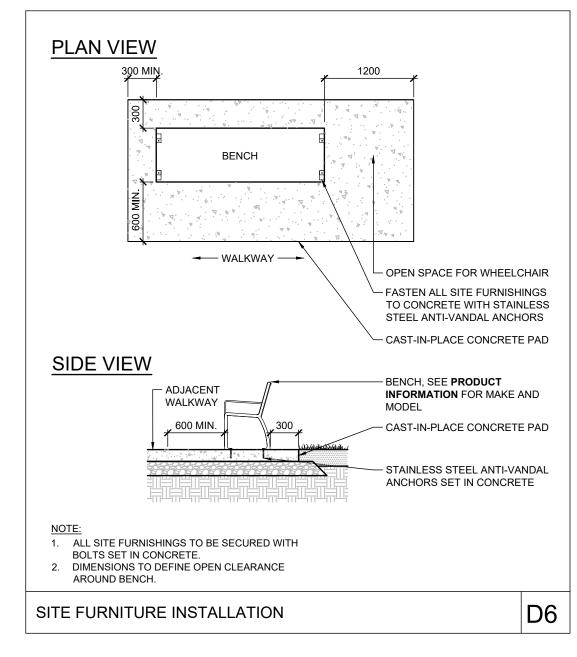

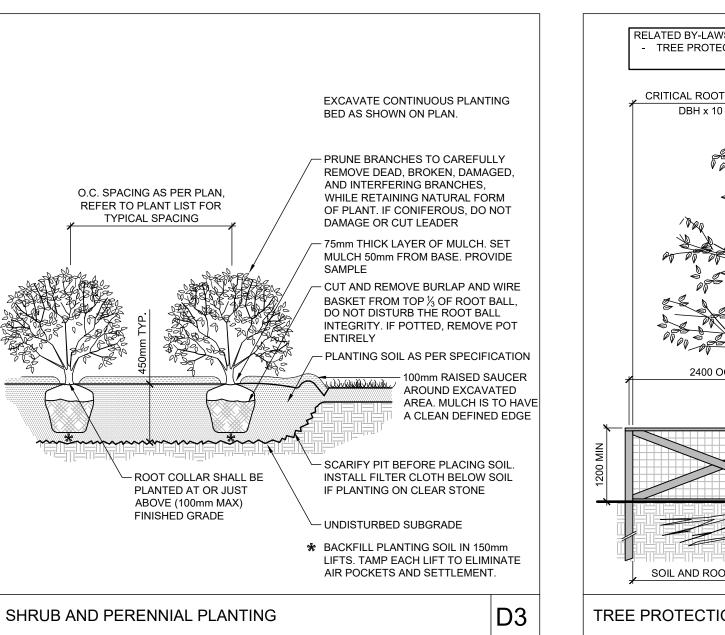

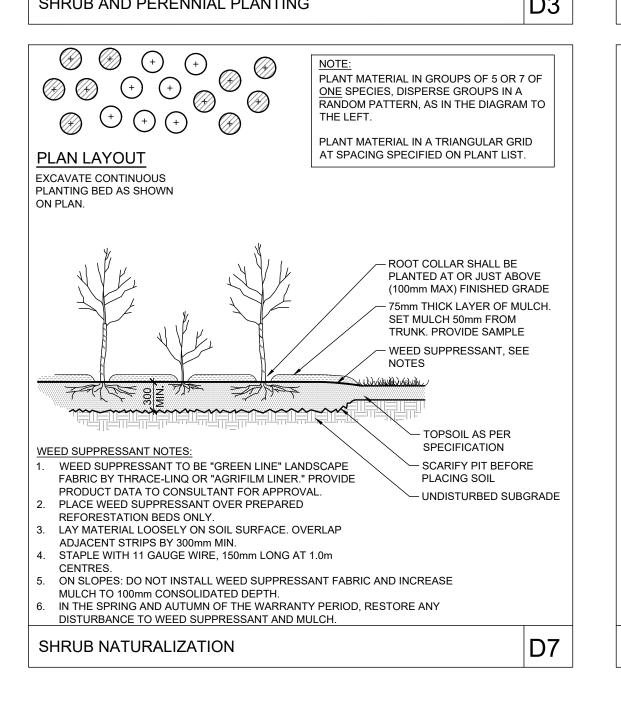

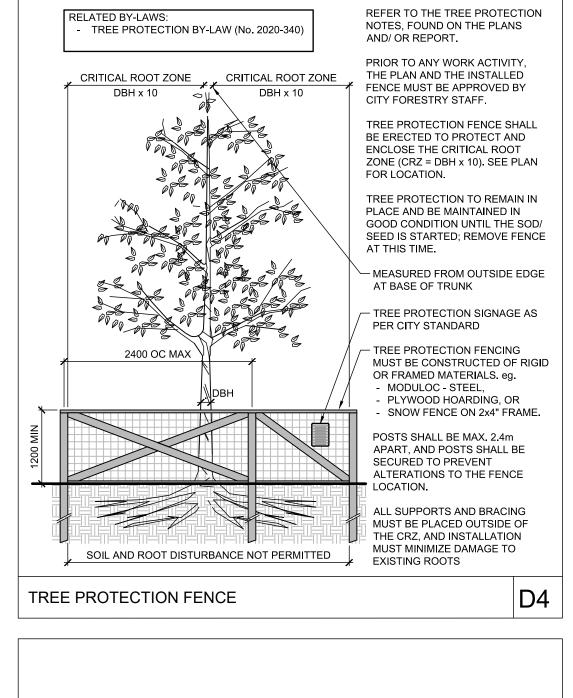

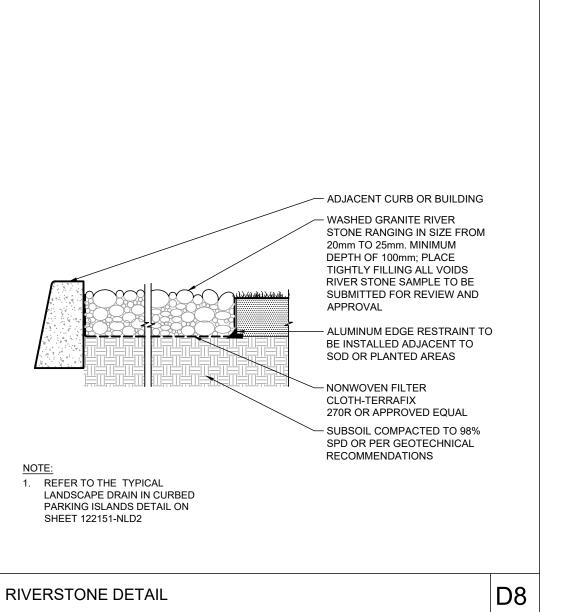


NOTE:
THE POSITION OF ALL POLE LINES, CONDUITS,
WATERMAINS, SEWERS AND OTHER
UNDERGROUND AND OVERGROUND UTILITIES AND
STRUCTURES IS NOT NECESSARILY SHOWN ON
THE CONTRACT DRAWINGS, AND WHERE SHOWN,
THE ACCURACY OF THE POSITION OF SUCH
UTILITIES AND STRUCTURES IS NOT GUARANTEED.
BEFORE STARTING WORK, DETERMINE THE EXACT
LOCATION OF ALL SUCH UTILITIES AND
STRUCTURES AND ASSUME ALL LIABILITY FOR
DAMAGE TO THEM.

Owner:

Rosefellow
c/o Julian Nini
750 Marcel-Laurin, Suite 210
Saint-Laurent, QC H4M 2M4
Phone: (514) 532-1080

NOT FOR CONSTRUCTION

				SCALE	DESIGN	
					K\	W
					CHECKED	
					RG	<b>S</b> J
					DRAWN	
4.	ISSUED FOR SITE PLAN APPROVAL	AUG 4/23	RGJ		K\	Λ/
3.	REVISED PER CITY COMMENTS	MAY 31/23	RGJ		CHECKED	V V
2.	REVISED PER CITY COMMENTS	MAR 30/23	RGJ		K	W
1.	ISSUED FOR CITY OF OTTAWA REVIEW	DEC 16/22	RGJ		APPROVED	
No.	REVISION	DATE	BY		RG	<b>3</b> J

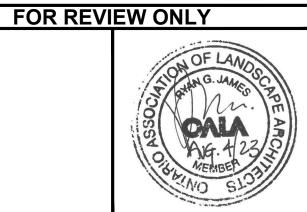

Engineers, Planners & Landscape Architects
Suite 200, 240 Michael Cowpland Drive
Ottawa, Ontario, Canada K2M 1P6
Telephone (613) 254-9643

(613) 254-5867

www.novatech-eng.com

Facsimile

LOCATION
CITY of OTTAWA
405 HUNTMAR DRIVE - WAREHOUSE DEVELOPMENT

DRAWING NAME
LANDSCAPE DETAILS

PROJECT No.

122151
REV