

NEW SITE PLAN LEGEND	
	EXISTING BUILDING TO REMAIN
	DEMOLISH EXISTING BUILDING AND OBJECTS
	EXISTING BUILDING NOT IN CONTRACT
	NEW ADDITION BUILDING
	EXISTING ASPHALT TO REMAIN
	NEW ASPHALT
	EXISTING CONCRETE SIDEWALK TO REMAIN
	NEW CONCRETE SIDEWALK
	EXISTING CRUSHED STONE PARCKING TO REMAIN
	NEW GRANULAR PER LANDSCAPING
	EXISTING PLANTING TO REMAIN
	NEW PLANTING
\(\psi\) \(\	NEW GRASS
	EXISTING SAND PLAYGROUND TO REMAIN
	NEW SAND PLAYGROUND
	MUD SLAB PER CIVIL. (TEMPORARY CONSTRUCTION)
	DDODEDTY LINE

## —— - - — SETBACK LINE

PROPERTY LINE

---- OVERHEAD \_\_\_\_x\_\_\_x\_\_\_\_x\_\_\_EXISTING FENCE TO REMAIN

ROAD SETBACK

## ——x——x—— NEW FENCE

TEMPORARY FENCE FOR PERIOD OF CONSTRUCTION —TP— TREE PROTECTION PER LANDSCAPING

—wtr——wtr——wtr— EXISTING WATER SUPPLY TO REMAIN

——SAN——SAN——SAN—— EXISTING SANITARY TO REMAIN

——wtr——wtr—— NEW WATER SUPPLY

EXISTING ELECTRICAL SERVICE TO REMAIN (BELOW GRADE) NEW ELECTRICAL SERVICE (BELOW

GRADE) **BUILDING ENTRANCE / EXIT** 

⊕ Ls LIGHT STAND - NEW MANHOLE - EXISTING

MANHOLE - NEW

LIGHT STAND - EXISTING

UTILITY POLE - EXISTING

UTILITY POLE - NEW

TREE - EXISTING TREE - NEW

80 TEMPORARY CONSTRUCTION PERIMETER BARRIER PER

81 RELOCATE EXISTING PRECAST STORAGE UNITS AT NEW POSITION AS SHOWN. REPLACE EXISTING SOIL WITH COMPACTED GRANULAR B TO FROST PROTECTION DEPTH PER GEOTECHNICAL REPORT. PROVIDE 200mm DEEP COMPACTED GRANULAR A BED UNDER PRECAST UNITS

NEW WASTE BIN STORAGE COMPLETED WITH 1829mm HIGH ENCLOSURE AND 1067mm WIDE ACCESS GATE.

83 NEW TREE PER LANDSCAPING

#### **SITE PLAN KEYNOTES:**

1 EXISTING SKATING RING TO REMAIN

2 EXISTING SOCCER FIELD TO REMAIN

3 EXISTING BASEBALL DIAMOND TO REMAIN

4 EXISTING COVERED DECK TO REMAIN

5 EXISTING PORCH STRUCTURES AND FENCE TO REMAIN

6 EXISTING ROOF OVERHANG ABOVE TO REMAIN

EXISTING DRILLED WELL TO REMAIN. VERIFY LOCATION ON

SITE. PROTECT WELL PER CIVIL. REGRADE ADJACENT SURFACE PER CIVIL.

8 EXISTING ASPHALT PAVING TO REMAIN

9 EXISTING CURB TO REMAIN

| 10 | EXISTING ASPHALT SIDEWALK TO REMAIN

11 EXISTING SEPTIC TANK TO REMAIN

12 EXISTING SEPTIC DRAIN FIELD TO REMAIN. ELIMINATE AUTOMOBILE AND EQUIPMENT MOVEMENT OVER THIS

13 PARKING SPACES RESERVED FOR SOCCER TEAMS DURING

CONSTRUCTION 14 EXISTING GRAVEL PARKING TO REMAIN

15 EXISTING ACCESSIBLE CONCRETE CURB RAMP AND DEPRESSED CURB TO REMAIN

16 EXISTING HOSE BIB TO REMAIN. ENSURE RUNNING WATER FOR HOCKEY RING DURING CONSTRUCTION.

18 EXISTING BENCH TO REMAIN

17 EXISTING PLAYGROUND TO REMAIN

19 EXISTING SEPTIC FIELD AND SANITARY SERVICE. SHOWN LOCATIONS ARE APPROXIMATE. VERIFY LOCATIONS ON

20 PORTION OF EXISTING LUMBER FENCE TO REMAIN. COORDINATE EXTENT ON SITE.

21 PORTION OF EXISTING ASPHALT SIDEWALK TO REMAIN

22 PORTION OF EXISTING CONCRETE CURB TO REMAIN

23 PORTION OF EXISTING ASPHALT PAVING TO REMAIN

51 REQUIRED STRUCTURE SETBACK

52 NEW CONCRETE PAVING PER LANDSCAPING

53 NEW GRANULAR PER LANDSCAPING

54 NEW ROOF OVERHANG ABOVE

12000mm MIN.

55 NEW HEAT PUMP AND CONDENSING UNITS PER MECHANICAL ON CONCRETE PAD. SURROUND BY LINK FENCE WITH LOCKABLE ACCESS GATE.

NEW TOP SOIL AND GRASS AT AREA AFFECTED BY CONSTRUCTION AND PER LANDSCAPING

NEW ACCESS ROUTE FOR FIRE DEPARTMENT (SHOWN DASHED). CLEAR WIDTH 6000mm MIN., CENTERLINE RADIUS

NEW HEAVY DUTY GRAVEL PAVEMENT STRUCTURE DESIGNED TO SUPPORT FIREFIGHTING EQUIPMENT AND PERMIT ACCESSIBILITY UNDER ALL CLIMATIC CONDITIONS PER CIVIL

NEW ASPHALT HEAVY DUTY PAVEMENT STRUCTURE DESIGNED TO SUPPORT FIRE FIGHTING EQUIPMENT PER

60 EXTEND DRIVEWAY PER CIVIL AS REQUIRED. VERIFY

EXTENT OF EXISTING DRIVEWAY ON SITE. 61 EXTEND CULVERT PER CIVIL AS REQUIRED. VERIFY EXTENT

62 TEMPORARY FENCING COMPLETED WITH ACCESS GATES FOR PERIOD OF CONSTRUCTION

63 NEW POST AND ACCESSIBLE PARKING SIGN.

64 NEW SANITARY SEWAGE PER CIVIL

OF EXISTING CULVERT ON SITE.

65 NEW PLANTING PER LANDSCAPING

66 INSTALL SALVAGED BICYCLE RACKS. ADJUST AS REQUIRED.

67 INSTALL SALVAGED SWINGS PER LANDSCAPING

INSTALL SALVAGED PLAY STRUCTURES PER LANDSCAPING

69 NEW PLAY GROUND EXTENSION PER LANDSCAPING

70 AREA FOR FUTURE SEPTIC FIELD EXPANSION PER LANDSCAPING

71 POND PER CIVIL

72 TEMPORARY CONSTRUCTION. MUD MAT PER CIVIL ON TOP OF EXISTING ASPHALT SITE ENTRANCE.

73 NEW HOLDING TANKS FOR FIRE PROTECTION PER CIVIL C/W FIRE SERVICE CONNECTIONS AND ROUND ACCESS

74 COVERED DRAINAGE PIPE PER CIVIL

NEW POST AND SIGN C/W WORDING: " 6 METER WIDE FIRE ROUTE WITHIN PARKING AISLE. NO PARKING ON FIRE

NEW POST AND SIGN C/W WORDING: " END OF FIRE

SNOW STORAGE AREA

PROVIDE NEW CONCRETE CURB AS REQUIRED FOR NEW ACCESSIBLE PARKING CONSTRUCTION. REINSTATE ASPHALT PAVING AND BASE COURSES, MATCH EXISTING CONCRETE CURB AND EXISTING PAVING ASSEMBLIES AT SIDEWALK AND PARKING SPOTS. MAKE ALL JUNCTION SMOOTH AND IN STRAIGHT LINES

79 PROVIDE NEW CONTRASTING PAINTING AT FACE OF ASPHALT WITHIN 1500mm ACCESS AISLE. REINSTATE PAVING MARKINGS CONTAINING INTERNATIONAL SYMBOL OF ACCESSIBILITY.

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13 2023/06/12 ISSUED FOR SPC RESUBMISSION

12 2023/04/25 ISSUED FOR SPC RESUBMISSION 10 2022/11/08 ISSUED FOR SITE PLAN CONTROL REVIEW

2022/04/22 ISSUED FOR TENDER 2022/02/23 ISSUED FOR SITE PLAN CONTROL REV DATE ISSUE

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**CITY OF OTTAWA** 

OTTAWA ONTARIO, CANADA

PROJECT

TITLE

CLIENT

**CORKERY COMMUNITY** HALL EXPANSION


3447 OLD ALMONTE RD., CARP, ON K0A 1L0

**SITE PLAN** 

PROJECT NO: 2020-0640 DRAWN: APPROVED: SCALE: As indicated

DATE PRINTED: 2023-06-12 4:50:28 PM REV

DRAWING NO.

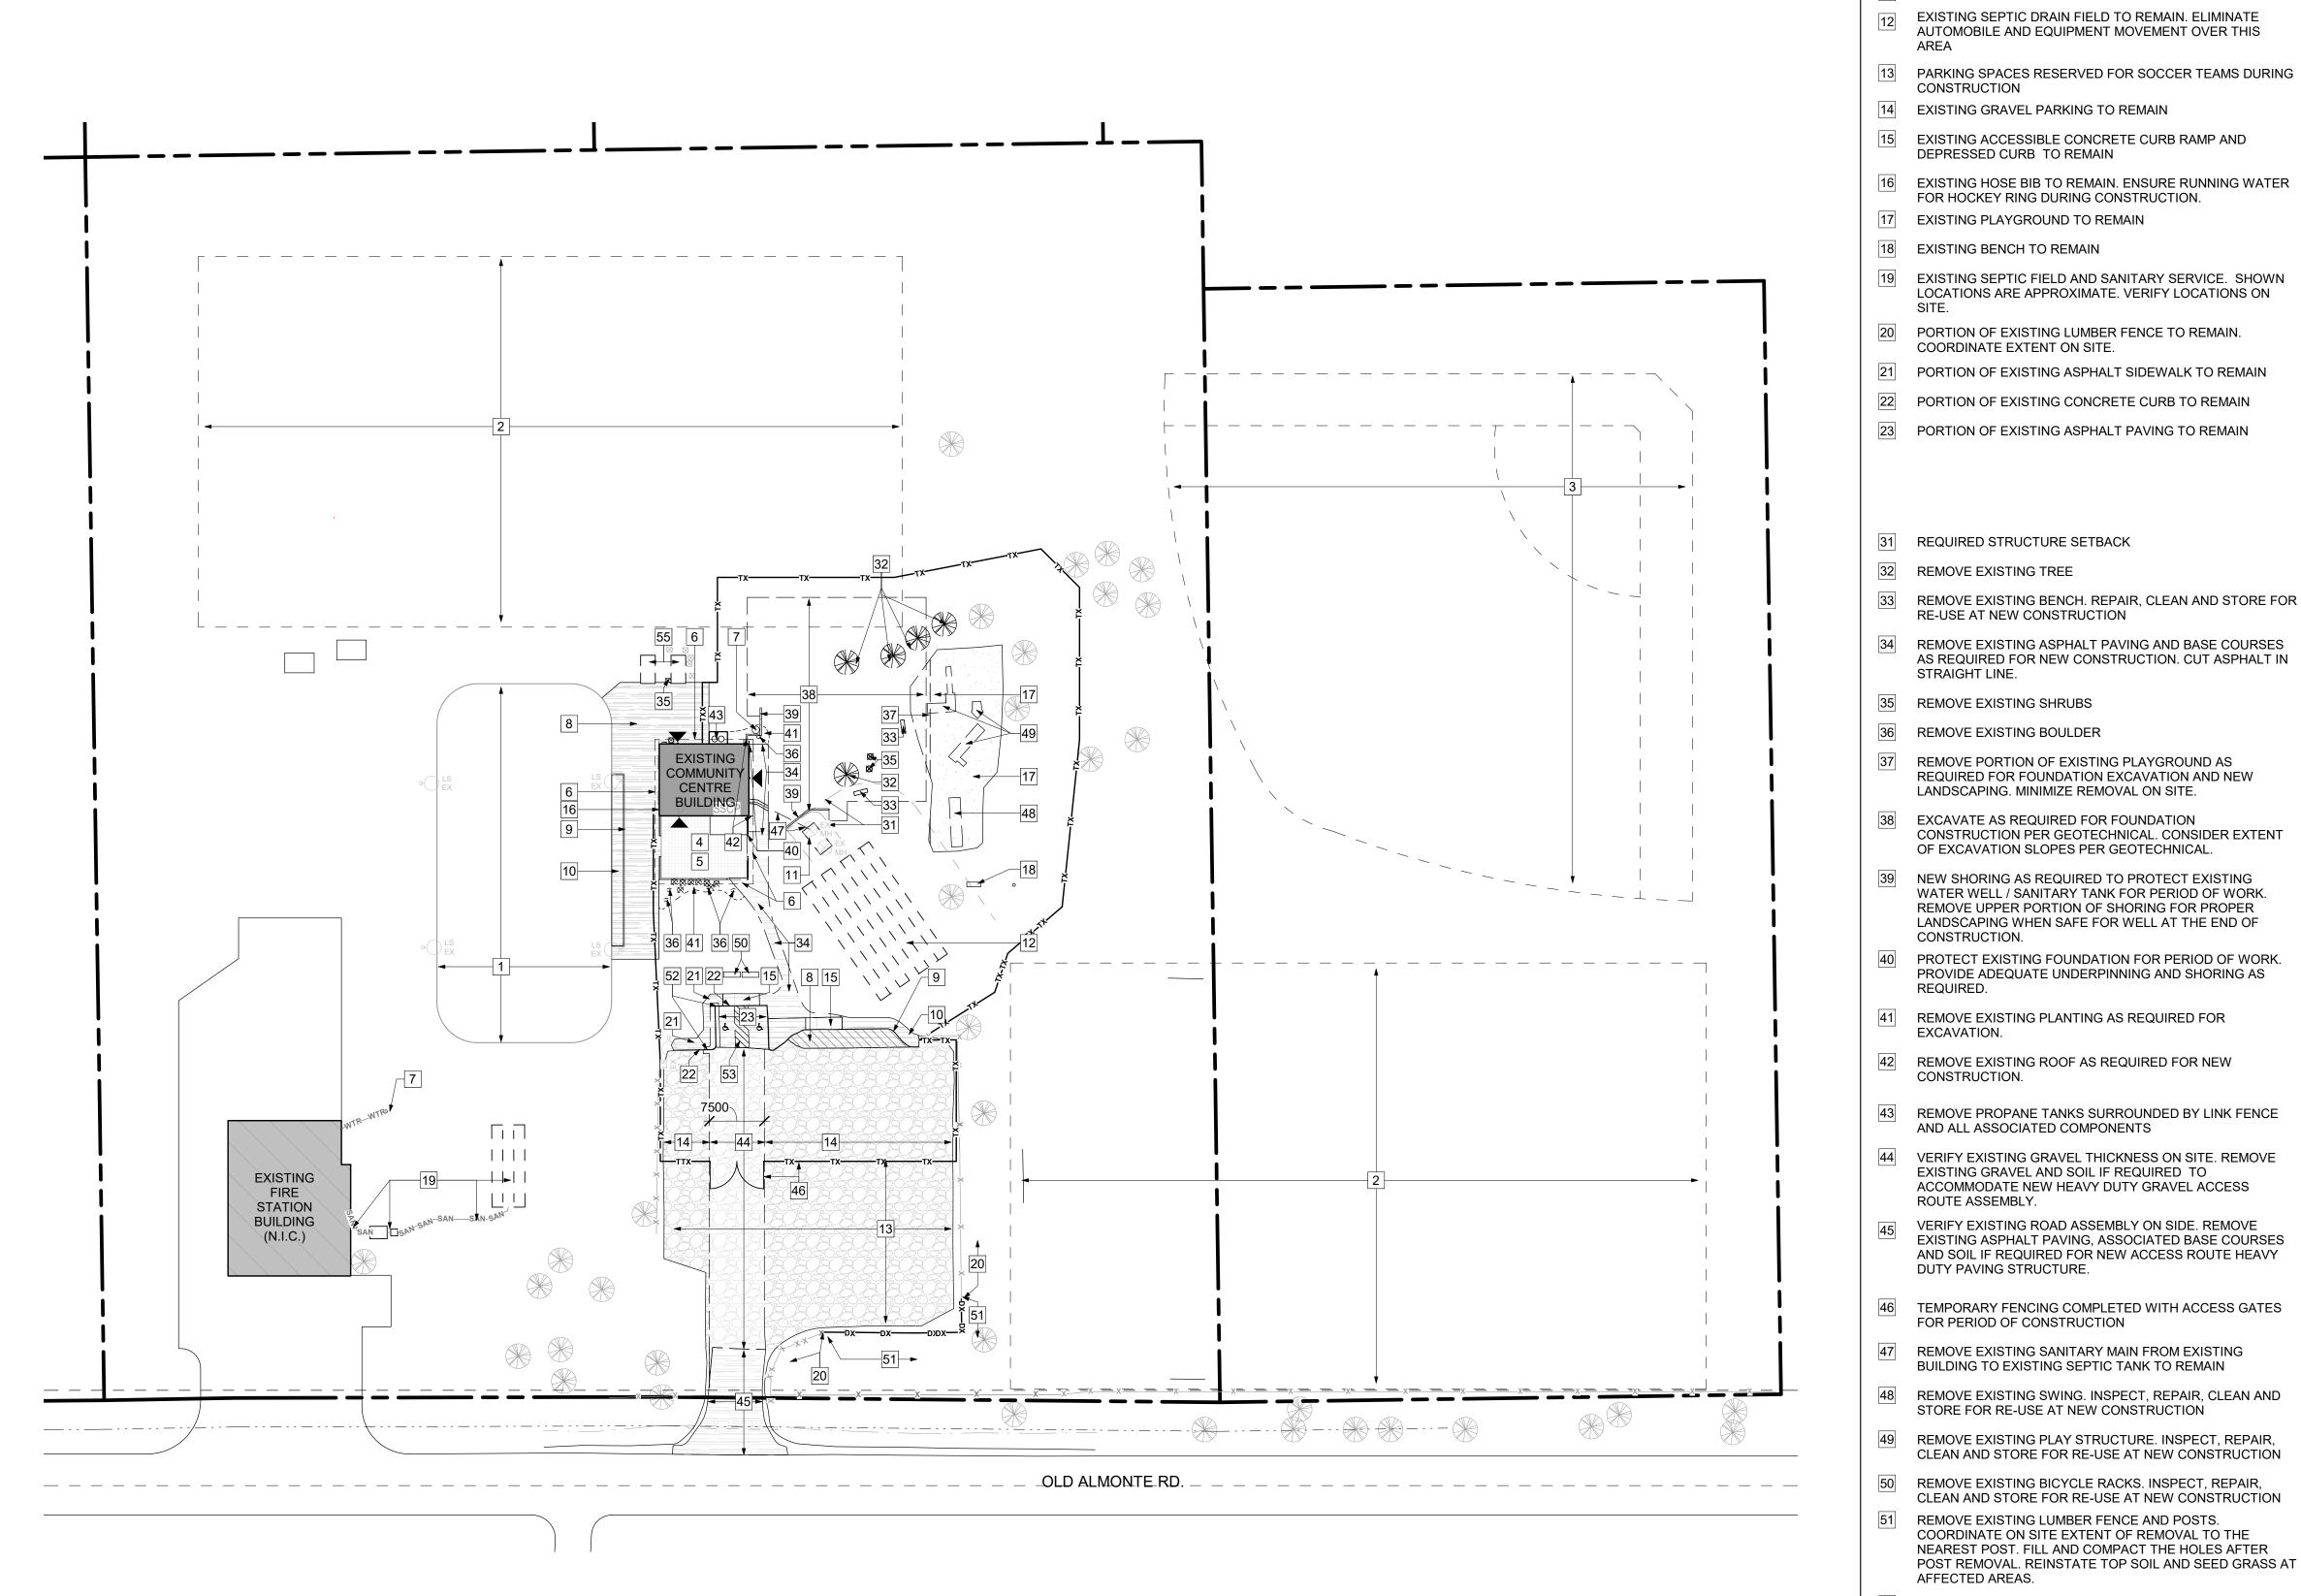

CONSTRUCTION. REMOVE PROPANE TANKS SURROUNDED BY LINK FENCE AND ALL ASSOCIATED COMPONENTS

**DEMOLITION SITE PLAN KEYNOTES:** 

1 EXISTING SKATING RING TO REMAIN

2 EXISTING SOCCER FIELD TO REMAIN

4 EXISTING COVERED DECK TO REMAIN

8 EXISTING ASPHALT PAVING TO REMAIN

10 EXISTING ASPHALT SIDEWALK TO REMAIN

11 EXISTING SEPTIC TANK TO REMAIN

DEPRESSED CURB TO REMAIN

COORDINATE EXTENT ON SITE.

RE-USE AT NEW CONSTRUCTION

STRAIGHT LINE.

CONSTRUCTION.

EXCAVATION.

FOR HOCKEY RING DURING CONSTRUCTION.

9 EXISTING CURB TO REMAIN

CONSTRUCTION

3 EXISTING BASEBALL DIAMOND TO REMAIN

6 EXISTING ROOF OVERHANG ABOVE TO REMAIN

5 EXISTING PORCH STRUCTURES AND FENCE TO REMAIN

7 EXISTING DRILLED WELL TO REMAIN. PROTECT WELL PER

AUTOMOBILE AND EQUIPMENT MOVEMENT OVER THIS

LOCATIONS ARE APPROXIMATE. VERIFY LOCATIONS ON

AS REQUIRED FOR NEW CONSTRUCTION. CUT ASPHALT IN

REMOVE PORTION OF EXISTING PLAYGROUND AS

LANDSCAPING. MINIMIZE REMOVAL ON SITE.

OF EXCAVATION SLOPES PER GEOTECHNICAL.

REQUIRED FOR FOUNDATION EXCAVATION AND NEW

CONSTRUCTION PER GEOTECHNICAL. CONSIDER EXTENT

WATER WELL / SANITARY TANK FOR PERIOD OF WORK. REMOVE UPPER PORTION OF SHORING FOR PROPER

LANDSCAPING WHEN SAFE FOR WELL AT THE END OF

PROVIDE ADEQUATE UNDERPINNING AND SHORING AS

VERIFY EXISTING GRAVEL THICKNESS ON SITE. REMOVE EXISTING GRAVEL AND SOIL IF REQUIRED TO ACCOMMODATE NEW HEAVY DUTY GRAVEL ACCESS ROUTE ASSEMBLY. VERIFY EXISTING ROAD ASSEMBLY ON SIDE. REMOVE

EXISTING ASPHALT PAVING, ASSOCIATED BASE COURSES AND SOIL IF REQUIRED FOR NEW ACCESS ROUTE HEAVY DUTY PAVING STRUCTURE.

TEMPORARY FENCING COMPLETED WITH ACCESS GATES FOR PERIOD OF CONSTRUCTION

47 REMOVE EXISTING SANITARY MAIN FROM EXISTING BUILDING TO EXISTING SEPTIC TANK TO REMAIN

REMOVE EXISTING SWING. INSPECT, REPAIR, CLEAN AND STORE FOR RE-USE AT NEW CONSTRUCTION

49 REMOVE EXISTING PLAY STRUCTURE. INSPECT, REPAIR,

CLEAN AND STORE FOR RE-USE AT NEW CONSTRUCTION

50 REMOVE EXISTING BICYCLE RACKS. INSPECT, REPAIR, CLEAN AND STORE FOR RE-USE AT NEW CONSTRUCTION 51 REMOVE EXISTING LUMBER FENCE AND POSTS.

COORDINATE ON SITE EXTENT OF REMOVAL TO THE NEAREST POST. FILL AND COMPACT THE HOLES AFTER POST REMOVAL. REINSTATE TOP SOIL AND SEED GRASS AT AFFECTED AREAS.

52 REMOVE PORTION OF EXISTING CURB AND ASPHALT PAVING AND BASE COURSES AS REQUIRED FOR NEW CURB CONSTRUCTION. CUT ASPHALT IN STRAIGHT LINE. MINIMIZE

753 REMOVE EXISTING PAINTING FROM THE FACE OF ASPHALT. PROTECT EXISTING TO REMAIN ASPHALT

ACCURATELY REMOVE EXISTING PRECAST STORAGE UNIT FOR RELOCATION TO NEW POSITION. REMOVE EXISTING BEDDING AND FOUNDATION UNDER THE EXISTING PRECAST UNIT AS REQUIRED FOR NEW GRADING.

#### SITE PLAN GENERAL NOTES

A. DO NOT SCALE THIS DRAWING B. REPORT ANY DISCREPANCIES PRIOR TO COMMENCING WORK. NO RESPONSIBILITY IS BORN BY THE CONSULTANT FOR

UNKNOWN SUBSURFACE CONDITIONS C. CONTRACTOR TO CHECK AND VERIFY ALL DIMENSIONS ON SITE AND REPORT ANY ERRORS AND/OR OMISSIONS TO THE

CONSULTANT D. REINSTATE ALL AREAS AND ITEMS DAMAGED AS A RESULT OF

CONSTRUCTION ACTIVITIES TO THE SATISFACTION OF THE CONSULTANT E. CONTRACTOR TO LAYOUT PLANTING BEDS, PATHWAYS ETC. TO APPROVAL OF CONSULTANT PRIOR TO ANY JOB

**EXCAVATION** . THE ACCURACY OF THE POSITION OF UTILITIES IS NOT GUARANTEED - CONTRACTOR TO VERIFY PRIOR TO

G. INDIVIDUAL UTILITY COMPANY MUST BE CONTACTED FOR CONFIRMATION OF UTILITY EXISTENCE AND LOCATION PRIOR

TO DIGGING H. ALL DISTURBED AREAS TO BE RESTORED TO ORIGINAL CONDITION OR BETTER UNLESS OTHERWISE NOTED

#### **DEMOLITION SITE PLAN LEGEND**

EXISTING BUILDING TO REMAIN DEMOLISH EXISTING BUILDING AND OBJECTS **EXISTING BUILDING NOT IN CONTRACT** EXISTING ASPHALT TO REMAIN EXISTING ASPHALT TO REMOVE EXISTING CONCRETE SIDEWALK TO EXISTING CRUSHED STONE PARCKING TO REMAIN EXISTING CRUSHED STONE PARCKING TO REMOVE EXISTING PLANTING TO REMAIN EXISTING SAND PLAYGROUND TO **NEW SHORING** PROPERTY LINE —— · · · — SETBACK LINE ---- OVERHEAD ——x——x—— EXISTING FENCE TO REMAIN ——DX——DX——DX——DEMOLISH EXISTING FENCE REMAIN (BELOW GRADE) —wtr—wtr—wtr— EXISTING WATER SUPPLY TO REMAIN ——SAN———SAN———SAN—— EXISTING SANITARY TO REMAIN BUILDING ENTRANCE / EXIT LIGHT STAND - EXISTING TO REMAIN MANHOLE - EXISTING TO REMAIN UTILITY POLE - EXISTING TO REMAIN TREE - EXISTING TO REMAIN

TREE - DEMOLITION

SHRUB - DEMOLITION

SHRUB - EXISTING OT REMAIN

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CLIENT

#### **CITY OF OTTAWA**

OTTAWA ONTARIO, CANADA

PROJECT

#### **CORKERY COMMUNITY** HALL EXPANSION

3447 OLD ALMONTE RD., CARP, ON K0A 1L0 TITLE


### **DEMOLITION SITE PLAN**

PROJECT NO: 2020-0640 DRAWN: APPROVED: JS As indicated DATE PRINTED: 2023-06-12 4:50:29 PM

DRAWING NO. REV

D101

1 SITE PLAN - DEMOLITION

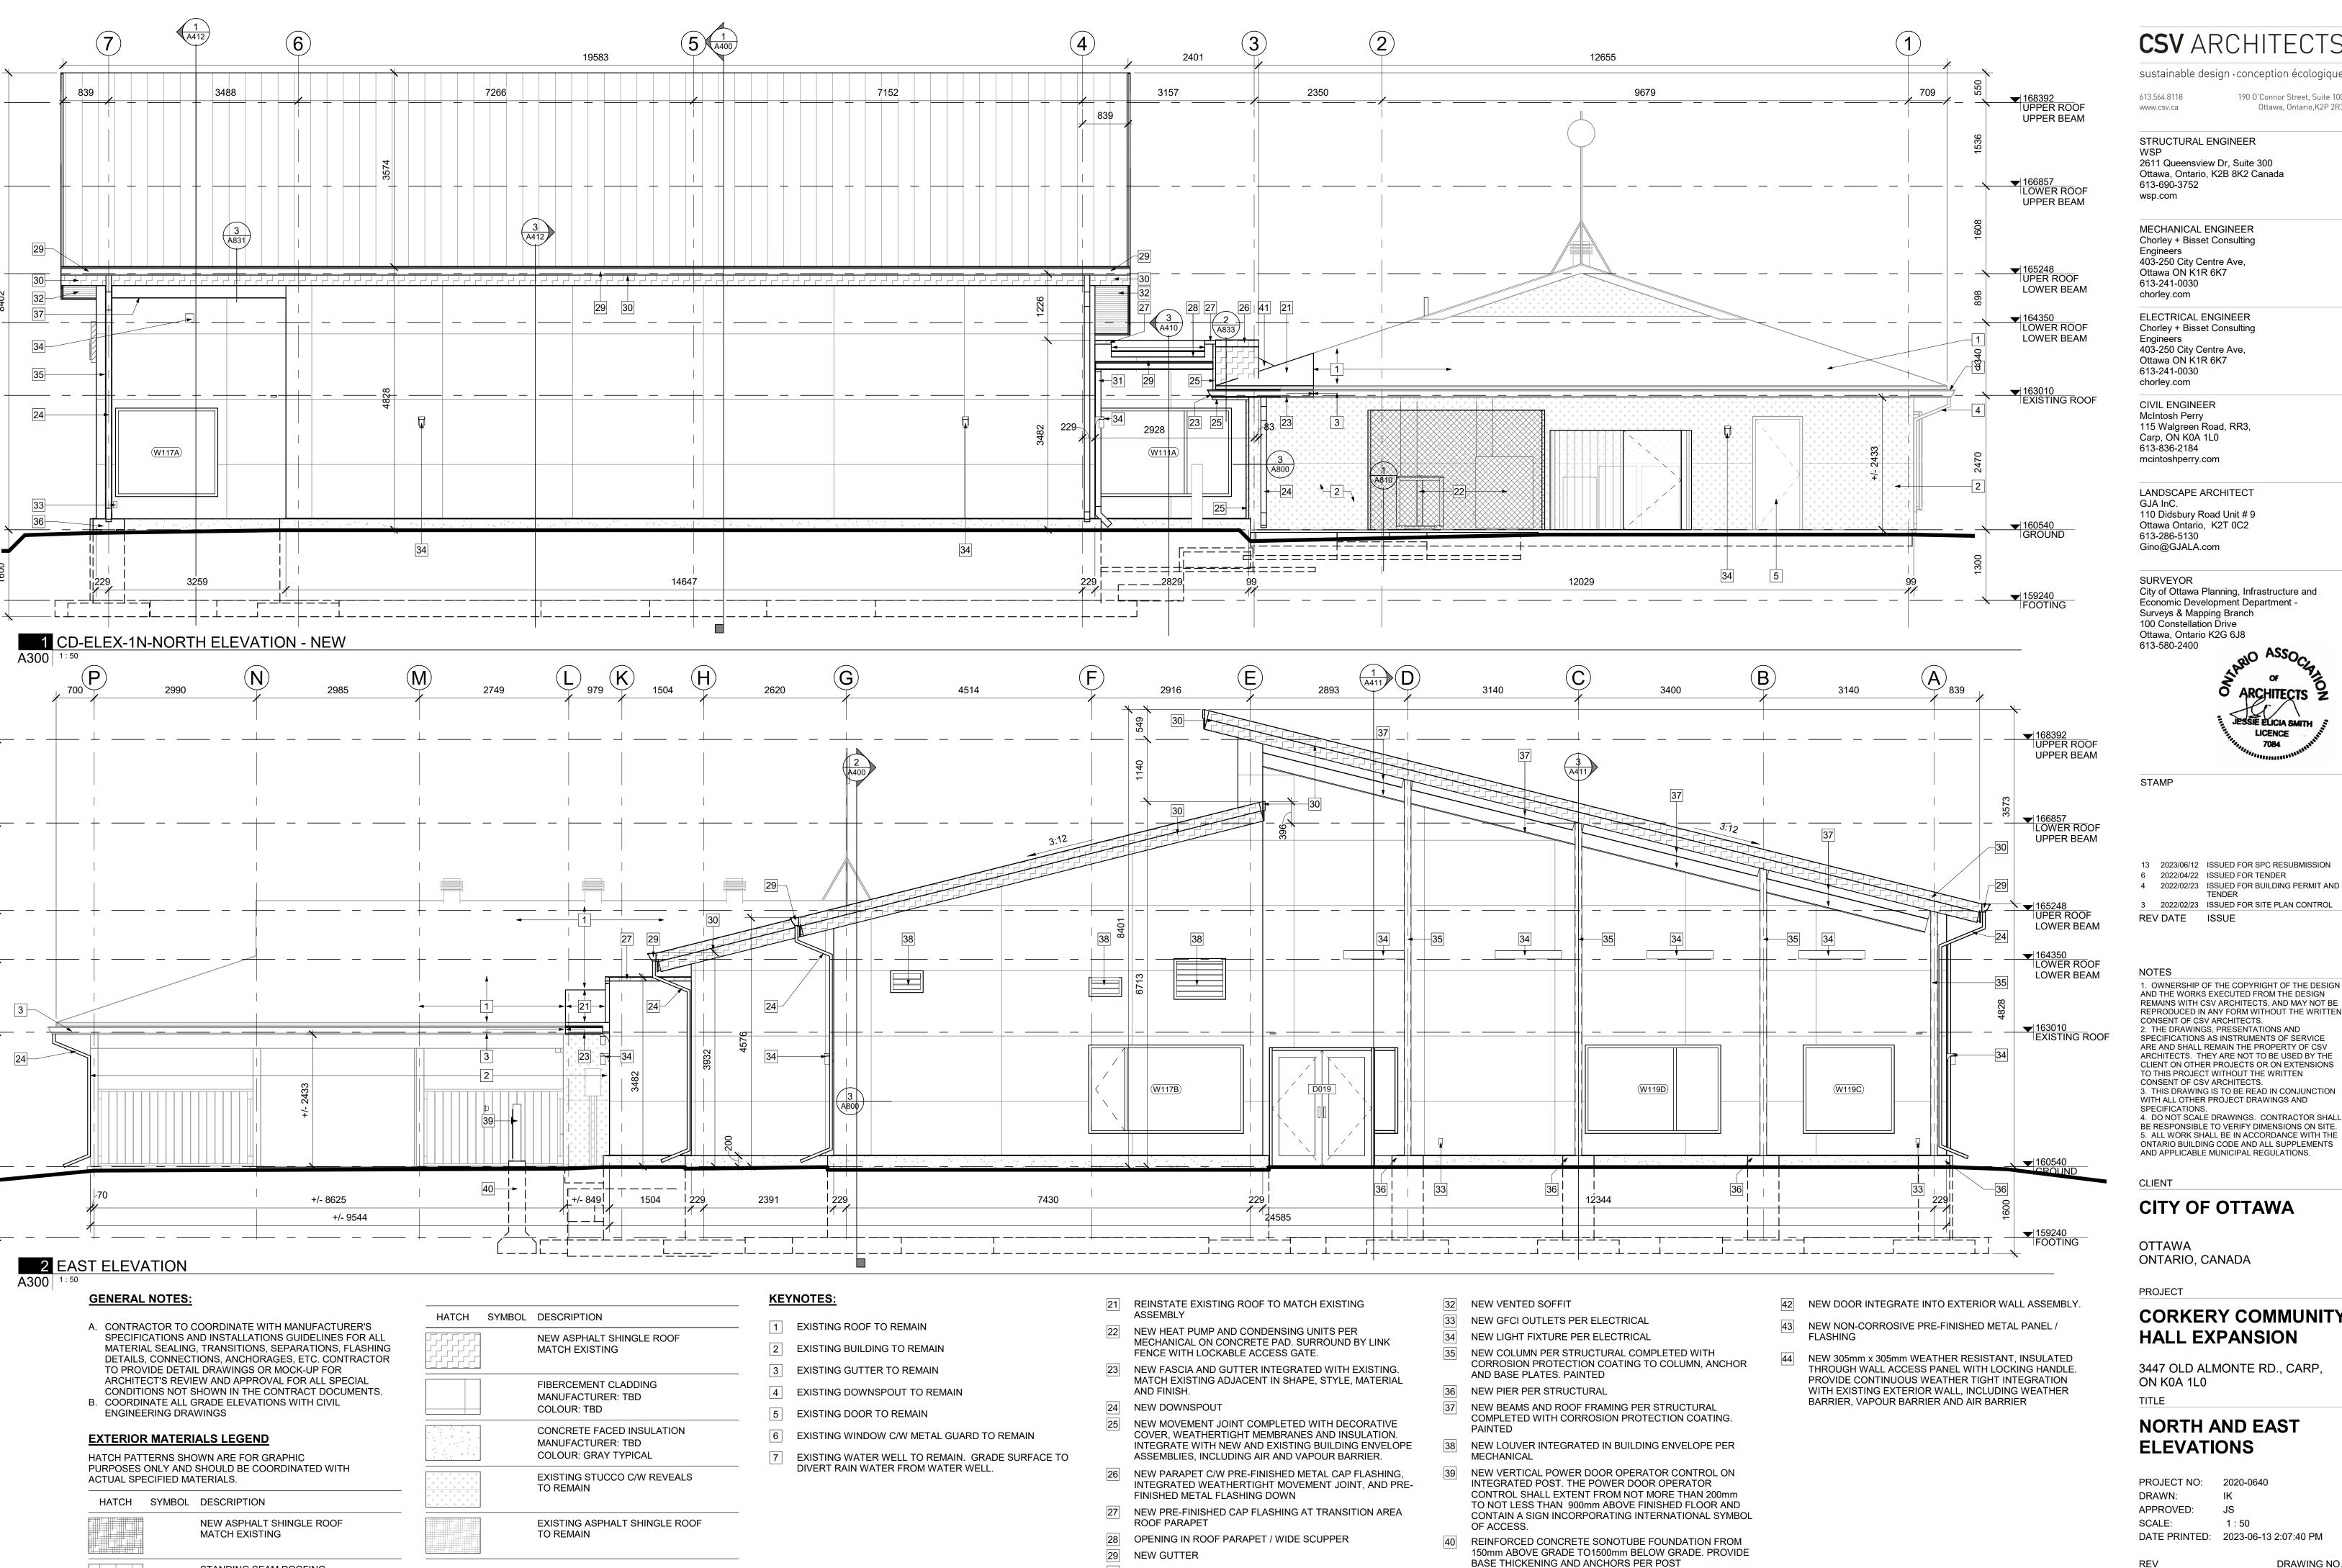

NEW NON-CORROSIVE PRE-FINISHED METAL FASCIA

OF WATER WELL

NEW DOWNSPOUT. EXTEND ALONG WALL AND DIVERT OUT

MANUFACTURER.

NEW ROOF CRICKET

STANDING SEAM ROOFING

MANUFACTURER: TBD

COLOUR: TBD

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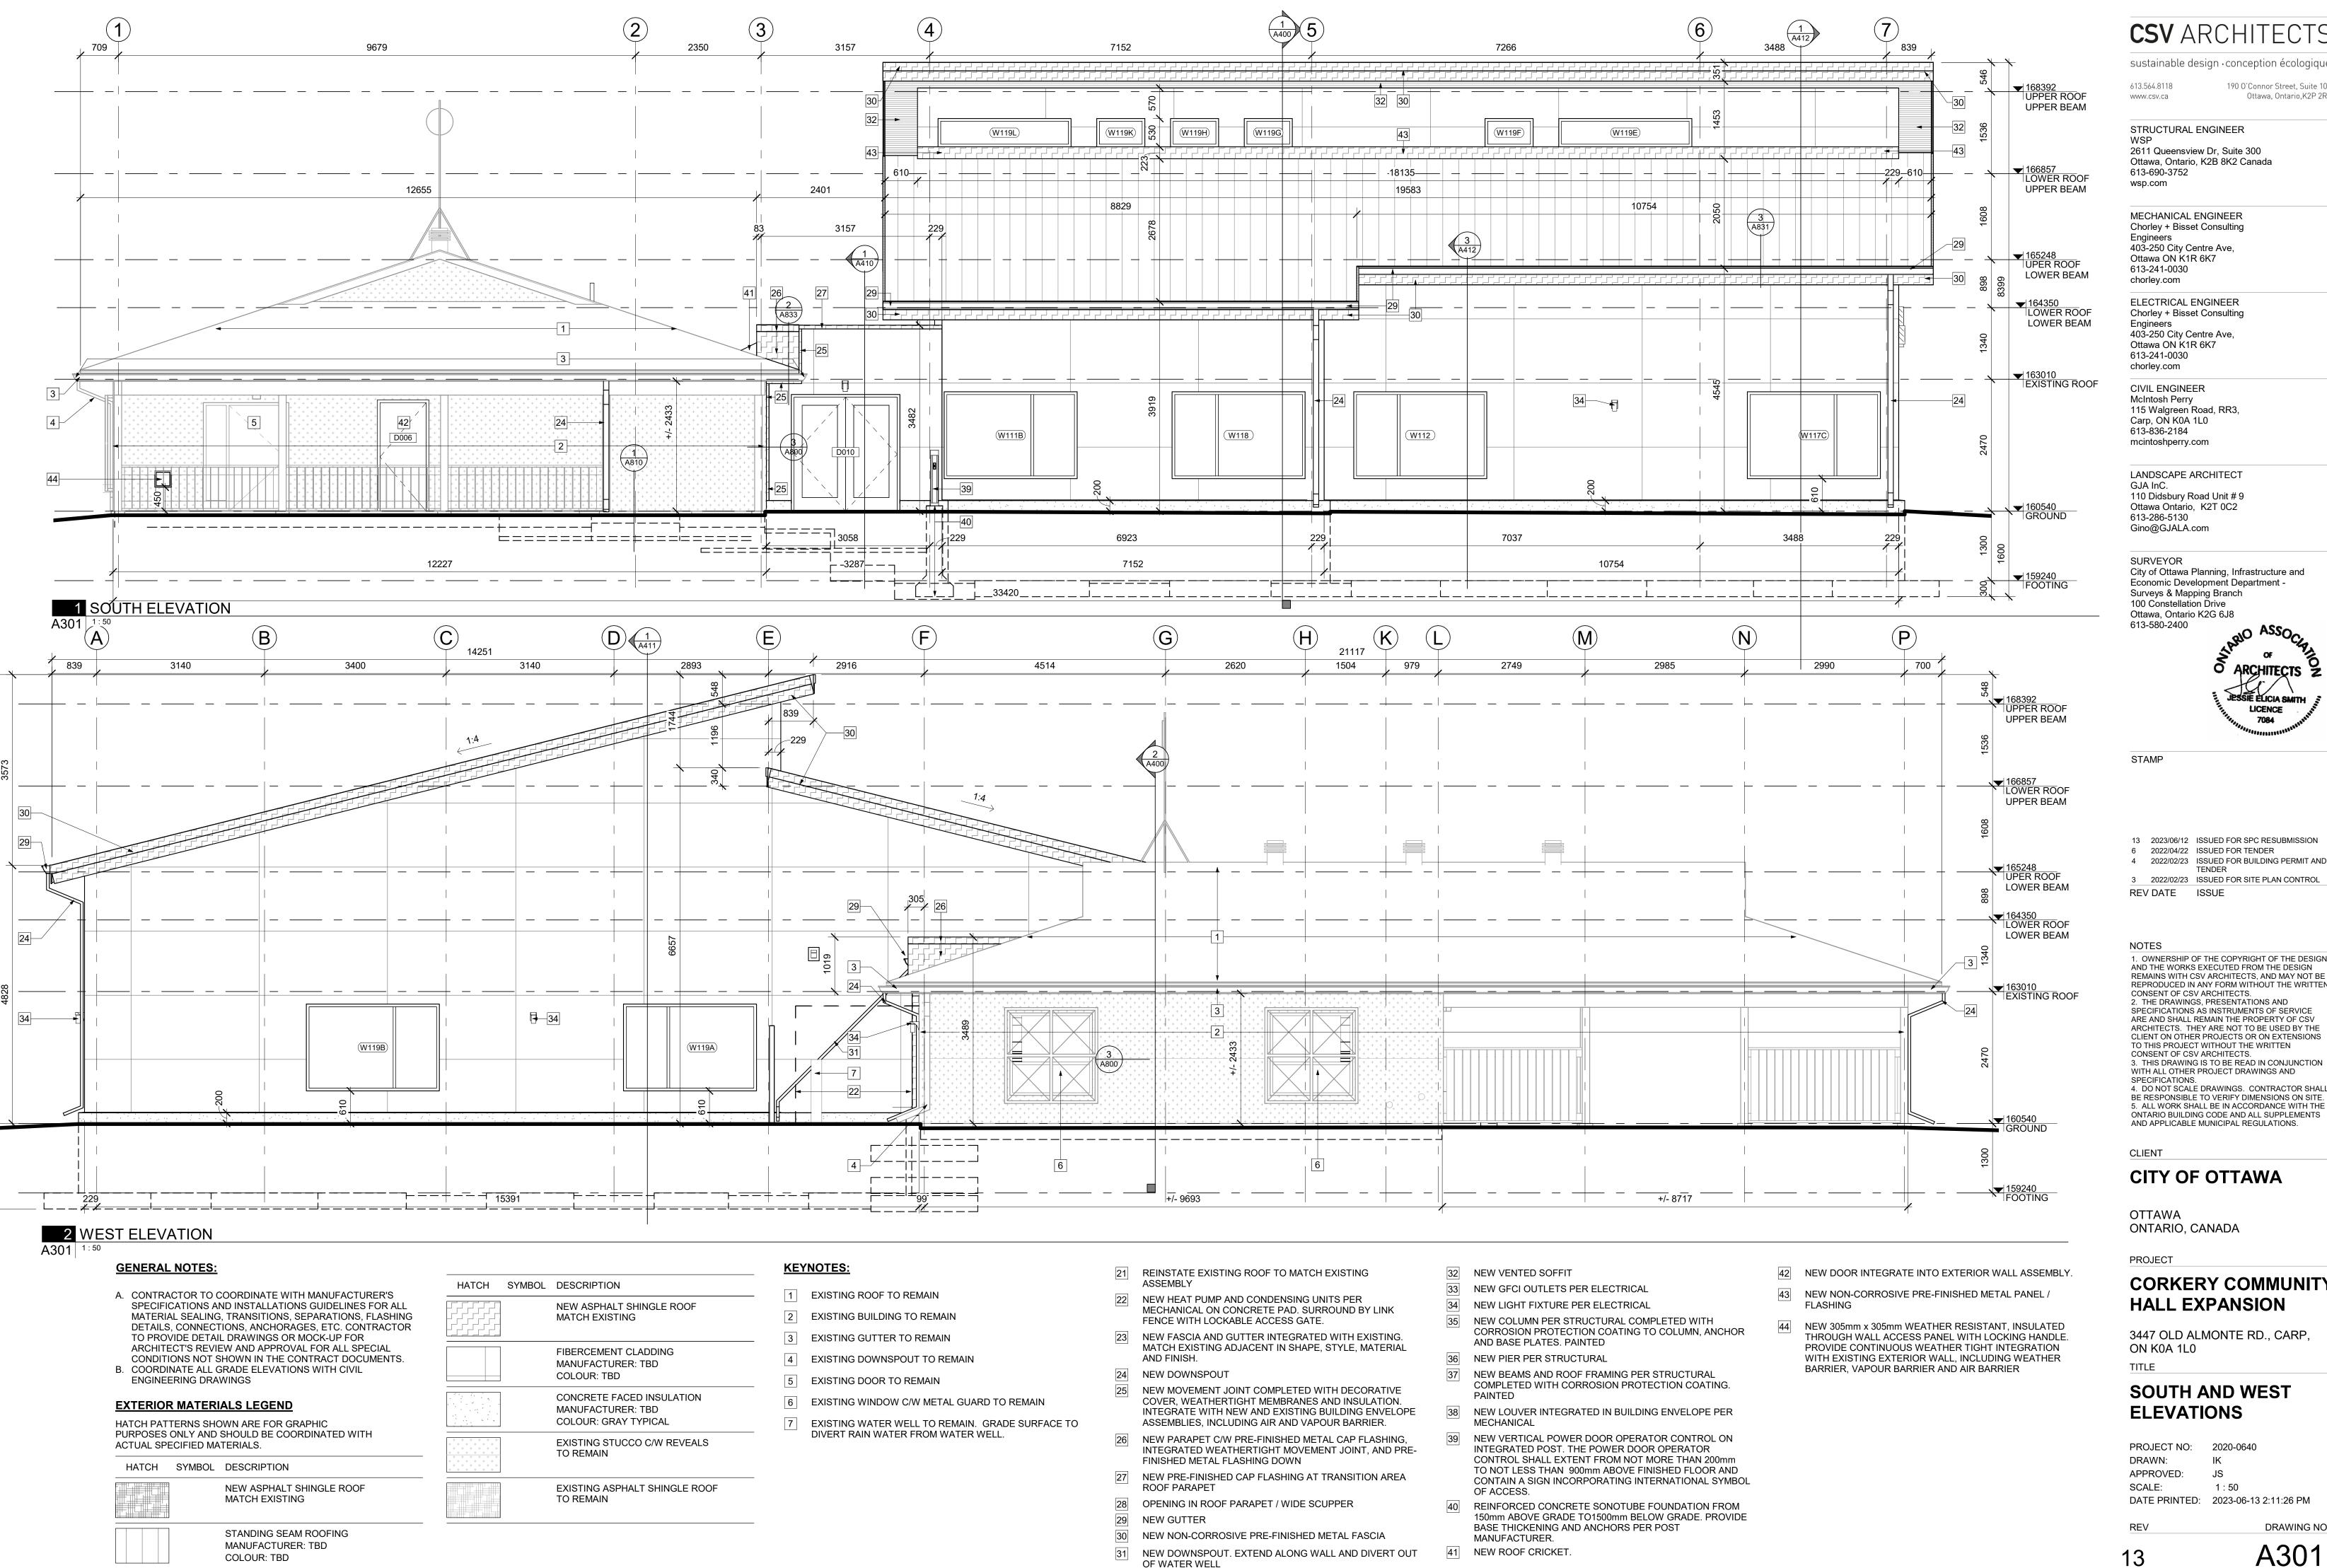
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### **NORTH AND EAST ELEVATIONS**

PROJECT NO: 2020-0640 DRAWN: APPROVED: JS 1:50

REV DRAWING NO.

A300



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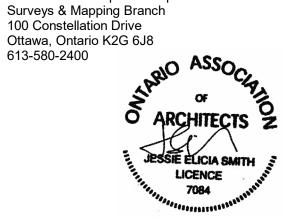
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OTTAWA ONTARIO, CANADA

## **CORKERY COMMUNITY** HALL EXPANSION

3447 OLD ALMONTE RD., CARP, ON K0A 1L0

### **SOUTH AND WEST ELEVATIONS**

PROJECT NO: 2020-0640 DRAWN: APPROVED: JS 1:50

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DRAWING NO.

A301