

# CARLING DEVELOPMENT

1240 CARLING, OTTAWA ON.
ISSUED FOR SITE PLAN CONTROL
2023-06-12 12:27:28 PM

ARCHITECTURAL DRAWINGS

STRUCTURAL DRAWINGS

PLANNER/LANDSCAPE




S.J. LAWRENCE ARCHITECT INC. 18 DEAKIN ST. SUITE 205 OTTAWA, ONTARIO K2E 8B7 (P) 613 739 7770 (F) 613 739 7703



CLELAND JARDINE ENGINEERING LIMITED 580 TERRY FOX DR. SUITE 200 KANATA, ONTARIO K2L 4B9 (P) 613 591 1533 (F) 613 591 1703



NOVATECH ENGINEERING CONSULTING LTD. 240 MICHAEL COWPLAND DRIVE, SUITE 101 OITTAWA, ONTARIO, K2M 1P6 (P) 613 254-9643 (F) 613 254-5867

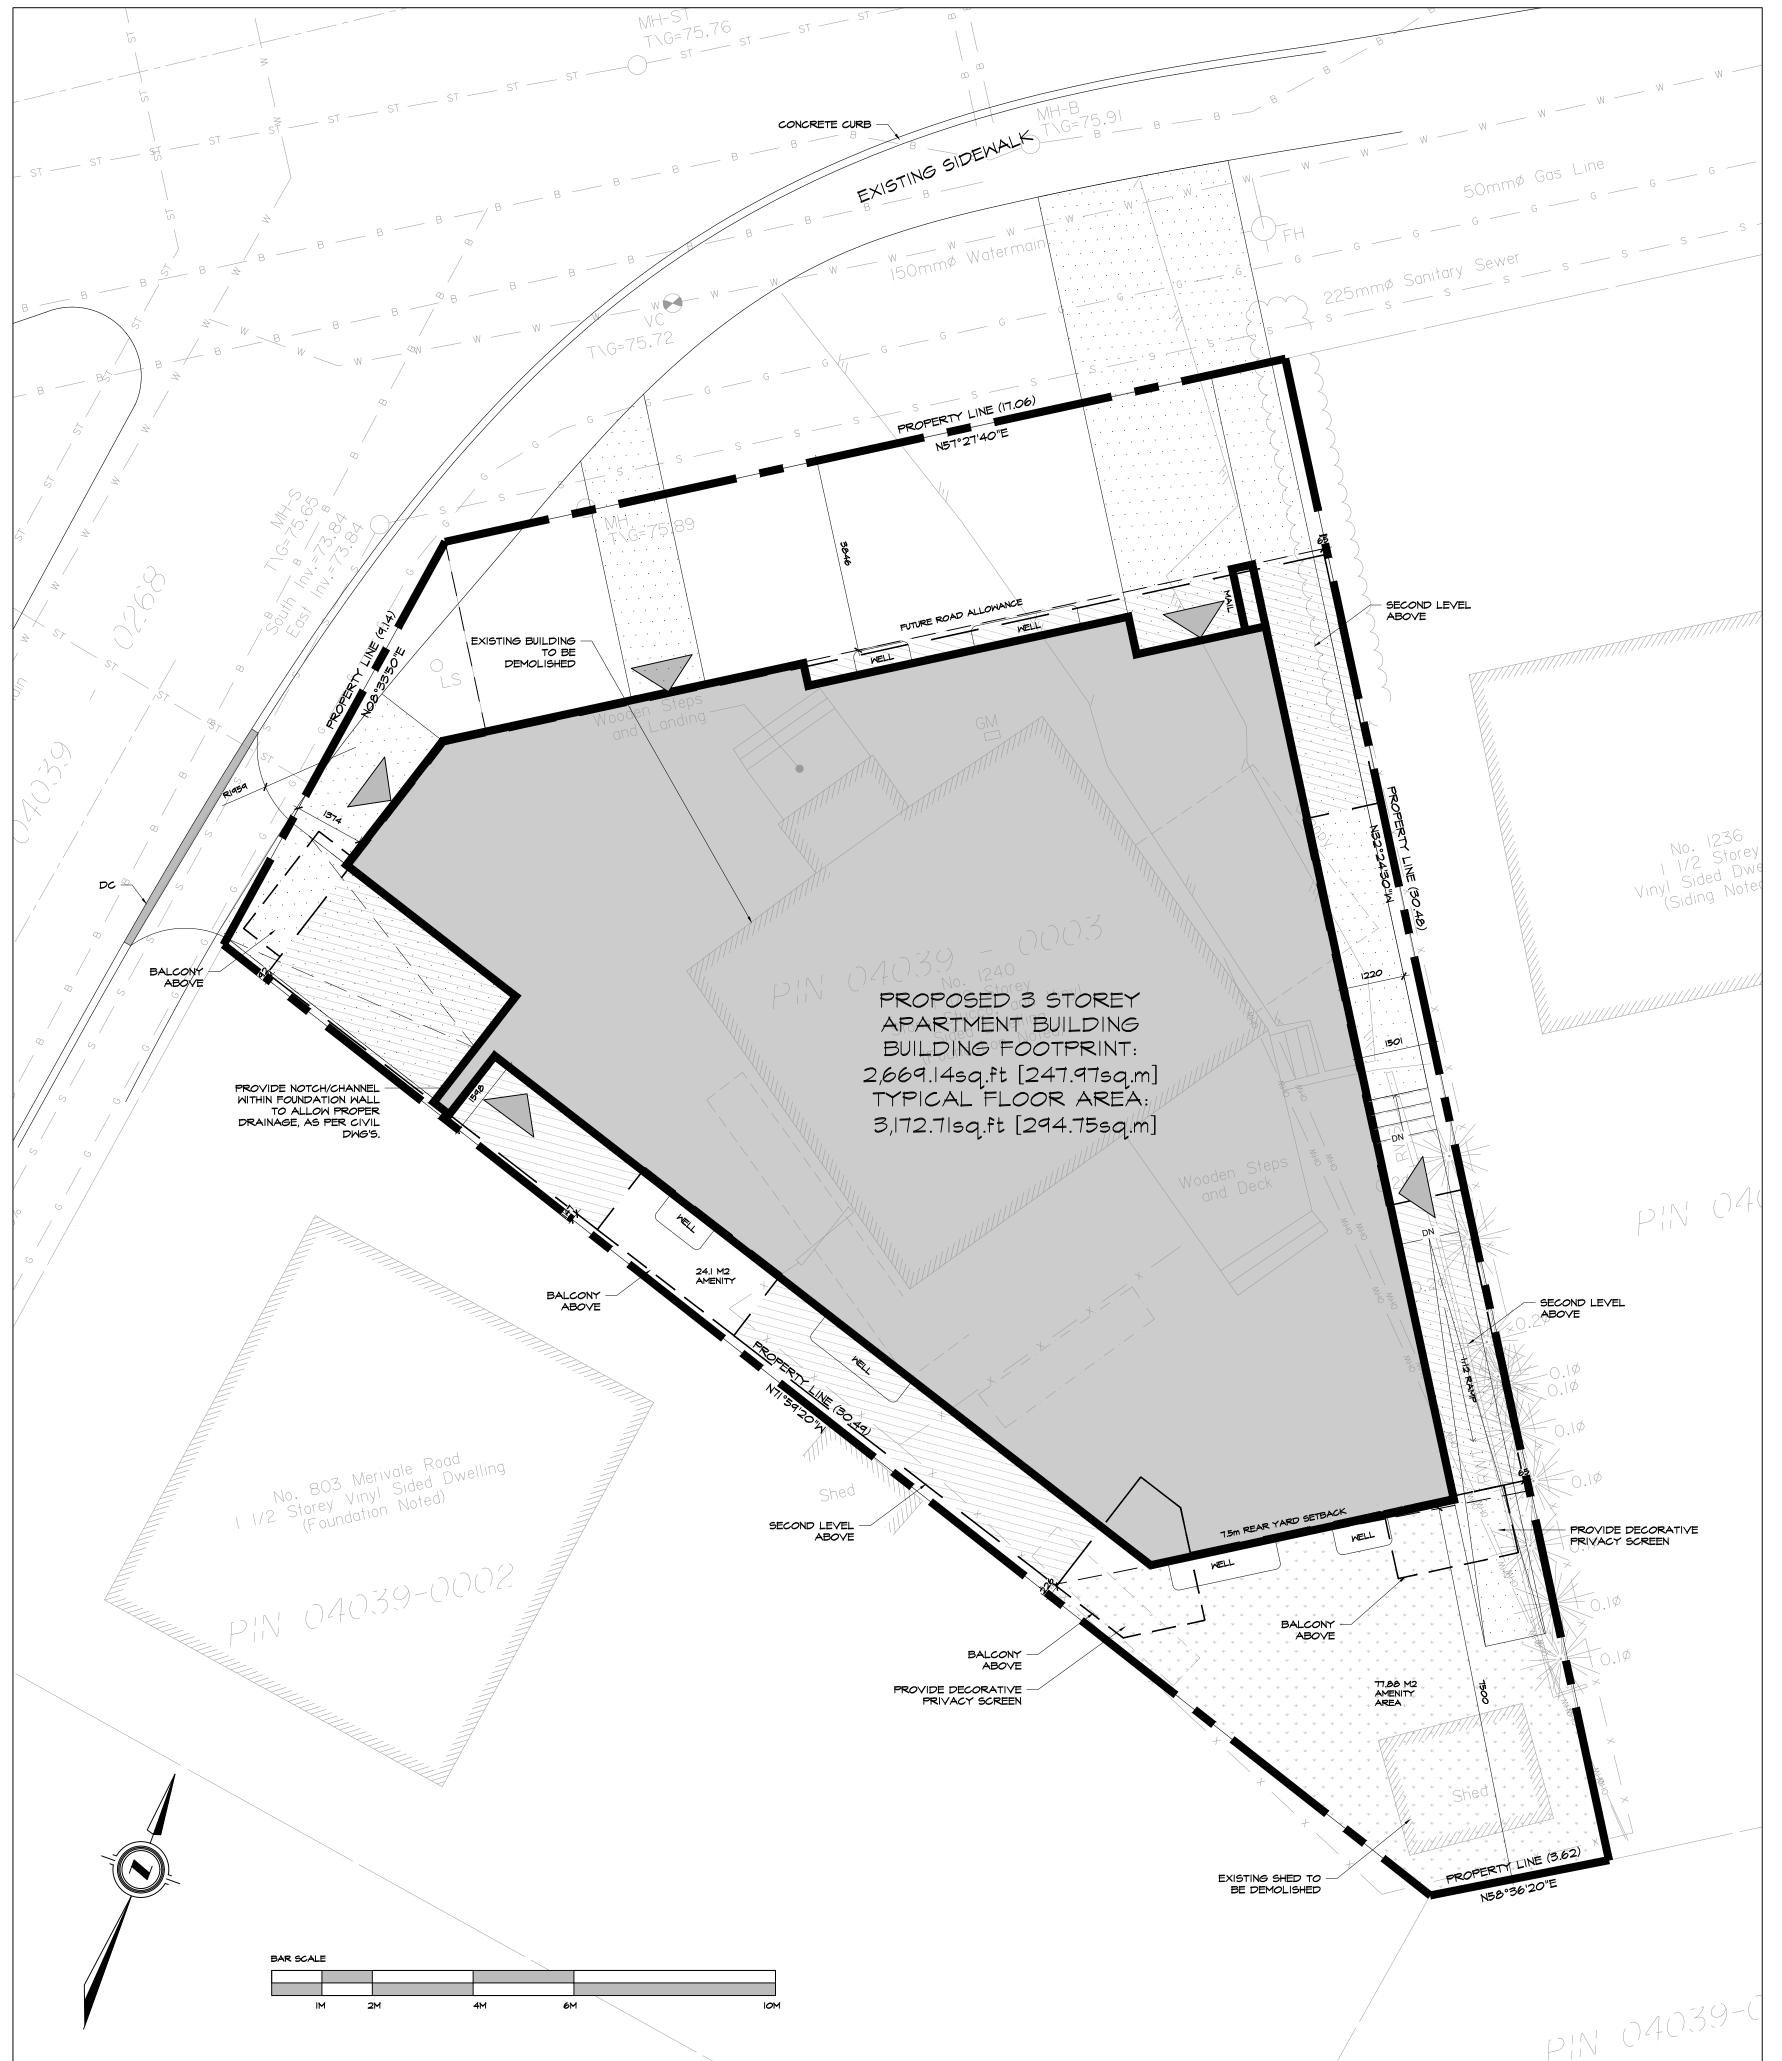



# KEY PLAN

TOPOGRAPHIC PLAN OF SURVEY OF LOT 3 REGISTERED PLAN 267570 CITY OF OTTAWA SURVEYED BY ANNIS, O'SULLIVAN, VOLLEBEKK LTD. DATED FEBRUARY 01, 2021

#### CITY OF OTTAWA ZONING BY-LAW

| ZONING PROVISIONS                                | REQUIRED  | PROPOSED   |  |
|--|---|--|--|
| AMIO [2197] H (11)                               |   |  |  |
| MIN. LOT AREA                                    | NO MINIMUM  | 451.6sq.m  |  |
| MIN. LOT DEPTH                                   | NO MINIMUM  | 32.5m  |  |
| MIN. LOT WIDTH                                   | NO MINIMUM  | 13.9m  |  |
| MIN. FRONT YARD<br>SETBACK                       | NO MINIMUM  | 3.85m  |  |
| MIN. INTERIOR CORNER<br>SIDE YARD SETBACK        | NO MINIMUM  | 1.37m  |  |
| MIN. INTERIOR SIDE YARD<br>SETBACK               | NO MINIMUM  | EAST 0.065m<br>WEST 0.092m                                   |  |
| MIN. REAR YARD SETBACK                           | 7.5m  | 7.5m   |  |
| MAX. BUILDING HEIGHT                             | Ilm   | ± IIm  |  |
| MAX. FLOOR SPACE INDEX                           | NO MAXIMUM  | ± 1.58m  |  |
| AMENITY AREA                                     | 6sq.m PER UNIT<br>X 18 = 108sq.m  | COMMUNAL AREA:<br>77.88sq.m                                  |  |
|  | 50% COMMUNAL<br>=54sq.m   | PRIVATE AMENITY<br>33.77sq.m<br>TOTAL AMENITY:<br>III.65sq.m |  |
| LOT COVERAGE                                     | N/A   | 55.1%  |  |
| FRONT WALL FRONTAGE<br>REQUIREMENT               | 50% OF FRONT<br>WALL WITHIN 4.5M<br>OF FRONTAGE                               | 84%  |  |
| ACTIVE ENTRANCES FACING<br>PUBLIC STREETS (MIN.) | I   | I  |  |
| GLAZING REQUIREMENTS<br>(MIN.)                   | 50% SURFACE<br>AREA OF<br>GROUND FLOOR<br>FACADE FACING<br>A PUBLIC<br>STREET | 53.1%  |  |
| AUTOMOBII E PARKING                              | SIMMARY   |  |  |

| AUTOMOBILE PARKING      | SUMMARY                             |                 |  |
|-------------------------|-------------------------------------|-----------------|--|
| REQUIRED PARKING        | REQUIRED                            | PROPOSED        |  |
| RESIDENT PARKING        | NOT REQUIRED                        | 0               |  |
| VISITOR PARKING         | O.I/UNIT (AFTER 12)<br>= I REQUIRED | 1               |  |
| TOTAL PROVIDED          | O SPACES                            | I SPACE         |  |
| PROVIDED PARKING        |                                     |                 |  |
|                         |                                     | ABOVE GROUND    |  |
| REGULAR SPACE           | MIN. 2.6m × 5.2m                    | 1               |  |
| TOTAL                   | =   PROVIDED PARKING SPACE          |                 |  |
| BICYCLE PARKING SUMMARY |                                     |                 |  |
| REQUIRED PARKING        | REQUIRED                            | PROPOSED        |  |
| BIKE PARKING            | 0.5/UNIT X 18= 9<br>SPACES          | 10 OR 20 STACKE |  |

ACUB ENTERPRISE INC

3) DO NOT SCALE DRAWINGS.

NEW OVERHEAD DOOR

NEW DOOR/ENTRANCE

PROPOSED RIVERSTONE MULCH

EXISTING VEGETATION REFER TO LANDSCAPE DWGS

BICYCLE PARKING SPACE

PROPOSED PRECAST CONCRETE PAVERS PROPOSED SOD - REFER TO LANDSCAPE DWGS

NEW SAWCUT CONCRETE SIDEWALK

PARKING STALL COUNT PER ROW

NEW SIGN, REFER TO SIGN LEGEND

DESIGNATED ACCESSIBLE PARKING SPACE

AS PER AODA STANDARDS

TWO WAY TRAFFIC

DEPRESSED CURB [DC]

MINIMUM SETBACKS [ZONING]

NEW CONSTRUCTION ABOVE

\*REFER TO LANDSCAPE DWGS

PROPERTY LINE

EXISTING FENCE

NEW CONSTRUCTION

EXISTING BUILDINGS

[1.8mXO.6m]

STREET LIGHT

HYDRO POST

NO PARKING LINES

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5) NOTIFY SHAWN J. LAWRENCE ARCHITECT FOR ANY ERRORS AND/OR OMISSIONS PRIOR TO START OF WORK.

S.J.LAWRENCE ARCHITECT INCORPORATED 18 DEAKIN STREET SUITE 205 OTTAWA, ONTARIO K2E 8B7 T: (613) 739.7770 F: (613) 739.7703

sjl@sjlarchitect.com



NORTH ARROW:

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CARLING DEVELOPMENT

05. 2023.06.12 ISSUED FOR SPC

04. 2023.04.03 ISSUED FOR COORDINATION 03. 2022.11.07 | ISSUED FOR CITY PRE-CONSULT

02. 2021.06.15 | ISSUED FOR REVIEW

No. DATE REVISION

1240 CARLING, OTTAWA ON

SHEET TITLE: SITE PLAN

CHECKED BY: S.J.L DRAWN BY: PLOT DATE: 2023.06.12 PROJECT DATE: 2021.04.15 SCALE: AS SHOWN JOB NUMBER: SL-1053-21

SHEET NUMBER:

A1.0 #

APPLICATION #

O1 CONCEPT SITE PLAN
A100 SCALE: 1:75

#### AcuB ENTERPRISE INC

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OF OF O ARCHITECTS Z
SHAWN JAMES LAWRENCE
LICENCE
LICE

08 2023.06.12 ISSUED FOR SPC 07 2023.05.04 ISSUED FOR COORDINATION 06 2023.04.04 ISSUED FOR COORDINATION 05 2022.12.07 ISSUED FOR COORDINATION

18 DEAKIN STREET SUITE 205 OTTAWA, ONTARIO K2E 8B7

No. DATE REVISION

T: (613) 739.7770 F: (613) 739.7703 sjl@sjlarchitect.com

03 | 2022.09.15 | ISSUED FOR REVIEW 02 2021.09.28 ISSUED FOR REVIEW 01 2021.05.26 ISSUED FOR REVIEW

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CARLING DEVELOPMENT

1240 CARLING, OTTAWA ON.


FOUNDATION PLAN

SL-1053-21

PLOT DATE: 2023-06-12 12:17:10 PM JOB NUMBER:

SCALE: 1/4" = 1'-0" **A2.0** 

CHECKED BY: **B.L. S.J.L.** 

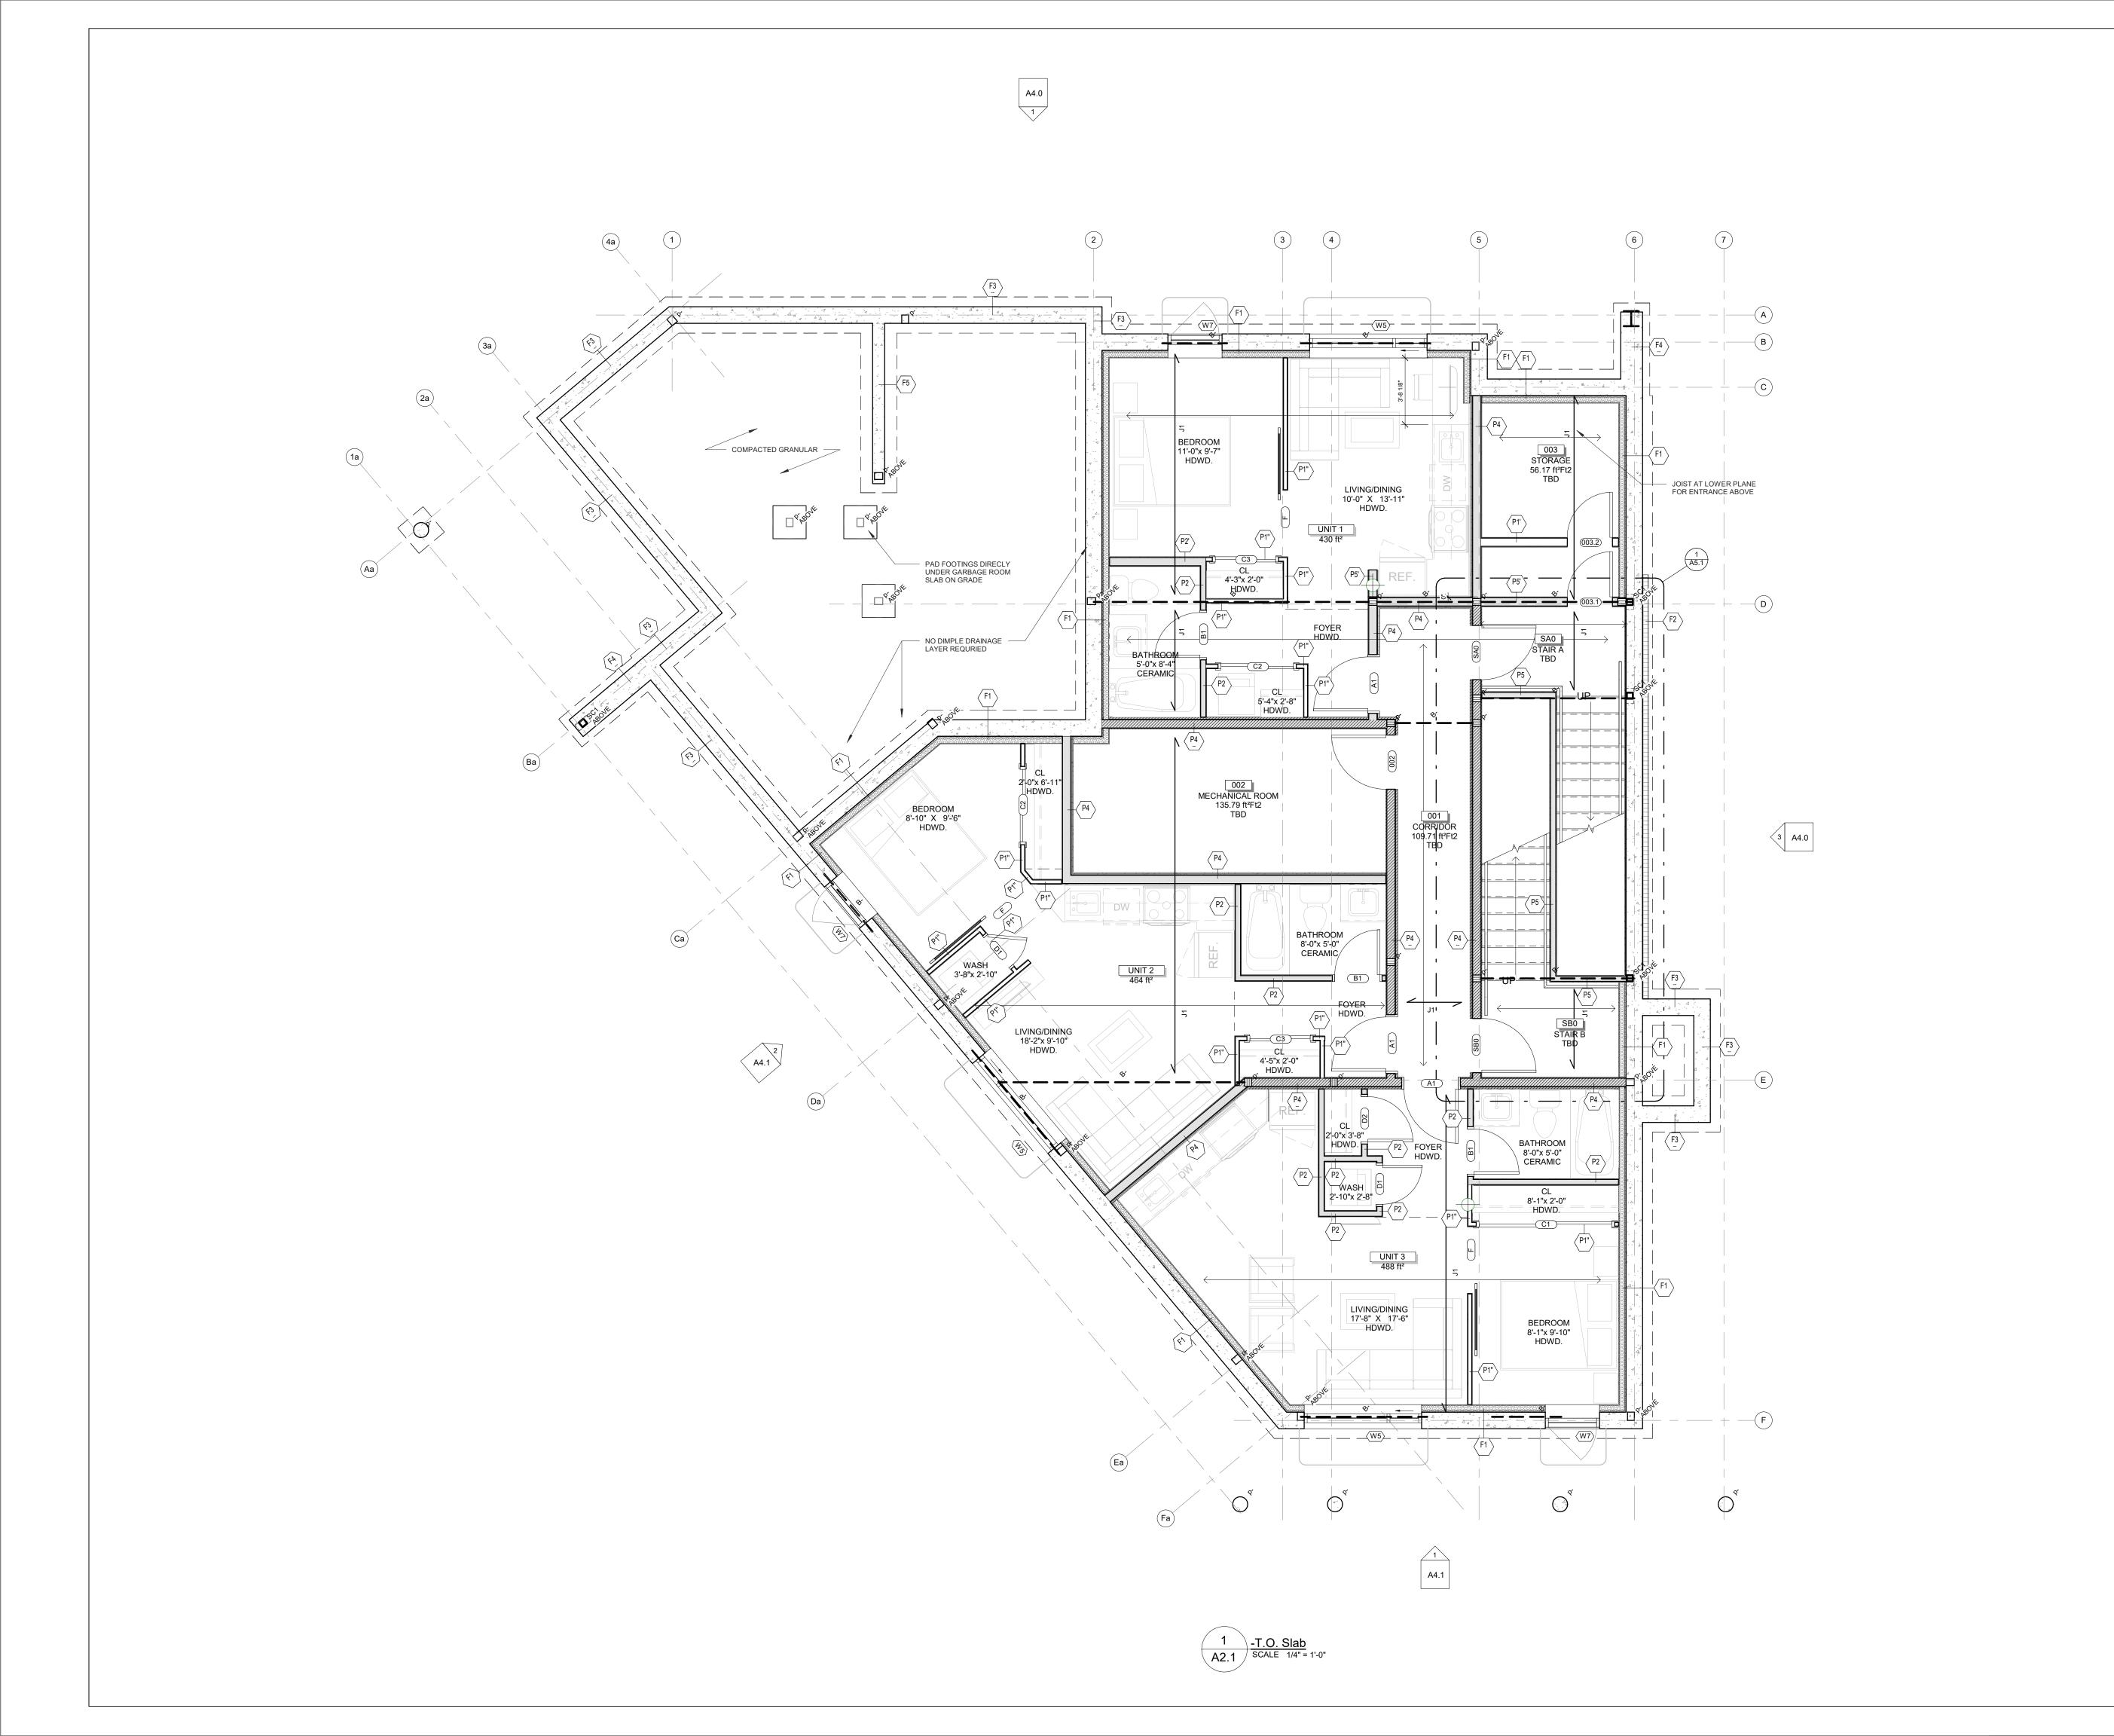

Area Schedule (Gross Building)

Area

429.60 ft<sup>2</sup>

464.03 ft<sup>2</sup>

488.32 ft<sup>2</sup>

424.05 ft<sup>2</sup>

635.21 ft<sup>2</sup>

490.61 ft<sup>2</sup>

337.81 ft<sup>2</sup>

347.52 ft<sup>2</sup>

540.82 ft<sup>2</sup>

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540.82 ft<sup>2</sup>

421.61 ft<sup>2</sup>

688.77 ft<sup>2</sup>

688.77 ft<sup>2</sup>

389.10 ft<sup>2</sup>

389.17 ft<sup>2</sup> LEVEL 3

1 BED UNIT 1

UNIT 3

UNIT 4

UNIT 5

UNIT 6

UNIT 8

UNIT 9

UNIT 10

UNIT 12

UNIT 14

UNIT 15

UNIT 18

2 BED

UNIT 7

UNIT 13

BACHELOR UNIT 11

WALL LEGEND

LOAD BEARING WALL

INSULATED WALL (REFER TO WALL ASSEMBLIES)

Level

BASEMENT

BASEMENT

BASEMENT

LEVEL 1

LEVEL 1

LEVEL 1

LEVEL 2

LEVEL 2

LEVEL 2

LEVEL 2

LEVEL 3

LEVEL 3

LEVEL 3

LEVEL 3

LEVEL 2

LEVEL 3

LEVEL 2

#### Acub enterprise inc

NOTES:

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ACCURACY.

MEASUREMENTS AND BE RESPONSIBLE FOR THEIR ACCURACY

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O ARCHITIFETS Z

SHAWN JAMES LAWRENCE LICENCE LICENCE 4442 NORTH ARROW:

S.J.LAWRENCE
ARCHITECT
INCORPORATED

18 DEAKIN STREET
SUITE 205
OTTAWA, ONTARIO
K2E 8B7

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PROJECT:

CARLING DEVELOPMENT

1240 CARLING, OTTAWA ON.

SHEET TITLE:

BASEMENT PLAN


PLOT DATE: 2023-06-12 12:17:14 PM JOB NUMBER:

SL-1053-21

A2.1

CHECKED BY: B.L. S.J.L.

As indicated

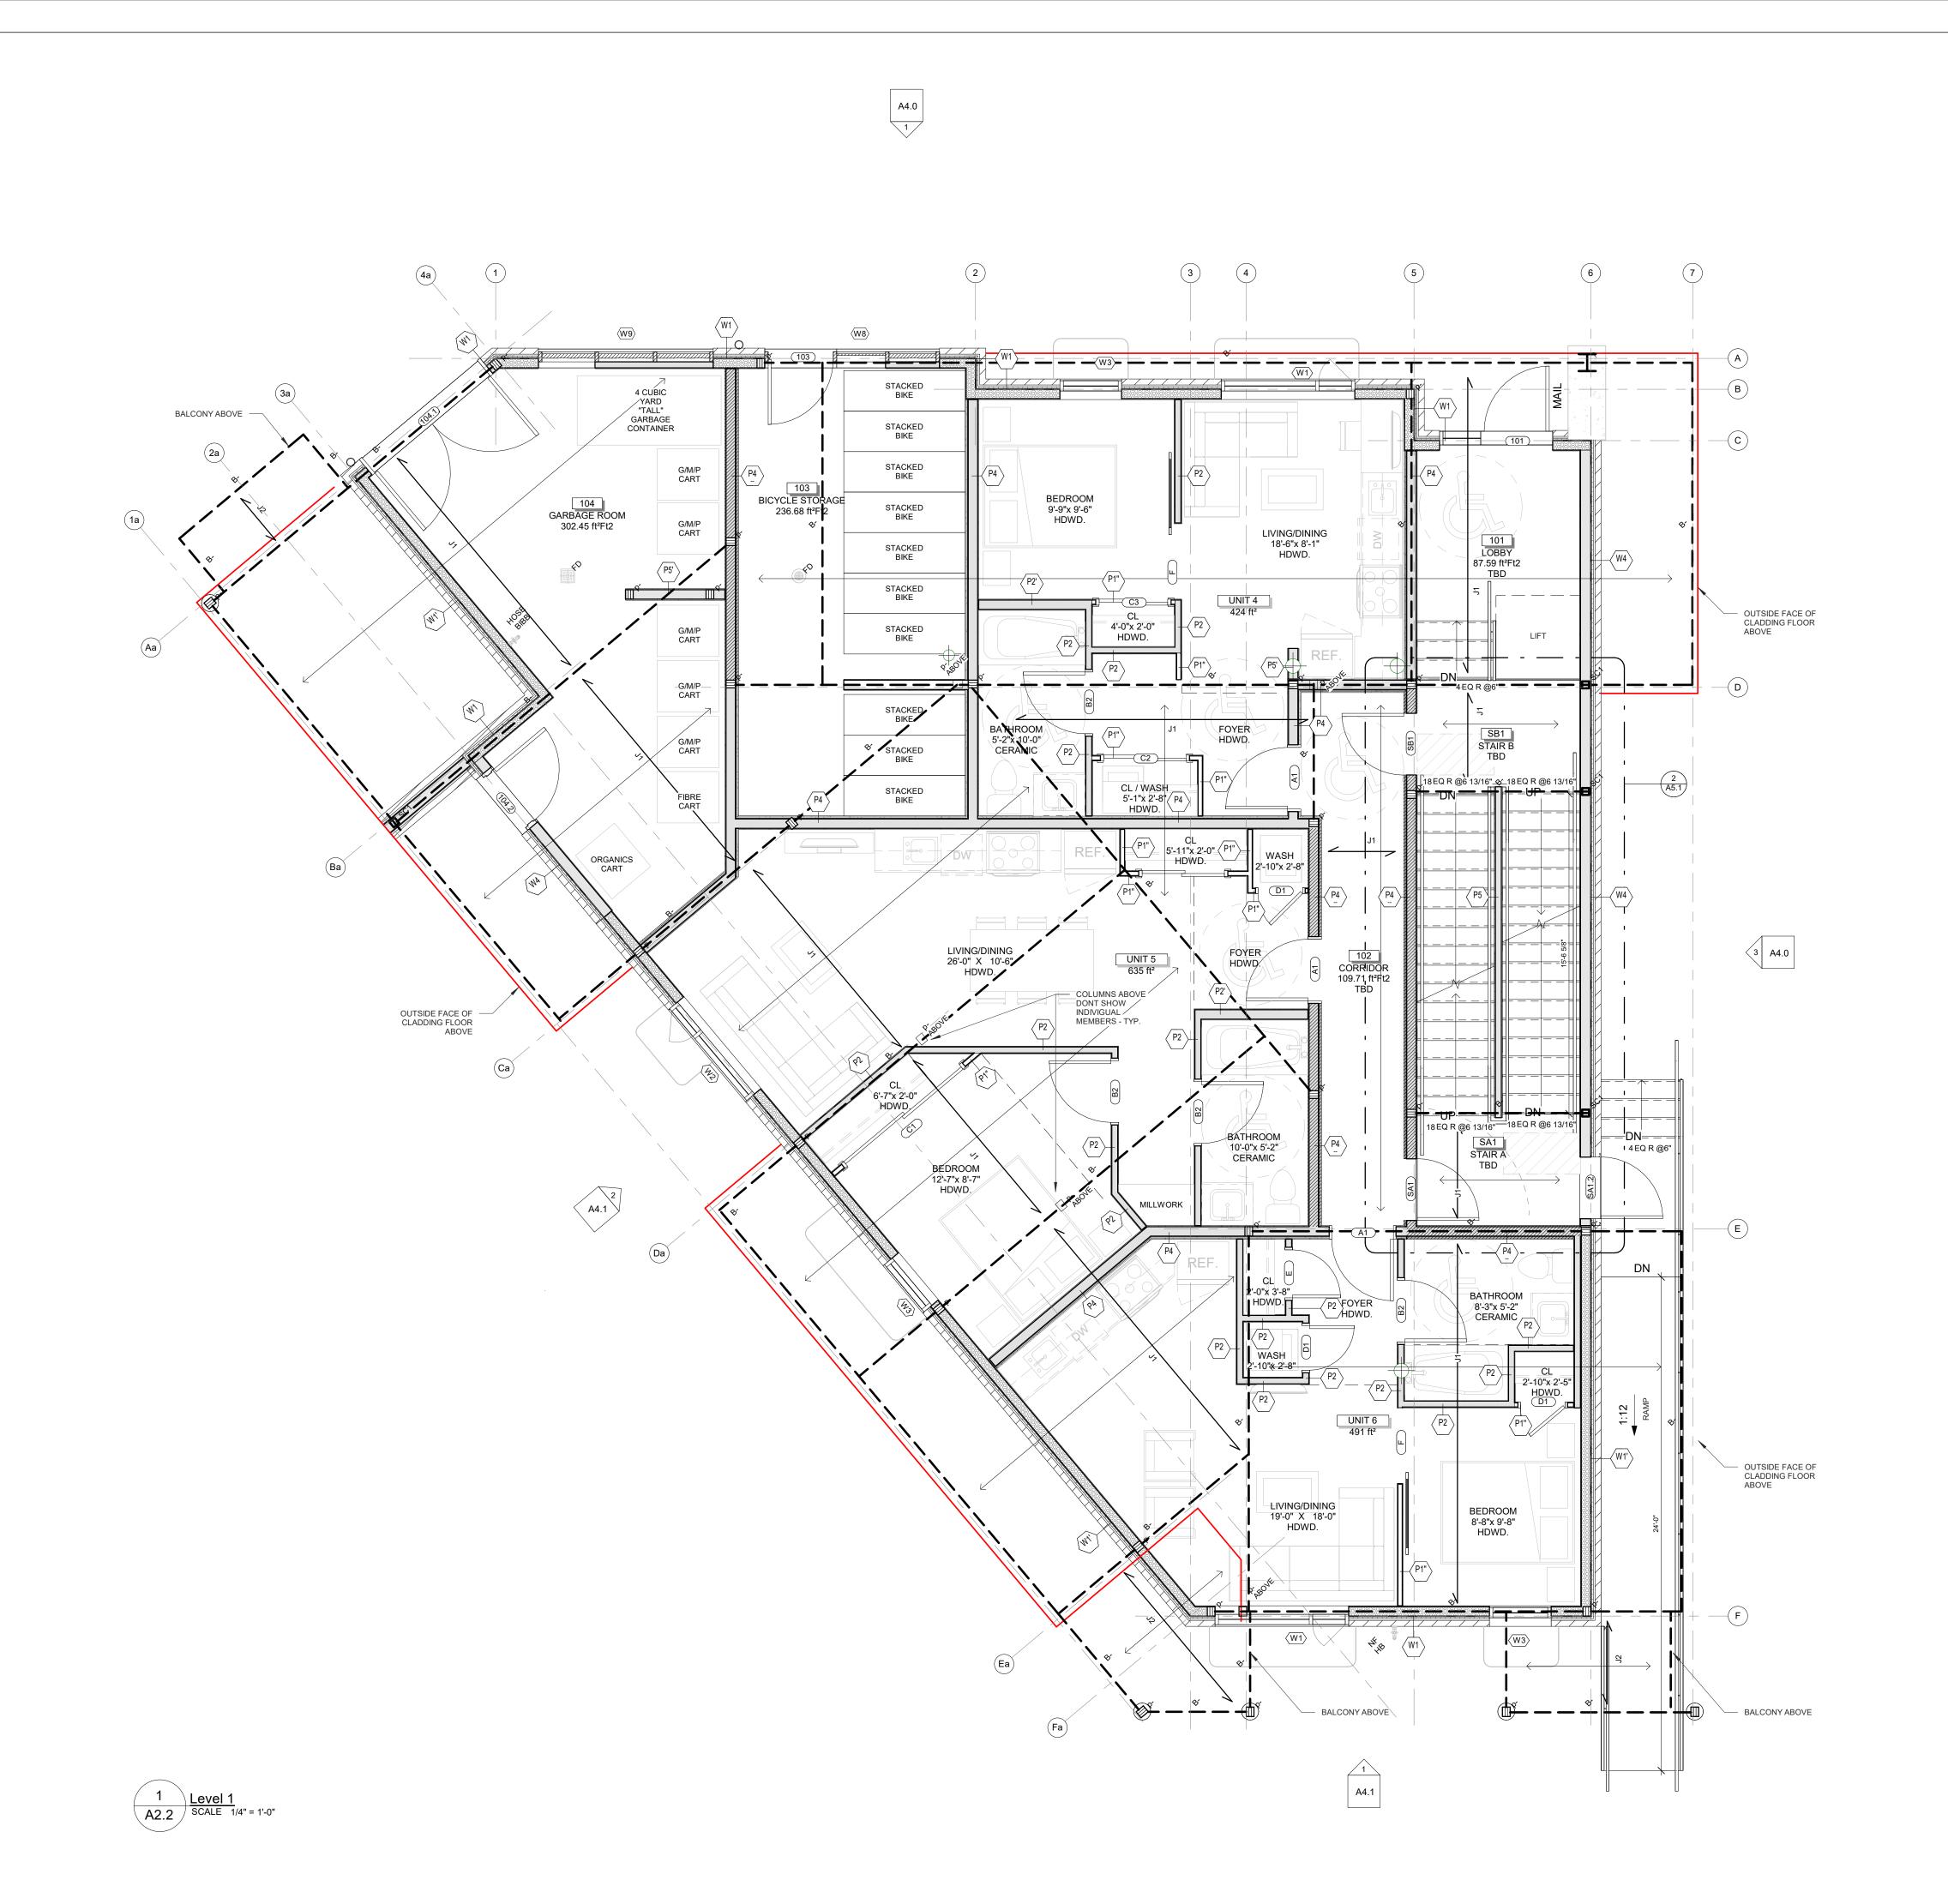

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WALL LEGEND

1 BED UNIT 1

UNIT 3

UNIT 4

UNIT 5

UNIT 6

UNIT 8

UNIT 9

UNIT 10

UNIT 12

UNIT 14

UNIT 15

UNIT 18

UNIT 13

UNIT 11

BACHELOR

2 BED UNIT 7

LOAD BEARING WALL

INSULATED WALL (REFER TO WALL ASSEMBLIES)

Area Schedule (Gross Building)

Area

429.60 ft<sup>2</sup>

464.03 ft<sup>2</sup>

488.32 ft<sup>2</sup>

424.05 ft<sup>2</sup>

635.21 ft<sup>2</sup>

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688.77 ft<sup>2</sup>

688.77 ft<sup>2</sup>

389.10 ft<sup>2</sup>

389.17 ft<sup>2</sup> LEVEL 3

Level

BASEMENT

BASEMENT

BASEMENT

LEVEL 1

LEVEL 1

LEVEL 1

LEVEL 2

LEVEL 2

LEVEL 2

LEVEL 2

LEVEL 3


LEVEL 3 LEVEL 3

LEVEL 3

LEVEL 2

LEVEL 3

LEVEL 2

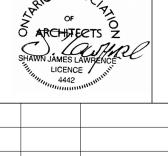

NORTH ARROW:

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02 | 2021.09.28 | ISSUED FOR REVIEW 01 | 2021.05.26 | ISSUED FOR REVIEW

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CARLING DEVELOPMENT


1240 CARLING, OTTAWA ON.

**GROUND FLOOR PLAN** 

CHECKED BY: B.L. S.J.L. DRAWN **D.T.** 

2023-06-12 12:17:17 PM JOB NUMBER: SL-1053-21 As indicated

**A2.2** 

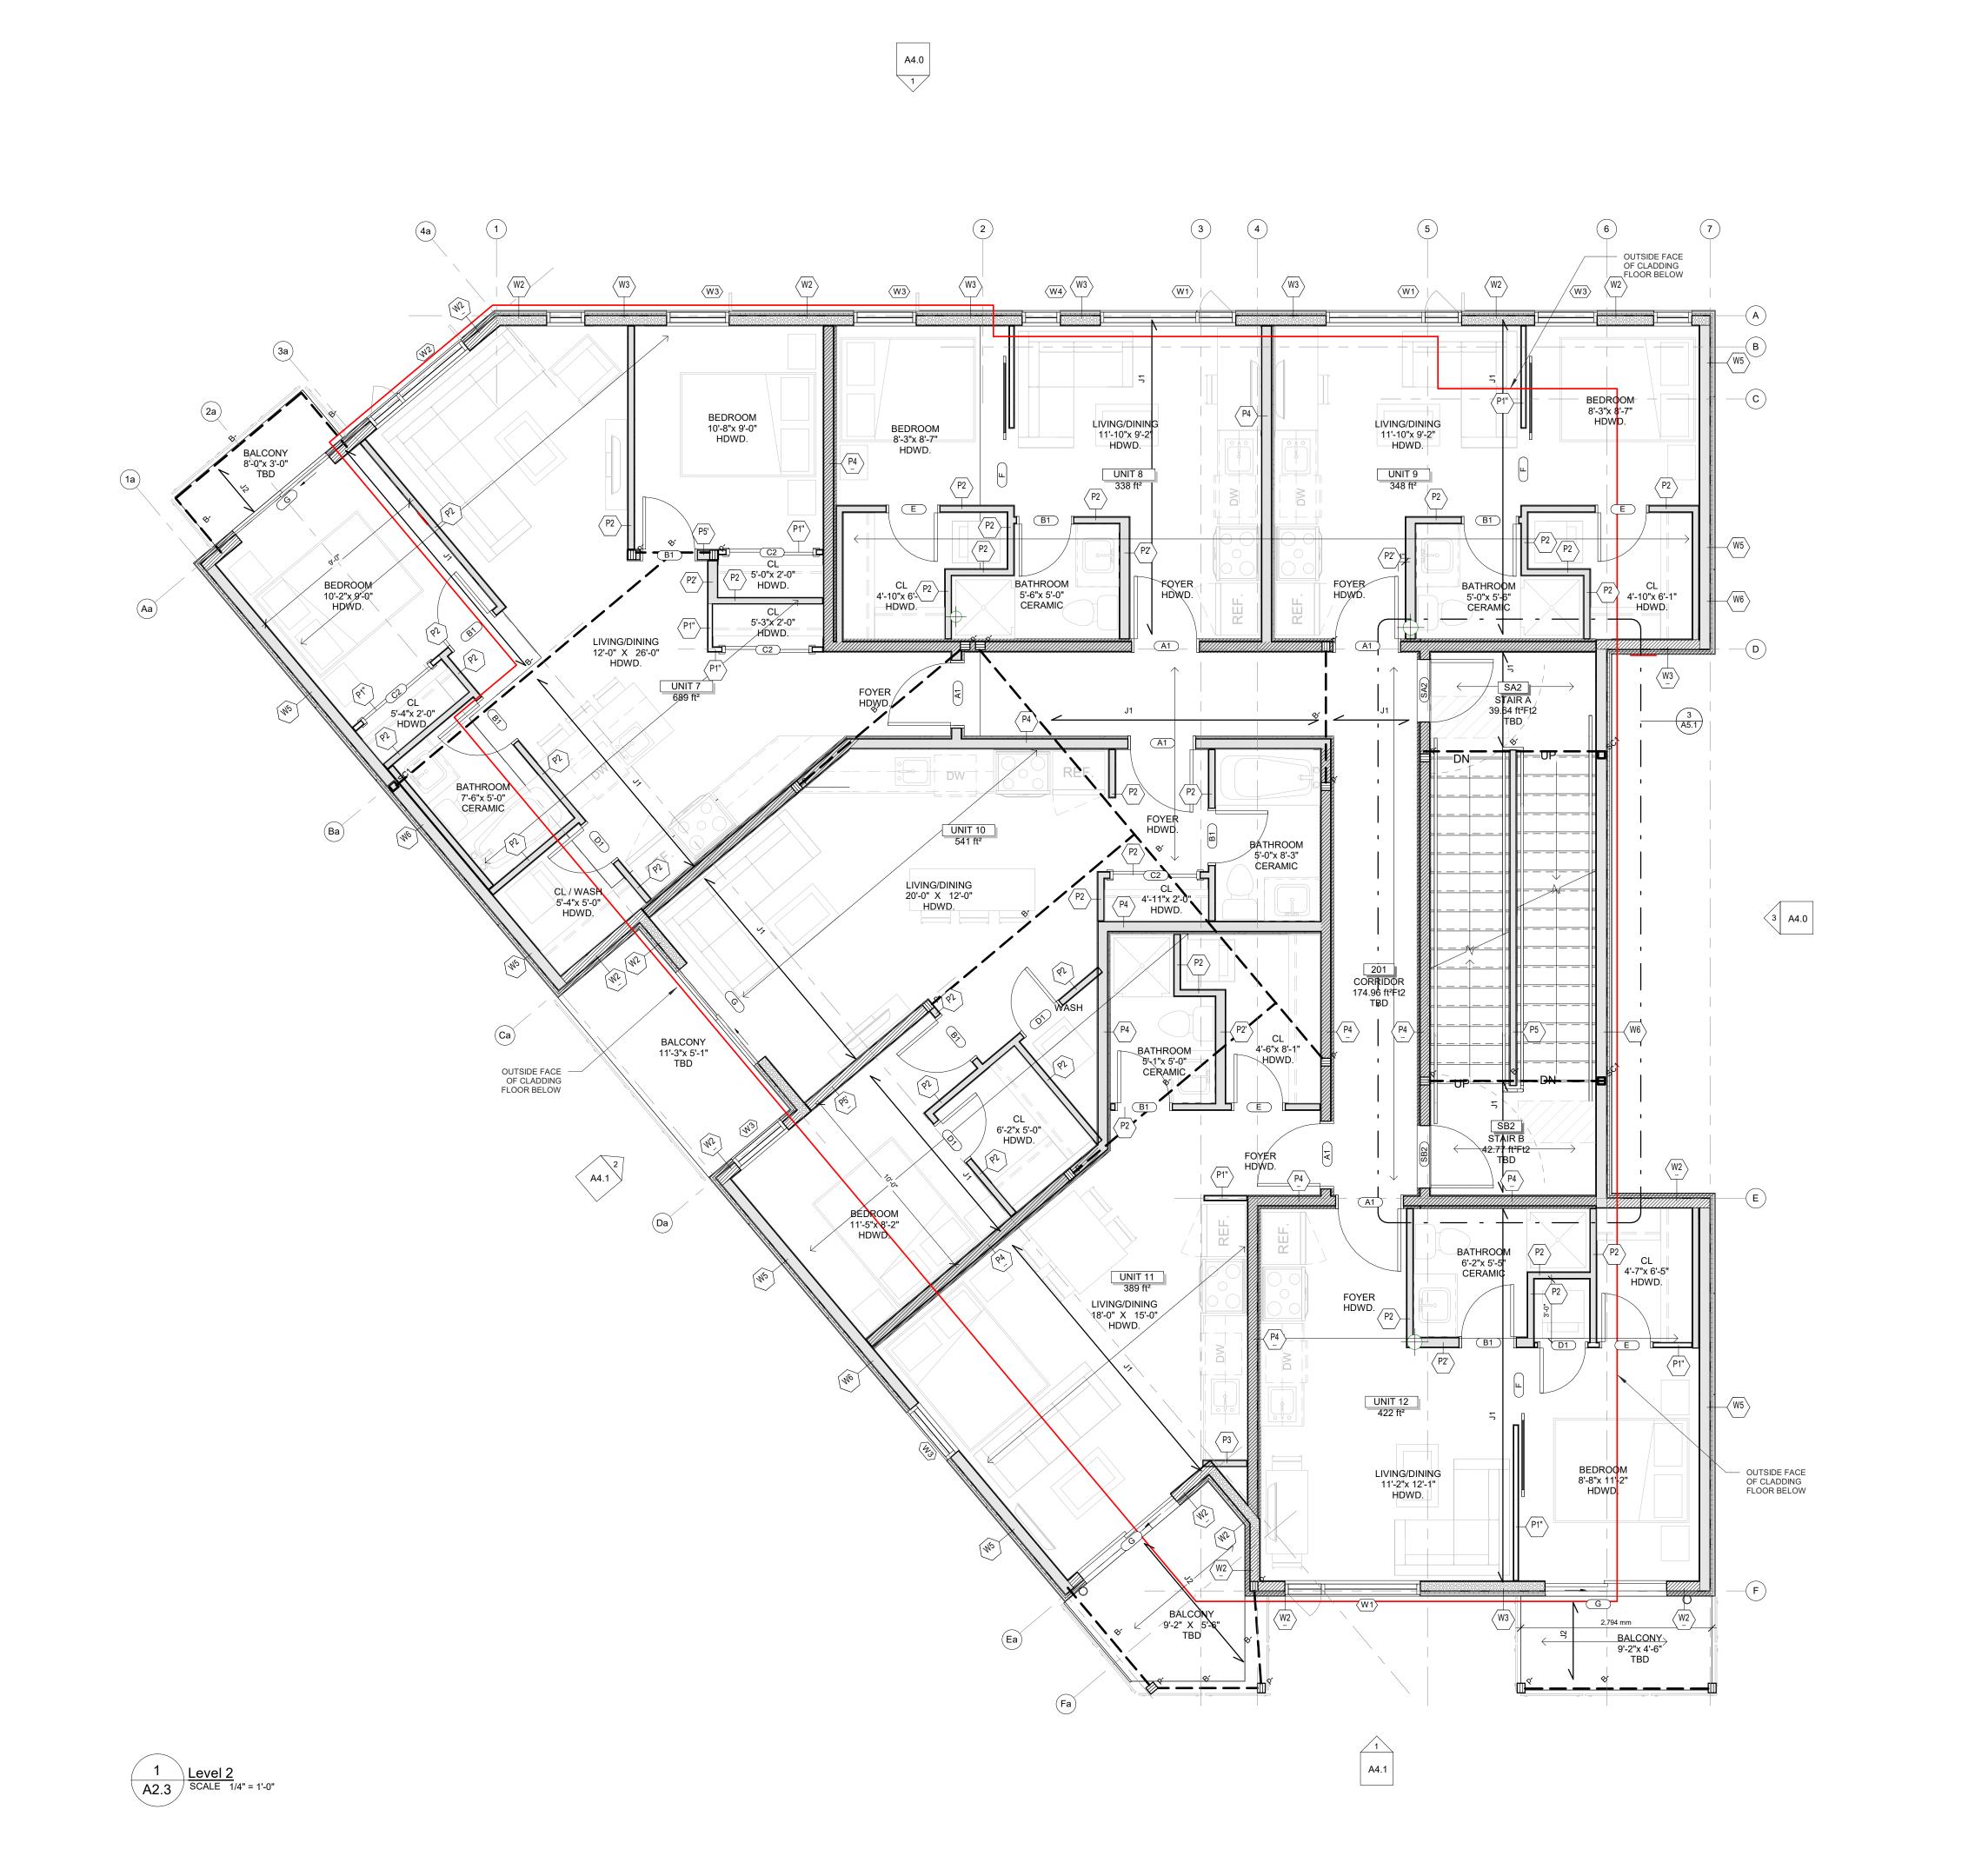

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ACCURACY

ACCURACY

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389.17 ft<sup>2</sup> LEVEL 3

Area Schedule (Gross Building)

Area

429.60 ft<sup>2</sup>

464.03 ft<sup>2</sup>

488.32 ft<sup>2</sup>

424.05 ft<sup>2</sup>

635.21 ft<sup>2</sup>

490.61 ft<sup>2</sup>

337.81 ft<sup>2</sup>

347.52 ft<sup>2</sup>

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389.10 ft<sup>2</sup>

1 BED UNIT 1

UNIT 2

UNIT 3

UNIT 4

UNIT 5

UNIT 6

UNIT 8

UNIT 9

UNIT 10

UNIT 12

UNIT 14

UNIT 15

UNIT 18

UNIT 13

BACHELOR UNIT 11

WALL LEGEND

LOAD BEARING WALL

INSULATED WALL (REFER TO WALL ASSEMBLIES)

2 BED UNIT 7 Level

BASEMENT

BASEMENT

BASEMENT

LEVEL 1

LEVEL 1

LEVEL 1

LEVEL 2

LEVEL 2

LEVEL 2

LEVEL 2

LEVEL 3

LEVEL 3

LEVEL 3

LEVEL 2

LEVEL 3

LEVEL 2

### SHAWN JAMES LAWBENCE LICENCE LICENCE LICENCE LICENCE HIGH 4442 A 1442 A 144

04 2022.11.07 ISSUED FOR CITY PRE-CONSULT

03 2022.09.15 ISSUED FOR REVIEW
 02 2021.09.28 ISSUED FOR REVIEW
 01 2021.05.26 ISSUED FOR REVIEW

NORTH ARROW:

S.J.LAWRENCE ARCHITECT INCORPORATED

18 DEAKIN STREET SUITE 205 OTTAWA, ONTARIO K2E 8B7

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PROJECT:

CARLING DEVELOPMENT

1240 CARLING, OTTAWA ON.

SHEET TITLE:
SECOND FLOOR PLAN

PLOT DATE: 2023-06-12 12:17:19 PM

JOB NUMBER:


DRAWN **D.T**.

SL-1053-21

SCALE: As indicated

**A2.3** 

CHECKED BY: B.L. S.J.L.

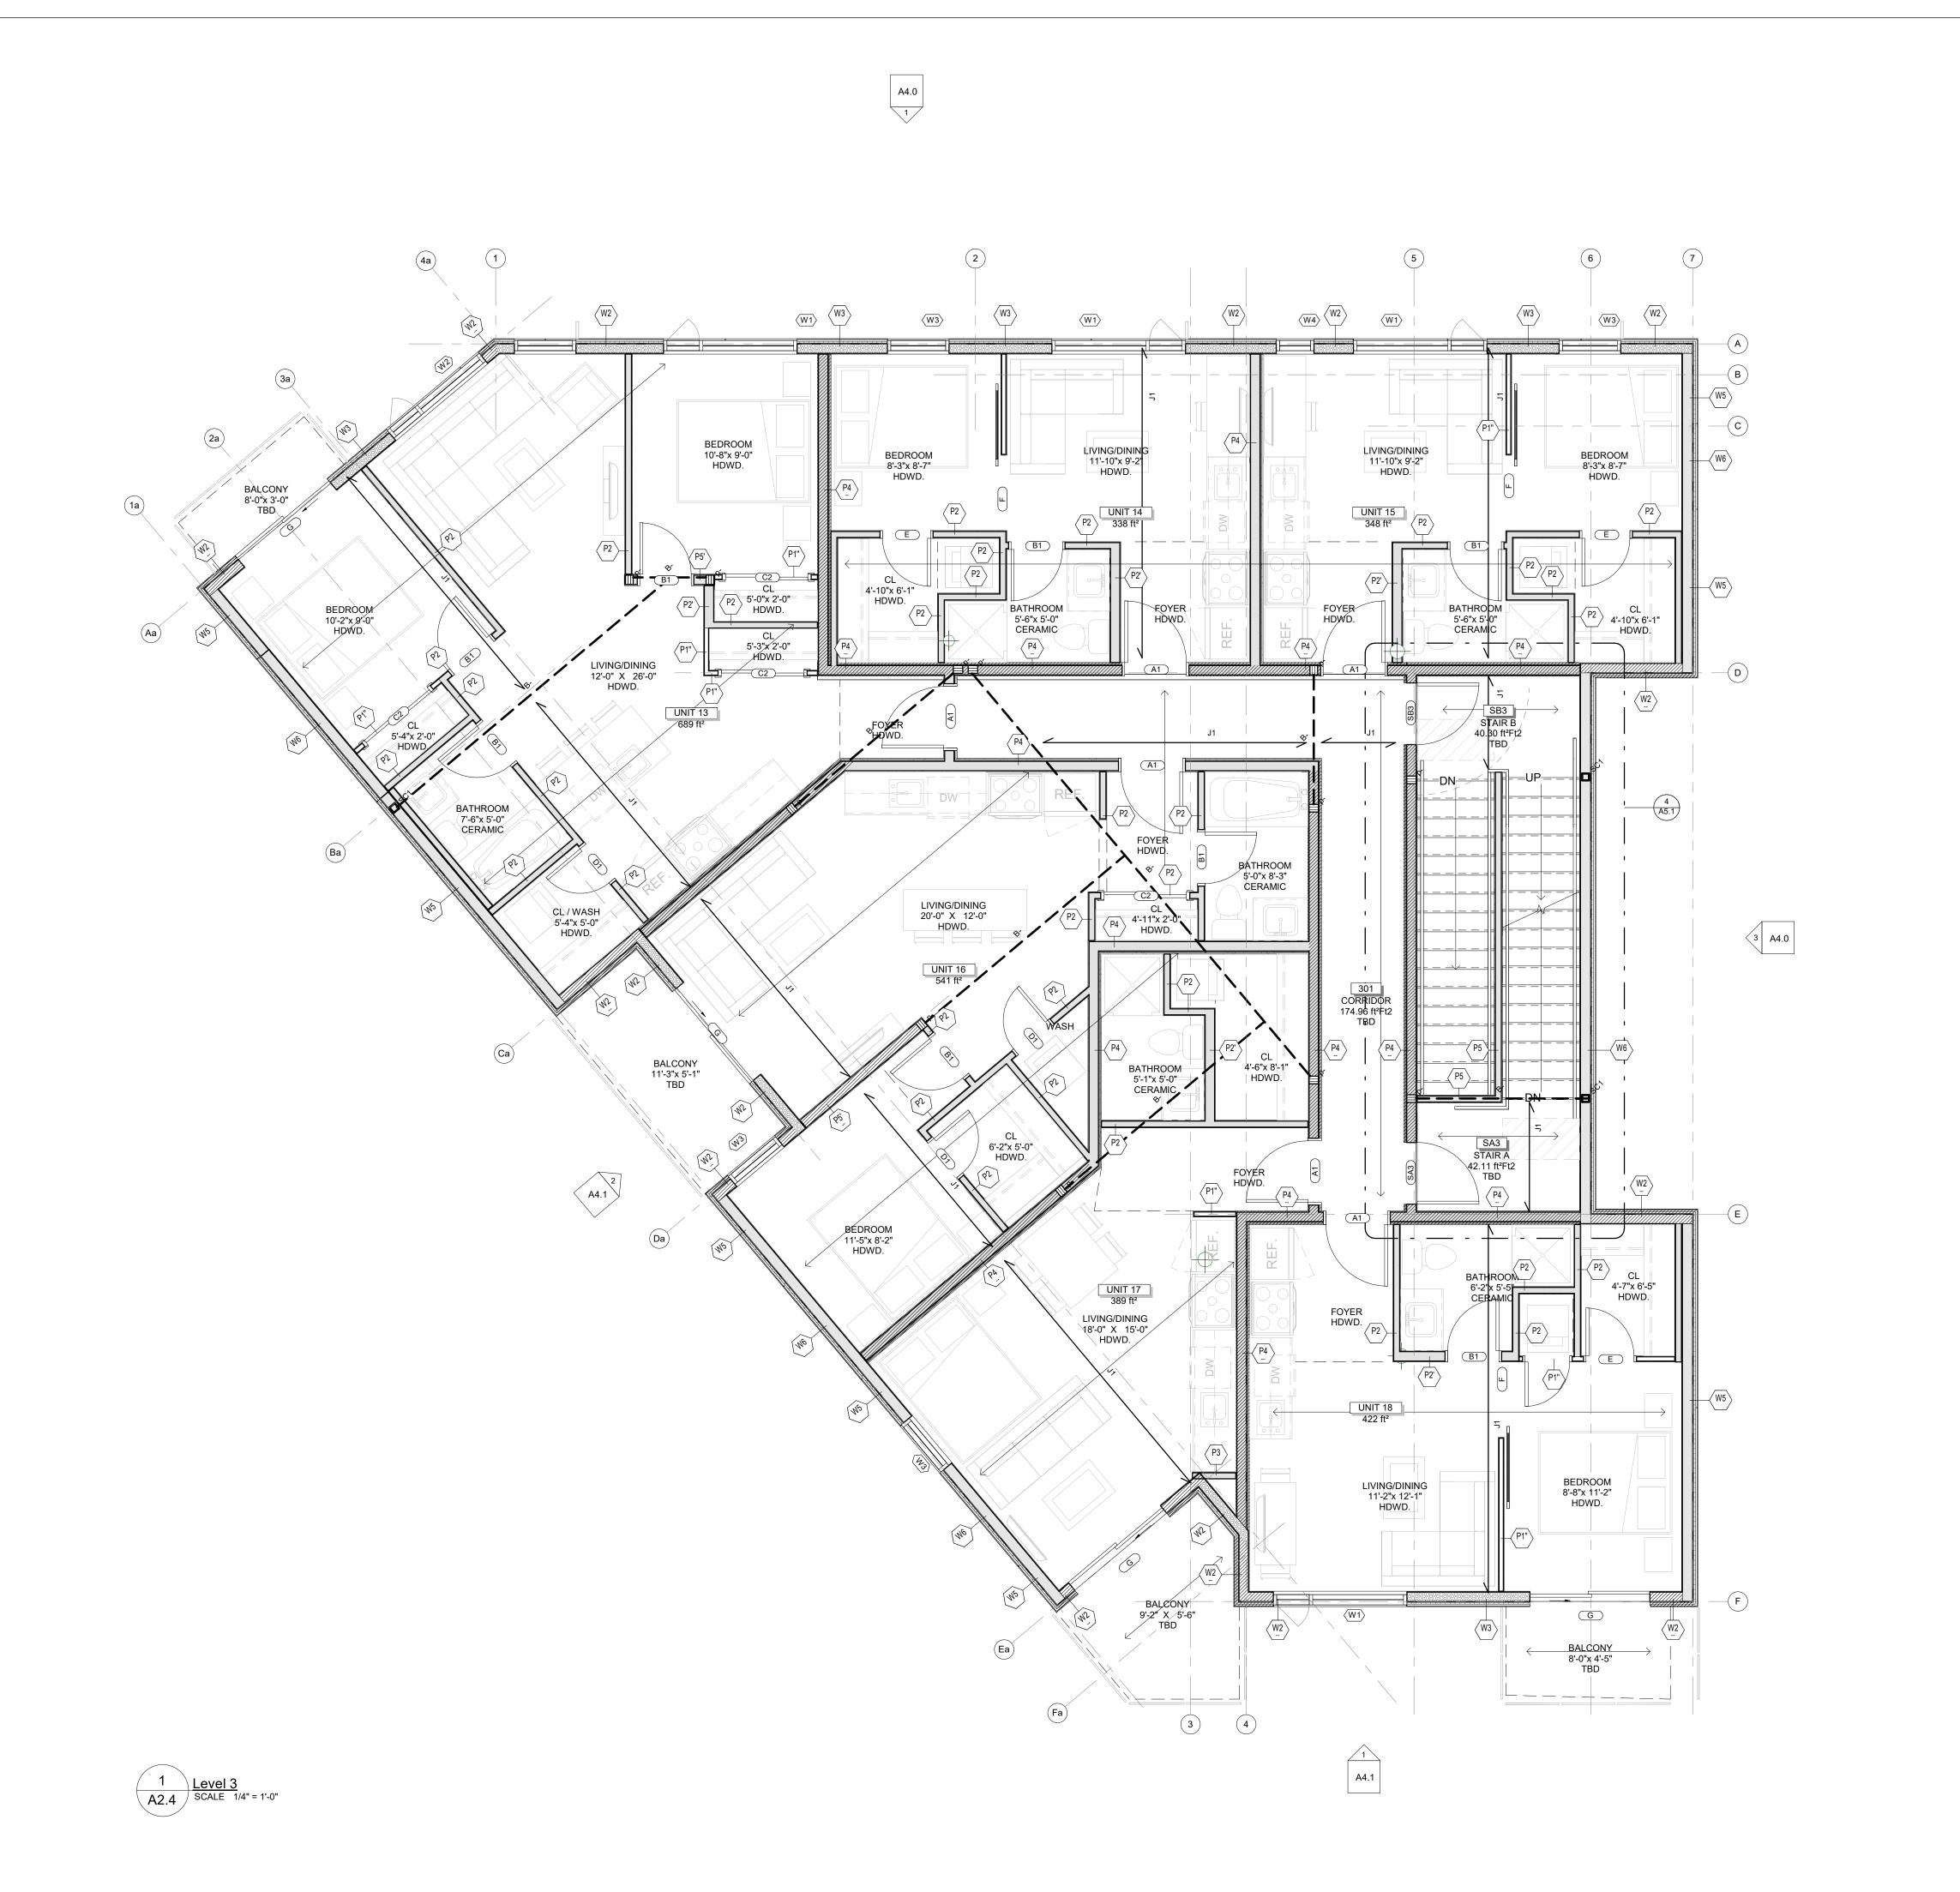

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ACCURACY

ACCURACY

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LOAD BEARING WALL

WALL LEGEND

1 BED UNIT 1

UNIT 2

UNIT 3

UNIT 4

UNIT 5

UNIT 6

UNIT 8

UNIT 9

UNIT 10

UNIT 12

UNIT 14

UNIT 15

UNIT 18

UNIT 13

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389.10 ft<sup>2</sup>

389.17 ft<sup>2</sup> LEVEL 3

Level

BASEMENT

BASEMENT

BASEMENT

LEVEL 1

LEVEL 1

LEVEL 1

LEVEL 2

LEVEL 2

LEVEL 2

LEVEL 2

LEVEL 3


LEVEL 3

LEVEL 3

LEVEL 2

LEVEL 3

LEVEL 2

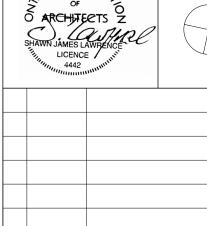

NORTH ARROW:

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PROJECT:

CARLING DEVELOPMENT

1240 CARLING, OTTAWA ON.

THIRD FLOOR PLAN


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D.T. B.L. S.J.L.

PLOT DATE: 2023-06-12 12:17:22 PM


JOB NUMBER:

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**A2.5** 

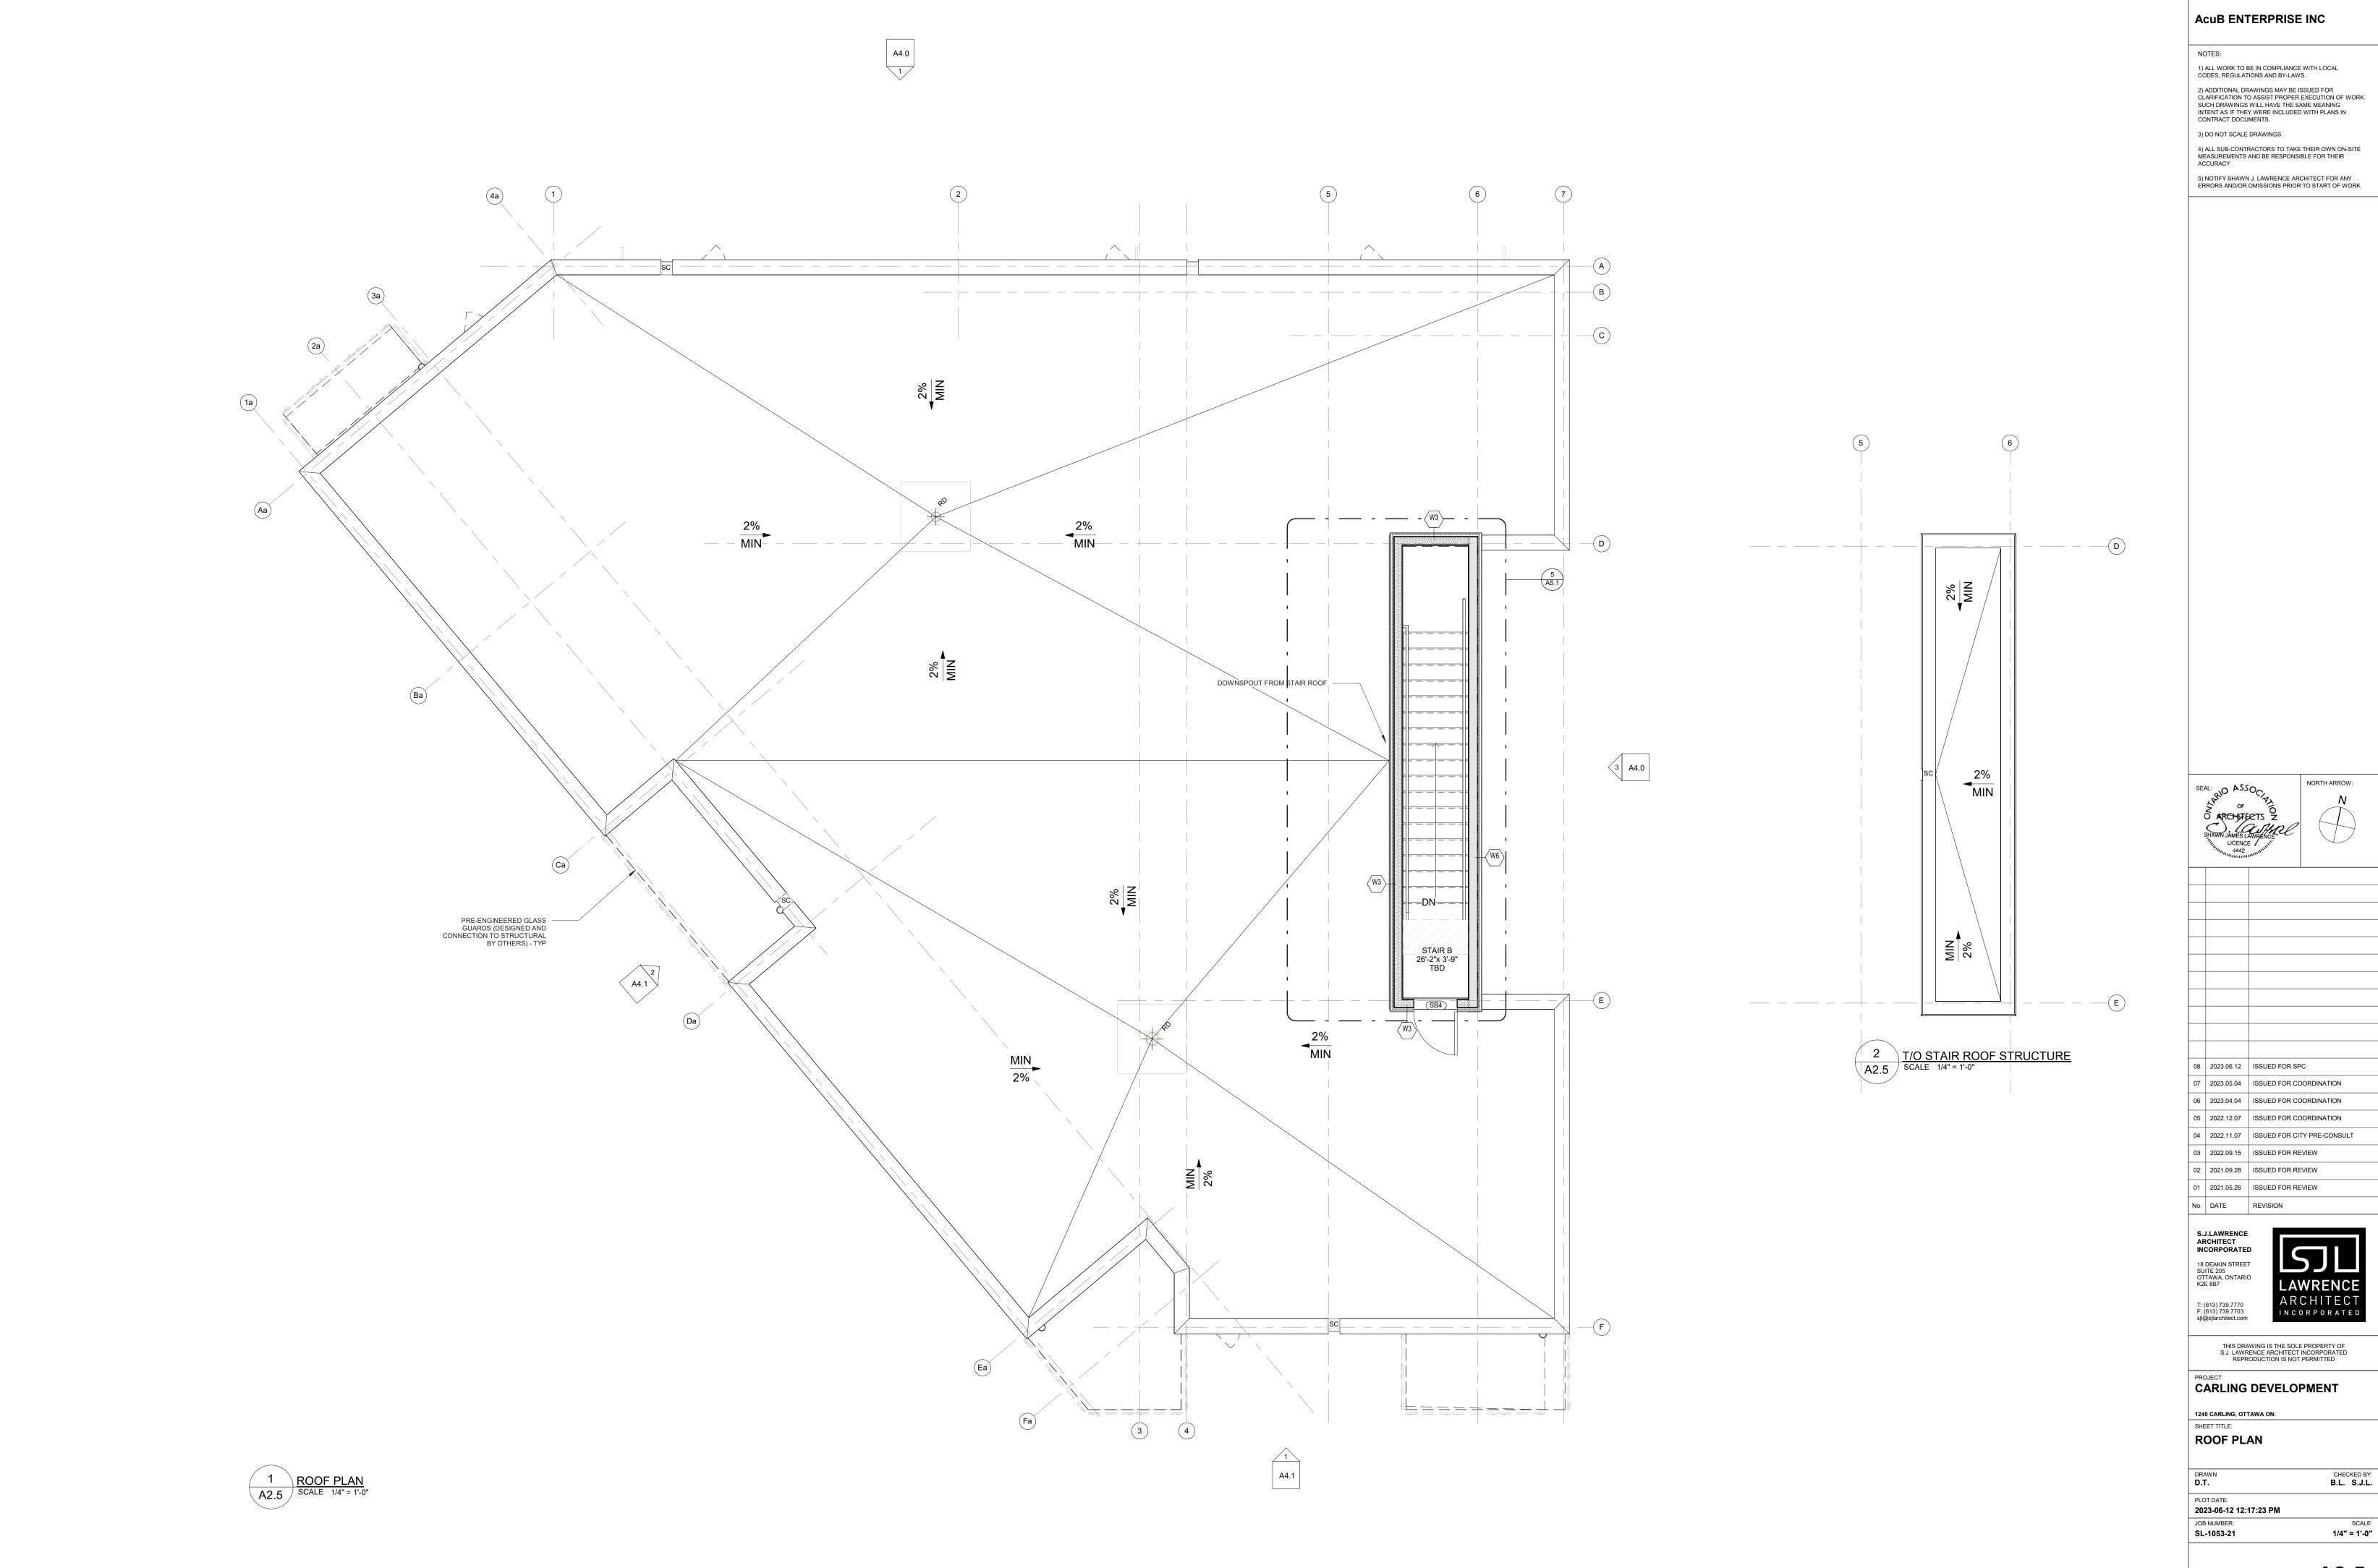

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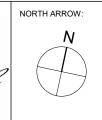
ERRORS AND/OR OMISSIONS PRIOR TO START OF WORK.

|                | KEYNOTES-ELEVATION   |
|----------------|--|
| NOTE<br>NUMBER | NOTE TEXT  |
| 1              | CEMENT PARGING ON ALL EXPOSED FOUNDATION TO 8" BELOW GRADE                       |
| 2              | BRICK GLENGERY_BROWN VELOUR  |
| 3              | 3" PRECAST CONCRETE SILL   |
| 4              | WALL SCONCE  |
| 5              | PRE-FINISHED METAL FASCIA  |
| 6              | HARDIEPANEL_VERTICAL SIDING. FIBEF<br>CEMENT PANEL_COLOUR MATCH<br>"ASCOT WHITE" |
| 7              | FRAMELESS GLASS GUARD RAIL (3'-6" TALL)  |
| 8              | FIBER CEMENT LAP SIDING - COLOUR MATCH "CLASSIC BRONZE"                          |
| 9              | OVERFLOW SCUPPER, REFER TO ROOF PLAN   |
| 10             | REVEALS IN PANEL AS PER ELEVATION  |
| 11             | SONOTUBE PIER  |
| 12             | KINGSPAN_VERTICAL FINS_BURNT   |

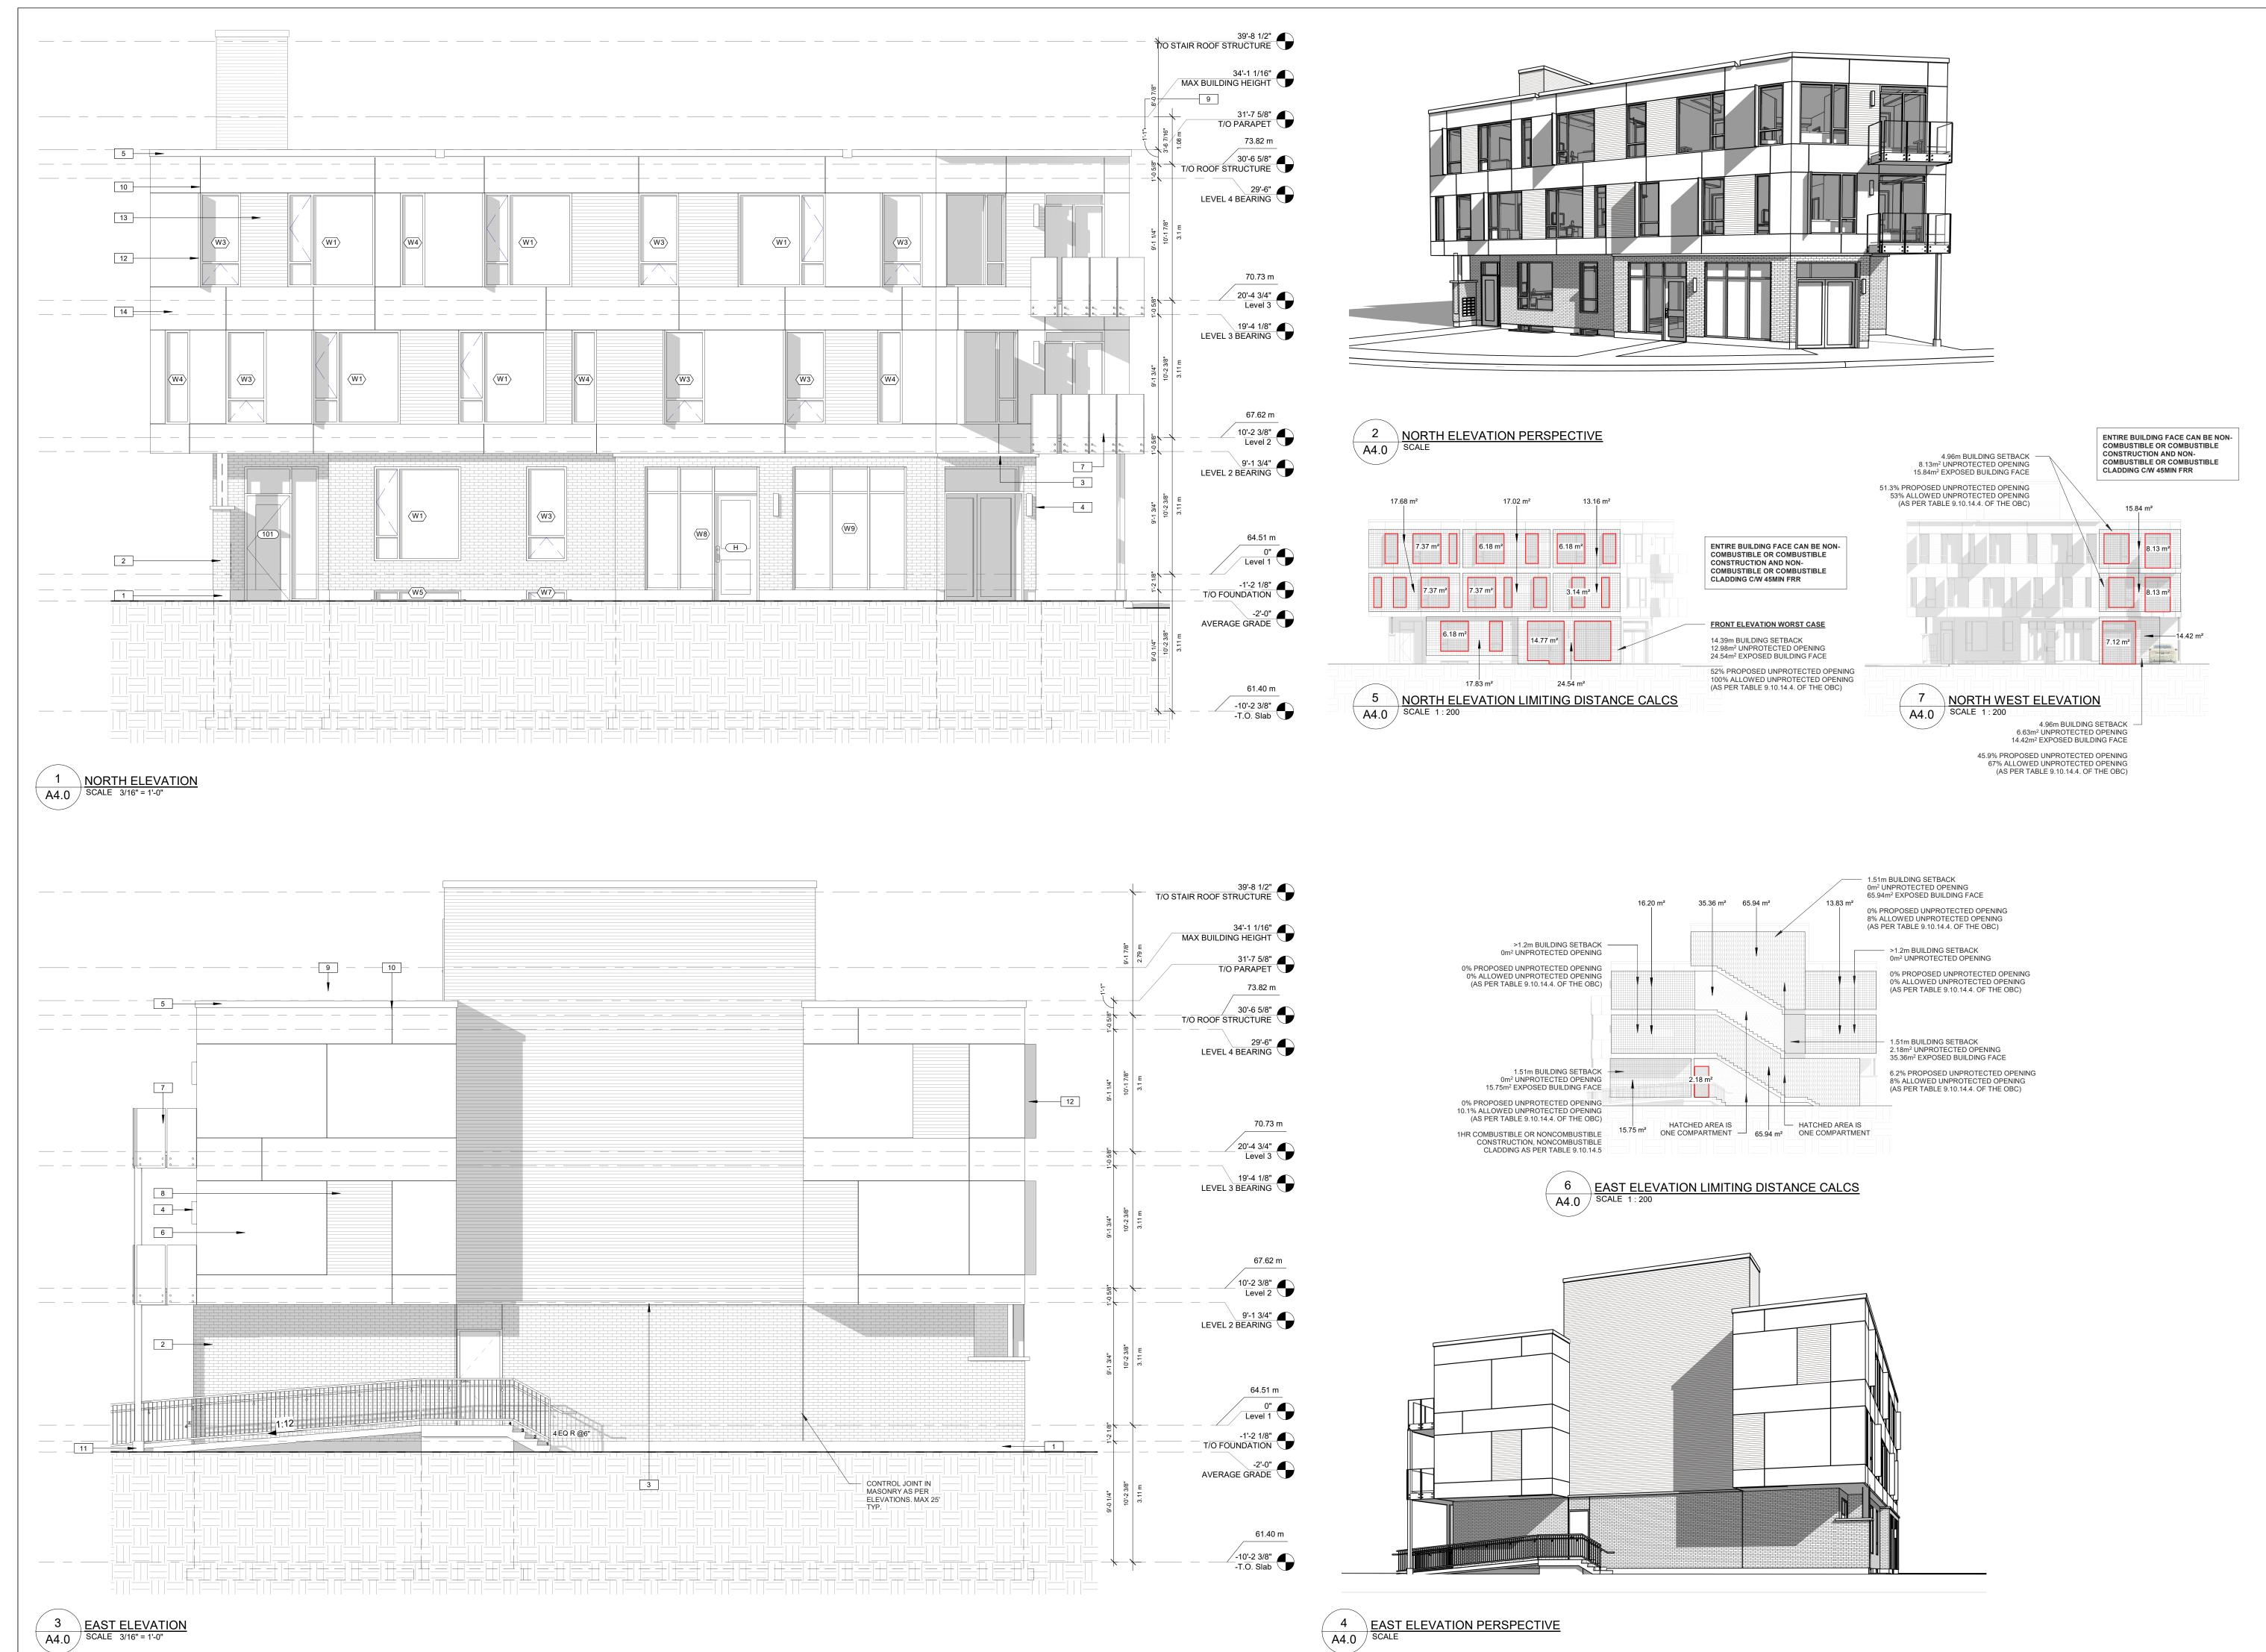LONGBOARD\_LAP SIDING\_BRONZE

ALCOTEX\_ACM\_ASCOT WHITE





| 4442 |            |                             |  |  |
|------|------------|-----------------------------|--|--|
|      |            |                             |  |  |
|      |            |                             |  |  |
|      |            |                             |  |  |
|      |            |                             |  |  |
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|      |            |                             |  |  |
|      |            |                             |  |  |
|      |            |                             |  |  |
|      |            |                             |  |  |
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CARLING DEVELOPMENT

1240 CARLING, OTTAWA ON. SHEET TITLE:

**ELEVATIONS** 

CHECKED BY: B.L. S.J.L. 2023-06-12 12:17:32 PM

JOB NUMBER: SL-1053-21 As indicated

**A4.0** 



CEMENT PARGING ON ALL EXPOSED BRICK GLENGERY\_BROWN VELOUR HARDIEPANEL\_VERTICAL SIDING. FIBER CEMENT PANEL\_COLOUR MATCH "ASCOT WHITE" FRAMELESS GLASS GUARD RAIL (3'-6" FIBER CEMENT LAP SIDING - COLOUR

OVERFLOW SCUPPER, REFER TO ROOF REVEALS IN PANEL AS PER ELEVATION

**A4.1**