

#### STORM SEWERS

- 1. ALL PVC STORM SEWERS ARE TO BE SDR 35 APPROVED PER C.S.A. B182.2 OR LATEST AMENDMENT, UNLESS OTHERWISE SPECIFIED.
- 2. ALL STORM SEWER TRENCH AND BEDDING SHALL BE IN ACCORDANCE WITH CITY OF OTTAWA STD. S6 AND S7 CLASS "B" UNLESS OTHERWISE SPECIFIED. BEDDING AND COVER MATERIAL SHALL BE SPECIFIED BY PROJECT GEOTECHNICAL ENGINEER.
- 3. ALL STORM LATERALS SHALL BE PVC SDR 28, WHITE IN COLOR AND MARKED WITH A 50MMX100MM WOODEN MARKER EXTENDING FROM THE INVERT TO 1.0 M ABOVE GRADE PAINTED GREEN. HOUSE CONNECTIONS SHALL BE 2.0M MIN. BELOW FINISHED GRADE AT STREET LINE WHERE POSSIBLE. SINGLE CONNECTIONS SHALL BE 100MM DIA..
- 4. ALL STORM SERVICES TO BE EQUIPPED WITH APPROVED BACKWATER VALVES.
- . STORM MANHOLE FRAME AND COVERS SHALL BE AS PER CITY OF OTTAWA STD. S24, S24.1, AND S25. . SAFETY PLATFORMS SHALL BE IN ACCORDANCE WITH OPSD 404.02.
- 7. STORM SEWER MANHOLES SERVING LOCAL SEWERS LESS THAN 900MM SHALL BE CONSTRUCTED WITH A
- 8. THE STORM SEWER CLASSES HAVE BEEN DESIGNED BASED ON BEDDING CONDITIONS SPECIFIED ABOVE. WHERE THE SPECIFIED TRENCH WIDTH IS EXCEEDED. THE CONTRACTOR SHALL BE REQUIRED TO PROVIDE ADDITIONAL BEDDING, A DIFFERENT TYPE OF BEDDING OR A HIGHER PIPE STRENGTH AT HIS OWN EXPENSE AND SHALL ALSO BE RESPONSIBLE FOR EXTRA TEMPORARY AND / OR PERMANENT REPAIRS MADE NECESSARY BY THE WIDENED TRENCH.

#### SANITARY SEWERS

- 1. ALL SANITARY SEWERS SHALL BE PVC SDR 35, IPEX "RING-TITE" (OR EQUIVALENT), AS PER CSA STANDARD B182.2 OR LATEST AMENDMENT, UNLESS OTHERWISE NOTED.
- 2. SANITARY SEWER TRENCH AND BEDDING SHALL BE AS PER CITY OF OTTAWA STD. S6 AND S7 CLASS "B" BEDDING UNLESS OTHERWISE NOTED.
- 3. ALL SANITARY LATERALS ARE TO BE PVC SDR 28, IPEX "RING-TITE" (OR EQUIVALENT), ANY COLOR EXCEPT WHITE AND MARKED WITH A 50MMX100MM WOODEN MARKER EXTENDING FROM THE INVERT TO 1.0 M ABOVE GRADE PAINTED RED. HOUSE CONNECTIONS SHALL BE 2.75M MIN. BELOW FINISHED GRADE AT STREET LINE WHERE POSSIBLE. SINGLE CONNECTIONS SHALL BE 135MM DIA..
- 4. ALL SANITARY SERVICES TO BE EQUIPPED WITH APPROVED BACKWATER VALVES. 5. SANITARY MANHOLE FRAME AND COVERS SHALL BE AS PER CITY OF OTTAWA STD. S24 AND S25.

6. SAFETY PLATFORMS SHALL BE IN ACCORDANCE WITH OPSD 404.02. 7. SANITARY SEWER MANHOLES SHALL BE BENCHED AS PER OPSD 701.021.

REPORT SHALL BE SUBMITTED TO THE ENGINEER FOR REVIEW.


- 8. SANITARY PRE-CAST MANHOLE SHALL BE CONSTRUCTED WITH A HIGHER PERCENTAGE OF SILICA FUME
- IN THE CONCRETE TO MAKE IT MORE DENSE AND LESS SUSCEPTIBLE TO CORROSION OR PINHOLE LEAKS. 9. FOR SANITARY MANHOLES, DEPENDING ON THE ELEVATION OF THE GROUNDWATER TABLE, AND BASED ON THE RECOMMENDATION OF THE PROJECT GEOTECHNICAL CONSULTANT, CRETEX SEALS, OR A SIMILAR PRODUCT, SHALL BE INSTALLED IN THE FIRST PRE-CAST MANHOLE SECTION TO JUST BELOW THE MANHOLE FRAME TO PREVENT INFILTRATION.

#### GENERAL NOTES

- 1. ALL SEWERS CONSTRUCTED WITH GRADES 0.5% OR LESS, SHALL BE INSTALLED WITH PIPE LASER AND
- CHECKED WITH LEVEL INSTRUMENTS PRIOR TO BACKFILLING. 2. THE CONTRACTOR SHALL BE RESPONSIBLE FOR ADDITIONAL BEDDING OR ADDITIONAL STRENGTH PIPE IF THE MAXIMUM TRENCH WIDTH, AS SPECIFIED BY OPSD, IS EXCEEDED.
- 3. CONTRACTOR SHALL PERFORM LEAKAGE TESTING, IN THE PRESENCE OF THE CONSULTANT, FOR SANITARY SEWERS IN ACCORDANCE WITH OPSD 410 AND OPSS 407. CONTRACTOR SHALL PERFORM VIDEO INSPECTION OF ALL STORM AND SANITARY SEWERS. A COPY OF THE VIDEO AND INSPECTION
- 4. CLAY SEALS TO BE INSTALLED AS PER CITY STANDARD DRAWING NO. S8. THE SEALS SHOULD BE AT LEAST 1.5M LONG (IN THE TRENCH DIRECTION) AND SHOULD EXTEND FROM TRENCH WALL TO TRENCH WALL. GENERALLY, THE SEALS SHOULD EXTEND FROM BELOW THE FROST LINE, 1,5 TO 2,0 M BELOW FINISH GRADE, AND FULLY PENETRATE THE BEDDING, SUBBEDDING AND PIPE COVER MATERIAL. THE BARRIERS SHOULD CONSIST OF RELATIVELY DRY AND COMPACTABLE BROWN SILTY CLAY PLACED IN MAXIMUM 225MM THICK LOOSE LAYERS COMPACTED TO A MINIMUM OF 95% OF THE MATERIAL'S SPMDD. THE CLAY SEALS SHOULD BE PLACED AT THE SITE BOUNDARIES AND AT STRATEGIC LOCATIONS AT NO
- MORE THAN 100M INTERVALS IN THE SERVICE TRENCHES. 5. ALL INSPECTIONS SHALL BE PERFORMED IN ACCORDANCE WITH APPLICABLE FEDERAL AND PROVINCIAL PRIVACY LEGISLATION INCLUDING THE CANADIAN PERSONAL INFORMATION PROTECTION AND ELECTRONIC DOCUMENTS ACT (PIPEDA). DOCUMENTATION CONFIRMING COMPLIANCE WITH THIS LEGISLATION SHALL BE MADE AVAILABLE TO THE OWNER AND SUBMITTED WITH THE PRE-CONSTRUCTION

#### WATER SUPPLY

- 1. ALL PVC WATERMAINS SHALL BE EQUAL TO AWWA C-900 CLASS 150, SDR 18, OR APPROVED EQUAL. 2. WATERMAIN TRENCH AND BEDDING SHALL BE IN ACCORDANCE WITH CITY OF OTTAWA STANDARD W17, UNLESS OTHERWISE SPECIFIED. BEDDING AND COVER MATERIAL SHALL BE SPECIFIED BY PROJECT
- GEOTECHNICAL ENGINEER. 3. ALL PVC WATERMAINS SHALL BE INSTALLED WITH A 10 GAUGE STRANDER COPPER TWU OR RWU TRACER WIRE IN ACCORDANCE WITH CITY OF OTTAWA STD. W36.
- 4. WATER SERVICES ARE TO BE TYPE K SOFT COPPER AS PER CITY OF OTTAWA STD. W26 UNLESS OTHERWISE SPECIFIED. SINGLE SERVICES SHALL BE 20MM DIA. 50MM DIA COPPER SHALL BE USED FOR
- WATER SERVICES SHALL BE MARKED WITH A "50MMX100MM", EXTENDING FROM THE INVERT TO 1.0M ABOVE GRADE PAINTED BLUE. STAND POSTS / SHUT-OFFS SHALL BE INSTALLED AT PROPERTY LINE. 5. CATHODIC PROTECTION IS REQUIRED ON ALL METALLIC FITTINGS AS PER CITY OF OTTAWA STD. W40 AND
- 6. CONTRACTOR TO SUPPLY HYDRANT EXTENSION TO ADJUST THE LENGTH OF HYDRANT BARREL. 7. FIRE HYDRANTS SHALL BE INSTALLED AS PER CITY OF OTTAWA STD. W19, AND LOCATED AS PER CITY
- STD. W18.
- 8. VALVE IN BOXES SHALL BE INSTALLED AS PER CITY OF OTTAWA STD. W24. 9. THRUST BLOCKING OF WATERMAIN TO BE INSTALLED AS PER CITY OF OTTAWA STD. W25.3 AND W25.4.
- 10. THE CONTRACTOR SHALL PROVIDE ALL TEMPORARY CAPS, PLUGS AND BLOW-OFFS AND NOZZLES REQUIRED FOR TESTING AND DISINFECTION OF THE WATERMAIN. 11. WHERE SEPARATION BETWEEN SERVICES AND MANHOLES IS LESS THAN 1.2M., WATER SERVICES ARE TO
- BE INSULATED AS PER CITY OF OTTAWA STD. W23. 12. AS PER CITY GUIDELINE, THE MINIMUM VERTICAL CLEARANCE BETWEEN WATERMAIN AND SEWER / UTILITY IS 0.25M FOR CROSSING OVER THE SEWER, AS PER CITY STD W25.2. FOR CROSSING UNDER SEWER. THE MINIMUM VERTICAL CLEARANCE IS 0.50M AS PER CITY STD. W25. FOR CROSSING UNDER SEWER, ADEQUATE STRUCTURAL SUPPORT FOR THE SEWERS IS REQUIRED TO PREVENT EXCESSIVE DEFLECTION OF JOINTS AND SETTLING. THE LENGTH OF WATER PIPE SHALL BE
- CENTERED AT THE POINT OF CROSSING SO THAT THE JOINTS WILL BE EQUIDISTANT AND AS FAR AS POSSIBLE FROM THE SEWER. 13. ALL WATER SERVICES CROSSING SEWERS ARE TO BE INSTALLED AS PER CITY OF OTTAWA STD. W38.

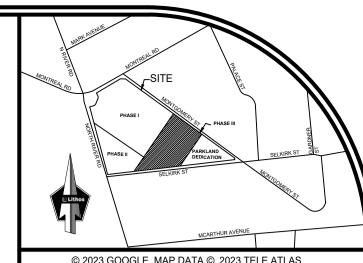

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#### LIST OF DRAWINGS

- SG-01 (SITE GRADING PLAN- PHASE III) SG-02 (SITE GRADING PLAN- PHASE I-II-III-PRELIMINARY)
- SS-01 (SITE SERVICING PLAN) SS-02 (SERVICING SECTIONS) SS-03 (SITE SERVICING PLAN-PHASES I-II-III PRELIMINARY)
- EC-01 (EROSION CONTROL PLAN) DD-01 (DETAIL DRAWINGS)
- DD-02 (DETAIL DRAWINGS)
- DD-03 (DETAIL DRAWINGS) CU-01 (COMPOSITE UTILITIES PLAN)
- RM-01 (REMOVALS PLAN) RR-01 (ROADWAY REINSTATEMENT PLAN)

#### SITE PLAN INFORMATION

56 Beech Street, Ottawa, Ontario K1S 3J6 TEL.: 613.724.9932 FAX: 613 724 1209 www.rodericklahey.ca


RODERICKLAHEY ARCHITECTS INC.


#### SURVEY INFORMATION

ANNIS, O' SULLIVAN, VOLLEBEKK LTD. ONTARIO LAND SERVEYORS 14 CONCOURSE GATE, SUITE 500 NEPEAN, ON K2E 7S6 T: (613) 727-0850 F: (613) 727-1079

### E: Nepean@aovltd.com **BENCHMARK**

ELEVATIONS SHOWN HEREON ARE GEODETIC AND ARE REFERRED TO THE CGVD28 GEODETIC DATUM, DERIVED FROM CITY OF OTTAWA BENCHMARK No. 3465 HAVING AN ELEVATION OF 62.831m.

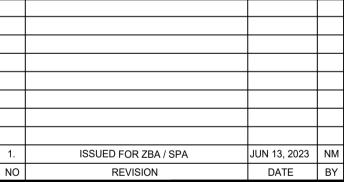

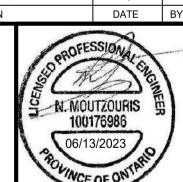

CITY OF OTTAWA


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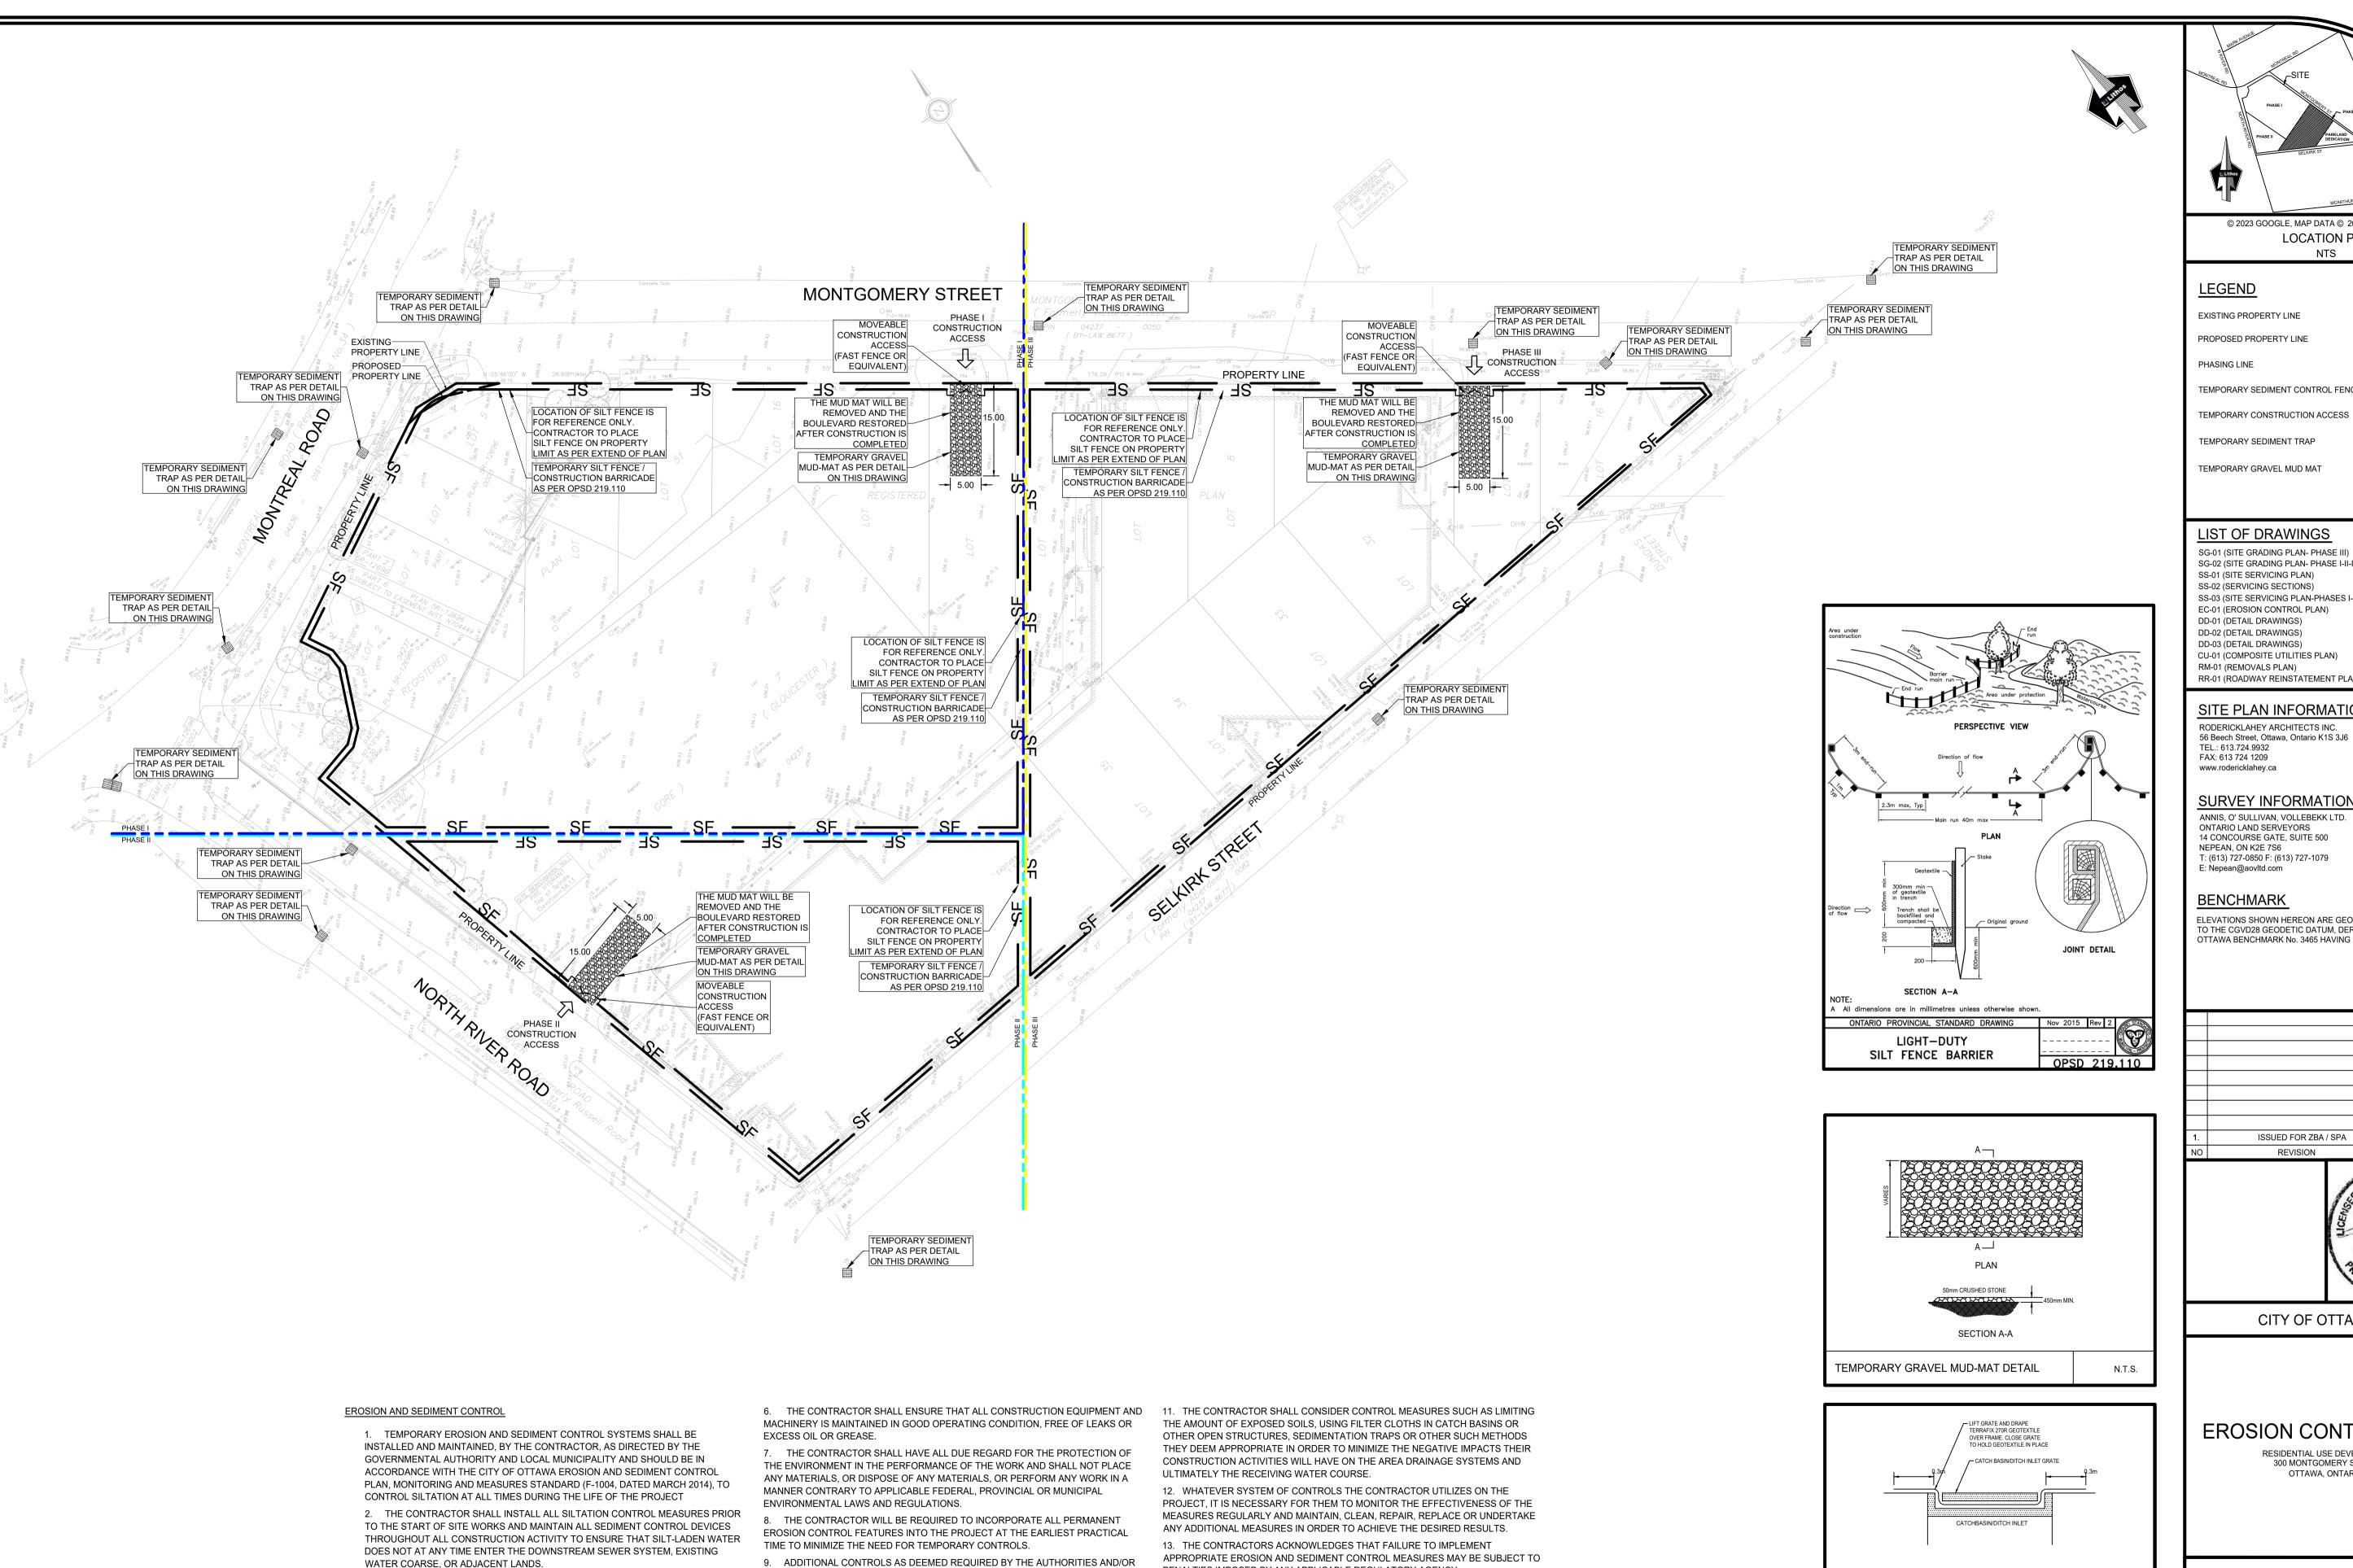
RESIDENTIAL USE DEVELOPMENT 300 MONTGOMERY STREET OTTAWA, ONTARIO



150 Bermomdsey Road , Toronto, Ontario M4A 1Y DESIGNED BY: EG DATE: JUNE, 2021

CHECKED BY: N RAWN BY: EG PROVED BY:N SCALE: 1:100 DRAWING No UD23-002 SS-02 © COPYRIGHT 2023 Lithos Group Ltd



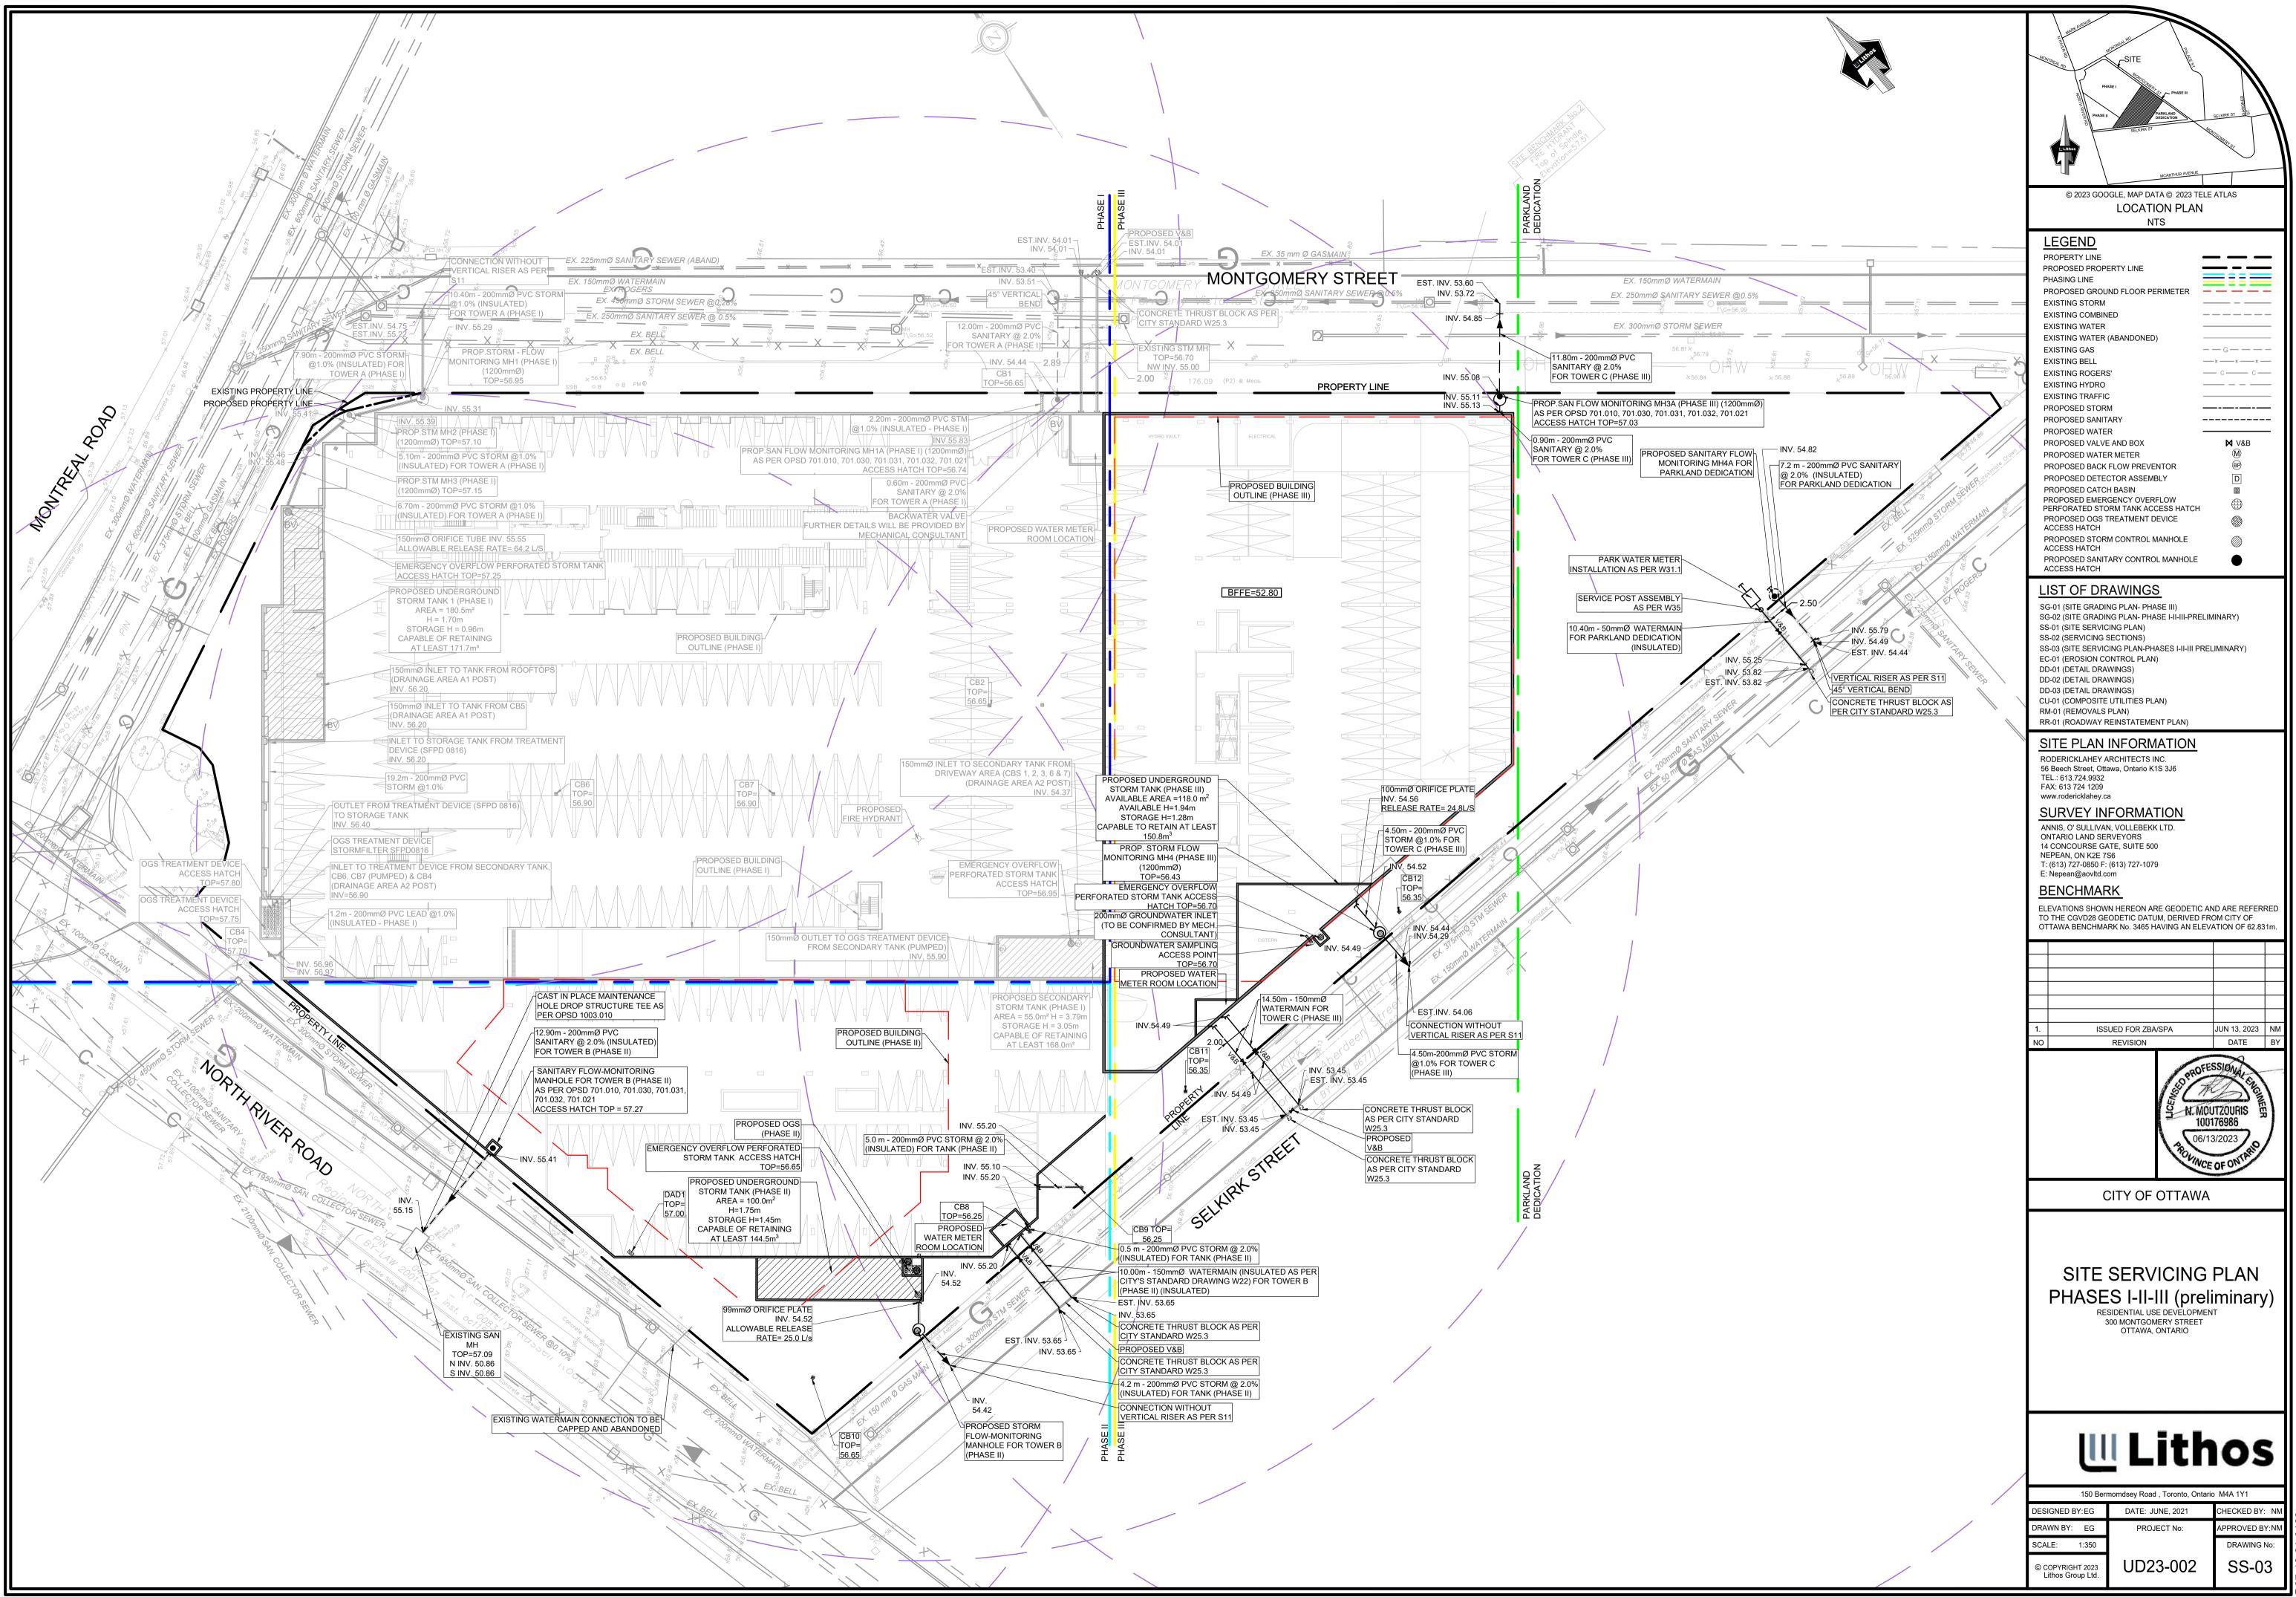

THE SITEWORKS ENGINEER OF RECORD DURING CONSTRUCTION ACTIVITIES SHALL

10. THE CONTRACTOR ACKNOWLEDGES THAT SURFACE EROSION AND SEDIMENT

THAT ALL CONSTRUCTION OPERATIONS THAT MAY IMPACT UPON WATER QUALITY

SHALL BE CARRIED OUT IN A MANNER THAT STRICTLY MEETS THE REQUIREMENTS

OF ALL APPLICABLE LEGISLATION AND REGULATIONS AS PER THE LATEST VERSION

OF THE FORMER REGION OF OTTAWA-CARLETON ON APPLICATION OF EROSION

DETRIMENTAL IMPACT ON ANY DOWNSTREAM WATERCOURSE OR SEWER, AND

BE PROVIDED BY THE CONTRACTOR. ADDITIONAL SILT FENCING MUST BE

RUNOFF RESULTING FROM HIS CONSTRUCTION OPERATIONS MAY HAVE A

AVAILABLE IN CASE IMMEDIATE REPAIR IS REQUIRED.

AND SEDIMENT CONTROL ON CONSTRUCTION PROJECTS.

3. SEDIMENT CONTROL FENCE SHALL BE AS PER DETAIL ON THIS DRAWING, OR

ACCORDANCE WITH OPSS 805 WHERE APPROPRIATE, OR IN ACCORDANCE WITH

4. TEMPORARY EROSION AND SEDIMENT CONTROL SYSTEMS SHALL BE

MANUFACTURER'S RECOMMENDATIONS.

CLEAN CONDITION AT ALL TIMES.

EACH RAINFALL AND REPAIRED IF REQUIRED.

APPROVED EQUIVALENT. SEDIMENT CONTROL FENCE INSTALLATION SHALL BE IN

INSPECTED BY THE CONTRACTOR ON A REGULAR BASIS AND IMMEDIATELY AFTER

5. THE CONTRACTOR WILL BE REQUIRED TO MAINTAIN EXISTING ROADS IN A

PENALTIES IMPOSED BY ANY APPLICABLE REGULATORY AGENCY.

14. THE CONTRACTOR SHALL IMPLEMENT BEST MANAGEMENT PRACTICES TO

LIMITING THE AMOUNT OF EXPOSED SOIL, USING FILTER CLOTH UNDER THE

BE REMOVED WHEN THE PROPOSED LANDSCAPING HAS BEEN ESTABLISHED.

GRATES OF CATCH BASINS AND MANHOLES, AND INSTALLING SILT FENCES AND

OTHER EFFECTIVE SEDIMENT TRAPS. EROSION CONTROL MEASURES SHALL ONLY

PROVIDE FOR PROTECTION OF THE AREA DRAINAGE SYSTEM AND THE RECEIVING

WATER COURSE DURING CONSTRUCTION. THIS INCLUDES (BUT IS NOT LIMITED TO)

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#### LEGEND

EXISTING PROPERTY LINE

PROPOSED PROPERTY LINE

TEMPORARY SEDIMENT CONTROL FENCE

TEMPORARY CONSTRUCTION ACCESS

TEMPORARY SEDIMENT TRAP

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DD-02 (DETAIL DRAWINGS) DD-03 (DETAIL DRAWINGS)

CU-01 (COMPOSITE UTILITIES PLAN) RM-01 (REMOVALS PLAN)

RR-01 (ROADWAY REINSTATEMENT PLAN)

#### SITE PLAN INFORMATION

RODERICKLAHEY ARCHITECTS INC.

TEL.: 613.724.9932 FAX: 613 724 1209

#### **SURVEY INFORMATION**

ANNIS, O' SULLIVAN, VOLLEBEKK LTD. ONTARIO LAND SERVEYORS 14 CONCOURSE GATE, SUITE 500

#### T: (613) 727-0850 F: (613) 727-1079 E: Nepean@aovltd.com

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ISSUED FOR ZBA / SPA	JUN 13, 2023	NM
REVISION	DATE	BY

CITY OF OTTAWA

# **EROSION CONTROL PLAN**

RESIDENTIAL USE DEVELOPMENT 300 MONTGOMERY STREET OTTAWA, ONTARIO



NOTE.


TEMPORARY INLET SEDIMENT CONTROL DEVICE TO BE INSTALLED & MAINTAINED OVER ALL CATCH
BASINS/DITCH INLETS WITHIN THE ZONE OF INFLUENCE OF CONSTRUCTION RUNOFF UNTIL ENTIRE AREA
HAS BEEN PAVED AND/OR SODDED AS REQUIRED.


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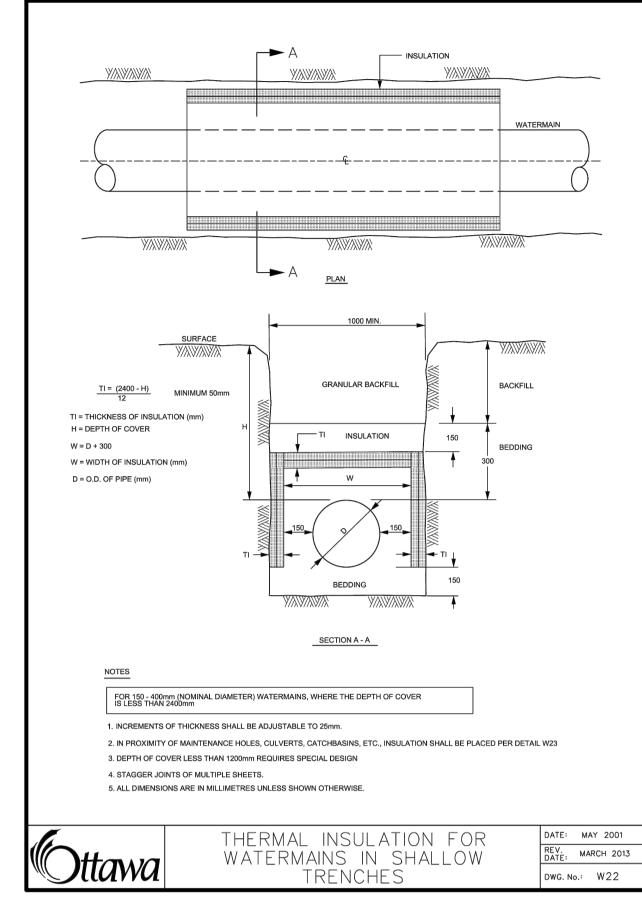
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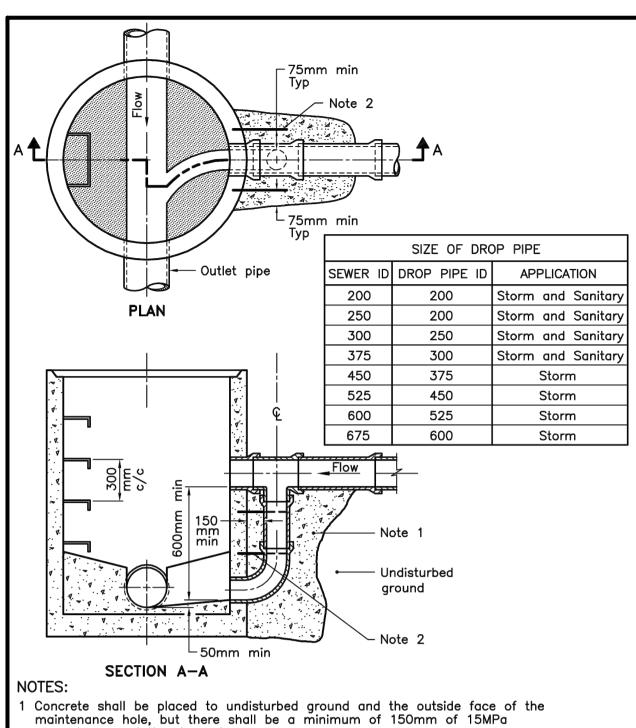
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AWN BY: EG	PROJECT No:	APPROVED BY:N	
ALE: 1:500		DRAWING No:	


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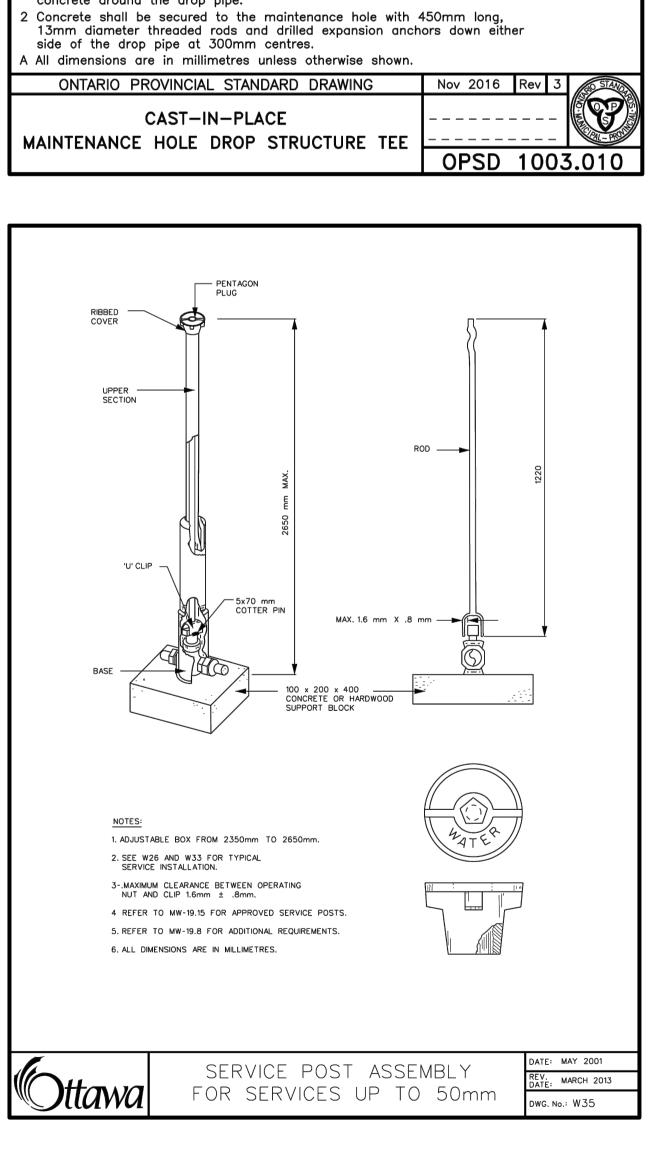







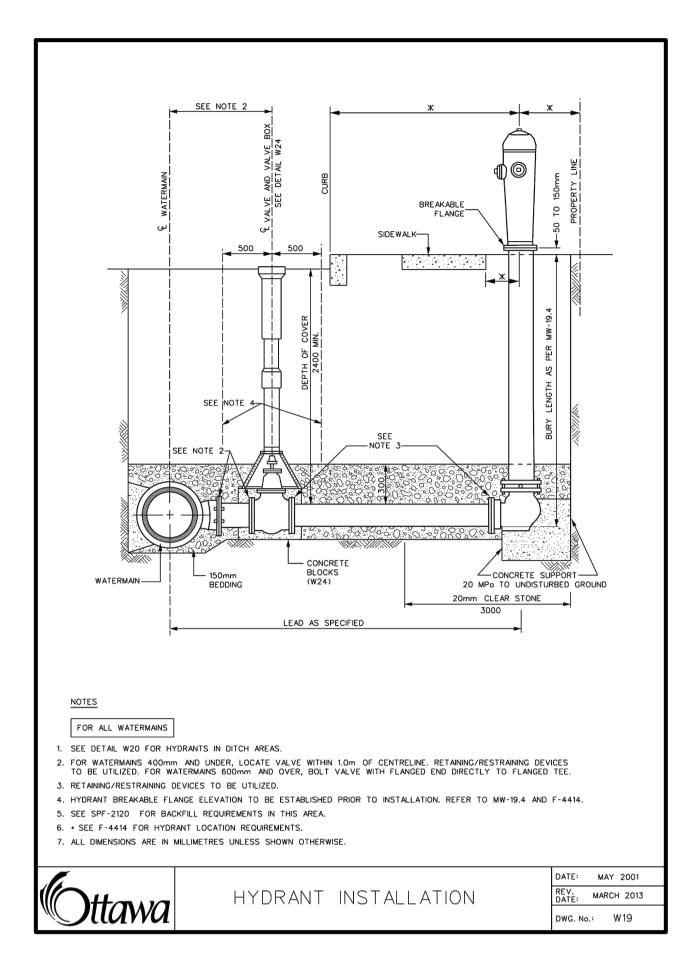

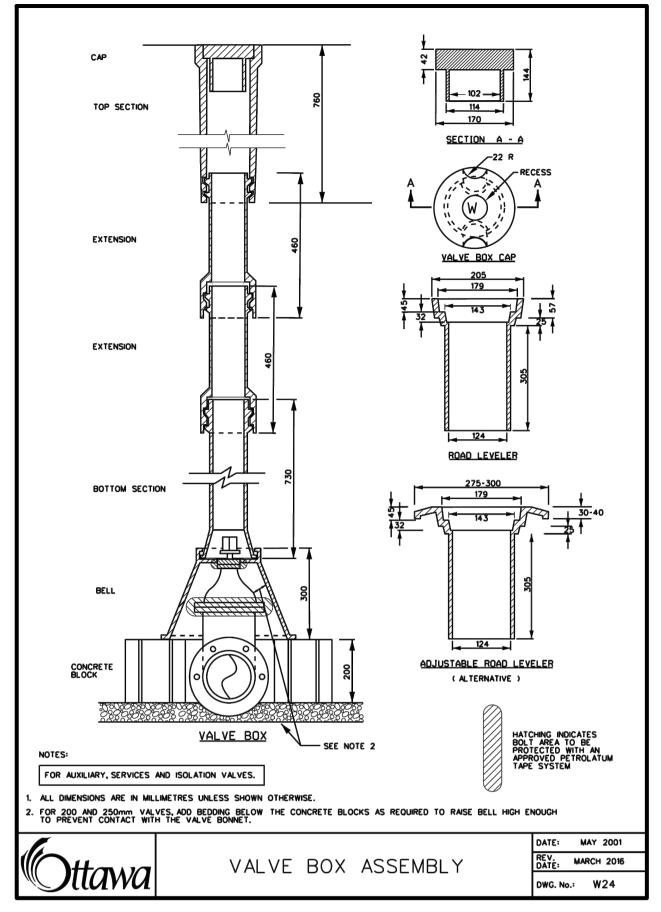

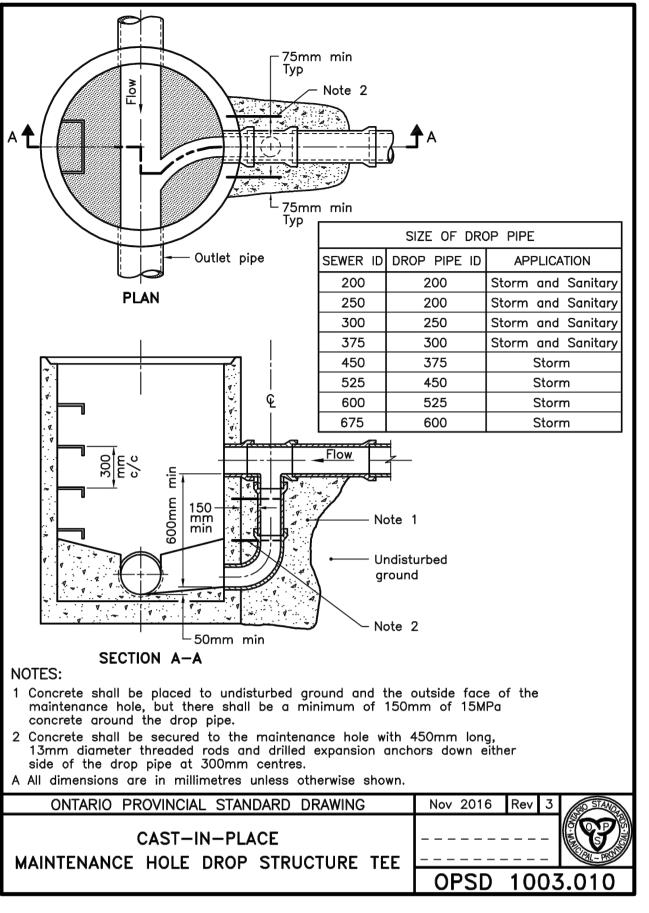

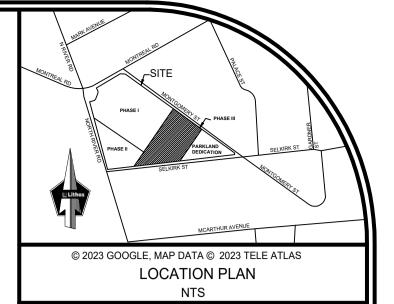

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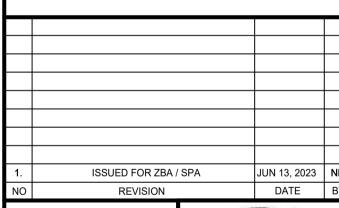
NEPEAN, ON K2E 7S6


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CITY OF OTTAWA


**DETAIL DRAWINGS** 

RESIDENTIAL USE DEVELOPMENT 300 MONTGOMERY STREET OTTAWA, ONTARIO




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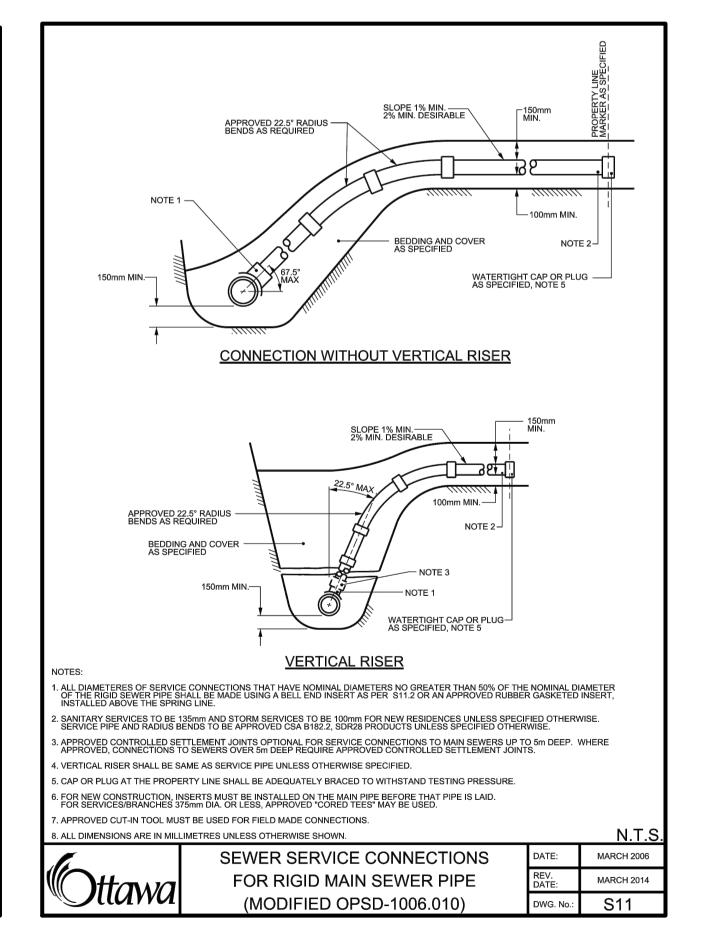
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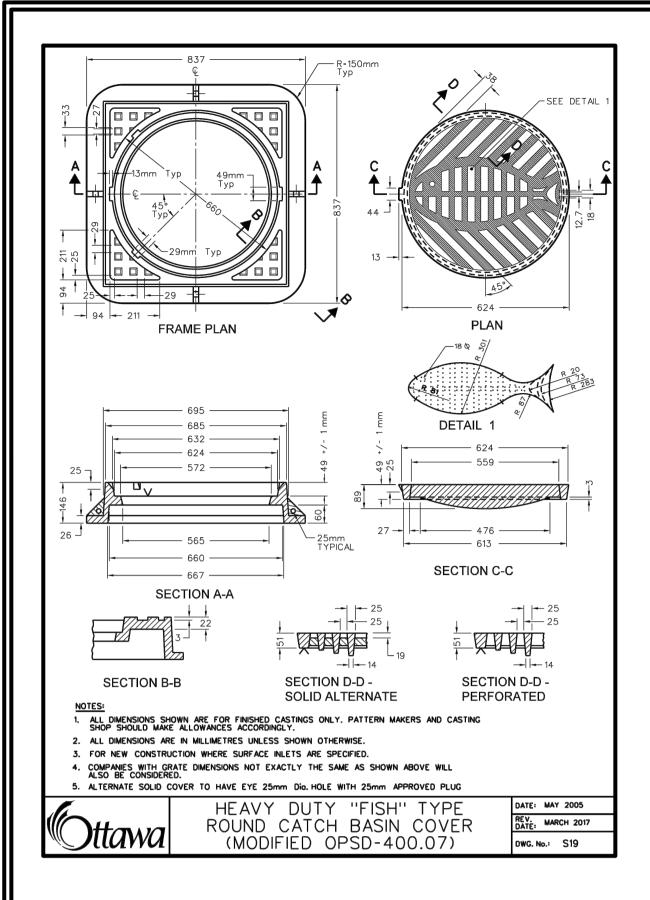
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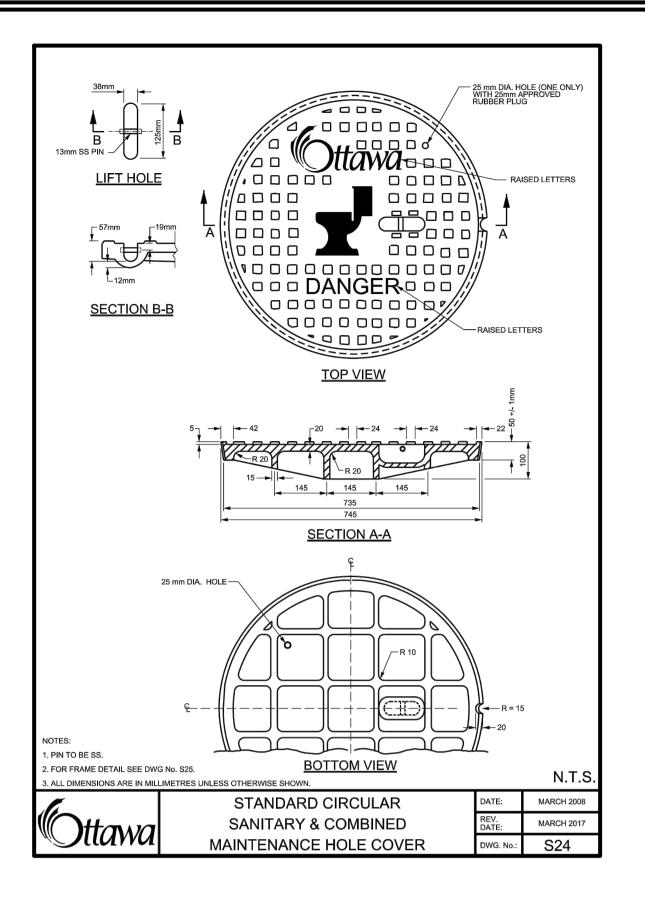


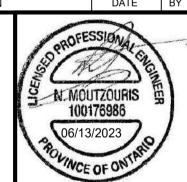
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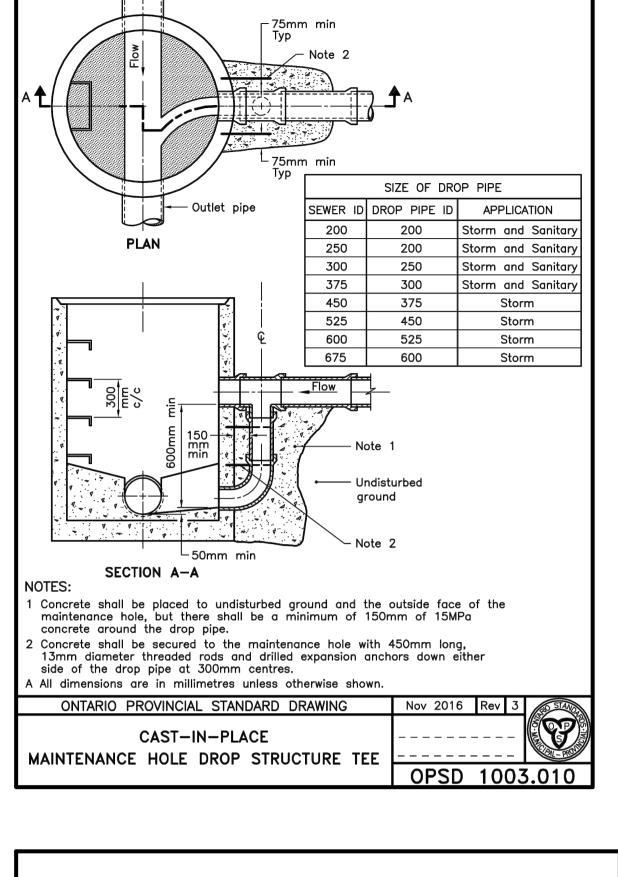
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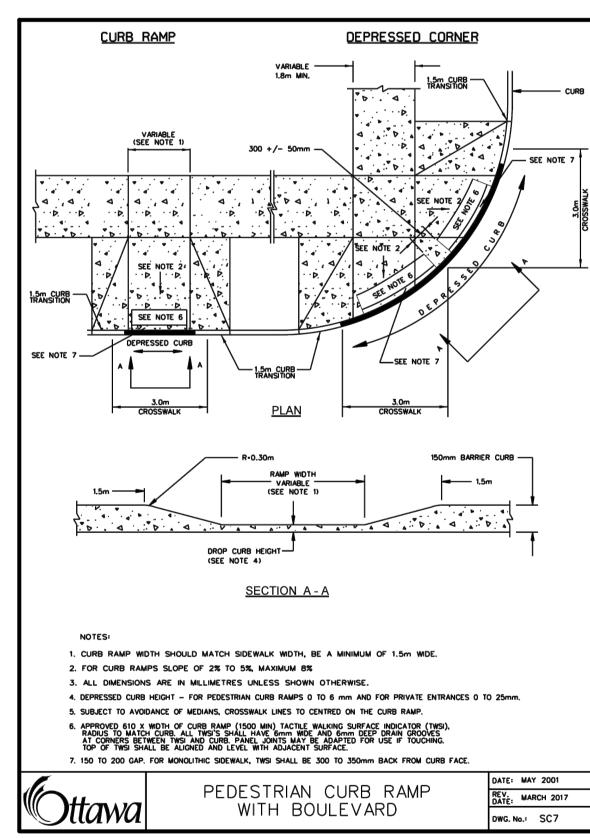


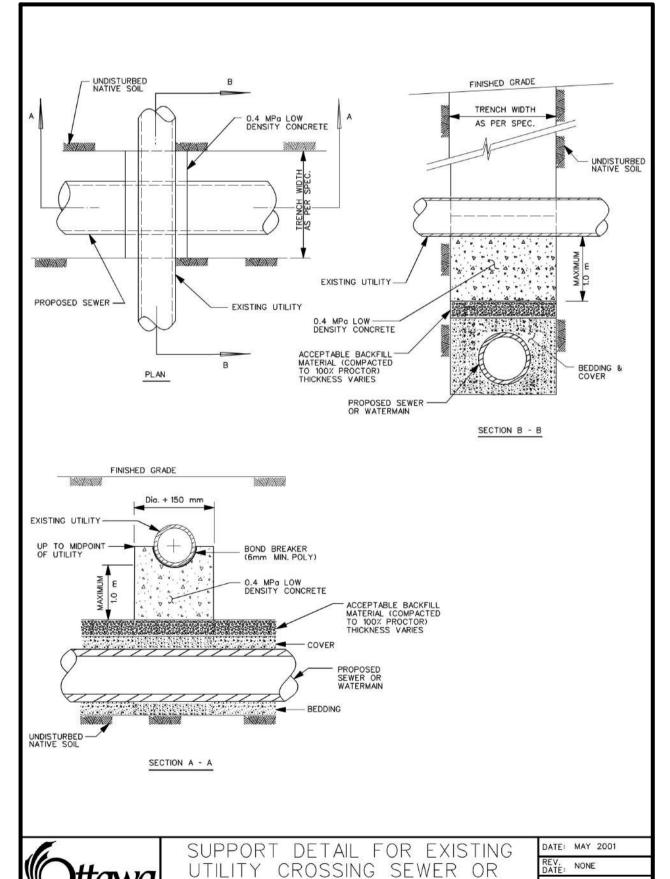








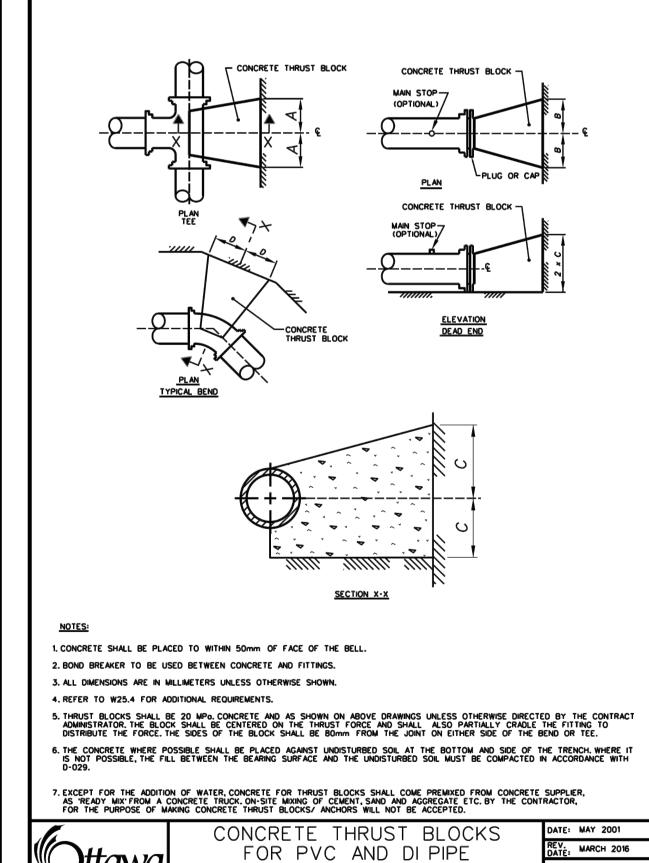


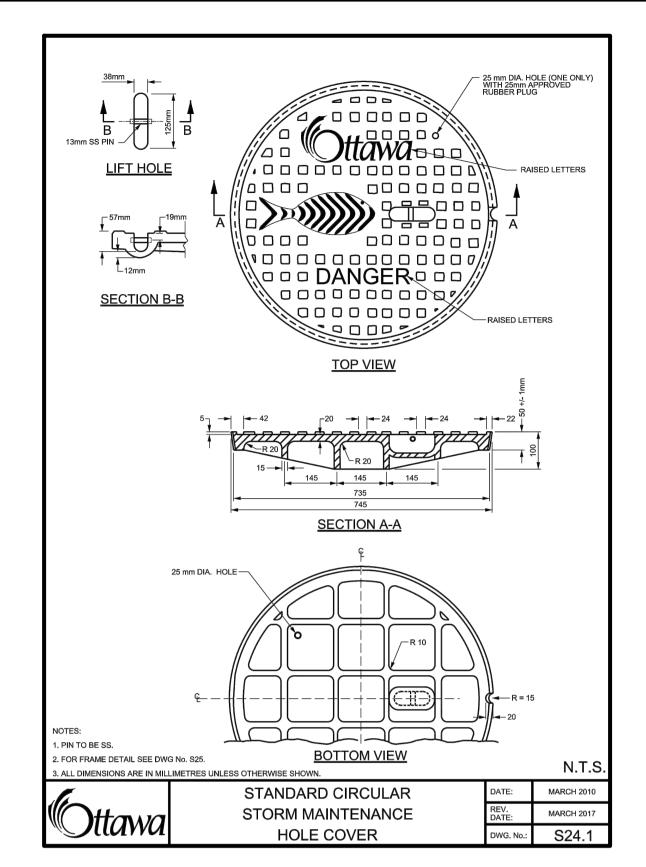

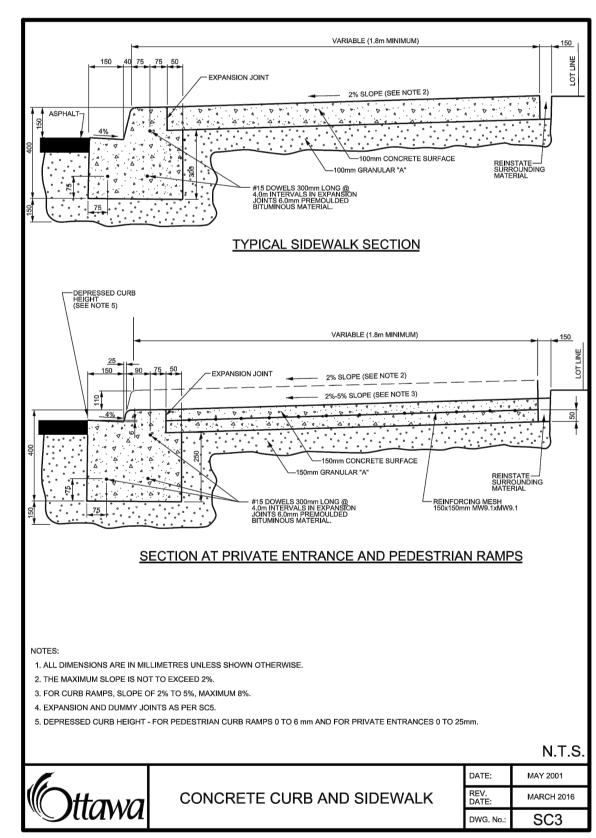

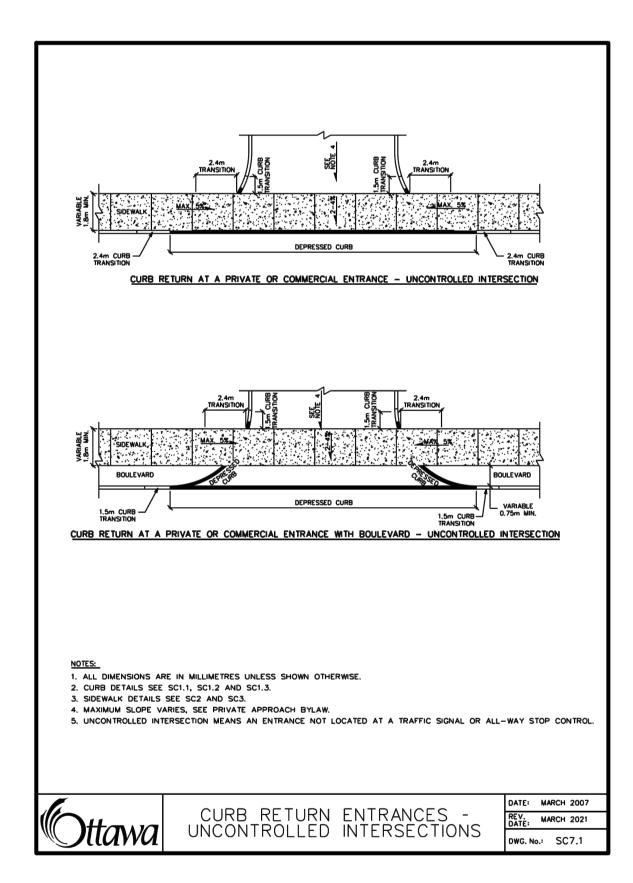

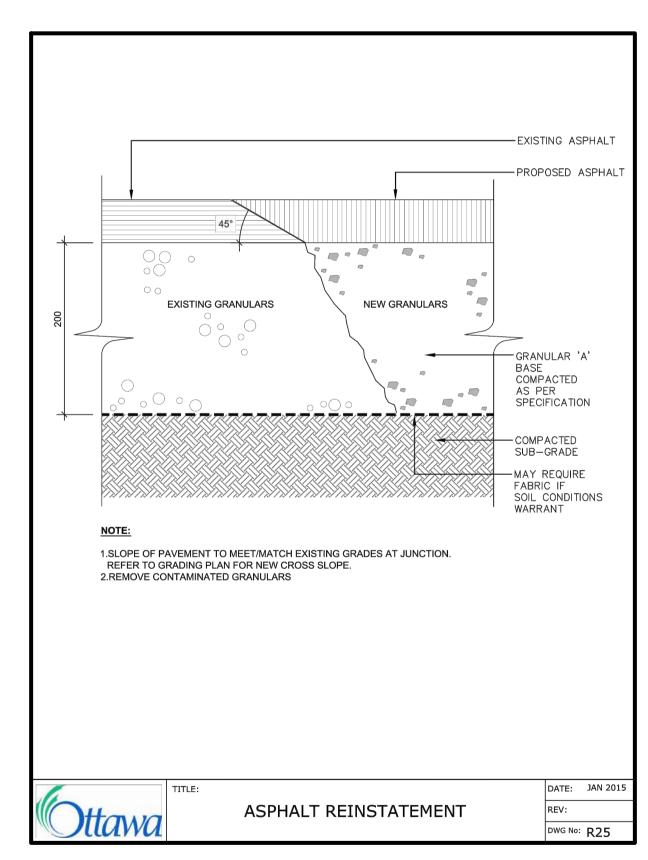

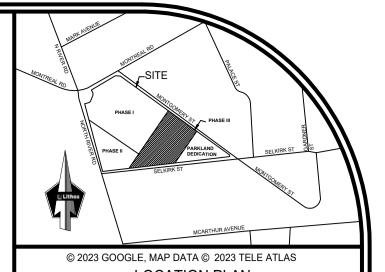

LOCATION PLAN NTS

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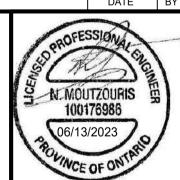
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JUN 13, 2023 DATE REVISION



CITY OF OTTAWA

**DETAIL DRAWINGS** 

RESIDENTIAL USE DEVELOPMENT 300 MONTGOMERY STREET OTTAWA, ONTARIO





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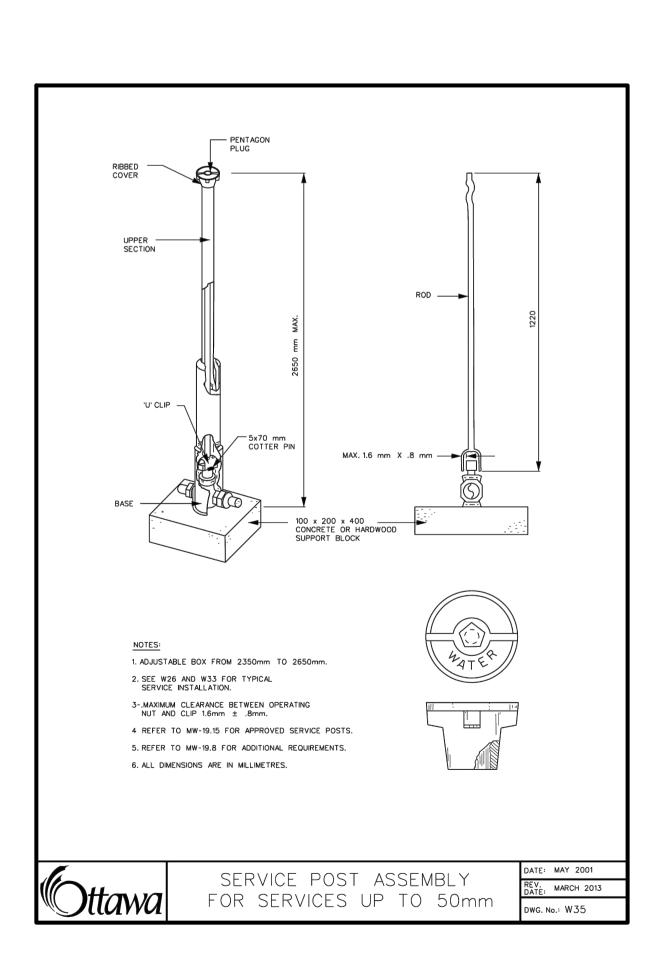
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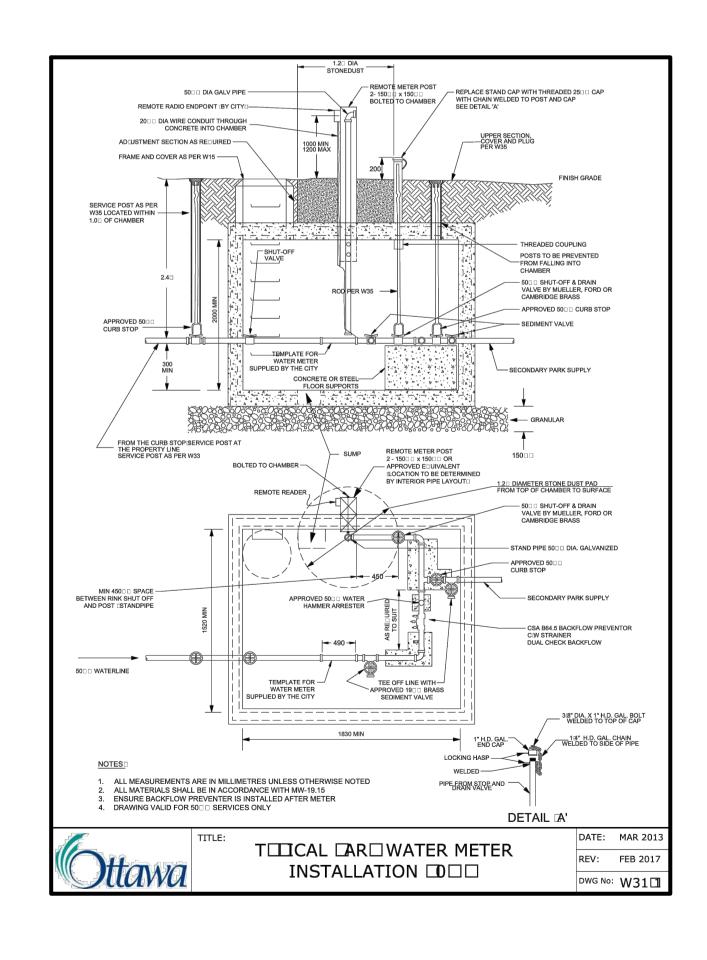
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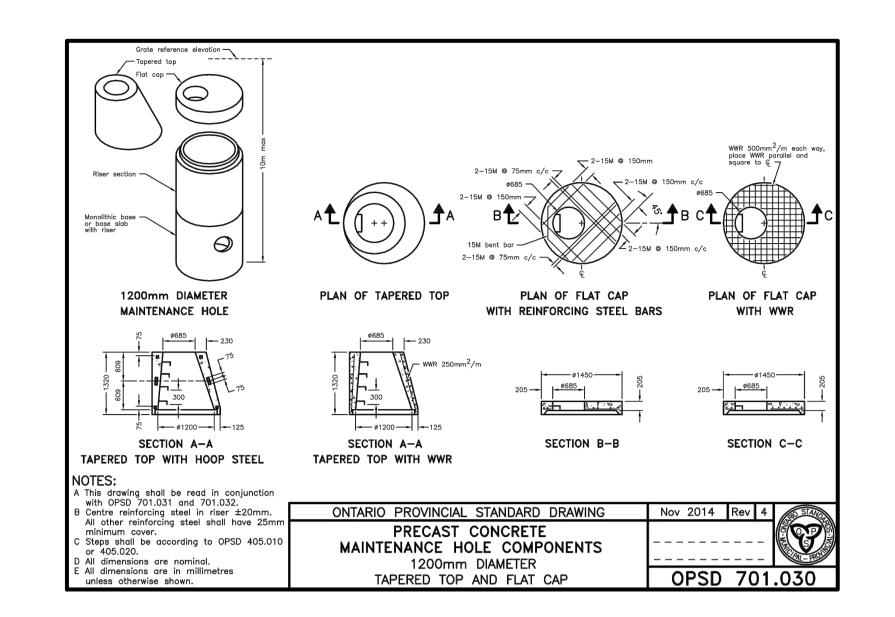
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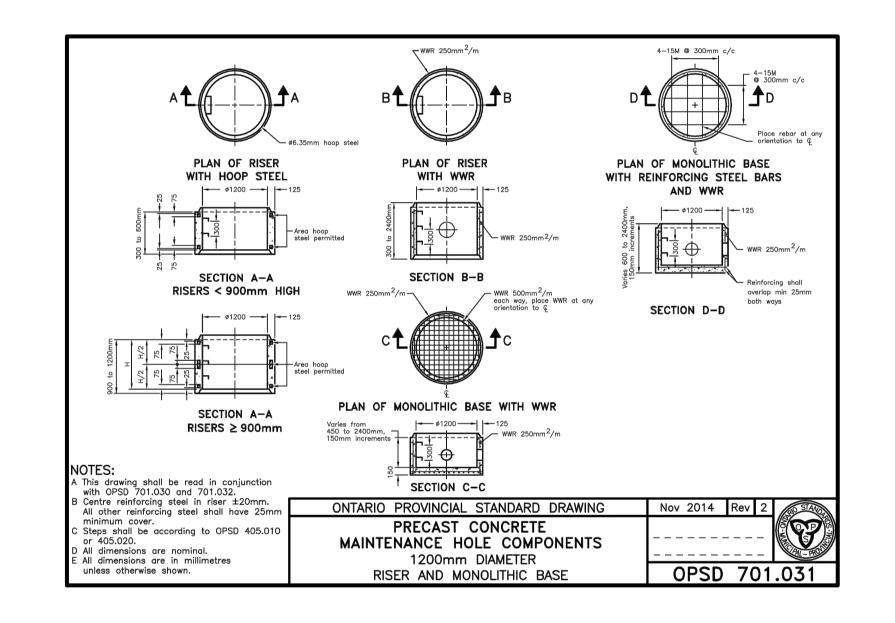










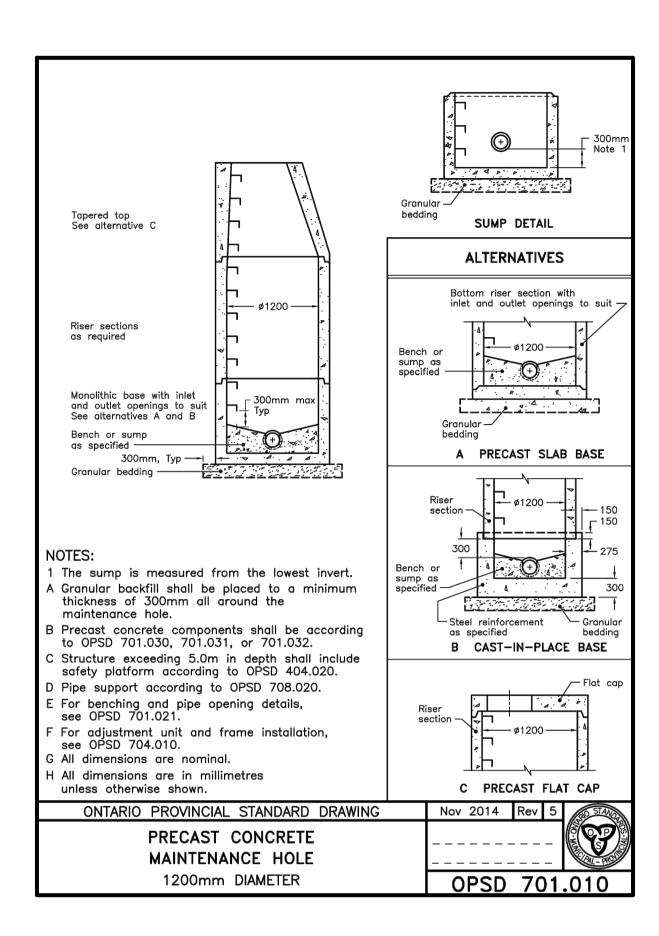

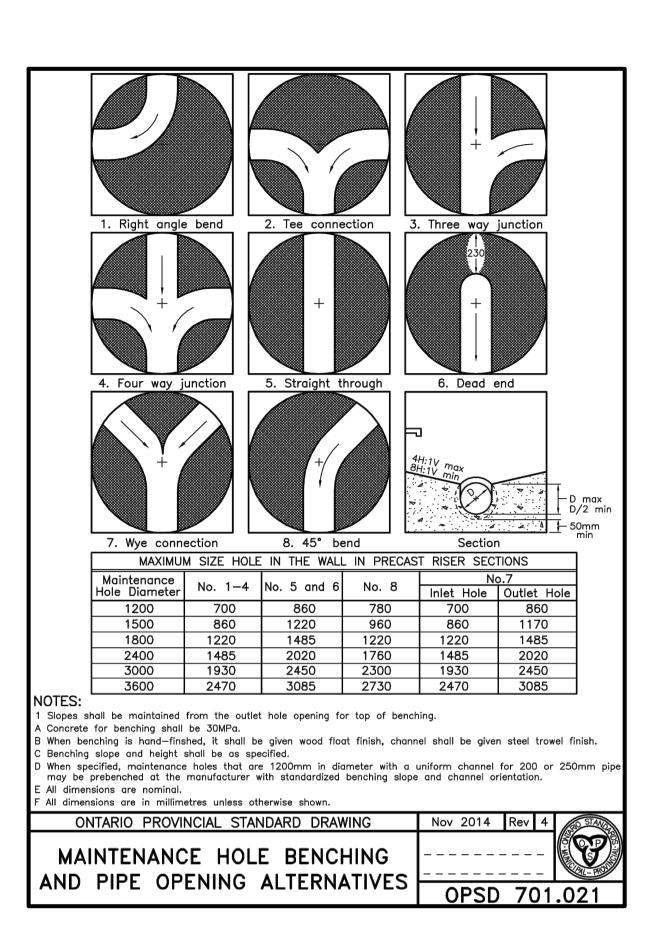

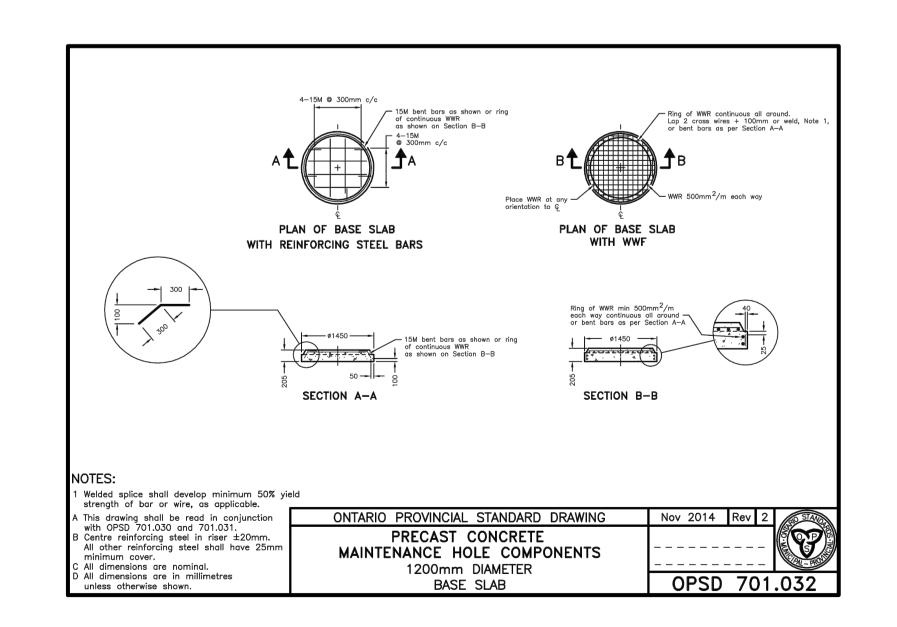

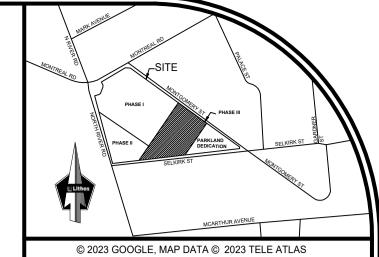

LOCATION PLAN NTS

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EC-01 (EROSION CONTROL PLAN) DD-01 (DETAIL DRAWINGS)

DD-02 (DETAIL DRAWINGS)

DD-03 (DETAIL DRAWINGS) CU-01 (COMPOSITE UTILITIES PLAN)

RM-01 (REMOVALS PLAN) RR-01 (ROADWAY REINSTATEMENT PLAN)

#### SITE PLAN INFORMATION

RODERICKLAHEY ARCHITECTS INC.

56 Beech Street, Ottawa, Ontario K1S 3J6 TEL.: 613.724.9932 FAX: 613 724 1209

www.rodericklahey.ca

**SURVEY INFORMATION** 

ANNIS, O' SULLIVAN, VOLLEBEKK LTD. ONTARIO LAND SERVEYORS

14 CONCOURSE GATE, SUITE 500

NEPEAN, ON K2E 7S6

T: (613) 727-0850 F: (613) 727-1079

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#### BENCHMARK

ELEVATIONS SHOWN HEREON ARE GEODETIC AND ARE REFERRED TO THE CGVD28 GEODETIC DATUM, DERIVED FROM CITY OF OTTAWA BENCHMARK No. 3465 HAVING AN ELEVATION OF 62.831m.

ISSUED FOR ZBA/SPA JUN 13, 2023 DATE REVISION



CITY OF OTTAWA

**DETAIL DRAWINGS** 

RESIDENTIAL USE DEVELOPMENT 300 MONTGOMERY STREET OTTAWA, ONTARIO



150 Bermomdsey Road , Toronto, Ontario M4A 1Y1 DATE: JUNE, 2021 CHECKED BY: DESIGNED BY: EG RAWN BY: EG

SCALE: N.T.S.

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APPROVED BY:N DRAWING No UD23-002 DD-03

