


LEGEND

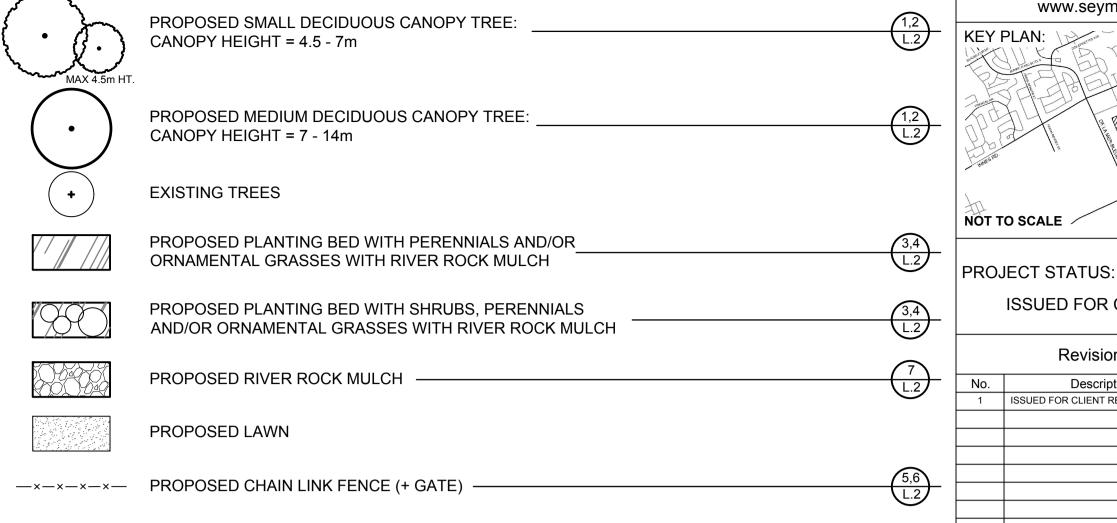

GENERAL NOTES

- ALL LANDSCAPED AREAS TO BE IRRIGATED.
- 2. REFER TO ARCHITECTURAL DRAWINGS FOR ALL SITE FURNISHINGS AND SURFACING.

PROPOSED SITE SIGNAGE

PROPOSED WOOD SCREEN FENCE

3. REFER TO ENGINEERING DRAWINGS FOR ALL SITE SERVICING.

PROPERTY LINE

PLANTING NOTES

- CONTRACTOR TO VERIFY LOCATION OF ALL UTILITIES PRIOR TO EXCAVATION.
- LOCATION OF ALL PLANT MATERIAL TO BE STAKED BY THE CONTRACTOR AND VERIFIED IN THE FIELD BY THE PROJECT MANAGER PRIOR TO THE EXCAVATION OF TREE PITS AND PLANTING BEDS.
- ALL PLANT MATERIAL SHALL BE NURSERY GROWN STOCK UNLESS OTHERWISE NOTED.
- 4. DECIDUOUS TREES TO HAVE A MINIMUM 1800 CLEAR STEM ABOVE GRADE.
- DECIDUOUS TREES TO HAVE A MINIMUM SETBACK FROM ALL BUILDING FOUNDATIONS IN ACCORDANCE WITH THE CITY OF OTTAWA TREE PLANTING IN SENSITIVE MARINE CLAY SOILS (2017 GUIDELINES) AND GEOTECHNICAL INVESTIGATION BY PATERSON GROUP DATED MARCH 22, 2023, REFER TO GUIDELINES BELOW.
- ALL PLANT MATERIAL SHALL BE WARRANTIED FOR TWO YEARS FROM THE DATE OF PERFORMANCE ACCEPTANCE AS DETERMINED BY THE PROJECT MANAGER.


- 7. ALL STEEL STAKING POSTS TO BE REMOVED AFTER ONE GROWING SEASON UNLESS OTHERWISE DIRECTED BY THE PROJECT MANAGER.
- 8. CONTRACTOR TO MAKE GOOD ALL EXISTING AREAS DAMAGED BY HIS OR HER WORK TO THE SATISFACTION OF THE PROJECT MANAGER
- 9. ANY PROPOSED PLANT MATERIAL SUBSTITUTIONS SHALL BE MADE WITH PLANTS OF EQUIVALENT OVERALL FORM, HEIGHT, HABIT, FLOWER, LEAF. COLOUR AND CULTURE AND ONLY AFTER WRITTEN APPROVAL FROM THE PROJECT MANAGER.
- 10. ALL SOD AREAS TO RECEIVE A MINIMUM 150 MM OF IMPORTED TOPSOIL.
- 11. ALL SOD TO BE NUMBER ONE TURF GRASS NURSERY SOD THAT HAS BEEN ESPECIALLY SOWN AND CULTIVATED IN NURSERY FIELDS AS TURF

NOTE: CITY OF OTTAWA POLICY RE: PLANTING IN DEVELOPMENTS WITH CLAY SUBSOILS

- CONSIDERATION FOR TREE PLANTING IN MARINE CLAY SOILS HAVE BEEN MADE ACCORDING TO RECOMMENDATIONS PROVIDED BY PATERSON GROUP IN THEIR GEOTECHNICAL INVESTIGATION PROPOSED MULTI-BUILDING DEVELOPMENT 4200 INNES ROAD OTTAWA, ONTARIO, REPORT PG6528-1 REVISION 1 DATED MARCH 22, 2023.
- 2. THE FOLLOWING TREE PLANTING SETBACKS ARE RECOMMENDED FOR THE LOW TO MEDIUM SENSITIVITY SILTY CLAY DEPOSIT AND WHERE TREES ARE LOCATED NEAR BUILDINGS FOUNDED ON COHESIVE SOILS. IT SHOULD BE NOTED THAT FOOTINGS BEARING UPON A COMPACT GLACIAL TILL OR SURFACE SOUNDED BEDROCK WILL NOT BE SUBJECT TO TREE PLANTING SETBACKS RESTRICTIONS.
 - LARGE TREES (MATURE HEIGHT OVER 14m) CAN BE PLANTED WITHIN THESE AREAS PROVIDED THAT A TREE TO FOUNDATION SETBACK EQUAL TO THE FULL MATURE HEIGHT OF THE TREE CAN BE PROVIDED.
 - TREE PLANTING SETBACK LIMITS MAY BE REDUCED TO 4.5 m FOR SMALL (MATURE TREE HEIGHT UP TO 7.5m) AND MEDIUM SIZE TREES (MATURE TREE HEIGHT 7.5 m TO 14 m), PROVIDED THAT THE CONDITIONS NOTED BELOW ARE MET.
 - A SMALL TREE MUST BE PROVIDED WITH A MINIMUM OF 25 M³ OF AVAILABLE SOILS VOLUME WHILE A MEDIUM TREE MUST BE PROVIDED WITH A MINIMUM OF 30 M3 OF AVAILABLE SOIL VOLUME, AS DETERMINED BY THE LANDSCAPE ARCHITECT. THE DEVELOPER IS TO ENSURE THAT THE SOIL IS GENERALLY UN-COMPACTED WHEN BACKFILLING IN STREET TREE PLANTING LOCATIONS.
 - THE TREE SPECIES MUST BE SMALL (MATURE TREE HEIGHT UP TO 7.5 m) TO MEDIUM SIZE (MATURE TREE HEIGHT 7.5 m TO 14 m) AS CONFIRMED BY THE LANDSCAPE ARCHITECT.

GRADING SURROUNDING THE TREE MUST PROMOTE DRAINAGE TO THE TREE ROOT ZONE (IN SUCH A MANNER AS NOT TO BE DETRIMENTAL TO THE TREE), AS NOTED ON THE GRADING PLAN.

SCALE - 1:300

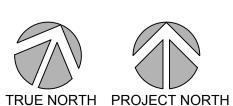

DRAWING #:

ADDITIONAL CLAIMS AND COSTS RELATED TO NON-MATERIAL CHANGES WILL NOT BE ACCEPTED BY SEYMOUR PACIFIC DEVELOPMENTS LTD. NON-MATERIAL CHANGES ARE DEEMED TO BE PLAN CHANGES OR SPECIFICATION ADJUSTMENTS THAT DO NOT SUBSTANTIALLY AFFECT THE VALUE, TIME, COST AND QUALITY OF

CONTRACTORS SHALL MAKE EVERY REASONABLE EFFORT TO MAINTAIN SCHEDULE TARGETS AND PROVIDE GOOD EFFICIENCY, PROGRESS, WORKMANSHIP AND QUALITY TOWARD DEFICIENCY-FREE RESULTS.

SEYMOUR PACIFIC

100 St Anns Street, Campbell River, B.C.

(T)250.286.8045 (F)250.286.8046 www.seymourpacific.ca

ISSUED FOR COORDINATION

Revision Schedule

studio

TRADE CONTRACTORS SHALL VERIFY ALL

DISCREPANCIES OR INCONSISTENCIES TO SEYMOUR PACIFIC DEVELOPMENTS LTD.,

WITHOUT DELAY, FOR CLARIFICATION

AND/OR CONFIRMATION. DO NOT SCALE

DRAWINGS USED AS INSTRUMENTS OF

AND PROPERTY OF SEYMOUR PACIFIC

OR USE FOR ANY PURPOSE OTHER THAN

THAT AUTHORIZED BY SEYMOUR PACIFIC

CONTRACTORS SHALL REMAIN FAMILIAR

PERFORM IN ACCORDANCE WITH LOCAL

CODES. CONTRACTORS SHALL MAINTAIN

GOOD INDUSTRY BUILDING AND SAFETY

DEVELOPMENTS LTD. IS PROHIBITED.

WITH, SHALL REFER TO, AND SHALL

LAWS, REGULATIONS AND BUILDING

PRACTICES CONSISTENT WITH THE CONTRACT INTENT AND THE

REQUIREMENTS OF JURISDICTIONAL

DRAWINGS. DESIGNS REPRESENTED AND

SERVICE SHALL REMAIN THE COPYRIGHT

DIMENSIONS AND REPORT ANY

DEVELOPMENTS LTD. ANY

REPRODUCTION

AUTHORITIES.

ISSUED FOR CLIENT REVIEW

Revision Date

NOT TO SCALE

SEAL:

PROJECT NAME:

CONSTRUCTION.

TRINITY CROSSING APARTMENTS

PROJECT NUMBER:

CITY OF OTTAWA:

ADDRESS:


4200 INNES ROAD

OTTAWA, ON


DRAWING TITLE: LANDSCAPE

CONCEPT PLAN K. SELIN DRAWN BY:


CHECKED BY: K. CERVENY 2023-05-24 DATE: SCALE: 1:300 REV #:

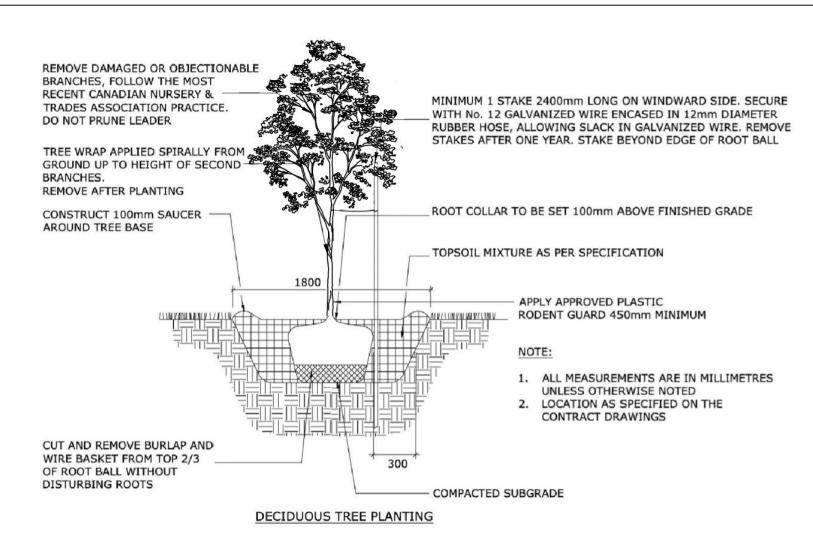

DECIDUOUS TREE PLANTING IN GRASSED AREAS

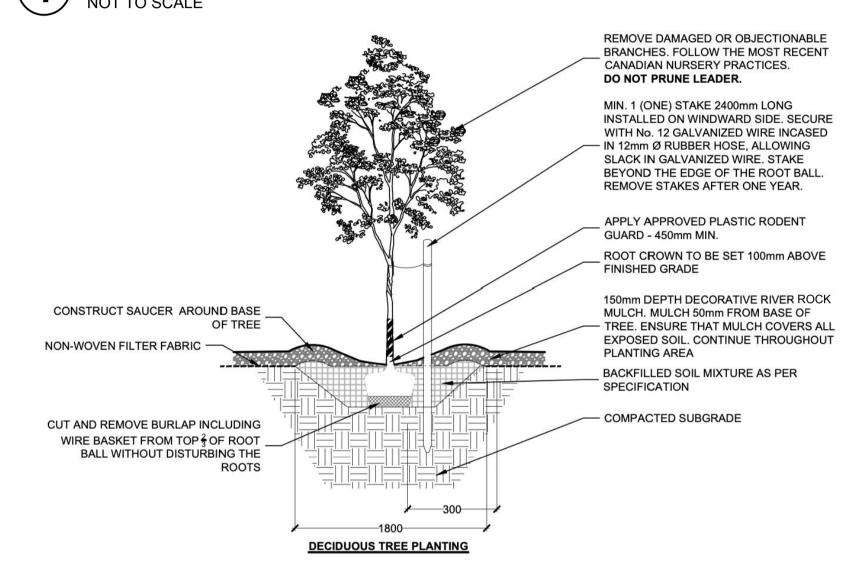


DECIDUOUS TREE PLANTING IN RIVER ROCK MULCH NOT TO SCALE

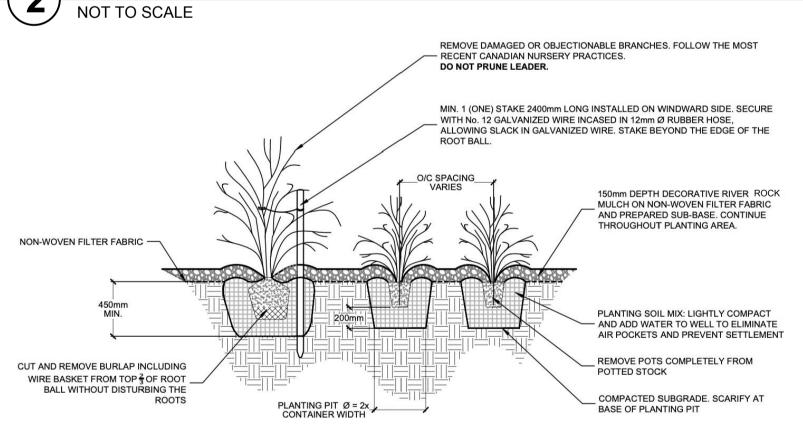

1. ALL MEASUREMENTS IN MILLIMETERS UNLESS OTHERWISE NOTED.
2. LOCATION OF SHRUBS SPECIFIED ON DRAWINGS L.1 - L.5.
3. PLANTING SOIL MIX AS PER SPECIFICATIONS
4. PROVIDE 100mm HIGH EARTH SAUCER AROUND SHRUBS.
5. STAKE SHRUBS LARGER THAN 1500mm TALL AT TIME OF PLANTING.

CONTINUOUS SHRUB PLANTING IN RIVER ROCK MULCH

STAKES TO BE REMOVED AT THE END OF THE WARRANTY PERIOD.

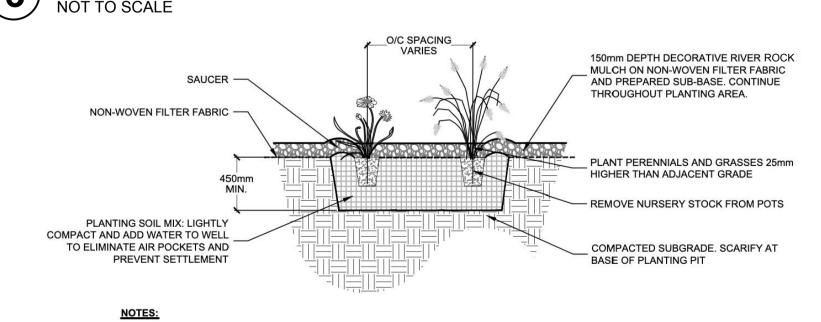


ALL MEASUREMENTS IN MILLIMETERS UNLESS OTHERWISE NOTED.
 LOCATION OF PERENNIAL BEDS SPECIFIED ON DRAWINGS L.1 - L.5.
 PLANTING SOIL MIX AS PER SPECIFICATIONS.

4. PROVIDE 100mm HIGH EARTH SAUCER AROUND PERENNIAL/GRASS BED.

PERENNIAL AND ORNAMENTAL GRASS PLANTING IN MULCH

NOT TO SCALE

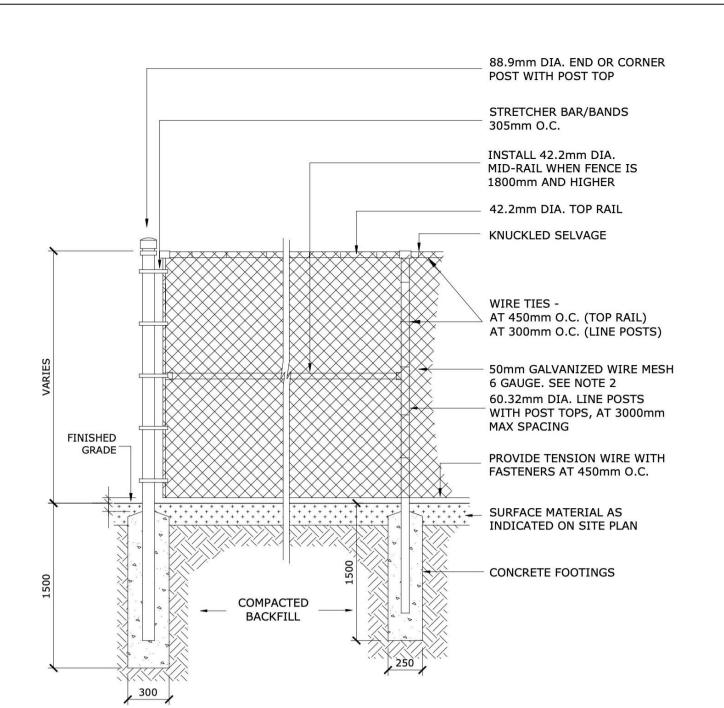


NOTES:

- ALL MEASUREMENTS ARE IN MILLIMETRES UNLESS OTHERWISE NOTED
- 2. IF FENCE IS TO BE BLACK VINYL, THE FENCE SHOULD BE 9 GAUGE GALVANIZED WIRE CORE WITH BLACK VINYL COATING TO PROVIDE A TOTAL OF 6 GAUGE THICKNESS
- POSTS, RAILS AND ALL OTHER HARDWARE SHOULD BE ELECTROSTATIC PAINTED
 CONCRETE FOOTING SHALL BE CSA 30MPa CLASS F-1

CHAIN LINK FENCE

NOT TO SCALE

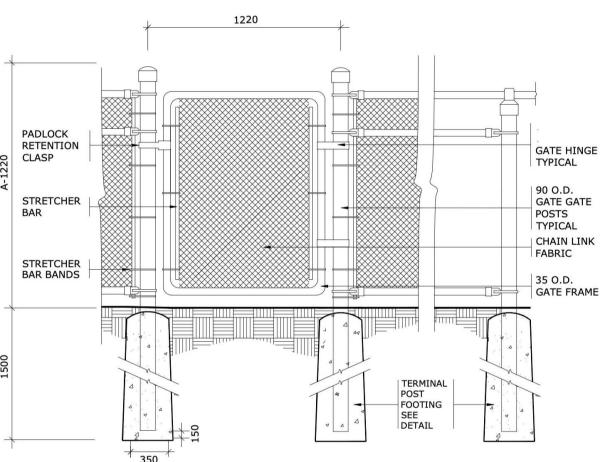


NOTES:

- ALL MEASUREMENTS ARE IN MILLIMETRES UNLESS OTHERWISE NOTED
 GATE FRAMES SHALL BE CONSTRUCTED OF 33 O.D. GALVANIZED STEEL PIPE, SHOP BENT, WELDED.
- AND GROUND SMOOTH

 3. STRETCHER BARS TO BE 5 x 19 MINIMUM

 4. STRETCHER BAR BANDS 300 O.C., 6 x 19 MINIMUM
- 5. CHAIN LINK FENCE TO BE BLACK VINYL COATED, 38 WOVEN MESH, 6 GAUGE O.D. OF 9 GAUGE GALVANIZED STEEL CORE FASTENED TO LINE POSTS, TOP RAIL, MID RAIL, INTERMEDIATE RAIL, AND BOTTOM RAIL, AND GATE FRAME WITH 3.5 (9 GAUGE) KNUCKLED FASTENERS
- PADLOCK RETENTION CLASPS TO BE INSTALLED
 FINISH OF FABRIC AND TIES TO MATCH ADJACENT FENCE
- 8. ALL FENCE POSTS, GATE FRAMES, AND RAILS TO BE GALVANIZED SCHEDULE '40' PIPE 9. NO PLASTIC FITTING OR COMPONENTS ARE TO BE USED
- 10. WELD ALL JOINTS

6 CHAIN LINK FENCE GATE NOT TO SCALE

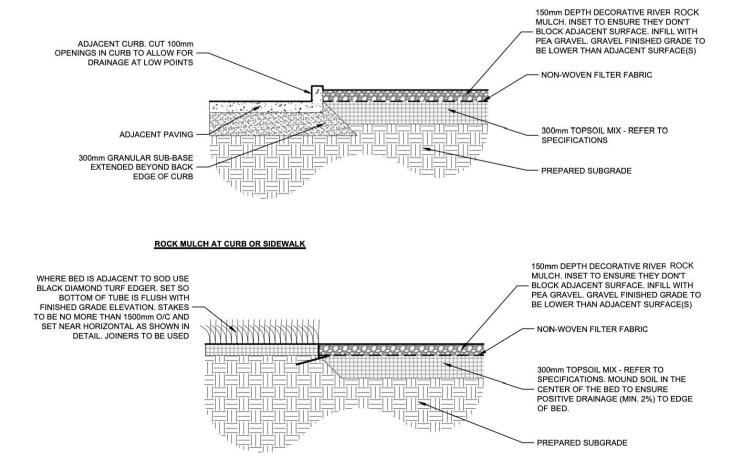

ROCK MULCH AT TURF EDGE



PROPOSED PLANT LIST

KEY	QTY	BOTANICAL NAME	COMMON NAME	CAL/ HT.	CONDITION/ REMARKS
ECIDUC	OUS TRE	ES			
Ac	7	Amelanchier canadensis	Serviceberry	50 mm Cal.	W/B
Ag	5	Acer ginnala 'Ruby Slippers'	Ruby Slippers Amur Maple	50 mm Cal.	W/B
AsC	1	Acer saccharum 'Commemoration'	Commemoration Sugar Maple	50 mm Cal.	W/B
AxG	4	Amelanchier x grandiflora 'Robin Hill'	Robin Hill Serviceberry	50 mm Cal.	Tree Form W/B
Сс	2	Corylus colurna	Turkish Hazel	50 mm Cal.	W/B
CcG	3	Crataegus crus-galli 'Crusader'	Crusader Hawthorn	50 mm Cal.	Tree Form W/B
CxJ	5	Cercis canadensis 'Joy's Pride'	Joy's Pride Redbud	50 mm Cal.	Tree Form W/B
GtS	1	Gleditsia triacanthos var. inermis 'Skyline'	Thornless Honey Locust	50 mm Cal.	W/B
Ms	8	Magnolia stellata 'Royal Star'	Royal Star Magnolia	175 cm Ht.	Potted
MxB	1	Malus 'Branzam' - Brandywine	Brandywine Crabapple	50 mm Cal.	W/B
MxD	4	Malus 'Dolgo'	Dolgo Crabapple	50 mm Cal.	W/B
MxR	1	Malus x 'Royal Raindrops'	Royal Raindrops Crabapple	50 mm Cal.	W/B
Pv	1	Prunus virginiana	Common Chokecherry	50 mm Cal.	Tree Form W/B
Qp	1	Quercus palustris	Pin Oak	50 mm Cal.	W/B
Тс	1	Tilia cordata	Littleleaf Linden	50 mm Cal.	W/B
ECIDUC	OUS SHE	RUBS	•		
Ah	47	Hydrangea arborescens 'Annabelle'	Annabelle Hydrangea	100 cm Ht.	Container
Cs	9	Cornus sericea	Red Osier Dogwood	50 cm Ht.	Container
Ds	79	Diervilla sessilifolia	Southern Bush Honeysuckle	50 cm Ht.	Container
DsC	45	Diervilla sessilifolia 'Cool Splash'	Cool Splash Bush Honeysuckle	50 cm Ht.	Container
Po	52	Physocarpus opulifolius	Common Ninebark	50 cm Ht.	Container
PoD	43	Physocarpus opulifolius 'Monlo' - Diablo	Diablo Ninebark	50 cm Ht.	Container
Ra	116	Rhus aromatica 'Gro-Low'	Gro-Low Fragrant Sumac	50 cm Ht.	Container
Rb	69	Rosa blanda	Meadow Rose	50 cm Ht.	Container
Rr	84	Rosa rugosa	Rugosa Rose	50 cm Ht.	Container
Sa	37	Symphoricarpos albus	Snowberry	50 cm Ht.	Container
Sj	29	Spiraea japonica 'Anthony Waterer'	Anthony Waterer Spirea	50 cm Ht.	Container
ERENN	ALS AN	D ORNAMENTAL GRASSES	-	'	
AcM	147	Astilbe chinensis 'Maggie Daley'	Maggie Daley Astilbe	1 gal.	Container
Am	396	Achillea millefolium	Common Yarrow	1 gal.	Container - Mixed Cultiva
Вс	68	Berginia cordifolia	Pigsqueak	1 gal.	Container
Cb	117	Calamagrostis brachytricha	Autumn Feather Reed Grass	1 gal.	Container
Em	83	Eurybia macrophylla	Large Leaf Aster	1 gal.	Container
Ер	110	Echinacea purpurea	Coneflower	1 gal.	Container
Ho	145	Hosta	Plantain Lily	1 gal.	Container - Mixed Cultvar
Hx	232	Hemerocallis	Daylily	1 gal.	Container - Mixed Cultivar
Nf	214	Nepeta faassenii 'Cat's Pyjamas'	Catmint	1 gal.	Container
Rh	80	Rudbeckia hirta	Black-eye Susan	1 gal.	Container


NOTE

1. RIVER ROCK SIZE TO BE 100-150mm DIAMETER.



DEVELOPMENTS LTD.

100 St Anns Street, Campbell River, B.C.
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PROJECT STATUS:

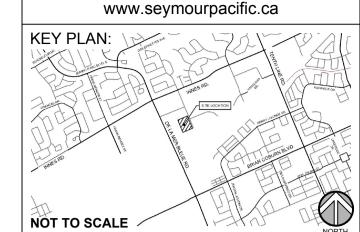ISSUED FOR COORDINATION

Revision Schedule

Description Revision Date

1 ISSUED FOR CLIENT REVIEW 2023-05-24	NO.	Description	INEVISION Dat
	1	ISSUED FOR CLIENT REVIEW	2023-05-24

SEAL:



TRADE CONTRACTORS SHALL VERIFY ALL DIMENSIONS AND REPORT ANY DISCREPANCIES OR INCONSISTENCIES TO SEYMOUR PACIFIC DEVELOPMENTS LTD., WITHOUT DELAY, FOR CLARIFICATION AND/OR CONFIRMATION. DO NOT SCALE DRAWINGS. DESIGNS REPRESENTED AND DRAWINGS USED AS INSTRUMENTS OF SERVICE SHALL REMAIN THE COPYRIGHT AND PROPERTY OF SEYMOUR PACIFIC DEVELOPMENTS LTD. ANY REPRODUCTION OR USE FOR ANY PURPOSE OTHER THAN THAT AUTHORIZED BY SEYMOUR PACIFIC

CONTRACTORS SHALL REMAIN FAMILIAR WITH, SHALL REFER TO, AND SHALL PERFORM IN ACCORDANCE WITH LOCAL LAWS, REGULATIONS AND BUILDING CODES. CONTRACTORS SHALL MAINTAIN GOOD INDUSTRY BUILDING AND SAFETY PRACTICES CONSISTENT WITH THE CONTRACT INTENT AND THE REQUIREMENTS OF JURISDICTIONAL AUTHORITIES.

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EFFICIENCY, PROGRESS, WORKMANSHIP
AND QUALITY TOWARD DEFICIENCY-FREE
RESULTS.

PROJECT NAME:

TRINITY CROSSING APARTMENTS

PROJECT NUMBER:

CITY OF OTTAWA:

ADDRESS:

4200 INNES ROAD OTTAWA, ON

DRAWING TITLE:

DETAILS

DRAWN BY: K. SELIN
CHECKED BY: K. CERVENY
DATE: 2023-05-24
SCALE: AS NOTED

DRAWING #:

1 2

