


OBC MATRIX


NAME OF PRACTICE: WARE MALCOMB (A BUSINESS NAME OF WMA INC.) CERTIFICATE OF PRACTICE NUMBER: 3619 NAME OF PROJECT: 2760-2770 SHEFFIELD ROAD LOCATION: 2760 SHEFFIELD RD. OTTAWA ON K1B 3V9, CANADA.		BUILDING CODE REFERENCE: REFERENCES ARE TO DIVISION B UNLESS NOTED. (A) FOR DIVISION A OR (C) FOR DIVISION C.																																																								
ITEM	ONTARIO BUILDING CODE DATA MATRIX PARTS 3 OR 9																																																									
1	PROJECT DESCRIPTION: <input checked="" type="checkbox"/> NEW <input type="checkbox"/> PART 11 <input type="checkbox"/> PART 3 <input type="checkbox"/> PART 9 INDUSTRIAL SHELL BUILDING <input type="checkbox"/> ADDITION 11.1 TO 11.4 1.1.2 (A) 1.1.2 (A) & 9.10.1.3 <input type="checkbox"/> CHANGE OF USE <input type="checkbox"/> ALTERATION																																																									
2	MAJOR OCCUPANCY(S) GROUP F, DIVISION 2; GROUP D (SUBSIDIARY)	3.1.2.1.(1)	9.10.2																																																							
3	BUILDING AREA (sq.m.) NEW: 10,564.4 SM TOTAL: 10,564.4 SM	1.4.1.2 (A)	1.4.1.2 (A)																																																							
4	GROSS AREA (sq.m.) NEW: 10,564.4 SM TOTAL: 10,564.4 SM	1.4.1.2 (A)	1.4.1.2 (A)																																																							
5	NUMBER OF STOREYS ABOVE GRADE: 1 BELOW GRADE: N/A	1.4.1.2 (A) & 3.2.1.1	1.4.1.2 (A) & 9.10.4																																																							
6	NUMBER OF STREETS / FIRE FIGHTER ACCESS: 3	3.2.2.10 & 3.2.5.5	9.10.20																																																							
7	BUILDING CLASSIFICATION(S) 3.2.2.67 GROUP F, DIV 2, ANY HEIGHT, ANY AREA SPRINKLERED	3.2.2.20-83	9.10.2																																																							
8	SPRINKLER SYSTEM PROPOSED <input checked="" type="checkbox"/> ENTIRE BUILDING 3.2.2.20-83 9.10.8.2 <input type="checkbox"/> SELECTED COMPARTMENTS 3.2.1.5 <input type="checkbox"/> SELECTED FLOOR AREAS 3.2.2.17 <input type="checkbox"/> BASEMENT <input type="checkbox"/> IN LIEU OF ROOF RATING INDEX INDEX <input type="checkbox"/> NOT REQUIRED																																																									
9	STANDPIPE REQUIRED <input type="checkbox"/> YES <input checked="" type="checkbox"/> NO	3.2.9	N/A																																																							
10	FIRE ALARM REQUIRED <input type="checkbox"/> YES <input checked="" type="checkbox"/> NO	3.2.4	9.10.18																																																							
11	WATER SERVICE / SUPPLY IS ADEQUATE <input checked="" type="checkbox"/> YES <input type="checkbox"/> NO <input type="checkbox"/> N/A	3.2.5.7	N/A																																																							
12	HIGH BUILDING <input type="checkbox"/> YES <input checked="" type="checkbox"/> NO	3.2.6	N/A																																																							
13	CONSTRUCTION RESTRICTIONS <input type="checkbox"/> COMBUSTIBLE PERMITTED <input checked="" type="checkbox"/> NON-COMBUSTIBLE REQUIRED <input type="checkbox"/> BOTH 3.2.2.20-83 9.10.6 ACTUAL CONSTRUCTION <input type="checkbox"/> COMBUSTIBLE <input checked="" type="checkbox"/> NON-COMBUSTIBLE <input type="checkbox"/> BOTH																																																									
14	MEZZANINE(S) AREA m2 N/A	3.2.1.1.(3)-(8)	9.10.4.1																																																							
15	OCCUPANT LOAD BASED ON <input type="checkbox"/> m2 / PERSON <input type="checkbox"/> DESIGN OF BUILDING 3.1.17 9.9.1.3 1ST FLOOR: OCCUPANCY: F2/D LOAD (PERSONS): <300 2ND FLOOR: XX OCCUPANCY: XX LOAD (PERSONS): XX																																																									
16	BARRIER-FREE DESIGN <input checked="" type="checkbox"/> YES <input type="checkbox"/> NO	3.8	9.5.2																																																							
17	HAZARDOUS SUBSTANCES <input type="checkbox"/> YES <input checked="" type="checkbox"/> NO	3.3.1.2 & 3.3.1.19	9.10.1.3 (4)																																																							
18	REQUIRED FIRE RESISTANCE RATING (FRR) HORIZONTAL ASSEMBLIES FRR (HOURS) LISTED DESIGN No. OR DESCRIPTION (SG-2) 3.2.2.20-83 & 3.2.1.4 9.10.8 9.10.9 FLOORS: 2 HOURS ROOF: - HOURS MEZZANINE: 1 HOURS FRR OF SUPPORTING MEMBERS LISTED DESIGN No. OR DESCRIPTION (SG-2) FLOORS: 2 HOURS ROOF: - HOURS MEZZANINE: 1 HOURS																																																									
19	SPATIAL SEPARATION - CONSTRUCTION OF EXTERIOR WALLS 3.2.3 9.10.14 <table border="1"> <thead> <tr> <th>WALL</th> <th>AREA OF EBF (sq. m.)</th> <th>LD (m)</th> <th>L/H OR H/L</th> <th>PERMITTED MAX. % OF OPENINGS</th> <th>PROPOSED % OF OPENINGS</th> <th>FRR (HOURS)</th> <th>LISTED DESIGN No. OR DESCRIP.</th> <th>COMB. CONSTR.</th> <th>COMB. CONSTR. NONC. CLADDING</th> <th>NON-COMB. CONSTRUCTION</th> </tr> </thead> <tbody> <tr> <td>NORTH</td> <td>2537</td> <td>>15</td> <td>-</td> <td>-</td> <td>-</td> <td>-</td> <td>-</td> <td>-</td> <td>-</td> <td>-</td> </tr> <tr> <td>SOUTH</td> <td>2537</td> <td>>15</td> <td>-</td> <td>-</td> <td>-</td> <td>-</td> <td>-</td> <td>-</td> <td>-</td> <td>-</td> </tr> <tr> <td>EAST</td> <td>574</td> <td>>15</td> <td>-</td> <td>-</td> <td>-</td> <td>-</td> <td>-</td> <td>-</td> <td>-</td> <td>-</td> </tr> <tr> <td>WEST</td> <td>574</td> <td>13.76</td> <td>-</td> <td>89%</td> <td>-</td> <td>-</td> <td>-</td> <td>-</td> <td>-</td> <td>-</td> </tr> </tbody> </table>	WALL	AREA OF EBF (sq. m.)	LD (m)	L/H OR H/L	PERMITTED MAX. % OF OPENINGS	PROPOSED % OF OPENINGS	FRR (HOURS)	LISTED DESIGN No. OR DESCRIP.	COMB. CONSTR.	COMB. CONSTR. NONC. CLADDING	NON-COMB. CONSTRUCTION	NORTH	2537	>15	-	-	-	-	-	-	-	-	SOUTH	2537	>15	-	-	-	-	-	-	-	-	EAST	574	>15	-	-	-	-	-	-	-	-	WEST	574	13.76	-	89%	-	-	-	-	-	-		
WALL	AREA OF EBF (sq. m.)	LD (m)	L/H OR H/L	PERMITTED MAX. % OF OPENINGS	PROPOSED % OF OPENINGS	FRR (HOURS)	LISTED DESIGN No. OR DESCRIP.	COMB. CONSTR.	COMB. CONSTR. NONC. CLADDING	NON-COMB. CONSTRUCTION																																																
NORTH	2537	>15	-	-	-	-	-	-	-	-																																																
SOUTH	2537	>15	-	-	-	-	-	-	-	-																																																
EAST	574	>15	-	-	-	-	-	-	-	-																																																
WEST	574	13.76	-	89%	-	-	-	-	-	-																																																
20	PLUMBING FIXTURE REQUIREMENTS FEMALE/MALE COUNT AT XX % MALE/ XX % FEMALE UNLESS NOTED OTHERWISE PART 3 PART 9 TBD TOTAL: XX																																																									
21	OTHERS (DESCRIBE)																																																									

SHEFFIELD INDUSTRIAL BUILDING

2760-2770 SHEFFIELD RD. OTTAWA ON K1B 3V9, CANADA.

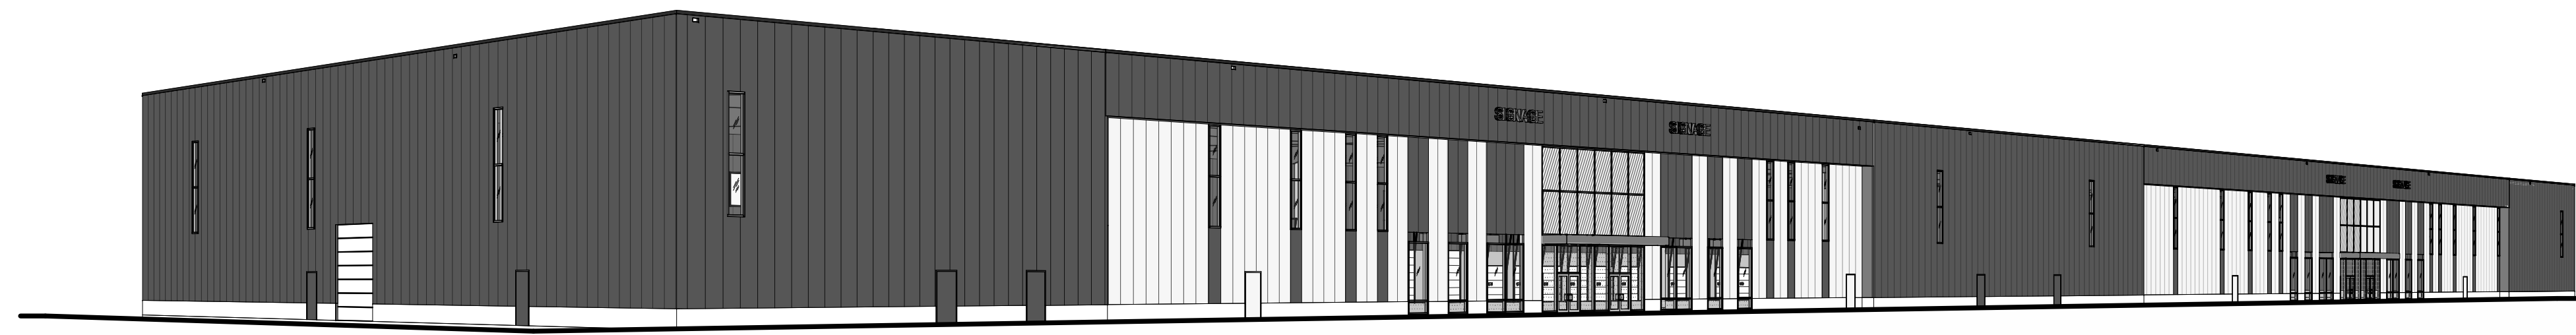

VICINITY MAP

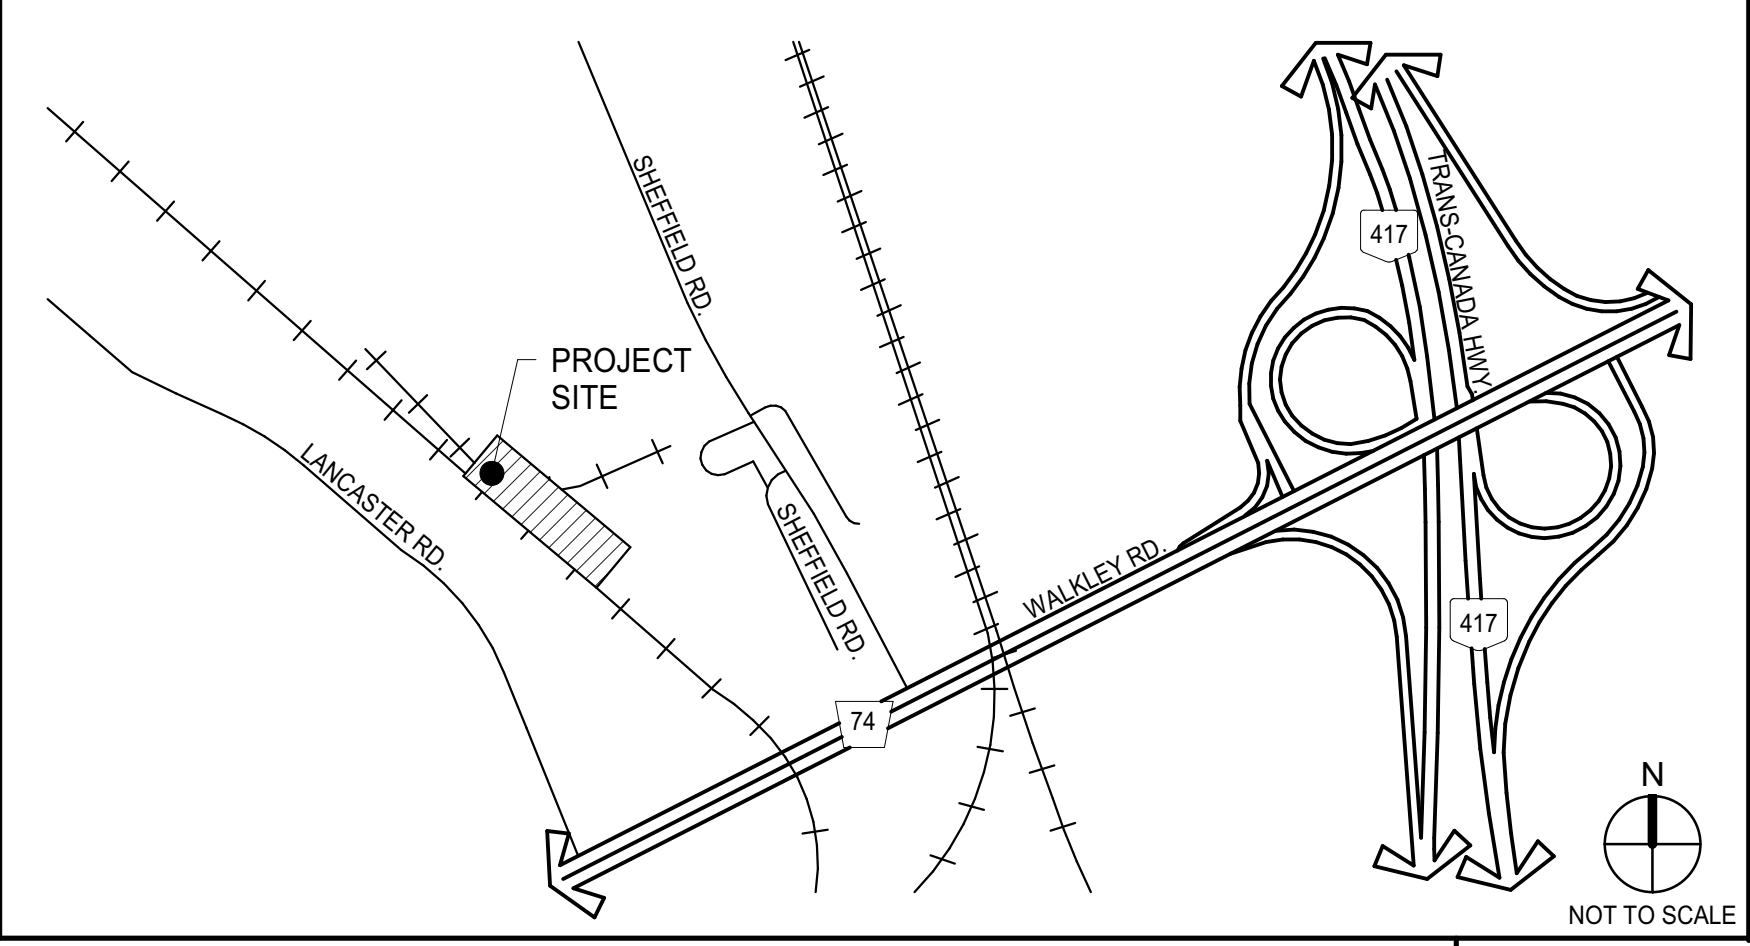

OWNER

RICHCRAFT PROPERTIES INC.
 2280 ST. LAURENT BLVD.
 SUITE 201
 OTTAWA, ON K1G 4K1

PRIMARY CONTACT: KEVIN YEMM
 PH: (613) 739-7111 EXT. 132
 EMAIL: KYEMM@RICHCRAFT.COM

OWNER'S CONSULTANTS

ENVIRONMENTAL CONSULTANT
 PATERSON GROUP
 9 AURIGA DRIVE,
 OTTAWA, ONTARIO K2E 7T9

PRIMARY CONTACT: MARK S. D'ARCY
 PH: (613) 226-7381 EXT. 207
 EMAIL: mdarcy@patersongroup.ca

ARCHITECT'S CONSULTANTS

LANDSCAPE ARCHITECT
 NAK DESIGN STRATEGIES
 1285 WELLINGTON STREET WEST,
 OTTAWA, ONTARIO K1Y 3A8

PRIMARY CONTACT: PAT GAUVREAU
 PH: (613) 237-2345 EXT. 28
 EMAIL: pgauvreau@nak-design.com

SHEET INDEX

ARCHITECTURAL

G010	TITLE SHEET
A100	SITE PLAN
A120	FLOOR PLAN
A190	ROOF PLAN
A210	EXTERIOR ELEVATIONS
A310	BUILDING SECTIONS
A310	ARCHITECTURAL SHEET COUNT: 6

ARCHITECT

WARE MALCOMB
 1420 BLAIR TOWERS PLACE,
 SUITE #104, GLOUCESTER,
 ONTARIO, CANADA K1J 9L8
 P 343.633.2977

PRIMARY CONTACT: JOHN HOLLAND
 PH: (905) 760-1221 EXT. 2134
 EMAIL: jholland@waremalcomb.com
 ALTERNATE CONTACT: HARRISON WERNER
 PH: (905) 760-1221 EXT. 2145
 EMAIL: hwerner@waremalcomb.com

GEOTECHNICAL ENGINEER
 PATERSON GROUP
 9 AURIGA DRIVE
 OTTAWA, ONTARIO K2E 7T9
 (613) 226-7381 EXT. 332

PRIMARY CONTACT: SCOTT DENNIS
 PH: (613) 226-7381 EXT. 332
 EMAIL: sdennis@patersongroup.ca

CIVIL ENGINEER
 WARE MALCOMB
 180 BASS PRO MILLS DR#103,
 VAUGHAN, ONTARIO L4K 0G9,

PRIMARY CONTACT: DAVID NEWSON
 PH: dnevson@waremalcomb.com
 EMAIL: (905) 760-1221 EXT. 2128

WARE MALCOMB
 1420 Blair Towers Place, Suite #104
 Gloucester, Ontario, Canada K1J 9L8
 P 343.633.2977

ARCHITECTURE CIVIL ENGINEERING
 PLANNING BRANDING
 INTERIORS BUILDING MEASUREMENT

ONTARIO ASSOCIATION
 OF
ARCHITECTS
 JOHN P. HOLLAND
 LICENCE
 8849

RICHCRAFT

SHEFFIELD INDUSTRIAL BUILDING
 2760-2770 SHEFFIELD RD.
 OTTAWA
 ON K1B 3V9, CANADA.

TITLE SHEET

DATE	REMARKS
2023-05-17 <td>ISSUED FOR SPA</td>	ISSUED FOR SPA
1	


PA/PM:	J. HOLLAND
DRAWN BY.:	D.P. / E.C.
JOB NO.:	OTW21-0002-00

SHEET
G010

THESE DRAWINGS AND SPECIFICATIONS ARE THE PROPERTY AND COPYRIGHT OF WARE MALCOMB AND SHALL NOT BE USED ON ANY OTHER WORK EXCEPT BY AGREEMENT WITH WARE MALCOMB. WRITTEN DIMENSIONS SHALL TAKE PRECEDENCE OVER SCALED DIMENSIONS AND SHALL BE KEPT ON THE JOB SITE. ANY DISCREPANCY SHALL BE BROUGHT TO THE NOTICE OF WARE MALCOMB PRIOR TO THE COMMENCEMENT OF ANY WORK.

SITE SURVEY INFORMATION:
 INFORMATION ON THIS PLAN WAS
 TAKEN FROM THE SURVEY PLAN
 PREPARED BY ANNIS, O'SULLIVAN,
 VOLLEBEKK Ltd DATED 2022-11-18

LEGAL DESCRIPTION:
 PLAN OF SURVEY OF
 PART OF BLOCK A
 REGISTERED PLAN 4M-121
 AND
 PART OF LOTS 24 AND 25
 CONCESSION 3 (OTTAWA FRONT)
 (GEOGRAPHIC TOWNSHIP OF GLOUCESTER)
 CITY OF OTTAWA

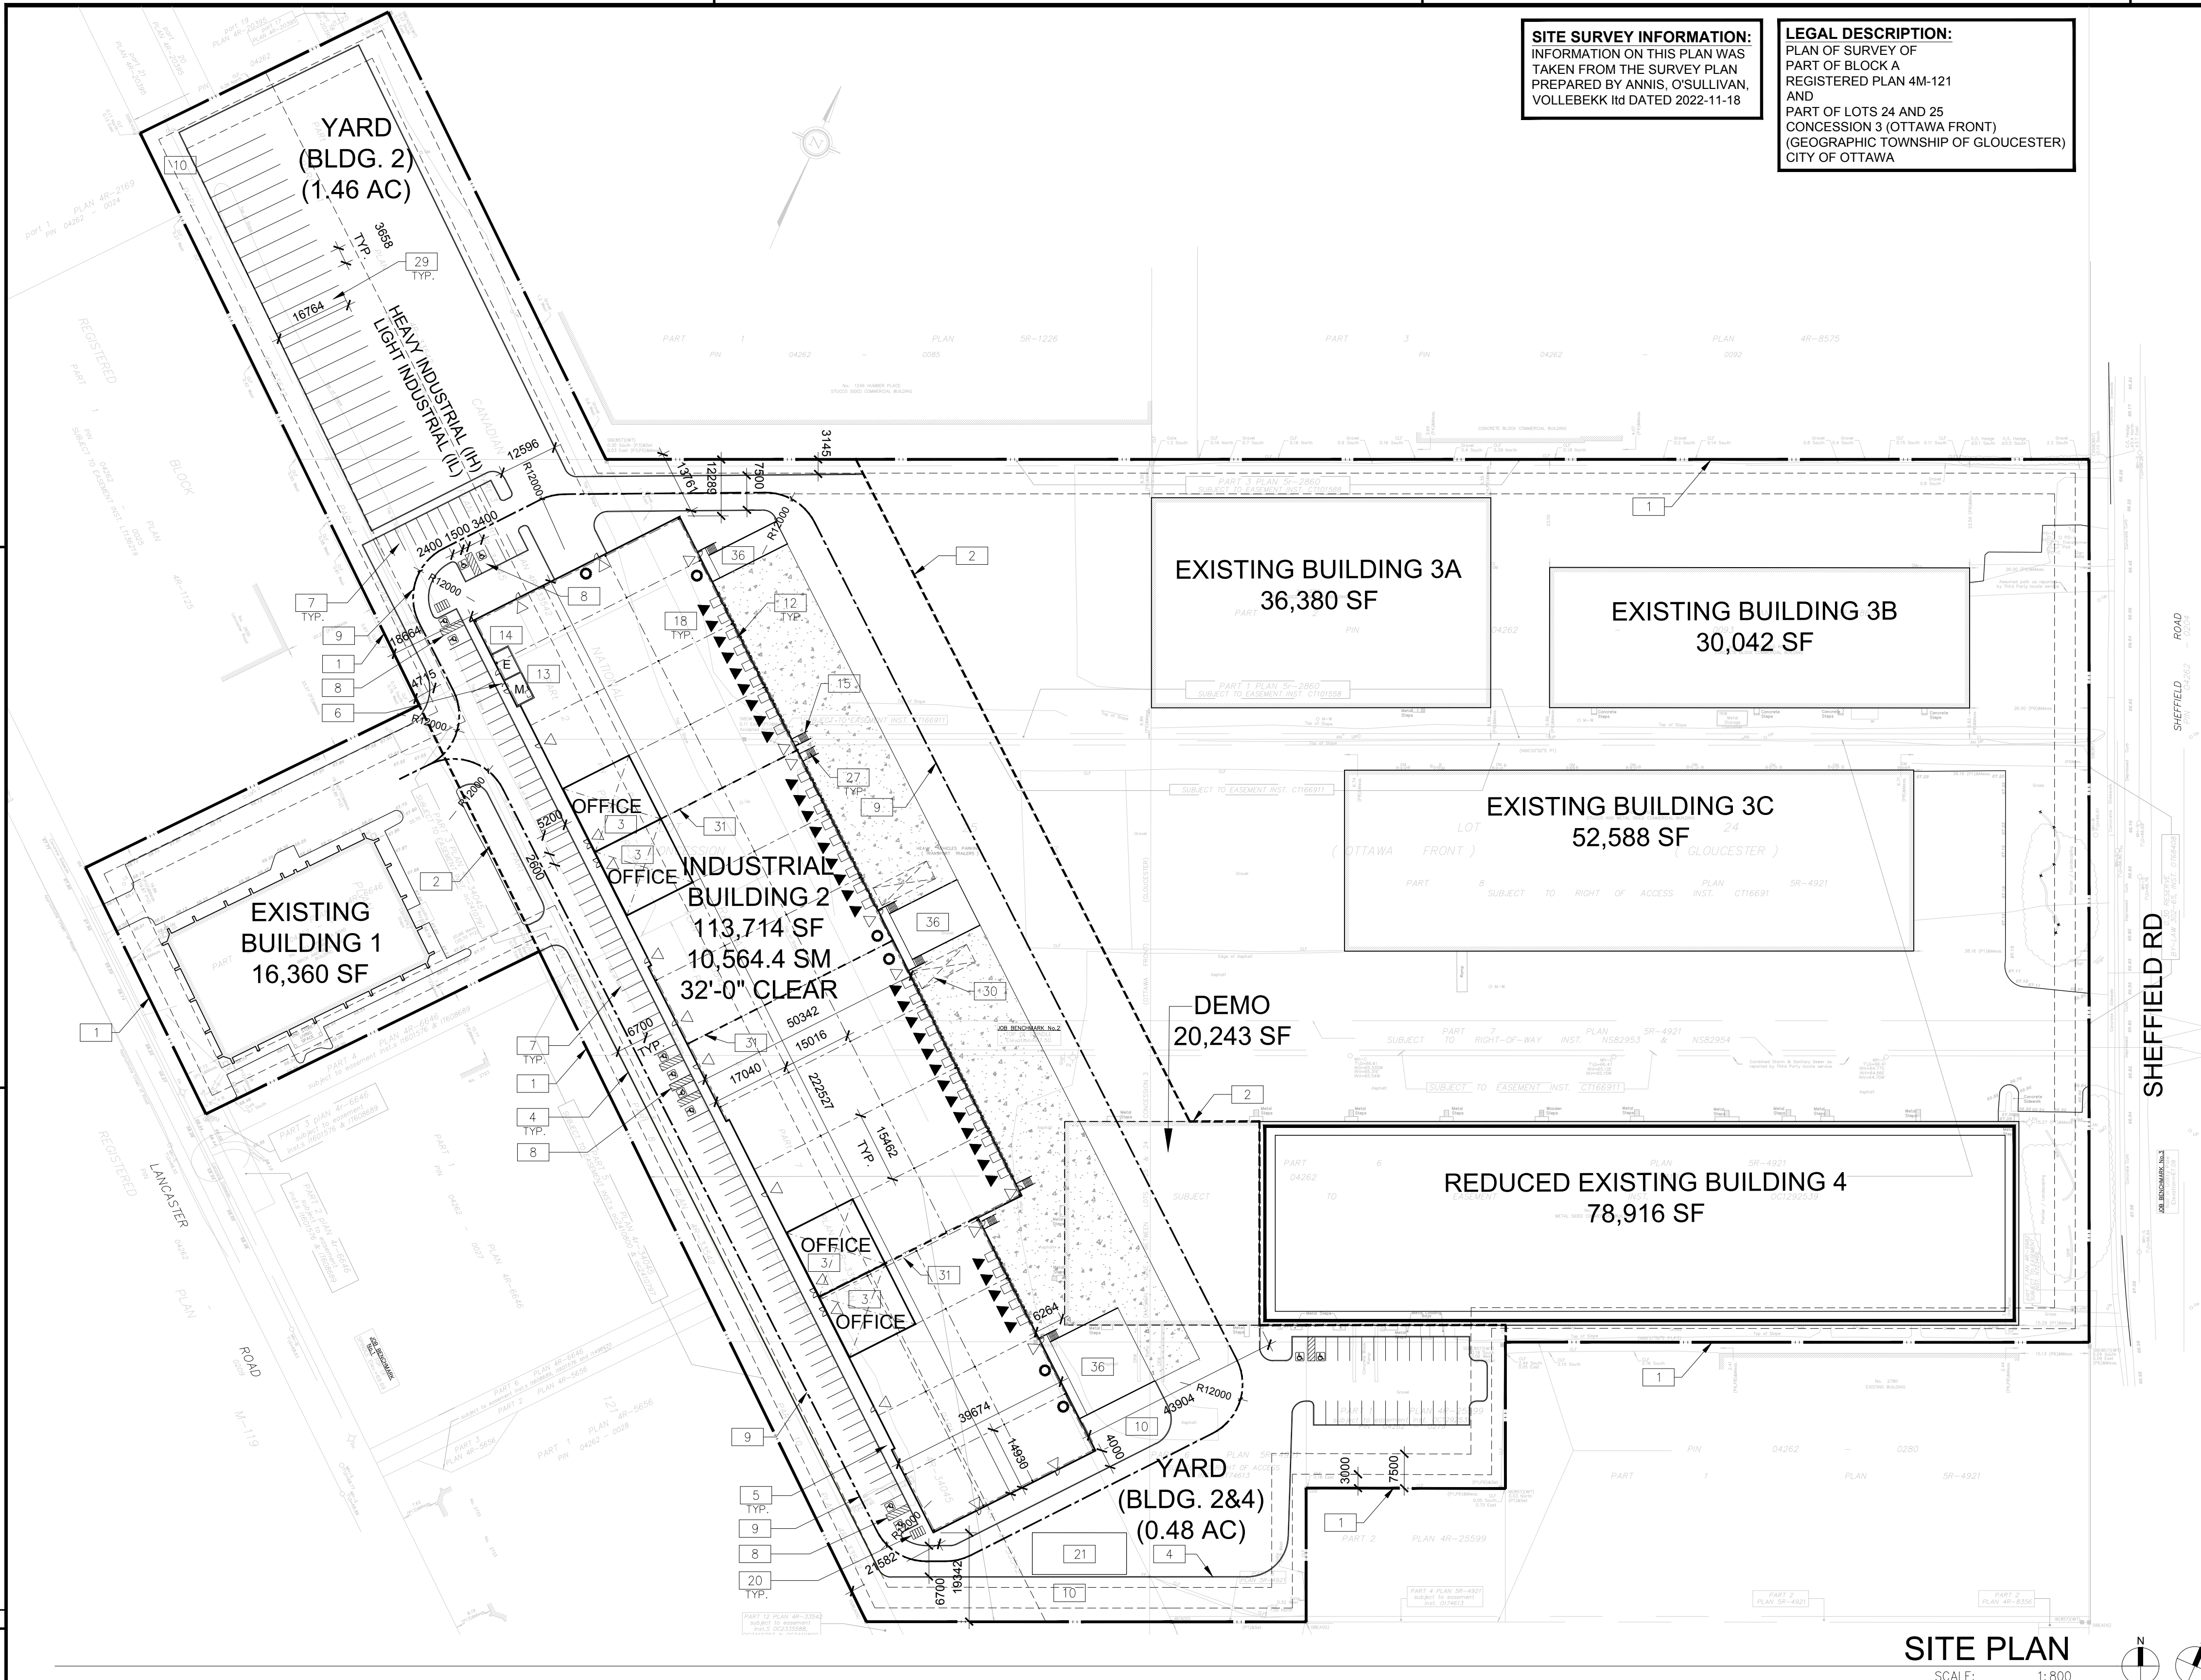

SITE PLAN
 SCALE: 1:800
 CONSTRUCTION NORTH TRUE NORTH

SITE PLAN NOTES

- 1 PROPERTY LINE
- 2 PROJECT LIMIT LINE
- 3 PRINCIPLE ENTRY - TENANT FIT-UP SUBJECT TO INTERIOR ALTERATION PERMIT
- 4 150mm WIDE CURB TYPICAL
- 5 SIDEWALK - SEE LANDSCAPE DWGS FOR CONSTRUCTION DETAILS
- 6 FIRE DEPARTMENT/SIAMESE CONNECTION
- 7 2600x5200mm PARKING STALL, PAINTED PARKING STRIPING PER CITY OF OTTAWA ZONING BY-LAW NO. 2008-250
- 8 TYPICAL ACCESSIBLE PARKING STALLS, PAINTED PARKING STRIPING PER BY-LAW OTTAWA ZONING BY-LAW NO. 2008-250. EACH PAIR OF SHARED STALLS TO HAVE TYPE A: 3.4m X 5.2m AND TYPE B: 2.4m X 5.2m WITH 1.5m WIDE PAINTED BARRIER FREE AISLE AND SIGNAGE REFER TO ONTARIO INTEGRATED ACCESSIBILITY STANDARDS.
- 9 FIRE ACCESS ROUTE W/ 12.0M TURNING RADIUS (---)
- 10 LANDSCAPE AREA - SEE LANDSCAPE DRAWINGS
- 11 GUARDRAIL SET INTO RETAINING WALL. REFER TO CIVIL DRAWINGS FOR EXTENT AND DETAILS.
- 12 12.0mX3.5m TRUCK LOADING SPACE (TYP.)
- 13 PROPOSED LOCATION OF MECHANICAL RM
- 14 PROPOSED LOCATION OF ELECTRICAL RM
- 15 GALVANIZED STEEL GUARDRAIL WITH HANDRAIL
- 16 EMPLOYMENT AMENITY SPACE - REFER TO LANDSCAPE DRAWINGS
- 17 SHADED AREA DENOTES HEAVY DUTY ASPHALT. TYPICAL FOR ALL AREAS REQUIRING FIRE OR TRACTOR TRUCK ACCESS.
- 18 TRUCK LOADING DOCK (TYP.)
- 19 STEEL BOLLARD
- 20 GALV. BICYCLE RACKS - SEE LANDSCAPE DRAWINGS
- 21 SNOW STORAGE AREA
- 22 EXISTING FIRE HYDRANT
- 23 PROPOSED LIGHT POLE. REFER TO ELECTRICAL DRAWINGS
- 24 FIRE ROUTE SIGNAGE PER CITY OF OTTAWA STANDARDS. REFER TO FIRE ROUTE BY-LAW NO. 2003-499 FOR SIGN REQUIREMENTS. SIGNS TO BE SPACED NO MORE THAN 25m APART
- 25 TACTILE WALKING SURFACE INDICATOR STRIP
- 26 IN GROUND EARTH-BIN GARBAGE RECEPTACLES WITH VEGETATION SCRIB
- 27 EXTERIOR GALV. STEEL STAIRS W/ TUBE STEEL GUARDRAIL, ON CONC. PAD, TYP.
- 28 EV PARKING STALLS (X PROPOSED; X FUTURE)
- 29 TRUCK TRAILER PARKING
- 30 13mX4.3m OVERSIZED TRUCK LOADING SPACE
- 31 FUTURE TENANT DEMISING WALL. SUBJECT TO TENANT FIT UP
- 32 CONCRETE APRON
- 33 PAINTED LINES PEDESTRIAN CROSSING
- 34 PYLON SIGNAGE
- 35 DIMENSION FROM FIRE DEPARTMENT CONNECTION TO HYDRANT.
- 36 DRIVE-IN RAMP BOUNDED BY RETAINING WALLS WITH GUARDRAILS WHERE GRADE CHANGE IS MORE THAN 600mm - REFER TO CIVIL DWGS

SITE LEGEND

- NEW HEAVY DUTY PAVEMENT (HATCHED)
- NEW LANDSCAPED AREA (HATCHED)
- NEW RIVER STONE AREA (HATCHED)
- PAINTED DIAGONAL LINES WHERE INDICATED
- FUTURE EV PARKING STALLS
- PROPERTY LINE
- SITE BOUNDARY LINE
- GAS METER LOCATION.
- FIRE DEPT CONNECTION (VERIFY LOCATION WITH CIVIL DRAWINGS)
- PROPOSED FIRE HYDRANT (VERIFY LOCATION WITH CIVIL DRAWINGS)
- PROPOSED FIRE HYDRANT
- LIGHT POLE
- WALL MOUNTED LIGHT
- MH DENOTES MANHOLE
- PROPOSED CATCHBASIN
- TACTILE INDICATORS AT DEPRESSED CURB
- BICYCLE RACK (1800 x 600 PER BIKE)
- MAN DOOR
- DOCK HIGH TRUCK DOOR
- GRADE LEVEL TRUCK DOOR
- FIRE ROUTE SIGNS
- PYLON SIGNAGE
- CONCRETE SIDEWALK
- ASPHALT PATHWAY
- STONE DUST PATHWAY

OTW21-0002-00

SITE STATISTICS

ZONING	IH/IL
GROSS SITE AREA	84,452 SM
PROJECT LIMIT AREA	37,191 SM

Zone Permitted Use (OTTAWA ZONING BY-LAW NO. 2008-250)

Proposed Use Warehouse

Regulations (Part 11: Industrial Zones)

	Proposed	Required IH (IL)
Min. Front Yard Building Setback (m)	18.66 m	7.5 m
Min. Interior Side Yard Building Set back (m)	12.29 m	7.5 m
Min.Rear Yard Building Setback (m)	N/A	7.5 m
Min.Landscape Front Yard Setback (m)	4.72 m	3 m
Min.Landscape Side Yard Setback (m)	3.15 m	3 m
Min.Landscape Rear Yard Setback (m)	N/A	3 m
Max. Floor Space Index	0.12	2
Max. Building Height	12 m	22 m (18m)

BUILDING FLOOR AREA

Building 2		
Warehouse Area	9,684.40m ²	
Office Area	880.00m ²	
TOTAL BUILDING GFA	10,564.40m²	


PARKING REQUIREMENT

	PROPOSED	REQUIRED
Warehouse GFA @ 0.8 Spaces per 100m ² , first 5000m ²	126	63
Warehouse GFA @ 0.4 Spaces per 100m ² , above 5000m ²		
Total No. of Parking Spaces	126	63
Barrier Free Parking Spaces	12	5

	PROPOSED	REQUIRED
Parking Stall Dimensions	2.6 m X 5.2 m	
Barrier Free Parking Stall Type A	3.4m X 5.2m	
Barrier Free Parking Stall Type B	2.4m X 5.2m	
Bicycle Parking Space Dimensions	1.8m X 0.6m	
No. Of Bicycle Parking (Warehouse: 1 per 2000m ² , Office 1 per 250m ²)	10	9
Loading Space Dimensions	3.5m X 9.0m	
Oversized Loading Space Dimensions	4.3m X 13.0m	
No. Of Loading Spaces	35	2
No. Of Oversized Loading Spaces	2	2
Trailer Parking	26	N/A


DOCK STATISTICS

DOCK-HIGH DOORS	35
OVER-HEAD DOORS	6

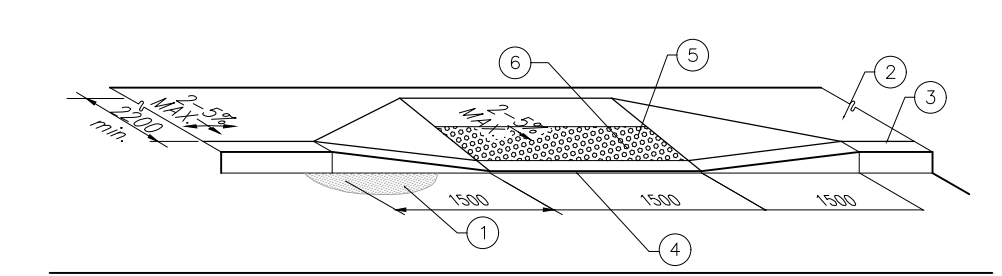

- 1 PAVEMENT
- 2 ACCESSIBLE ROUTE OF PEDESTRIAN TRAVEL 2200mm MIN. (UNLESS OTHERWISE NOTED ON PLANS)
- 3 TOP FACE OF CURB
- 4 DEPRESSED CURB
- 5 TRUNCATED DOMES WITH A HEIGHT OF 4.5-5.5mm, BASE DIAMETER OF 21-25mm. REGULAR SPACING PATTERN AT 55-50mm ON CENTRE
- 6 A MINIMUM 600mm WIDE SECTION DETECTABLE WARNING SURFACE SHALL BE PROVIDED WHEN FLAT TRAVEL SURFACE ADJACENT A VEHICULAR WAY (0mm CURB FACE)

ACCESSIBLE CURB RAMP
 SCALE: N.T.S

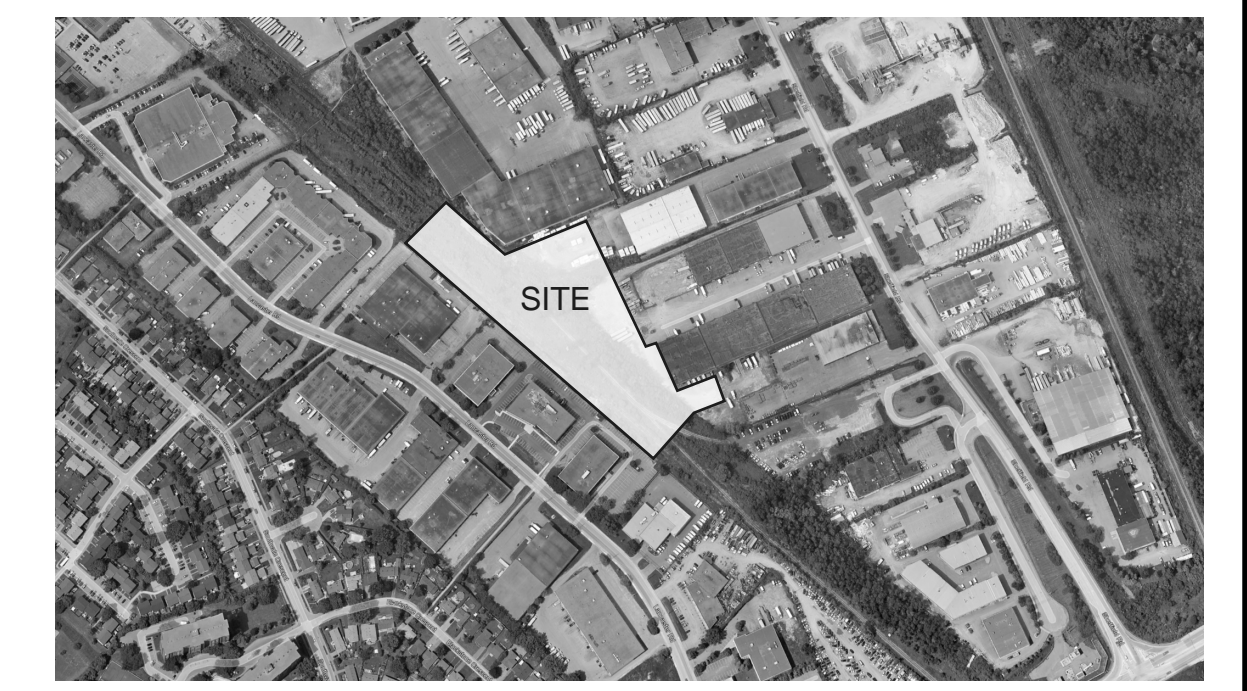

KEY PLAN
 SCALE: N.T.S

WARE MALCOMB

1420 Blair Towers Place, Suite #104
 Gloucester, Ontario, Canada K1J 9L8
 P 343.633.2977

ARCHITECTURE
 PLANNING
 INTERIORS

CIVIL ENGINEERING
 BRANDING
 BUILDING MEASUREMENT

ONTARIO ASSOCIATION
 OF
ARCHITECTS

JOHN P. HOLLAND
 LICENCE
 8649

RICHCRAFT


SHEFFIELD INDUSTRIAL BUILDING
 2760-2770 SHEFFIELD RD.
 OTTAWA
 ON K1B 3V9, CANADA.

SITE PLAN

DATE	ISSUED FOR SPA	REMARKS
2023-05-17		

PA/PM:	J. HOLLAND
DRAWN BY.:	
JOB NO.:	OTW21-0002-00

SHEET
A100

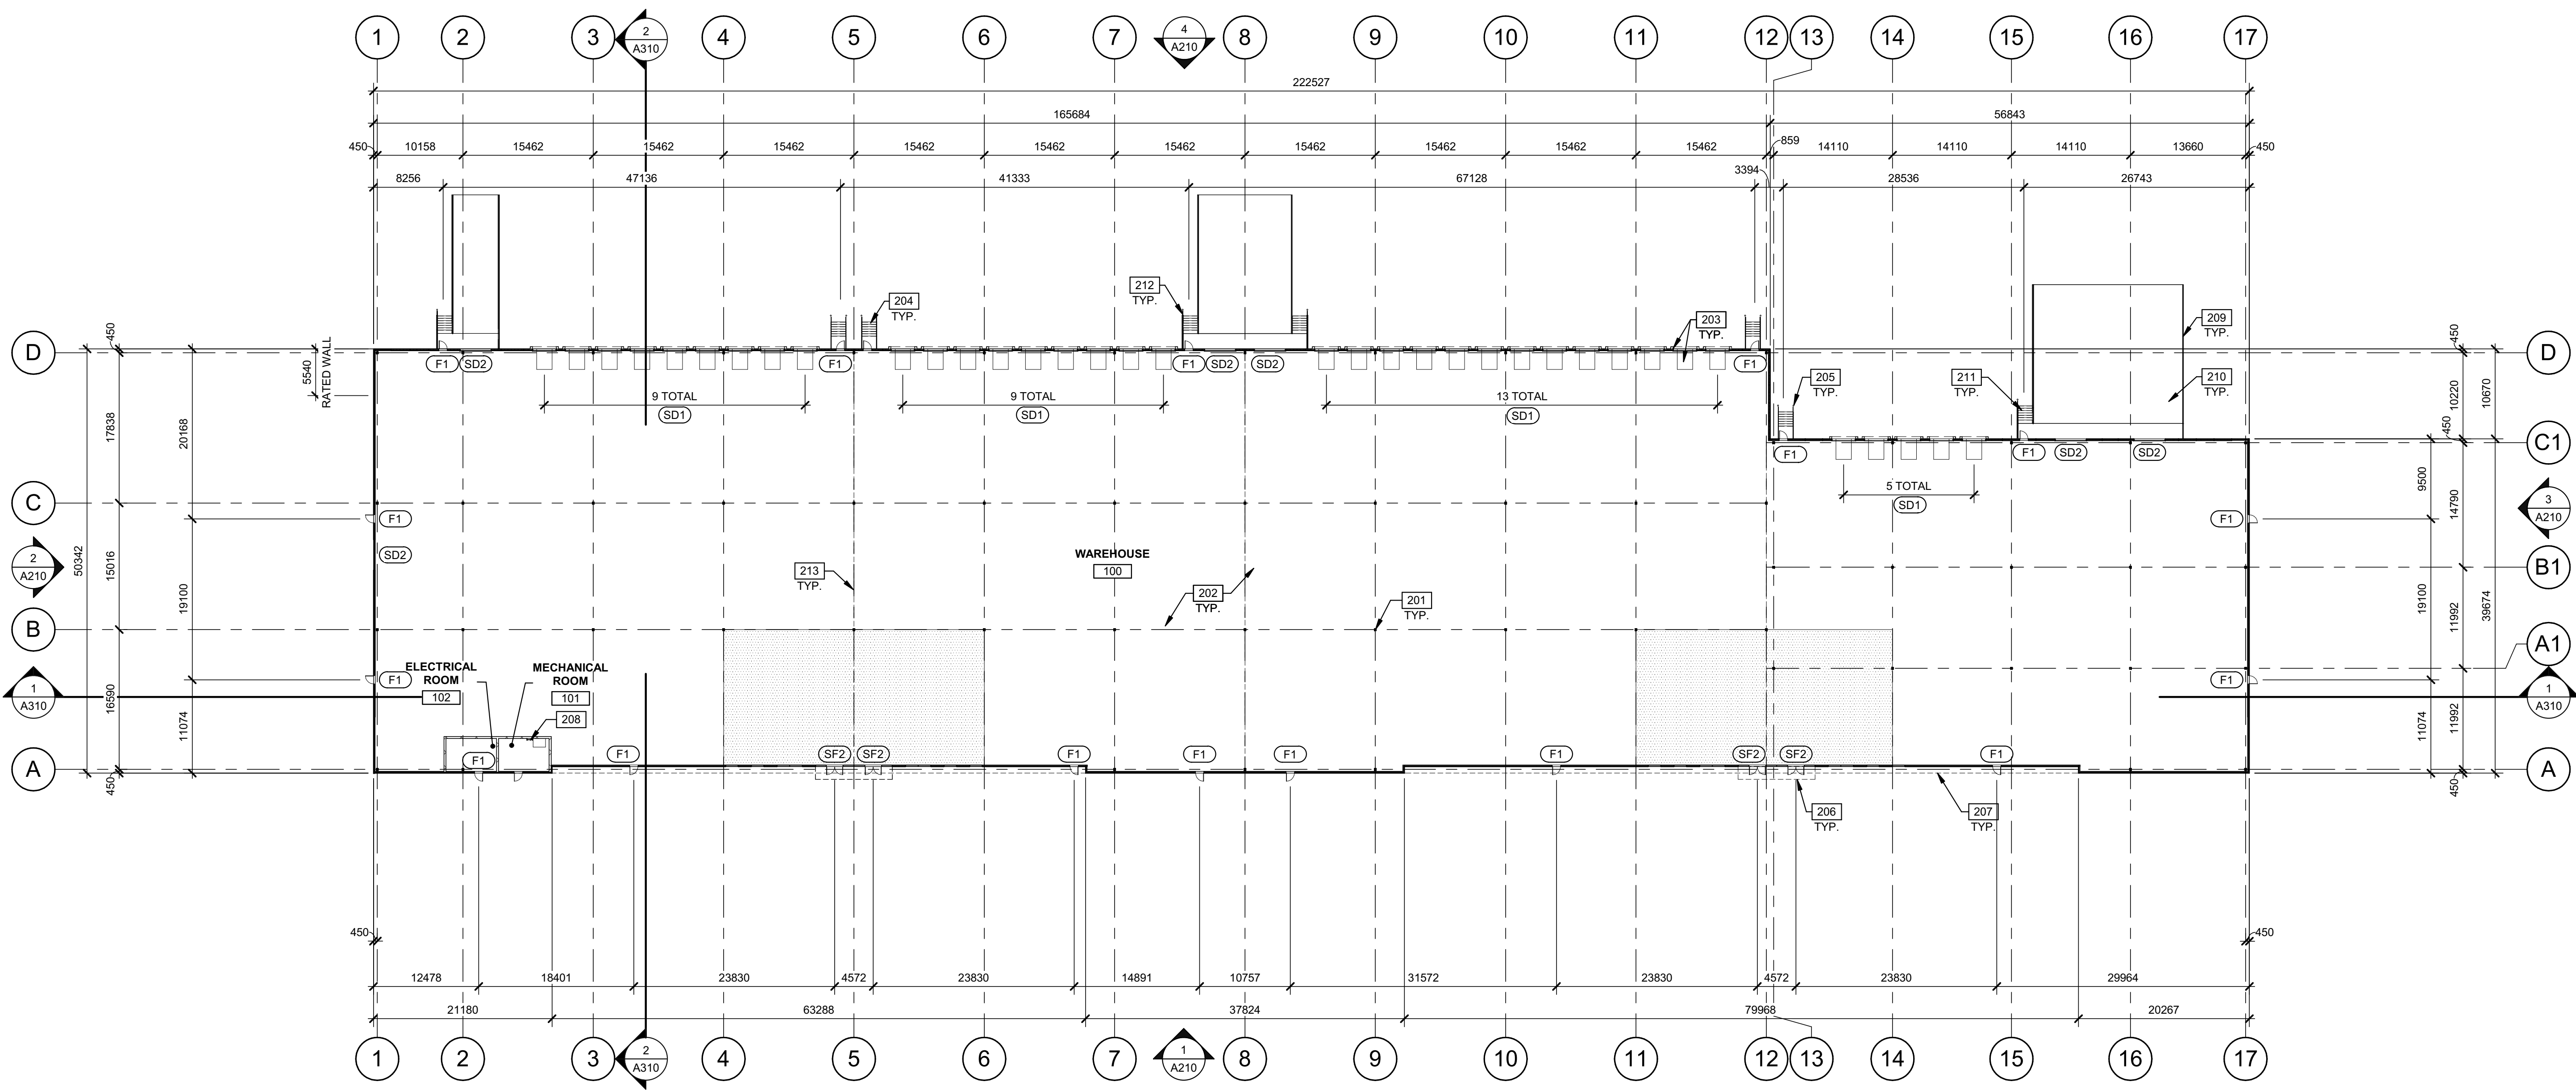




1:400

0 5m 10m 20m 40m

FLOOR PLAN

SCALE: 1 : 400

DOOR TYPES

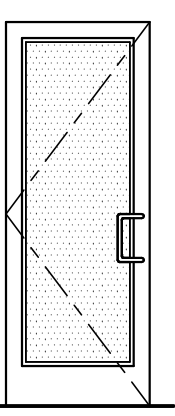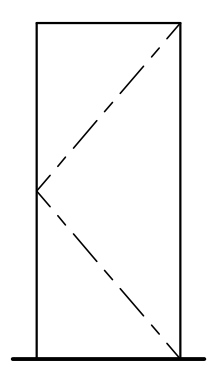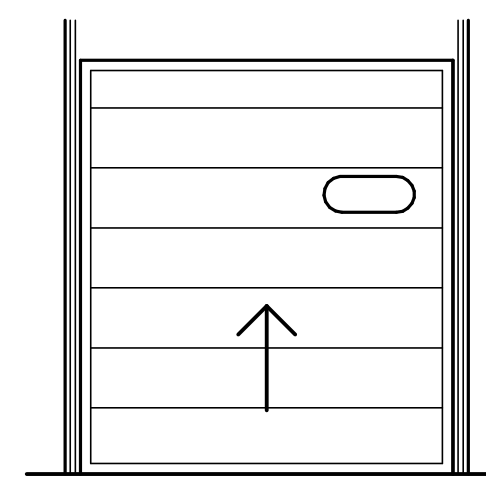

<p>(SF2) ALUMINUM STOREFRONT</p>  <p>(SF2) 1930mm x 2135mm (PAIR) CLEAR ANOD. ALUM. STOREFRONT DOOR W/TEMPERED GLAZING (NARROW STILE) FRAME: MANUFACTURER</p> <p>(F1) HOLLOW METAL</p> 	<p>(F1) 965mm x 2135mm PAINTED INSULATED HOLLOW METAL DOOR FRAME: PAINTED HOLLOW METAL</p> <p>(SD1) SECTIONAL O.H. DOOR</p>  <p>(SD2)</p>
--	---

HARDWARE:

2 SETS PIVOT SET	3 EA HINGES
2 SETS INTER PIVOT	1 EA EXIT DEVICE
1 EA EXIT DEVICE	1 EA CYLINDER
1 EA MORTISE CYLINDER	1 EA CLOSER
2 SETS OFFSET PULL	1 EA PERIMETER SEAL
2 EA OH CLOSER	1 EA BOTTOM DRIP
1 EA THRESHOLD	1 EA THRESHOLD
1 EA DECAL	1 EA LOCK GUARD
	1 EA HVY DUTY FLOOR STOP

NOTE: WEATHERSEAL BY DOOR MANUFACTURER

WALL LEGEND

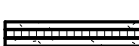-  ARCHITECTURAL PRECAST PANEL.
-  INSULATED METAL PANEL SYSTEM.

LEGEND

-  PROPOSED FUTURE OFFICE AREA

KEYNOTES

- 201 STRUCTURAL STEEL COLUMN.
- 202 CONCRETE SLAB.
- 203 DOCK LEVELER AND DOCK SHELTER.
- 204 EXTERIOR STEEL STAIR, ALL COMPONENTS GALVANIZED AND PAINTED.
- 205 STEEL BOLLARD, CONCRETE-FILLED PAINTED SAFETY YELLOW.
- 206 OUTLINE OF CANOPY ABOVE.
- 207 OUTLINE OF WALL ABOVE.
- 208 ROOF ACCESS LADDER.
- 209 CONCRETE RETAINING WALL.
- 210 CONCRETE RAMPS.
- 211 CONCRETE STAIR.
- 212 1070MM TOTAL HEIGHT PAINTED METAL GUARDRAIL.
- 213 FUTURE TENANT LINE.

WARE MALCOMB

ARCHITECTURE CIVIL ENGINEERING PLANNING BRANDING INTERIORS BUILDING MEASUREMENT

1420 Blair Towers Place, Suite #104 Gloucester, Ontario, Canada K1J 9L8 P 343.633.2977

ONTARIO ASSOCIATION OF ARCHITECTS

JOHN P. HOLLAND LICENCE 8649

RICHCRAFT



SHEFFIELD INDUSTRIAL BUILDING
2760-2770 SHEFFIELD RD.
OTTAWA
ON K1B 3V9, CANADA.

FLOOR PLAN		REMARKS
DATE	ISSUED FOR SPA	
2023-05-17		

PA/PM:	J. HOLLAND
DRAWN BY.:	D.P. / E.C.
JOB NO.:	OTW21-0002-00

SHEET
A120

THESE DRAWINGS AND SPECIFICATIONS ARE THE PROPERTY AND COPYRIGHT OF WARE MALCOMB AND SHALL NOT BE USED ON ANY OTHER WORK EXCEPT BY AGREEMENT WITH WARE MALCOMB. WRITTEN DIMENSIONS SHALL TAKE PRECEDENCE OVER SCALED DIMENSIONS AND SHALL BE KEPT ON THE JOB SITE. ANY DISCREPANCY SHALL BE BROUGHT TO THE NOTICE OF WARE MALCOMB PRIOR TO THE COMMENCEMENT OF ANY WORK.

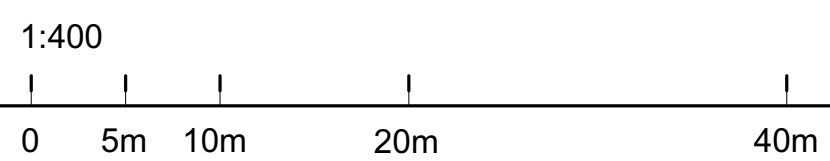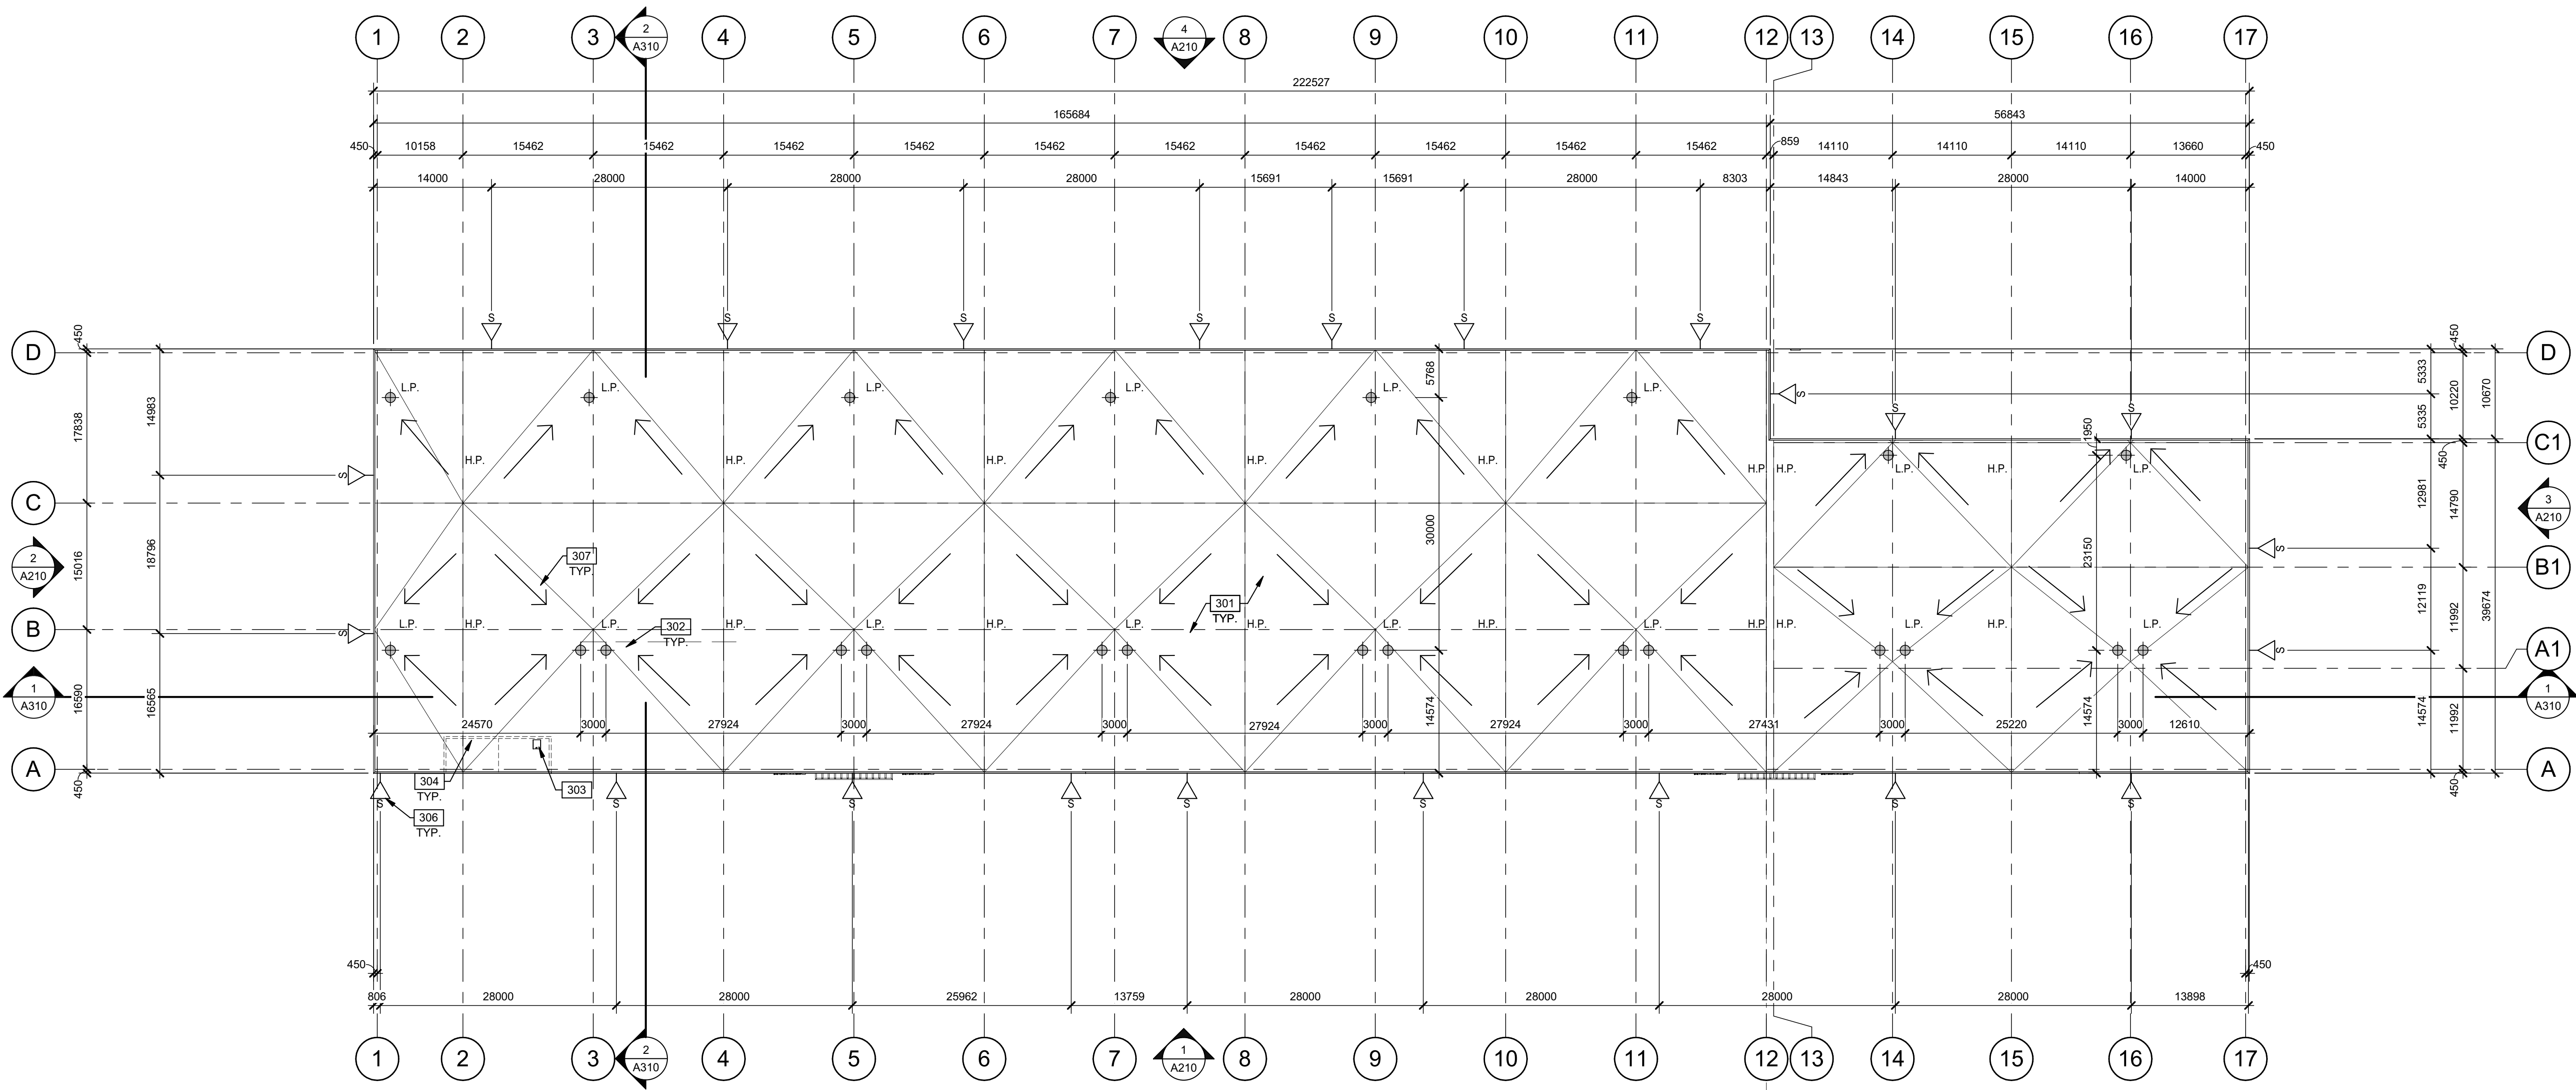

ROOF PLAN
SCALE: 1:400

LEGEND

- FLOW LINE TO DRAIN.
- ROOF DRAIN - SEE MECHANICAL DRAWINGS.
- ROOF SCUPPER LOCATION - SEE ELEVATIONS.
- ROOF EXPANSION JOINT.
- OUTLINE OF WALL BELOW.

KEYNOTES

- 301 2-PLY MEMBRANE ON 6" POLYISO INSULATION.
- 302 ROOF DRAINS.
- 303 ROOF HATCH.
- 304 LINE OF WALL BELOW.
- 306 OVERFLOW SCUPPER.
- 307 FLOW LINE TO DRAIN.

WARE MALCOMB
ARCHITECTURE CIVIL ENGINEERING
PLANNING BRANDING
INTERIORS BUILDING MEASUREMENT

1420 Blair Towers Place, Suite #104
Gloicester, Ontario, Canada K1J 9L8
P 343.633.2977

ONTARIO ASSOCIATION
OF
ARCHITECTS
JOHN P. HOLLAND
LICENCE
8649

RICHCRAFT


SHEFFIELD INDUSTRIAL BUILDING
2760-2770 SHEFFIELD RD.
OTTAWA
ON K1B 3V9, CANADA.

ROOF PLAN		REMARKS
DATE	ISSUED FOR	
1	2023-05-17	ISSUED FOR SPA

PA/PM:	J. HOLLAND
DRAWN BY.:	D.P. / E.C.
JOB NO.:	OTW21-0002-00

SHEET
A190

THESE DRAWINGS AND SPECIFICATIONS ARE THE PROPERTY AND COPYRIGHT OF WARE MALCOMB AND SHALL NOT BE USED ON ANY OTHER WORK EXCEPT BY AGREEMENT WITH WARE MALCOMB. WRITTEN DIMENSIONS SHALL TAKE PRECEDENCE OVER SCALED DIMENSIONS AND SHALL BE KEPT ON THE JOB SITE. ANY DISCREPANCY SHALL BE BROUGHT TO THE NOTICE OF WARE MALCOMB PRIOR TO THE COMMENCEMENT OF ANY WORK.

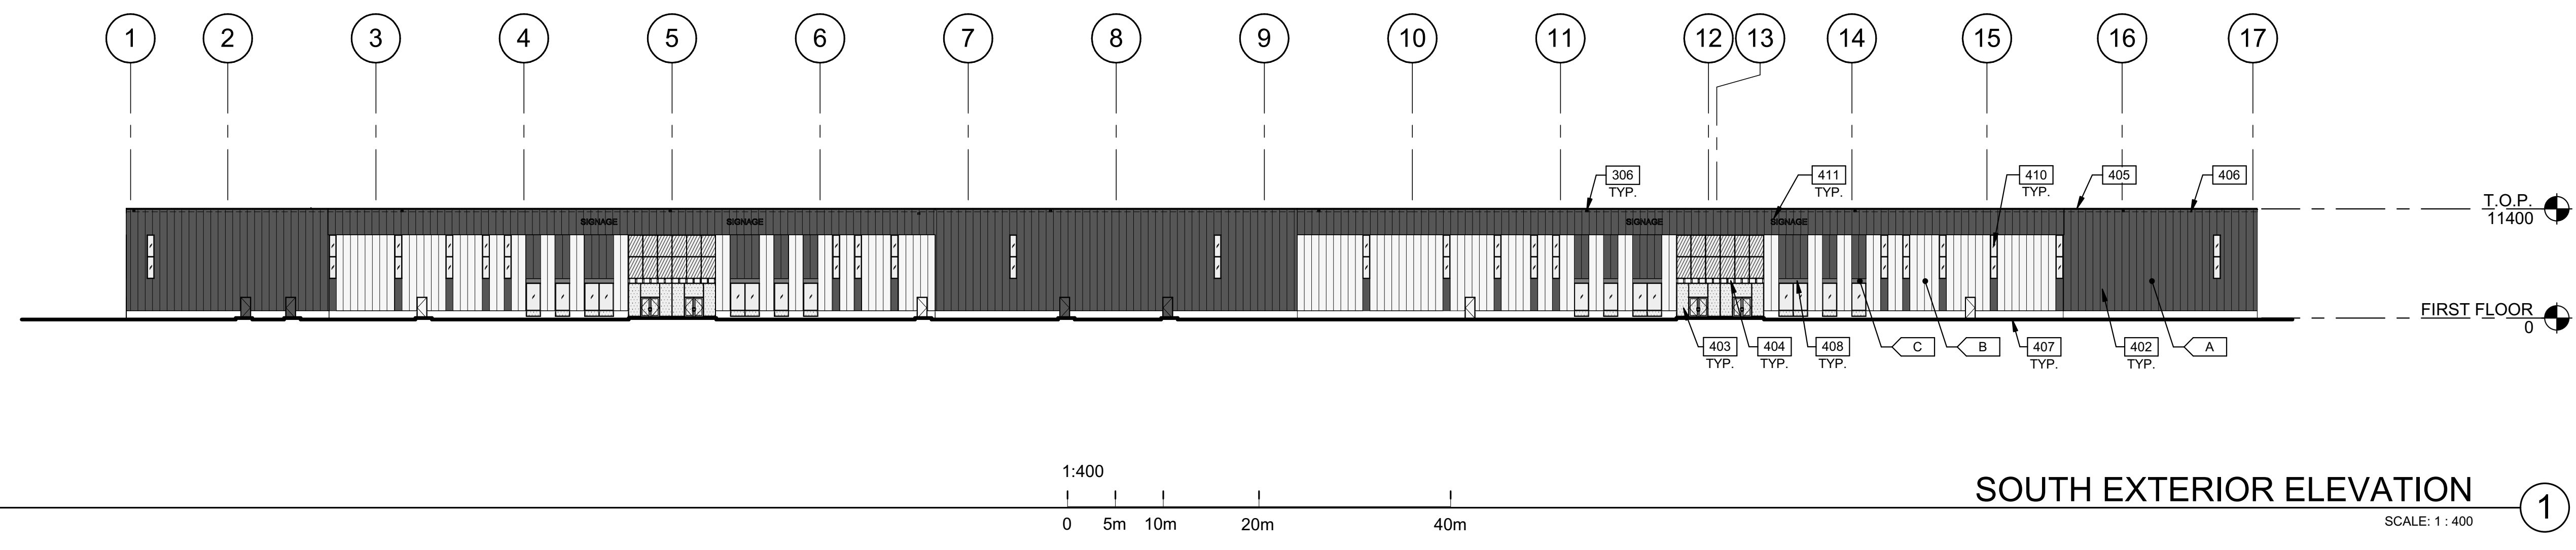


SOUTH EXTERIOR ELEVATION

1

1:400
0 5m 10m 20m 40m


SCALE: 1 : 400

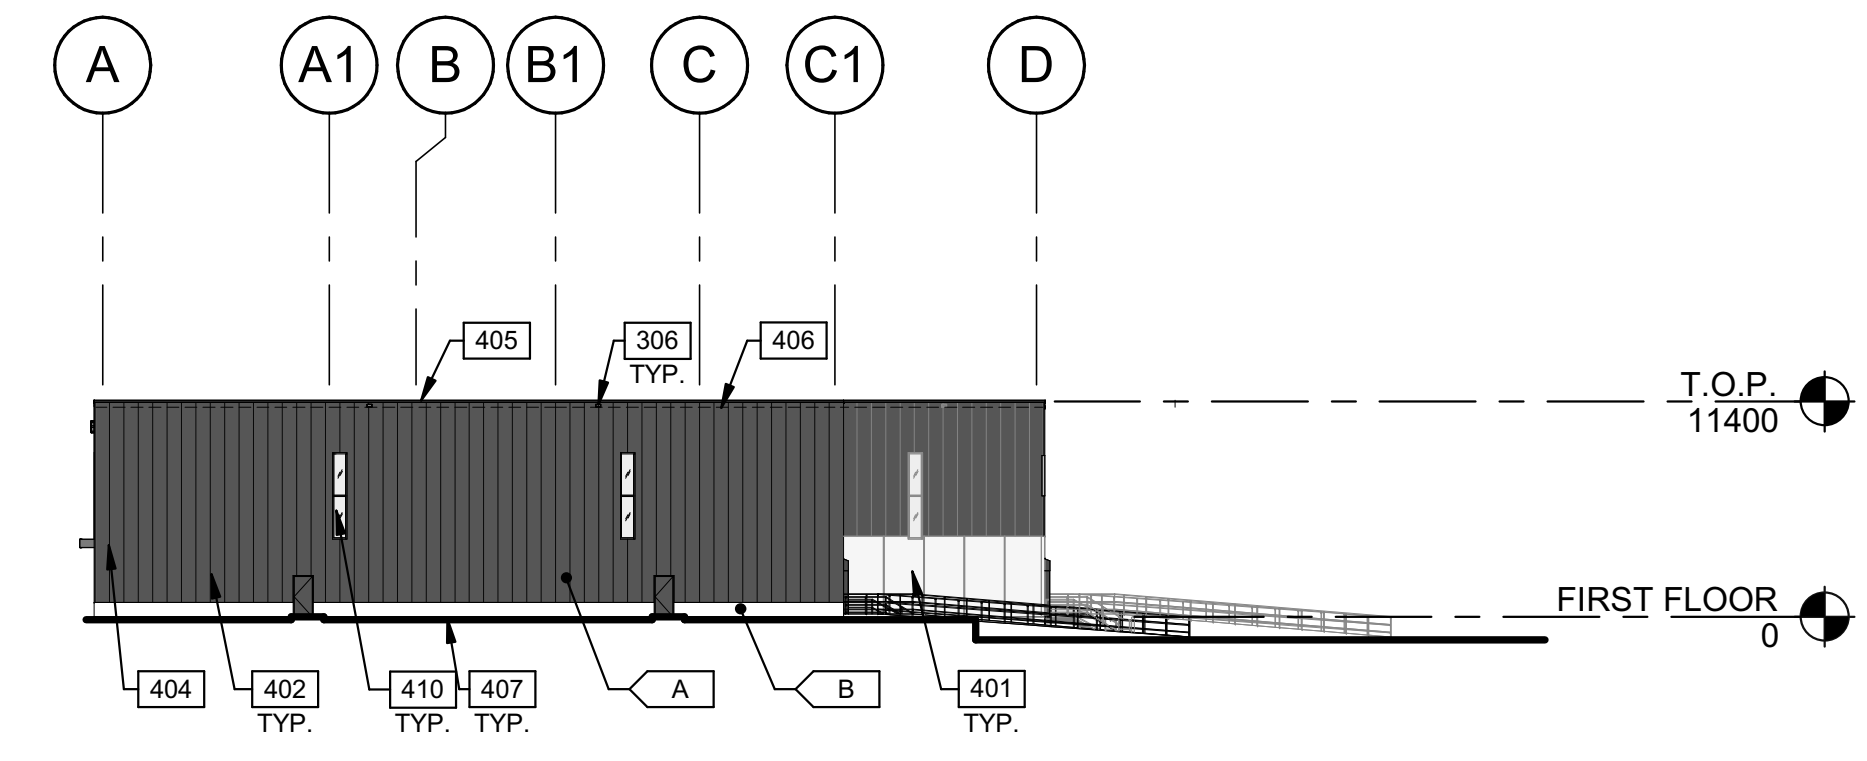

EAST EXTERIOR ELEVATION

3


SCALE: 1 : 400

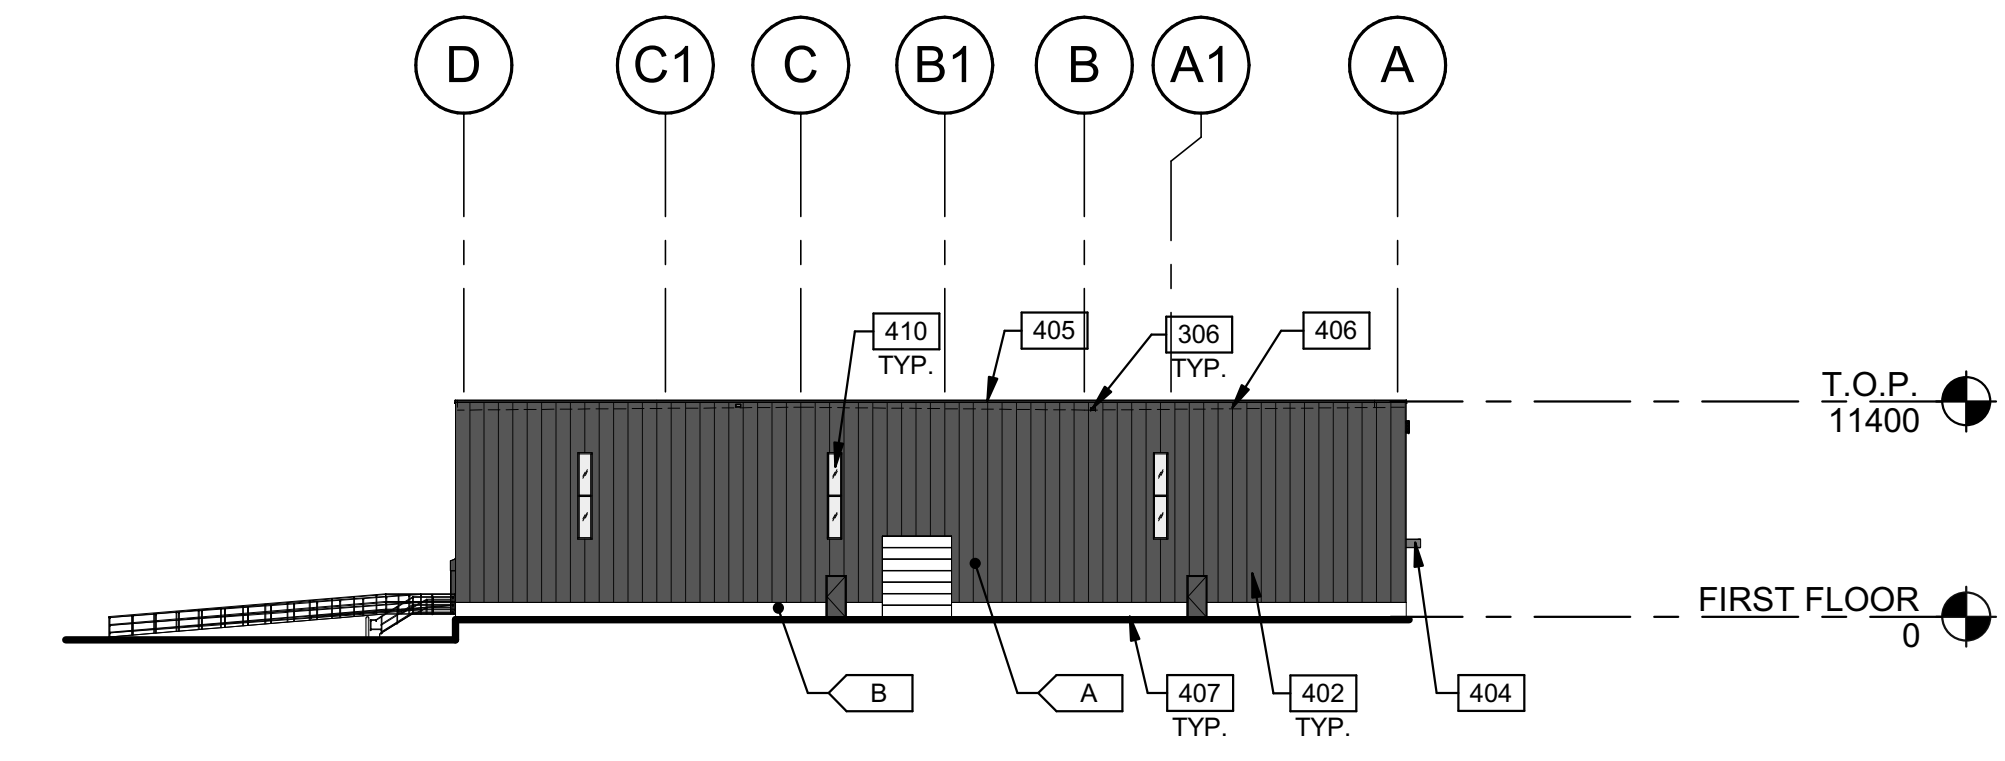

WEST EXTERIOR ELEVATION

2

SCALE: 1 : 400

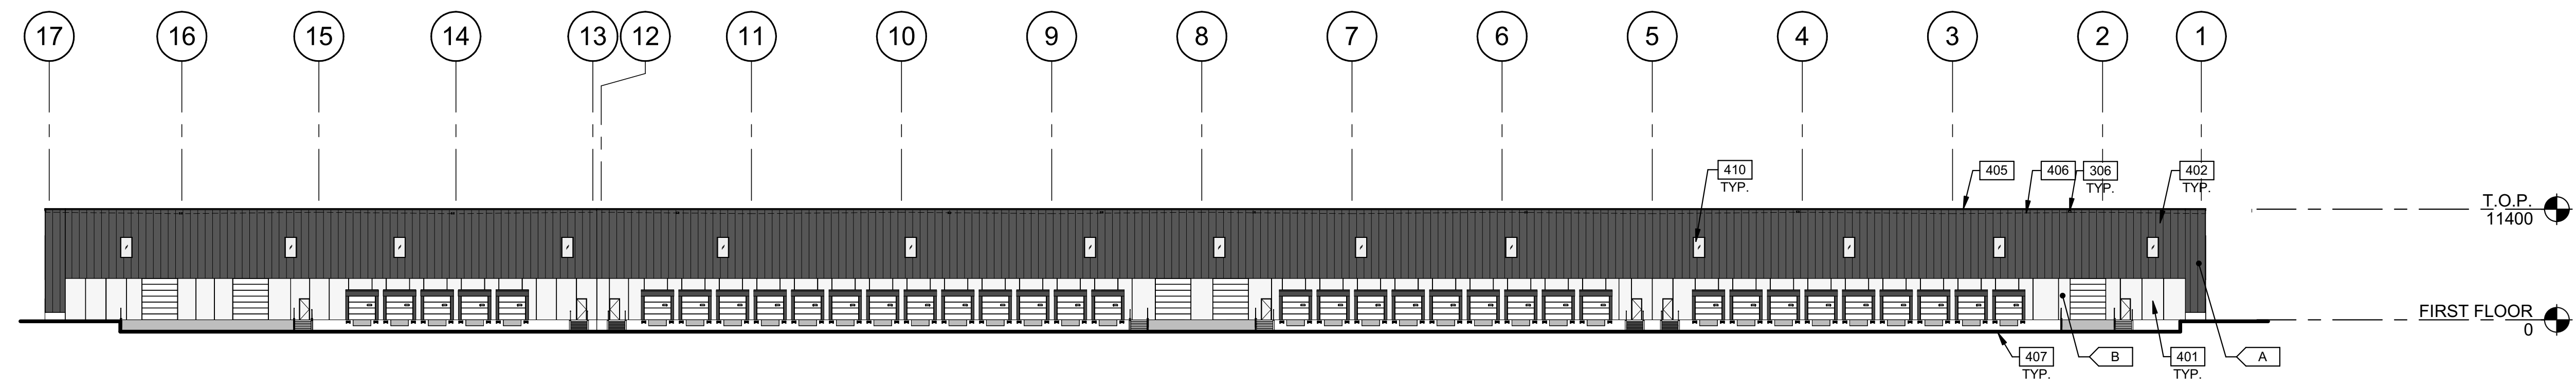

NORTH EXTERIOR ELEVATION

4

SCALE: 1 : 400

LEGENDS

- GLASS:**
- VISION GLASS
 - SPANDREL GLASS
 - TEMPERED GLASS

- COLOURS:**
- PROVIDE 1,828.8mm WIDE PAINT COLOUR MOCK-UP FULL HEIGHT OF BUILDING FOR OWNER/ARCHITECT REVIEW.
- A** BASE COLOUR: BLACK
 - B** SECONDARY COLOUR: WHITE
 - C** ACCENT COLOUR: BRONZE

KEYNOTES

- 306 OVERFLOW SCUPPER.
- 401 PRECAST INSULATED CONCRETE WALL PANEL SYSTEM.
- 402 INSULATED METAL PANEL.
- 403 CURTAIN WALL GLAZING SYSTEM.
- 404 CANOPY WITH HSS PROFILE.
- 405 CONTINUOUS METAL CAP FLASHING, PAINTED TO MATCH ADJACENT WALL.
- 406 ROOF LINE BEYOND.
- 407 GRADE LINE VARIES.
- 408 ALUMINUM COMPOSITE METAL PANEL.
- 410 CLERESTORY WINDOW.
- 411 TENANT SIGNAGE.

WARE MALCOMB

ARCHITECTURE
PLANNING
INTERIORS

CIVIL ENGINEERING
BRANDING
BUILDING MEASUREMENT

1420 Blair Towers Place, Suite #104
Gloucester, Ontario, Canada K1J 9L8
P 343.633.2977

ONTARIO ASSOCIATION
OF
ARCHITECTS

JOHN P. HOLLAND
LICENCE
8649

RICH CRAFT


SHEFFIELD INDUSTRIAL BUILDING
2760-2770 SHEFFIELD RD.
OTTAWA
ON K1B 3V9, CANADA.

EXTERIOR ELEVATIONS		REMARKS
DATE	ISSUED FOR SPA	
1	2023-05-17	


PA/PM:	J. HOLLAND
DRAWN BY.:	D.P. / E.C.
JOB NO.:	OTW21-0002-00

SHEET
A210

THESE DRAWINGS AND SPECIFICATIONS ARE THE PROPERTY AND COPYRIGHT OF WARE MALCOMB AND SHALL NOT BE USED ON ANY OTHER WORK EXCEPT BY AGREEMENT WITH WARE MALCOMB. WRITTEN DIMENSIONS SHALL TAKE PRECEDENCE OVER SCALED DIMENSIONS AND SHALL BE KEPT ON THE JOB SITE. ANY DISCREPANCY SHALL BE BROUGHT TO THE NOTICE OF WARE MALCOMB PRIOR TO THE COMMENCEMENT OF ANY WORK.

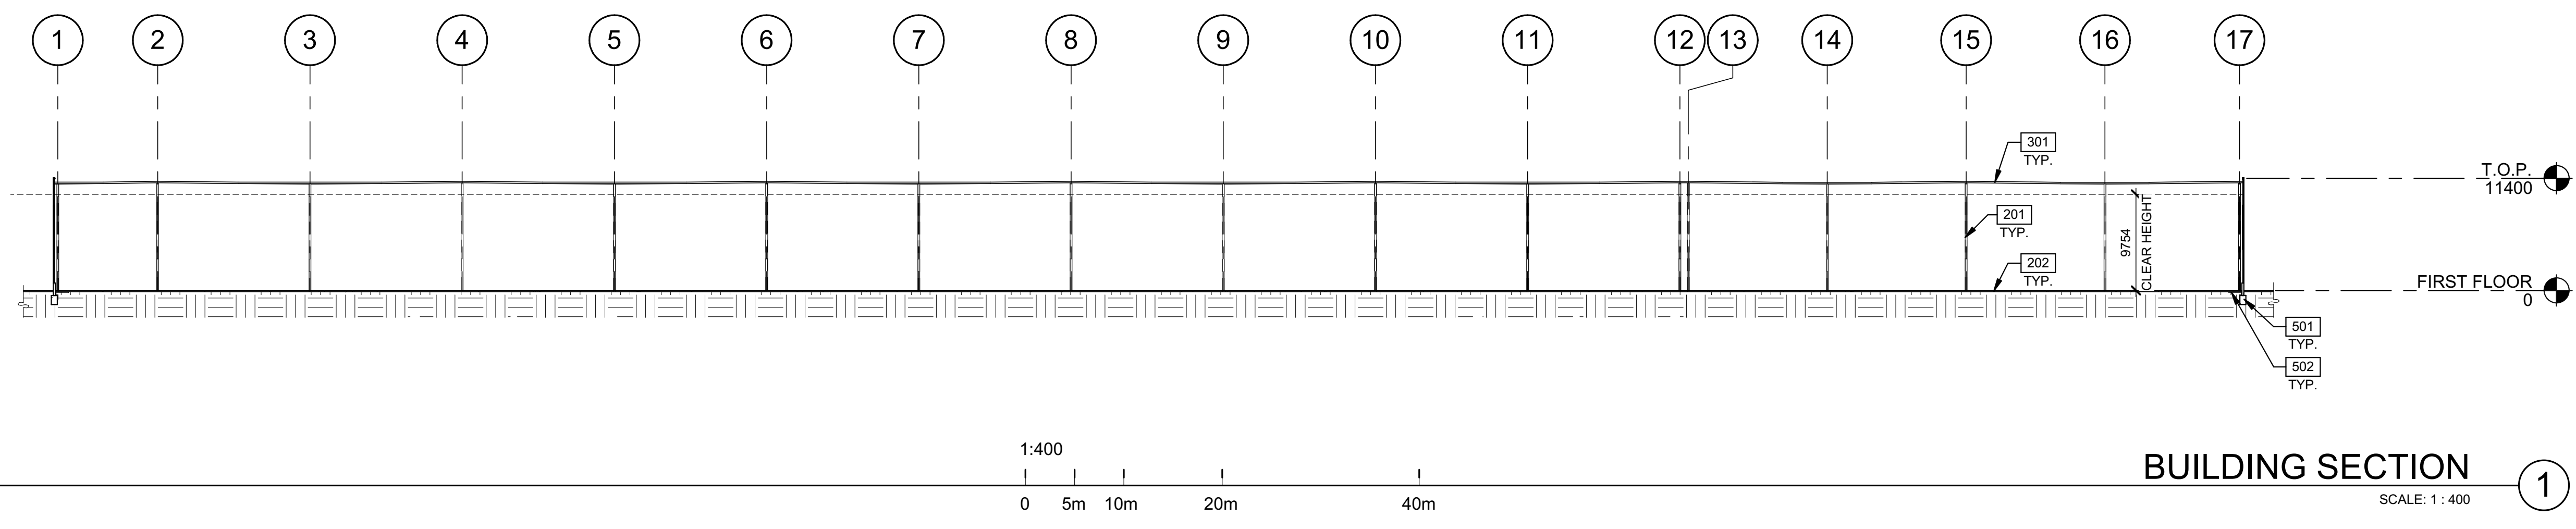

BUILDING SECTION 1
SCALE: 1 : 400

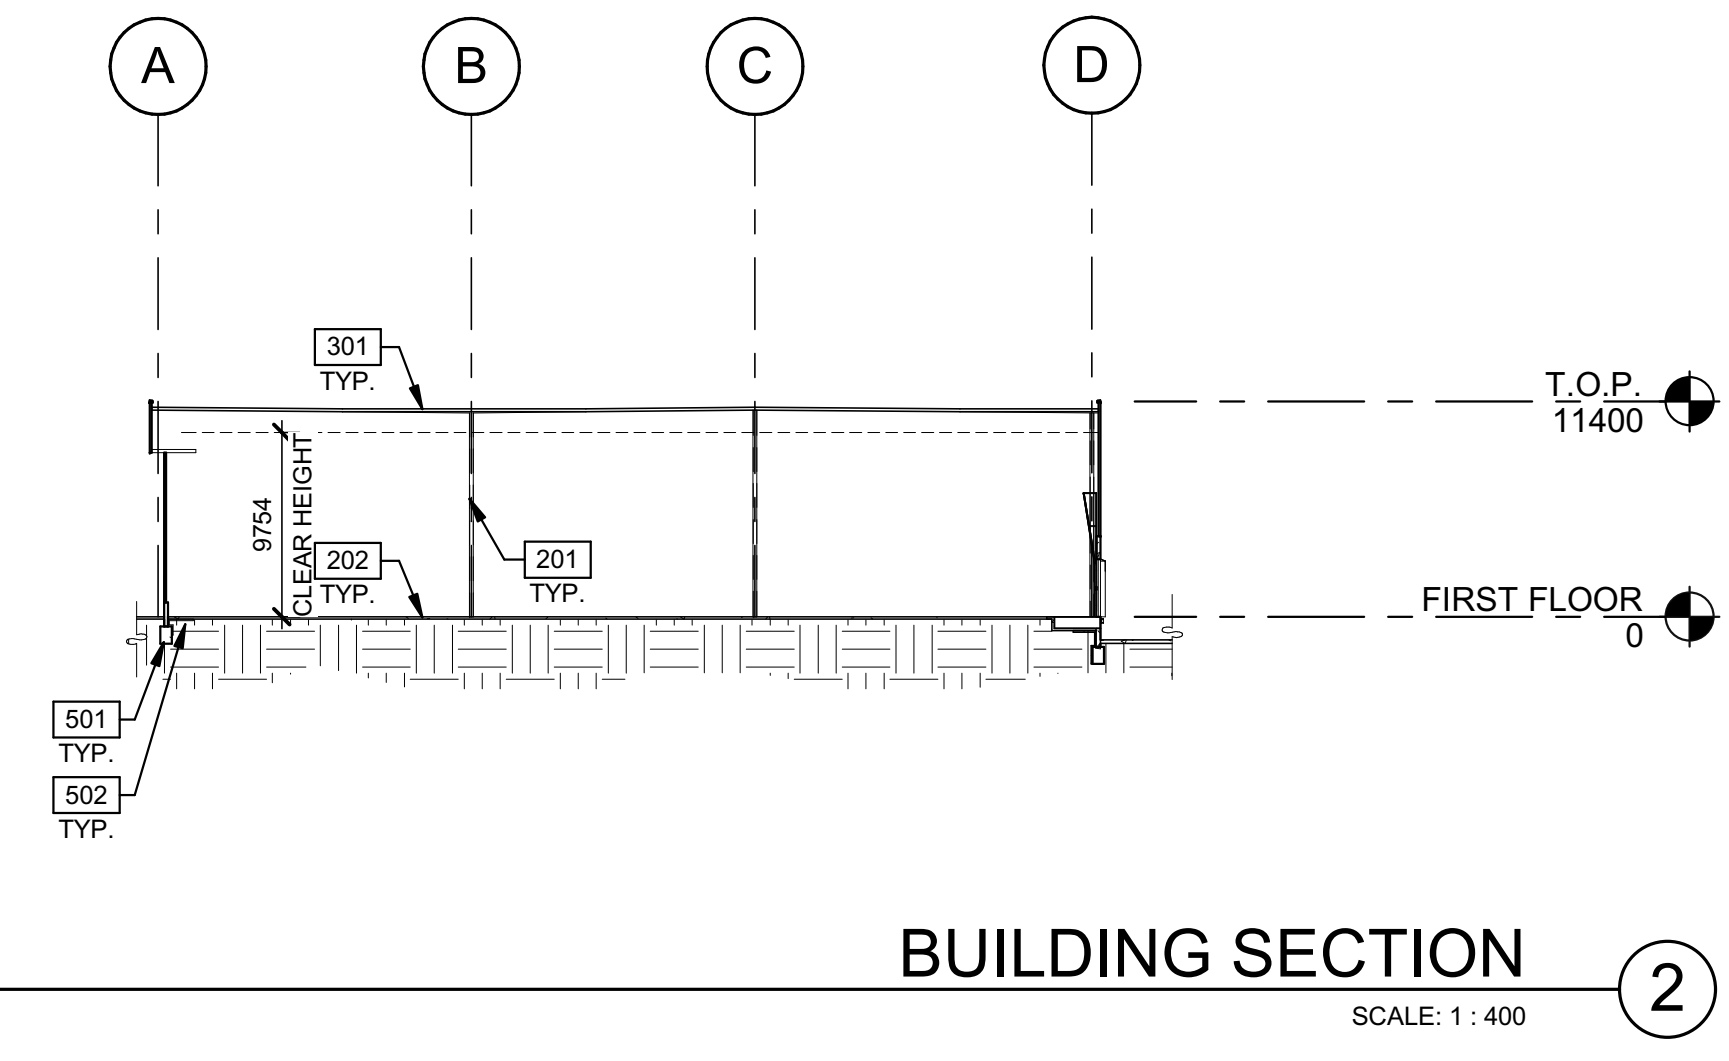

BUILDING SECTION 2
SCALE: 1 : 400

KEYNOTES

- 201 STRUCTURAL STEEL COLUMN.
- 202 CONCRETE SLAB.
- 301 2-PLY MEMBRANE ON 6" POLYISO INSULATION.
- 501 CONCRETE FOOTING.
- 502 PROVIDE RIGID INSULATION AT FOOTINGS AND WALL PANELS BELOW SLAB.

WARE MALCOMB
 ARCHITECTURE
 CIVIL ENGINEERING
 PLANNING
 INTERIORS
 BRANDING
 BUILDING MEASUREMENT

1420 Blair Towers Place, Suite #104
 Gloucester, Ontario, Canada K1J 9L8
 P 343.633.2977

ONTARIO ASSOCIATION
 OF
 ARCHITECTS
 JOHN P. HOLLAND
 LICENCE
 8849

RICHCRAFT

SHEFFIELD INDUSTRIAL BUILDING
 2760-2770 SHEFFIELD RD.
 OTTAWA
 ON K1B 3V9, CANADA.

BUILDING SECTIONS		REMARKS
DATE	ISSUED FOR SPA	
1	2023-05-17	

PA/PM:	J. HOLLAND
DRAWN BY.:	D.P. / E.C.
JOB NO.:	OTW21-0002-00

SHEET
A310

THESE DRAWINGS AND SPECIFICATIONS ARE THE PROPERTY AND COPYRIGHT OF WARE MALCOMB AND SHALL NOT BE USED ON ANY OTHER WORK EXCEPT BY AGREEMENT WITH WARE MALCOMB. WRITTEN DIMENSIONS SHALL TAKE PRECEDENCE OVER SCALED DIMENSIONS AND SHALL BE KEPT ON THE JOB SITE. ANY DISCREPANCY SHALL BE BROUGHT TO THE NOTICE OF WARE MALCOMB PRIOR TO THE COMMENCEMENT OF ANY WORK.