



Plant	t List				
ID	Qty	Botanical Name	Common Name	Scheduled Size	Remarks
		TREES			
Вр	2	Betula papyrifera	Paper Birch, Canoe Birch	Clump 250 cm. 15gal	
CaW	1	Caragana arborescens 'Walker'	Walker Siberian Peashrub		B&B / WB, single stem
Со	1	Celtis occidentalis	Common Hackberry	60mm caliper	WB Staked
JvSR	32	Juniperus virginiana 'Skyrocket'	Skyrocket Juniper	150 cm	Potted
MHG	2	Malus 'Harvest Gold'	Harvest Gold Crab Apple	60mm caliper	WB, Staked
SrIP	5	Syringa reticulata 'Ivory Pillar'	Ivory Pillar Tree Lilac	45mm dia.	WB Staked
		SHRUBS			
DI	7	Diervilla Ionicera	Dwarf Bush-honeysuckle	50cm ht	1.0m o.c.
HaA	13	Hydrangea arborescens 'Annabelle'	Annabelle Hydrangea	2 gallon pot	0.9m o.c.
Lb	7	Lindera benzoin	Spicebush	50cm ht	1.0m o.c.
Pmm	1	Pinus mugo mughus	Mugho Pine	75cm spd	2m o.c.
RaLG	26	Rhus aromatica 'Gro-Low'	Gro-Low Fragrant Sumac	40 cm ht.	Potted
SbF	2	Spiraea bumalda 'Froebelii'	Froebel's Spirea	50cm ht.	Potted, 1.0m o.c.
SpBW	3	Spiraea prunifolia	Bridal Wreath Spirea	50 cm ht.	Bare root
ТоН	4	Thuja occidentalis 'Holmstrup'	Holmstrup Eastern Arborvitae	100 cm ht.	Potted
		PERENNIALS			
PvA	71	Sun / Shade - Coral Bells, Sedges, Hostas			
PvB	17	Shade - Ornamental Grasses			
PvC	79	Shade - Ferns, Hostas, Daylilies, Solomon's Seal			
PvD	40	Sun - Sedges, Feather Reed Grasses			

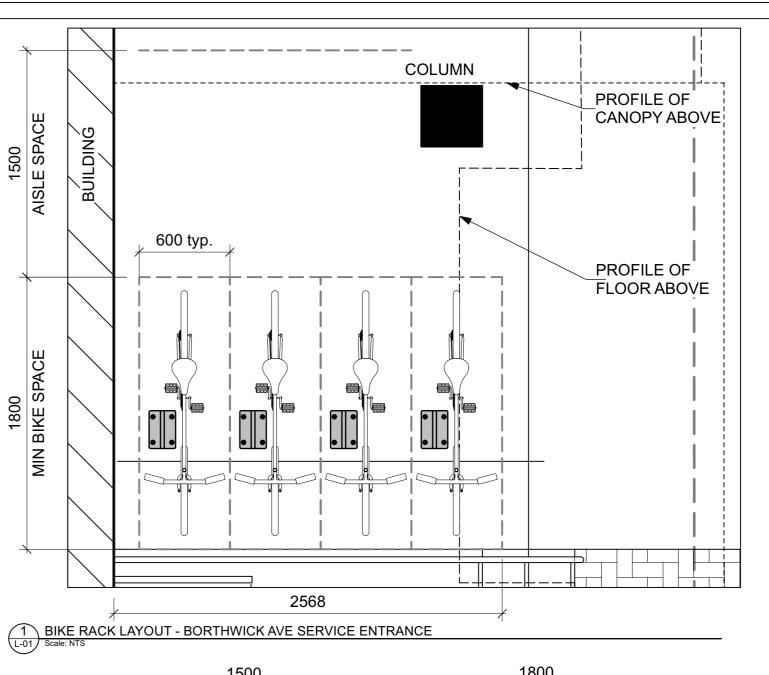

1800 1500 AISLE SPACE MAINTENANCE EDGE ROOF OVERHANG

BIKE RACK LAYOUT - MONTREAL AVE COMMERCIAL ENTRANCES

L-01) Scale: NTS

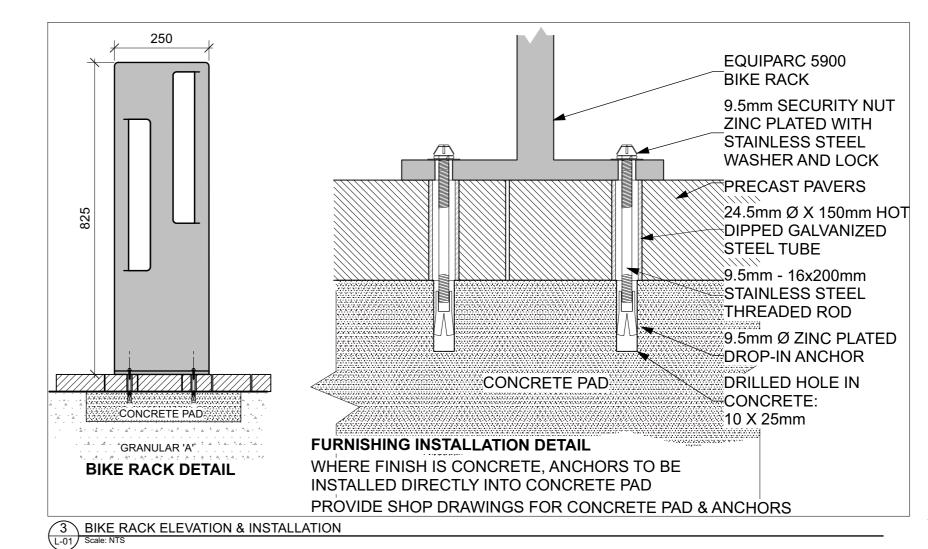

SOFT

790

Tree Soil Volumes		OTTAWA	Design		
Soil Volume Area, Tree Quantity and Size (soil to depth of 1r	n Tree	Target Soil	Soil	Soil Adequacy	
in areas A & B, all other areas to depth of 0.9m)	Quantity	Volume (m ³)	Volume	percentage	
AREA A - 1 small ornamental tree (15cm DBH)*					+ EVTD
plant bed (11.2 sq m x 1 metre deep)	1	8.0	11.2	140.00%†	† EXTRA SOIL DEPTH TO ALLOW
AREA B - 1 medium tree					FOR POSSIBLE
plant bed (27.1 sq m x 1 metre deep)	1	25.0	27.1	108.40%†	FUTURE BUS STOP INSTALLATION
AREA C - 2 medium trees					
plant bed (33.5 sq m x 0.9 metre deep)	2	30.0	30.2	100.50%	
AREA D - 1 large tree, 1 medium tree					
plant bed (37.6 sq m x 0.9 metre deep)	2	33.0	33.8	102.55%	
AREA E - 2 small trees					
plant bed (28.5 sq m x 0.9 metre deep)	2	24.0	25.7	106.88%	
AREA F - 1 small ornamental tree (10cm DBH)*					
plant bed (5.8 sq m x 0.9 metre deep)	1	6.0	5.2	87.00%	
AREA G - 1 small ornamental tree (15cm DBH)*					
plant bed (9.7 sq m x 0.9 metre deep)	1	8.0	8.7	109.13%	
AREA H - 1 small ornamental tree (15cm DBH)*					
plant bed (7.5 sq m x 0.9 metre deep)	1	8.0	6.8	84.38%	

much soil to grow a big tree' by DeepRoot as a guide

Ruhland & Associates Ltd landscape architecture • urban design • site planning

Ph 613-224-4744 Fx 613-224-1131

Site plan Control resubmission 2022 04 22 Re-Issued for Site plan Control Issued for Site plan Control 2021 10 26 DATE: (Y/M/D) INITIALS INITIALES MBER/ MILESTONE / FAIT SAILLANT

CHECKED BY / VERIFIE PAR M RUHLAND M RUHLAND DRAWN BY / DESSINE PAR

SCALE / ECHELLE Scale: 1:100

ARCHITECT CONSULTANT

CONSULTANT CONSULTANT

PROJECT / LOCATION 630 MONTREAL ROAD **APARTMENT BUILDING** COMPLEX

630 MONTREAL ROAD OTTAWA, ON


PROJECT NO.


PLANTING PLAN

OCT 2021

21-1646

SHEET NO.

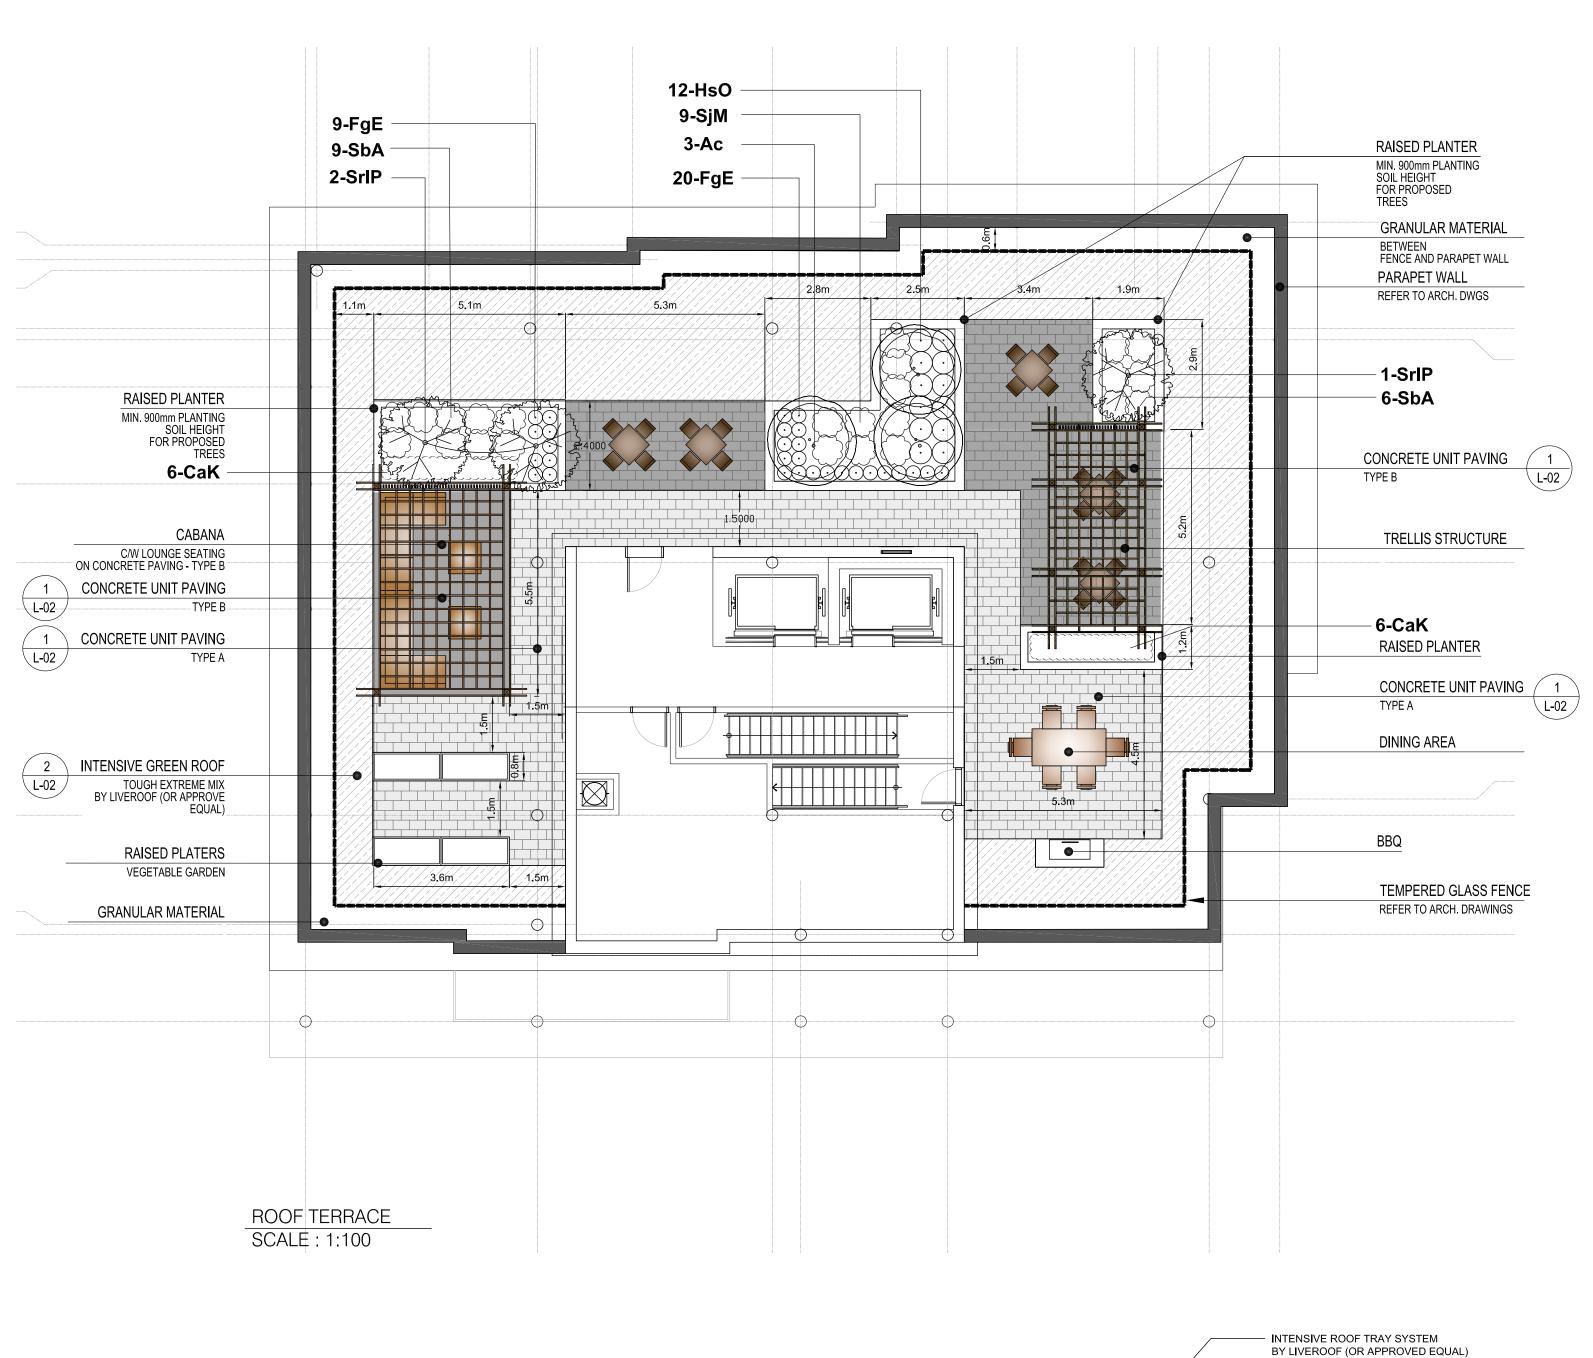

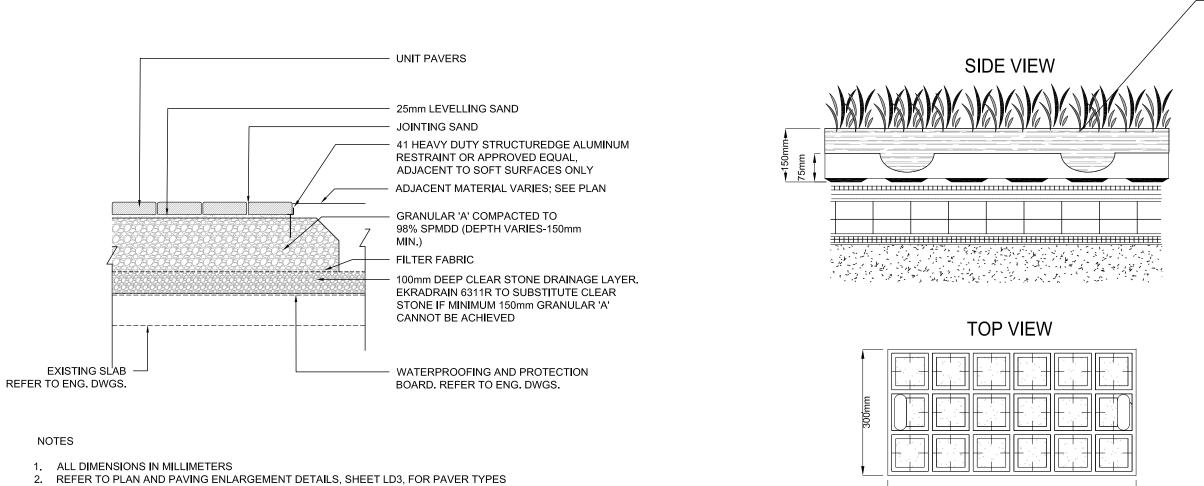

1 CONCRETE UNIT PAVING - ON SLAB


L-02 NTS

2 INTENSIVE ROOF TRAY SYSTEM L-02 NTS

REFER TO ARCHITECTURAL DRAWINGS FOR

ROOF MEMBRANE.

Tough Extreme Mix

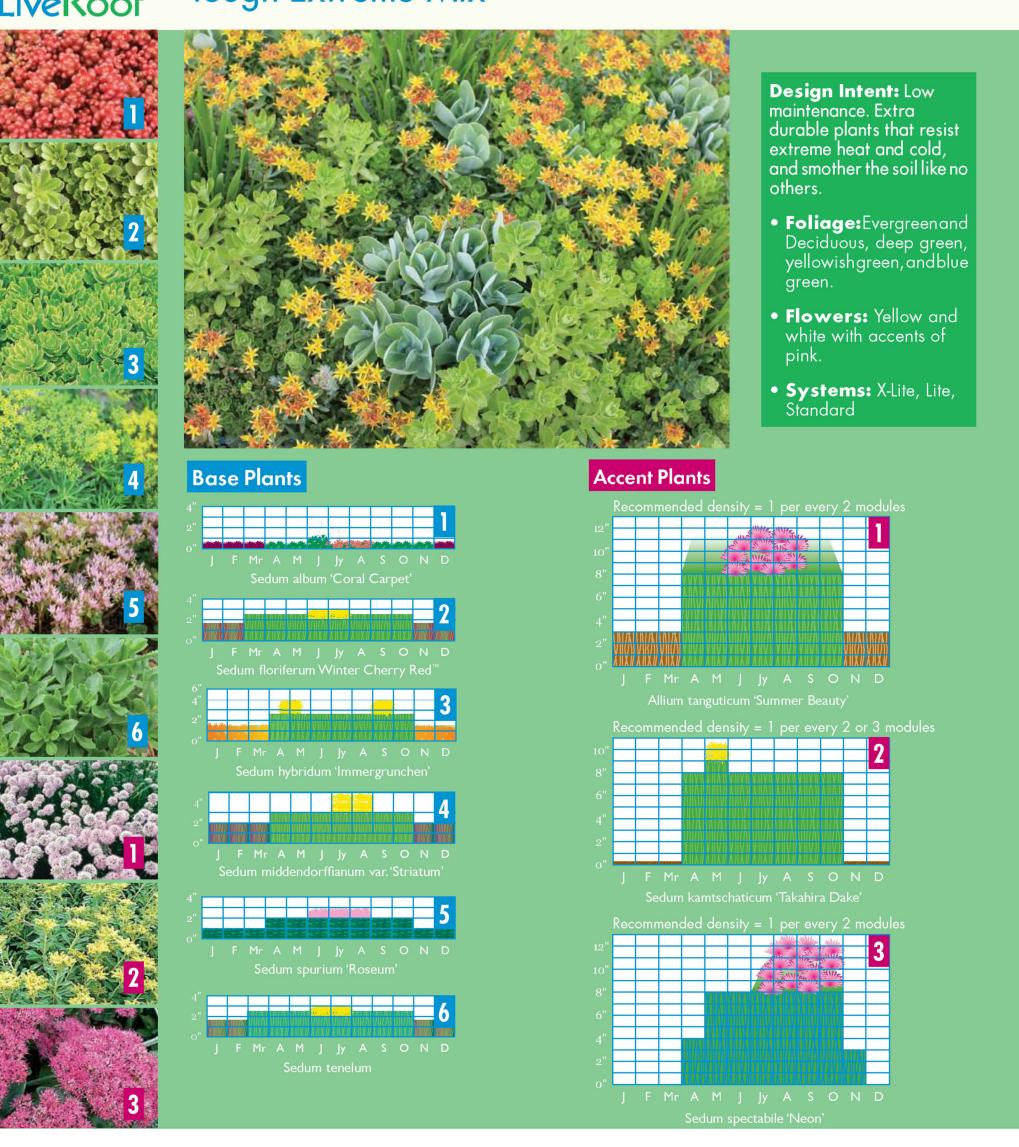

ID	Qty	Botanical Name	Common Name	Scheduled Size	Remarks
		TREES			
Ac	3	Amelanchier canadensis	Serviceberry	45mm caliper	WB, Multi-Stem
SrIP	3	Syringa reticulata 'Ivory Pillar'	Ivory Pillar Tree Lilac	45mm dia.	WB Staked
		SHRUBS			
SbA	15	Spiraea x bumalda 'Anthony Waterer'	Anthony Waterer Spirea	50cm ht.	Potted, 0.6 m o.c.
SjM	9	Spiraea japonica 'Flaming Mound'	Flaming Mound Spirea	50cm ht.	Potted, 0.6 m o.c.
		PERENNIALS			
CaK	12	Calamagrostis acutiflora 'Karl Foerster'	Feather Reed Grass	2 gal.	Potted 0.6m o.c.
FgE	29	Festuca glauce 'Elijah Blue'	Grasses	2 gal.	Potted 0.3m o.c.
HsO	12	Hemerocallis 'Stella D'Oro'	Stella D'Oro Dailily	2 gal.	Potted. 0.5m o.c.

Ruhland & Associates Ltd

landscape architecture • urban design • site planning Ph 613-224-4744 Fx 613-224-1131

Issued for Site plan Control DATE: (Y/M/D) INITIALS INITIALES NUMBER/ MILESTONE / FAIT SAILLANT CHECKED BY / VERIFIE PAR M RUHLAND M RUHLAND DRAWN BY / DESSINE PAR

JK/TF SCALE / ECHELLE



ARCHITECT CONSULTANT CONSULTANT CONSULTANT

PROJECT / LOCATION 630 MONTREAL ROAD APARTMENT BUILDING COMPLEX


630 MONTREAL ROAD OTTAWA, ON

GREEN ROOF PLAN

OCT 2021

SHEET NO.

PROJECT NO. 21-1646

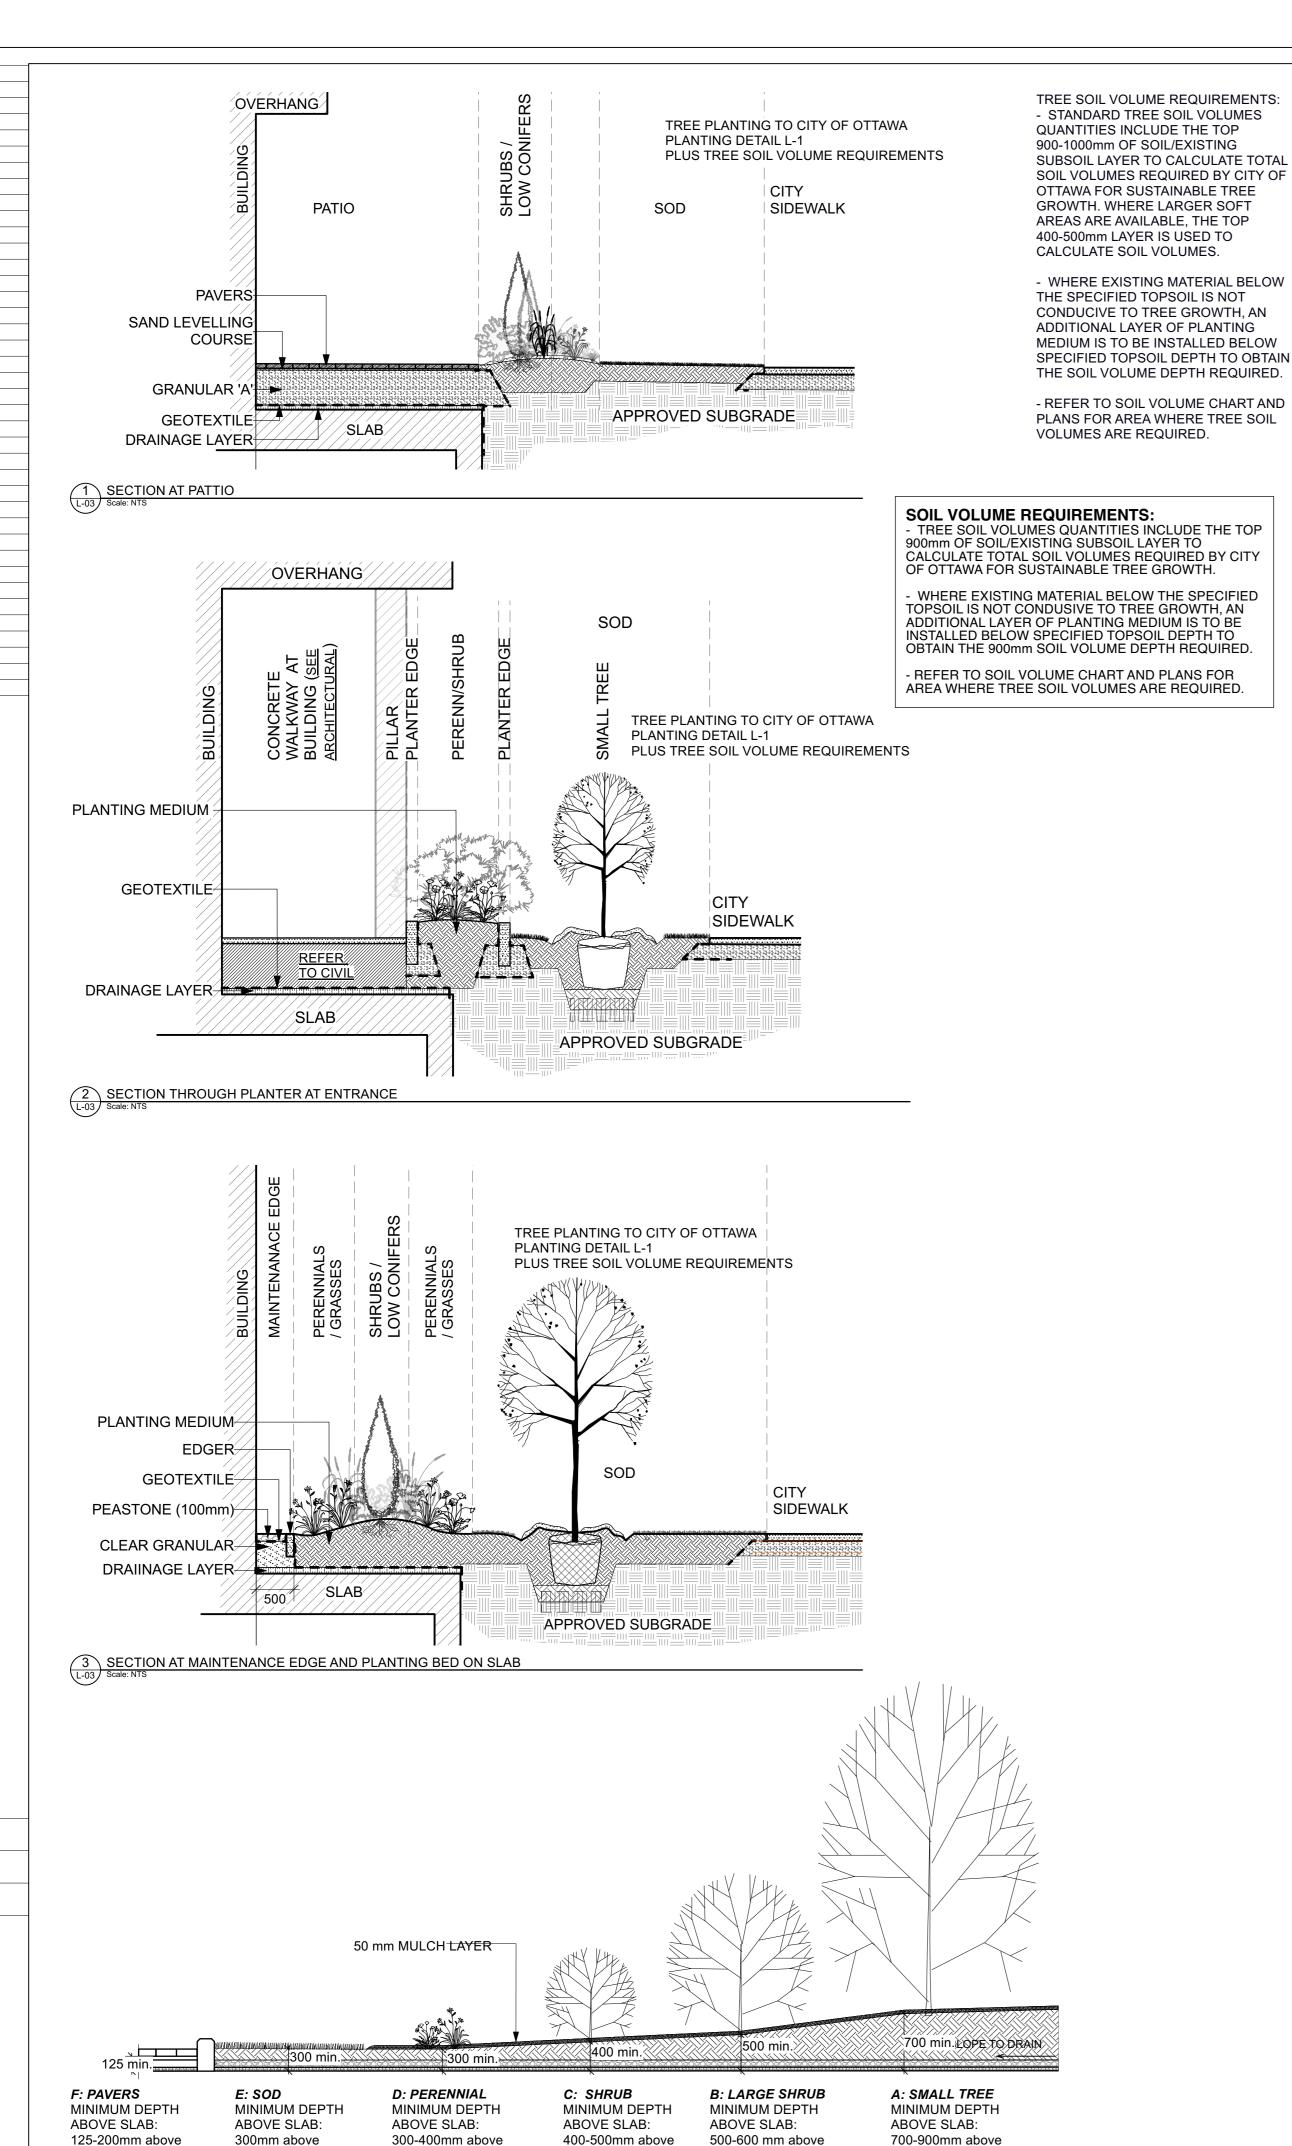

drainage layer

drainage layer

TYPICAL SECTION OF LANDSCAPE PROFILES ON SLAB


Scale: NTS


drainage layer

drainage layer


drainage layer


drainage layer

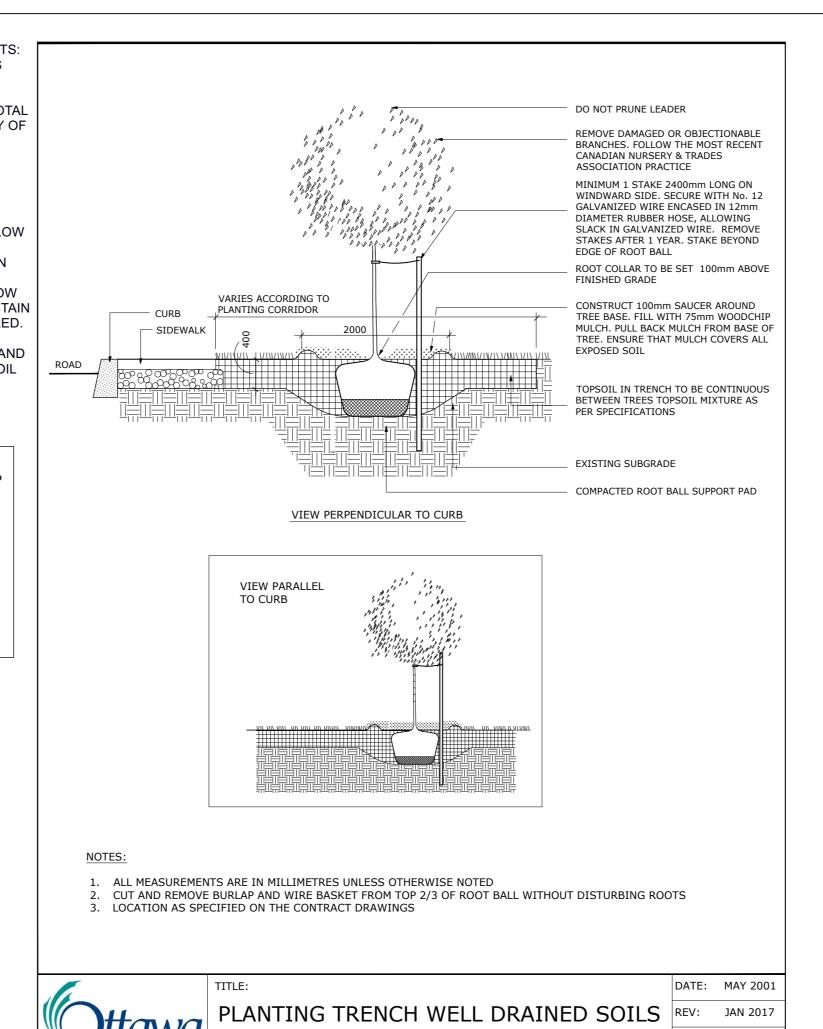

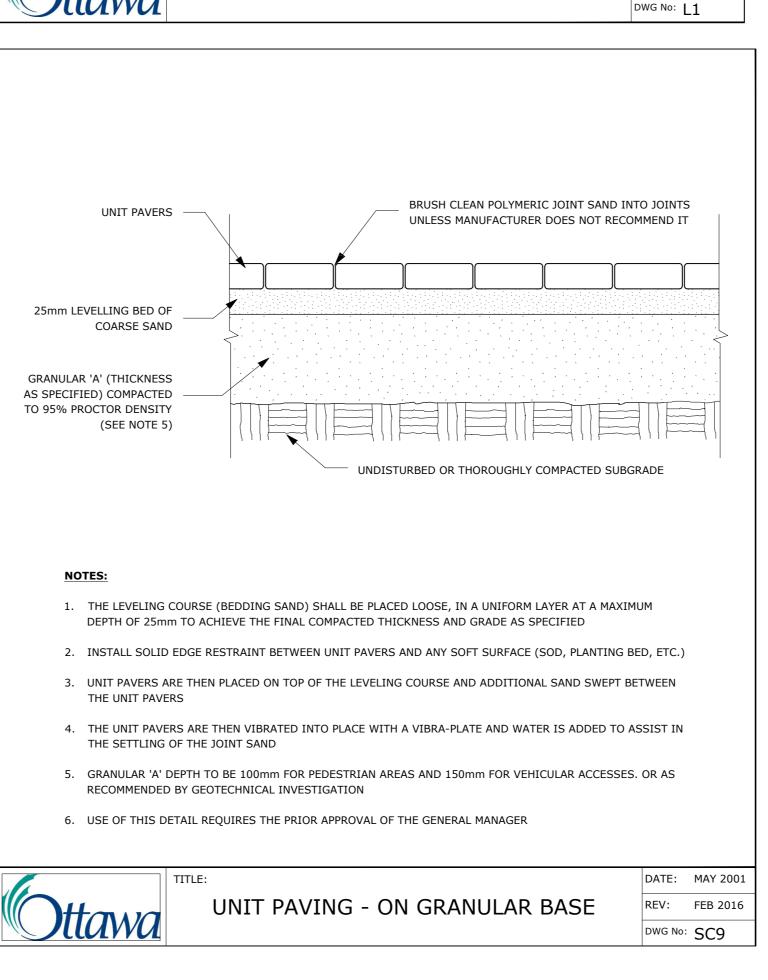

ADDITIONAL NOTES FOR NUMBER 5: 100mm DEPTH GRANULAR 'A' TO BE USED (AFTER APPROVAL) ONLY IN PEDESTRIAN WHERE NO SNOW REMOVAL IS PLANNED. ALL OTHER PEDESTRIAN AREAS ARE TO RECEIVE 150mm COMPACTED GRANULAR'A' MINIMUM, VEHICULAR 200mm MINIMUM. FURTHER ADJUSTMENTS TO BE SPECIFIED IN RELATION TO SITE CONDITIONS AND GEOTECHNICAL RECOMMENDATIONS.

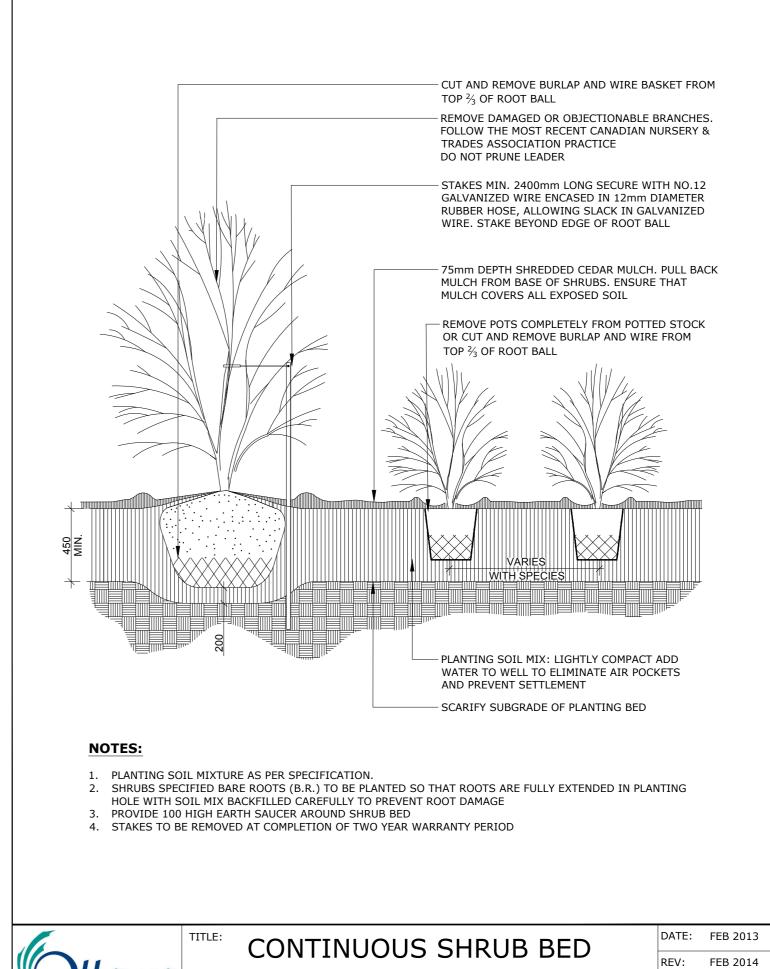

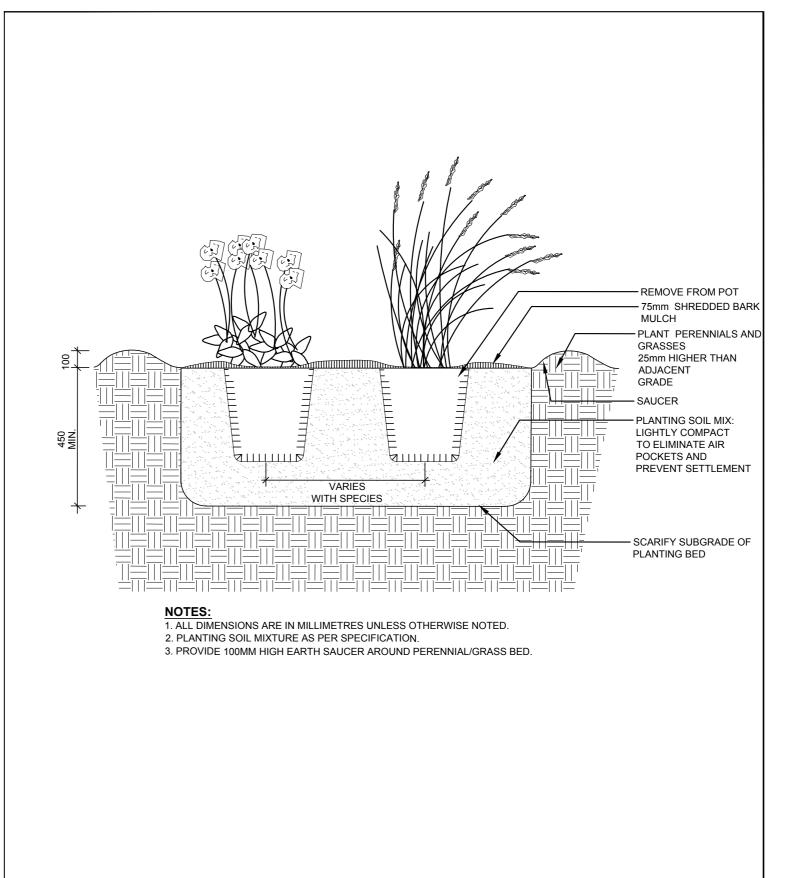


PERENNIAL AND ORNAMENTAL

GRASS PLANTING

PLANTING

DWG No: L17

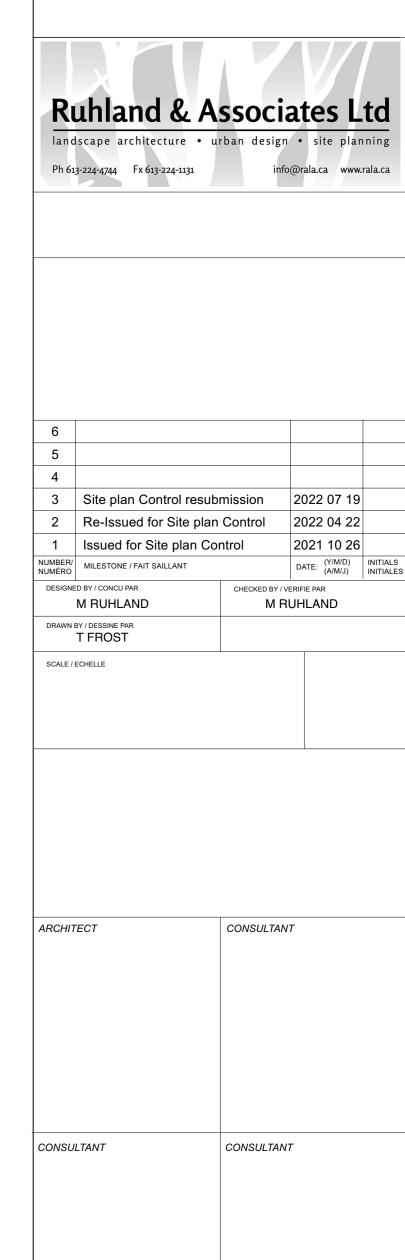

PROJECT / LOCATION 630 MONTREAL ROAD **APARTMENT BUILDING** COMPLEX

630 MONTREAL ROAD OTTAWA, ON

DATE: JAN 2015

DWG No: L21

DETAILS

OCT 2021

SHEET NO.

PROJECT NO.

21-1646