

**GENERAL NOTES** 

All general site information and conditions compiled from existing plans, surveys and consultant's field notes. Report all discrepancies prior to any work. No responsibility is born by the Consultant for unknown subsurface conditions.

2 The location of the utilities is approximate only, and the exact location should be determined by consulting the municipal authorities and utility companies concerned. The Contractor shall prove the location of utilities and shall be responsible for adequate protection from damage.

All dimensions shown are to be verified on site prior to any construction. No deviations are to be made from the layouts as shown on this plan without prior consultation with

the Landscape Architect and Owner.

5 Stake planting locations and receive approval of Landscape Architect, prior to excavation of any planting pits. No substitutions of plant material shall be made without prior

6 Where clay is encountered proper drainage must be ensured in tree/shrub pits, prior to planting. Have method approved by Landscape Architect.

All sodded areas to receive a minimum of 150mm of topsoil over graded sub-base. If sod with mesh is used, mesh to be removed completely during sodding operations. Sod shall come from an approved source and shall be laid within 24 hours of being cut in the nursery. Only nursery sod shall be

.8 Final subgrade is to approved by the Landscape Architect prior to sod being laid.

.9 Maintain positive surface runoff through the entire

construction period. 10 Reinstate all areas and items damaged as a result of

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5		
4	Re-issued SPC submission	2023/04/24
3	Re-issued SPC submission	2023/01/09
2	Re-issued SPC submission	2022/07/08
1	Issued for SPC submission	2021/11/22

issue / revision



**Ruhland & Associates Ltd** 

**3996 INNES RD,** OTTAWA ON

drawing title

LANDSCAPE PLAN

			_
scale	drawn by	designed by	200
1:100	C. Reed/T. Frost	C. Reed	Ċ
date	checked by	plot date	2
November 2021	M. Ruhland	Nov10, 2021	12
project number	drawing number		-700
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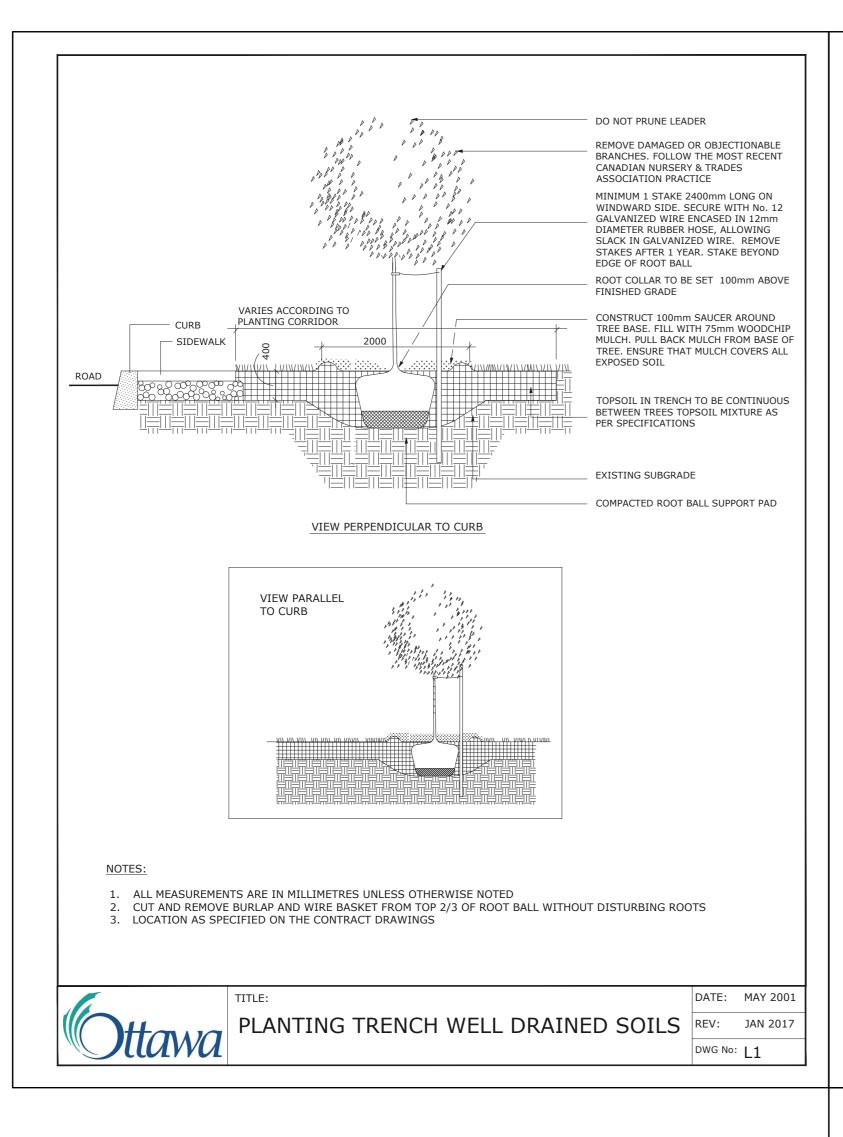
Contractor to check and verify all dimensions on the job


SOIL VOLUME NOTES TO GO WITH L1


TREE SOIL VOLUME REQUIREMENTS: - STANDARD TREE SOIL VOLUMES QUANTITIES INCLUDE THE TOP 900-1000mm OF SOIL/EXISTING SUBSOIL LAYER TO CALCULATE TOTAL SOIL VOLUMES REQUIRED BY CITY OF OTTAWA FOR SUSTAINABLE TREE GROWTH. WHERE LARGER SOFT AREAS ARE AVAILABLE, THE TOP 400-500mm LAYER IS USED TO CALCULATE SOIL VOLUMES.


WHERE EXISTING MATERIAL BELOW THE SPECIFIED TOPSOIL IS NOT CONDUCIVE TO TREE GROWTH, AN ADDITIONAL LAYER OF PLANTING MEDIUM IS TO BE INSTALLED BELOW SPECIFIED TOPSOIL DEPTH TO OBTAIN THE SOIL VOLUME DEPTH REQUIRED.


- REFER TO SOIL VOLUME CHART AND PLANS FOR AREA WHERE TREE SOIL VOLUMES ARE REQUIRED.




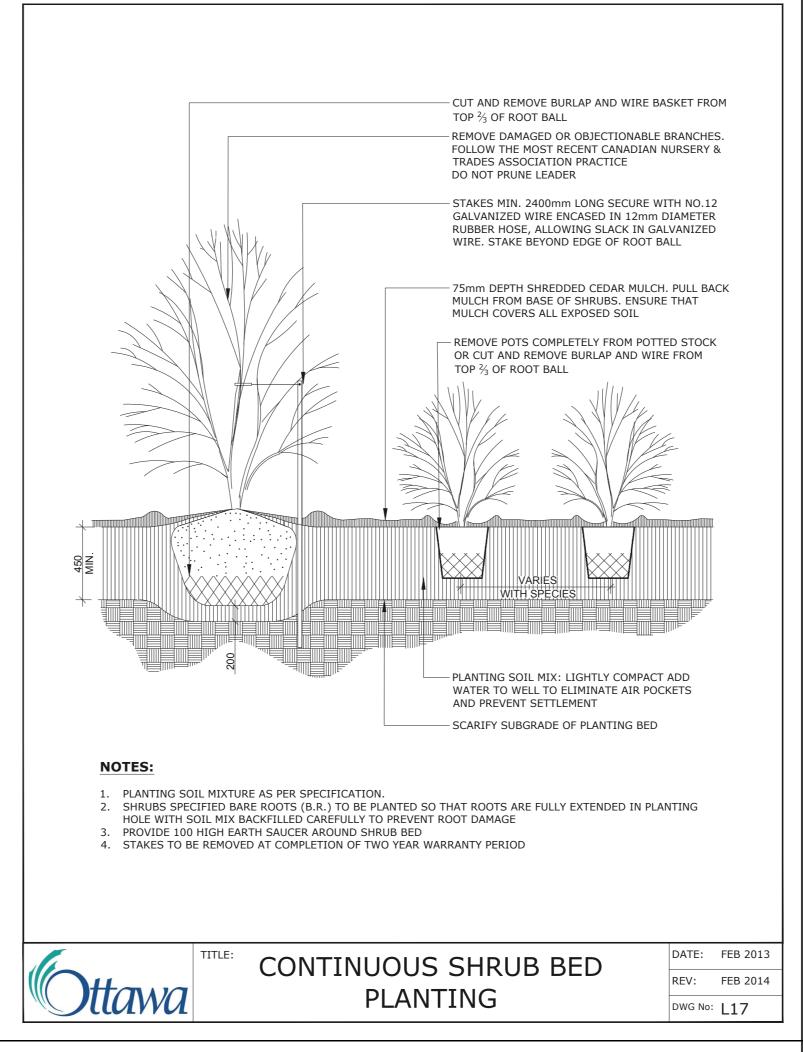


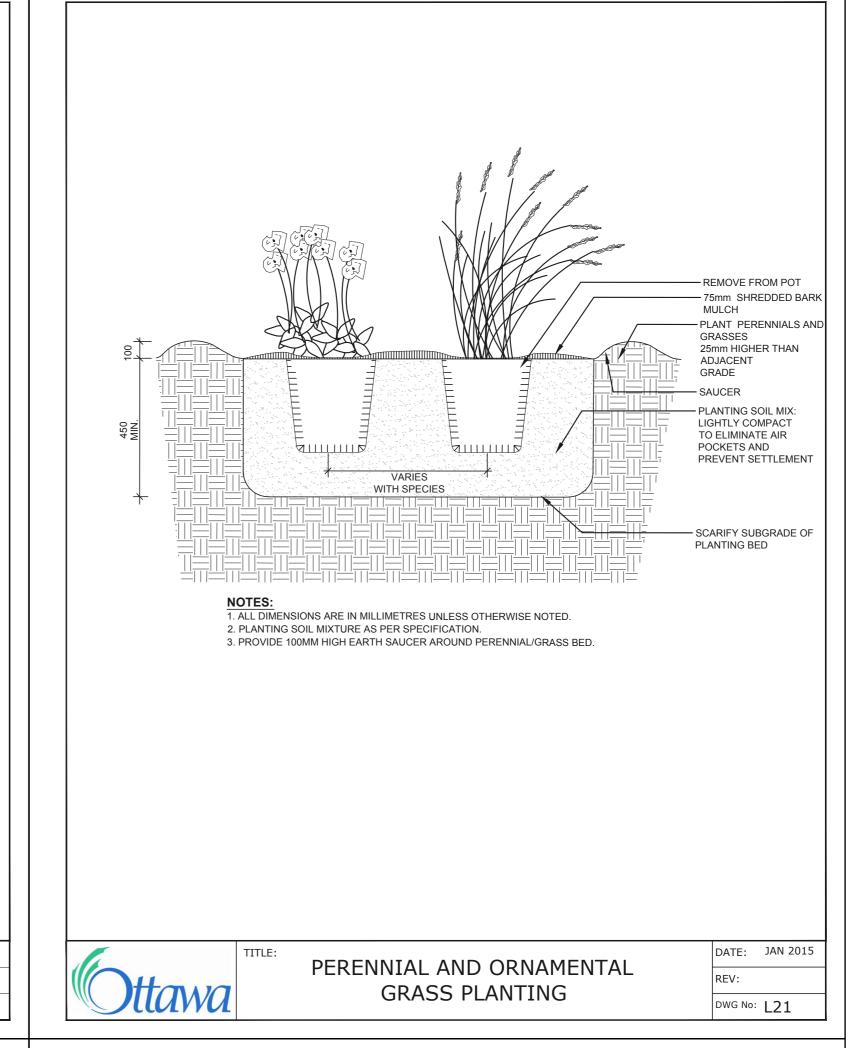

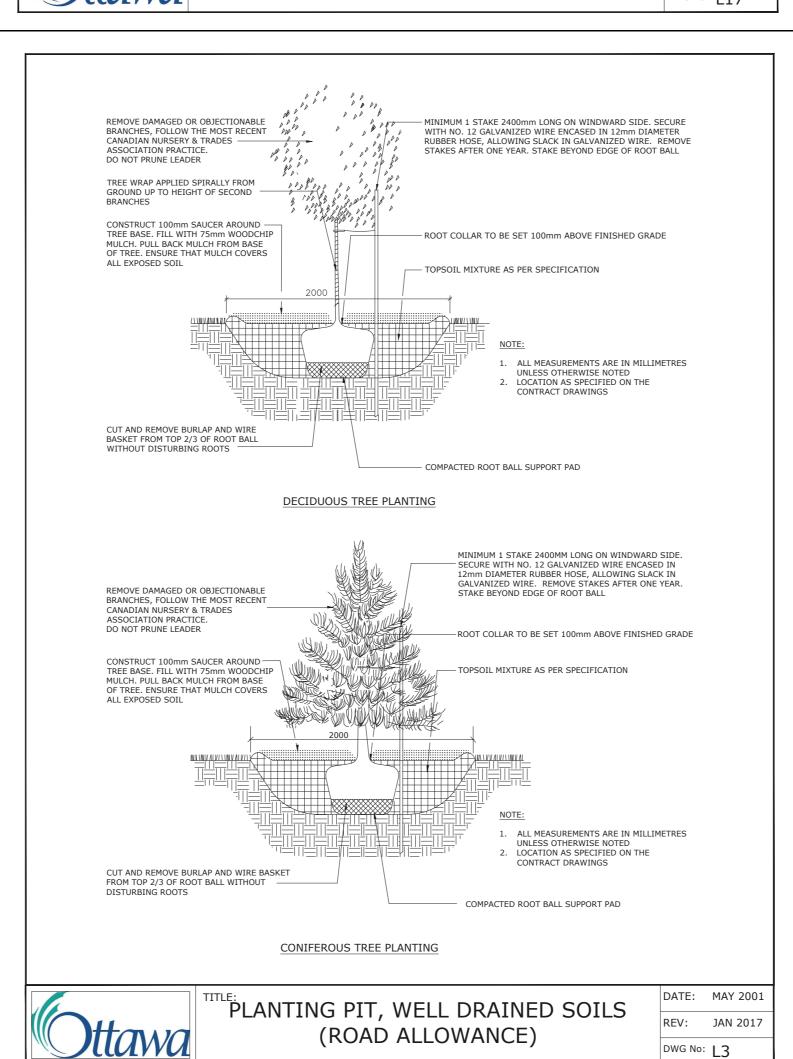

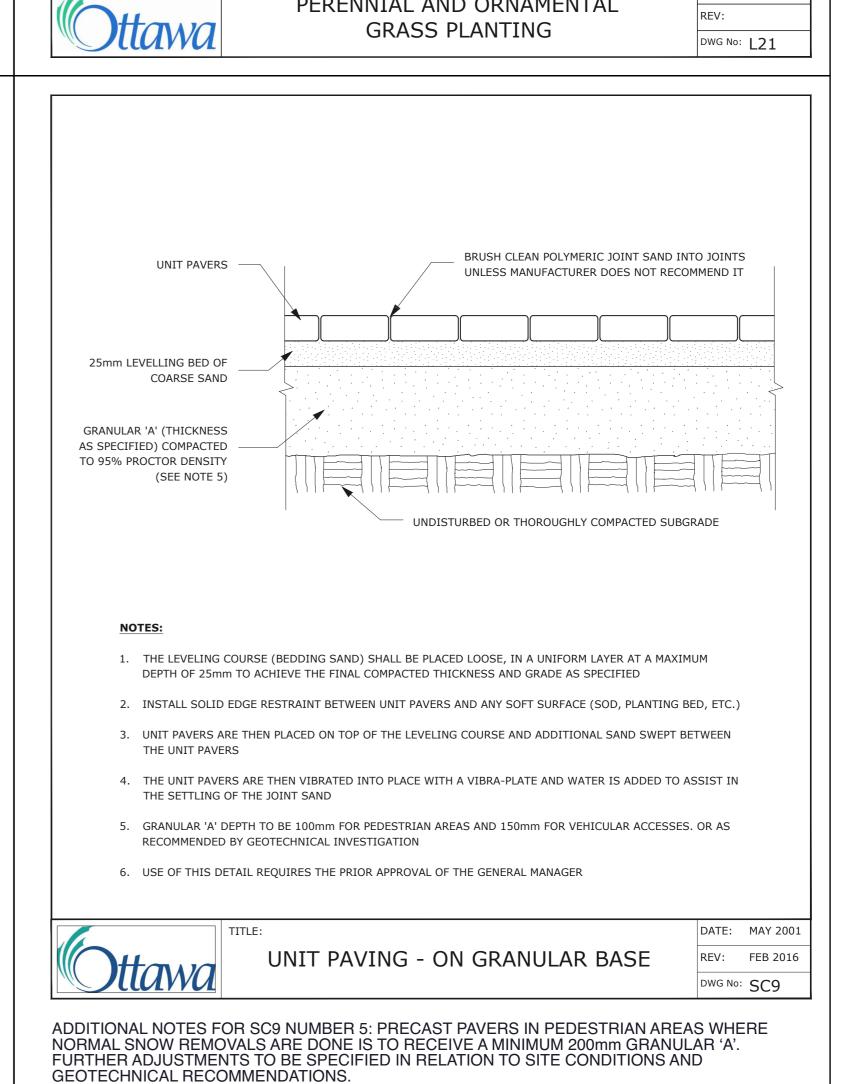

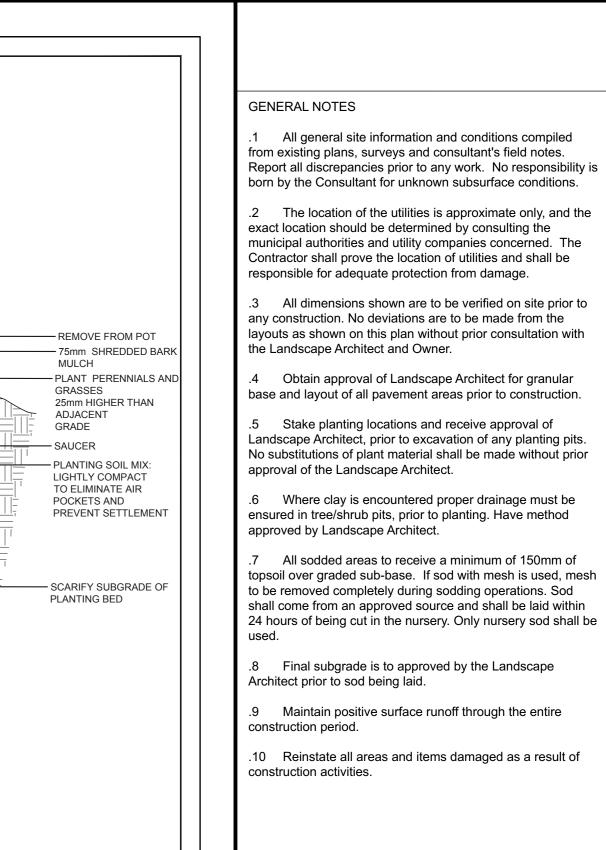

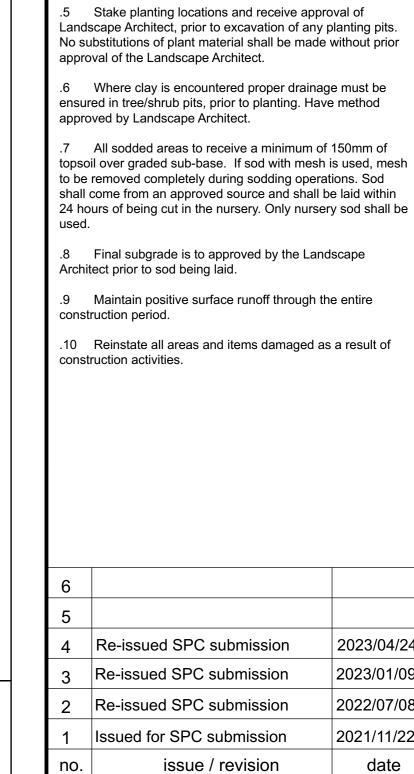



project

north

**3996 INNES RD,** OTTAWA ON

drawing title

**DETAILS** 

designed by scale drawn by C. Reed/T. Frost C. Reed date checked by plot date November 2021 Nov10, 2021 M. Ruhland

project number

drawing number

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2023/04/24

2023/01/09

2022/07/08

2021/11/22

date

**TYPICAL SECTION** 

SECTION ALONG EAST PROPERTY LINE

2 SECTION Scale: NTS

1 METALLIC GUARD RAIL
L-03 Scale: NTS
REFER TO SITE PLAN FOR LOCATIONS

3 GLOBAL INDUSTRIAL™ 4' PARK BENCH Tan, w/Backrest

-WALKWAY PAVEMENT -PLANTING MEDIUM ACCORDING TO LANDSCAPING PLAN AND-SPECIFICATIONS 150mm Min. -FABRIC FILTER. -RETENTION/AERATION DRAINAGE LAYER100mm Min. -DRAINAGE GEOTEXTILE (e.g. MIRADRAIN) -PROTECTION MEMBRANE -THERMAL INSULATION: R35. -GREEN ROOF WATERPROOFING MEMBRANE -PROVIDE SHOP-DRAWINGS AND SPECIFICATIONS FOR APPROVAL. -REINFORCED CONCRETE SLAB STRUCTURAL SUPPORT -RIGID INSULATION SLAB-ON-GRADE SEE PLAN DRAINAGE PIPE THROUGH (REFER TO ARCH. / MECH. FOR ELEV./ SLOPE TO DRAIN) FOUNDATION WALL @ 3000 o.c. (CONFIRM WITH MECH. / CIVIL) FOOTING (SEE STRUCTURAL DRAWINGS)



5 SKYLINE OUTDOOR PATIO HARD-TOP GAZEBO
L-03 Canvas, w/ Bug Net, Black 10'x12'

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- .3 All dimensions shown are to be verified on site prior to any construction. No deviations are to be made from the layouts as shown on this plan without prior consultation with
- the Landscape Architect and Owner..4 Obtain approval of Landscape Architect for granular
- .5 Stake planting locations and receive approval of Landscape Architect, prior to excavation of any planting pits. No substitutions of plant material shall be made without prior approval of the Landscape Architect.

base and layout of all pavement areas prior to construction.

- .6 Where clay is encountered proper drainage must be ensured in tree/shrub pits, prior to planting. Have method approved by Landscape Architect.
- .7 All sodded areas to receive a minimum of 150mm of topsoil over graded sub-base. If sod with mesh is used, mesh to be removed completely during sodding operations. Sod shall come from an approved source and shall be laid within 24 hours of being cut in the nursery. Only nursery sod shall be
- .8 Final subgrade is to approved by the Landscape Architect prior to sod being laid.
- .9 Maintain positive surface runoff through the entire construction period.
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north			

Ruhland & Associates Ltd

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project

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drawing title

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umber

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