

#### LEGEND - LANDSCAPE

DETAIL SHEET # NOVATECH OR CITY Implement the following protection measures for retained trees both on site and on adjacent sites, prior to any work activity, including tree removal. Maintain tree protection fence in place

— — — PROPERTY LIMIT

TREE PROTECTION FENCE

PROPOSED CONCRETE

RIVERSTONE

PROPOSED PLANTING BED

SEED MIX A - SEE NOTE

SEED MIX B - SEE NOTE

SEED MIX C - SEE NOTE

PROPOSED WET SHRUB MIX, REFER TO SHEET L6

PROPOSED DRY SHRUB MIX, REFER TO SHEET L6 PROPOSED DECIDUOUS TREE

PROPOSED CONIFEROUS TREE

PROPOSED SHRUBS

EXISTING TREE TO REMAIN

EXISTING HEDGEROW TO REMAIN

blanket. Erosion control blanket to be machine woven mats made

on manufacturer, with stitching between two photo-degradable

natural organic fiber nettings. Submit products for approval by Consultant. OPSS 804 applies except as may be amended and

In addition to the specified seed mixes, all applications are to

15% Canada Wild Rye (Elymus canadensis)

CUSTOM NATIVE PARKING ISLAND SEED MIX BY DLF

(613) 254-9643

(613) 254-5867

www.novatech-eng.com

from natural wood, coco or cotton fiber, or combination depending

- SPECIES (SEE PLANT LIST)

1. Plant material to be No. 1 Grade and is to comply with Canadian Standards for Nursery Stock (latest edition)

published by the Canadian Nursery Landscape Association. 2. Use structurally sound plant material with strong fibrous root system free of disease, defects, and injuries. Use trees with straight trunks, well and characteristically branched for species. Obtain approval from consultant of plant material at source prior to digging. All trees and shrubs to be container grown, potted, W/B or B/B, as indicated on Plant List. Bare

Implement the following protection measures for retained trees,

in good condition for the duration of site works:

fence prior to work commencement.

of any tree, including outhouses.

CRZ without approval.

machinery permitted.

away from any tree canopy.

ground within the CRZ.

Excavation of Root Zone.

prior to fence movement.

PLANTING

landscaping.

tree disclosure report, etc.).

including tree removal. Maintain tree protection fence in place and

1. The Landscape Architect or Certified Arborist is to determine the location of the tree protection fencing and detail it on any associated plans for the site (e.g. tree conservation report,

2. Under the guidance of a Landscape Architect or Certified

3. Refer to the Tree Protection Plan for fence location. City Forestry Staff are to approve both the plan and the installed

5. Do not attach any signs, notices, or posters to any tree. 6. Do not disturb, raise, or lower the existing grade within the

7. Only tunnel or bore when digging within the CRZ of a tree. Hand work only where required within the CRZ; absolutely no

8. Do not damage the root system, trunk, or branches, or any

10. Ensure that exhaust fumes from all equipment are directed

11. When trees marked for removal overlap with the CRZ of trees

12. Prior to work taking place, notify and consult the Landscape Architect and City Forestry Staff if roots must be cut. Roots 20mm or larger should be cut at right angles with clean, sharp

City of Ottawa Specification S.P. F-8011 Tree Protection,

13. If damaged or objectionable branches are observed, consult

not prune leaders. Do not prune more than 1/4 of crown. 14. Set up a water and fertilizing program, if trees are being affected by site works, to the satisfaction of the Landscape

15. The Landscape Architect is to prescribe mitigation measures

construction. Measures may include the placement of

plywood, wood chips, or steel plating over the roots for protection. City Forestry Staff are to approve said measures

16. City of Ottawa By-law: Protects municipal trees and municipal

property in the urban area of the City of Ottawa (2020-340).

natural areas in the City of Ottawa and trees on private

the Landscape Architect, before any work is conducted. Do

marked for preservation: cut roots at the edge of the CRZ and grind down stumps after tree removals, do not pull out stumps. Ensure there is not root pulling or disturbance of the

horticultural tools without tearing, crushing, or pulling. Refer to

9. Do not extend hard surface or significantly change

4. Do not place any material or equipment within 2m of the CRZ

Arborist, erect a fence at the critical root zone (CRZ) of trees. Diameter at breast height (DBH) is the trunk diameter measured at 1.3m height on the tree trunk. The CRZ is

calculated as DBH x 10. Refer to the Tree Protection Fence

root plants are only acceptable for certain species and as approved by the Landscape Architect. 3. Plant material substitutions are not be permitted without the written approval from the Consultant, with 48 hours notice, prior to shipping plant material.

4. Plant locations are schematic / approximate only. Contractor is to stake out locations on site for approval by the Landscape Architect prior to installation. 5. The illustrated number of plants shown in the Planting Plan

supersedes the estimated number in the Plant List. Contractor to report any discrepancies to the Landscape Architect prior to installation. Contractor will assume full responsibility if the Landscape Architect is not notified. Ensure trees are thoroughly watered following planting. Monitor material and ensure adequate moisture until

acceptance. 7. In heavy clay or poorly drained soils, set root ball with root

collar 75-100mm higher than finished grade. 8. Approved topsoil depths are as follows:

a. Plant Beds - **450mm** continuous depth. Applies to

shrubs, perennials, vines, and groundcovers. b. Sod/ Seed Areas - 100mm depth. Sod to be No. 1 Kentucky Bluegrass Sod grown from minimum mixture of 3 Kentucky Bluegrass cultivars. Quality

and source are to comply with Canadian Standards for Nursery Stock, Section 17, (latest edition) published by the Canadian Nursery Landscape Nursery Landscape Association.

10. Apply the following mineral fertilizer unless soil tests show other requirements:

a. Plant Beds - (8-32-16), i.e. 8% Nitrogen, 32% Phosphorus, 16% Potash per manufacturer specifications. b. Sod Areas - (8-32-16), i.e. 8% Nitrogen, 32% Phosphorus, 16% Potash at a rate of 350kg/ha.

11. Where applicable, for any plant areas with a mix of species/ cultivars notes, Contractor is to cluster like plants in groups of 3-5 and evenly distribute these in the noted area.

CITY DETAILS SEED MIX AND APPLICATION Related details from City of Ottawa Standard Tender Documents For areas steeper than 3:1, Contractor to apply erosion control

SC4. Typical Concrete Sidewalk in Boulevard

**FOR REVIEW ONLY** 

SC5. Sidewalk Construction Joints

Volume No. 2 Standard Detail Drawings.

### NOVATECH DETAILS

Found on Sheet L7.

- D1. Standard Deciduous Tree Planting D2. Standard Coniferous Tree Planting D3. Shrub and Perennial Planting
- D4. Tree Protection Fence D5. Bike Layout D6. Site furniture installation
- D7. Reforestation D8. Riverstone

Facsimile

extended herein.

include a nurse crop as noted.

40% Oats (Avena sativa)

45% Barley (Hordeum vulgare)

Seeding Rate: 15kg/hectare

Seeding Rate: 25kg/hectare

NURSE CROP

SEED MIX C

Engineers, Planners & Landscape Architect Suite 200, 240 Michael Cowpland Drive

Ottawa, Ontario, Canada K2M 1P6

LOCATION CITY of OTTAWA 105 HUNTMAR DRIVE - WAREHOUSE DEVELOPMENT 🛚 🧲

DRAWING NAME LANDSCAPE PLAN

122151 REV # 2 122151-L2

THE POSITION OF ALL POLE LINES, CONDUITS, WATERMAINS, SEWERS AND OTHER UNDERGROUND AND OVERGROUND UTILITIES AND STRUCTURES IS NOT NECESSARILY SHOWN ON THE CONTRACT DRAWINGS, AND WHERE SHOWN. THE ACCURACY OF THE POSITION OF SUCH UTILITIES AND STRUCTURES IS NOT GUARANTEED. BEFORE STARTING WORK, DETERMINE THE EXACT LOCATION OF ALL SUCH UTILITIES AND STRUCTURES AND ASSUME ALL LIABILITY FOR

DAMAGE TO THEM.

NOT FOR CONSTRUCTION

Owner: Rosefellow


c/o Julian Nini


750 Marcel-Laurin, Suite 210 Saint-Laurent, QC H4M 2M4

Phone: (514) 532-1080

SCALE 1:400 REVISED PER CITY COMMENTS MAR 30/23 ISSUED FOR CITY OF OTTAWA REVIEW DEC 16/22 DATE REVISION

#18906

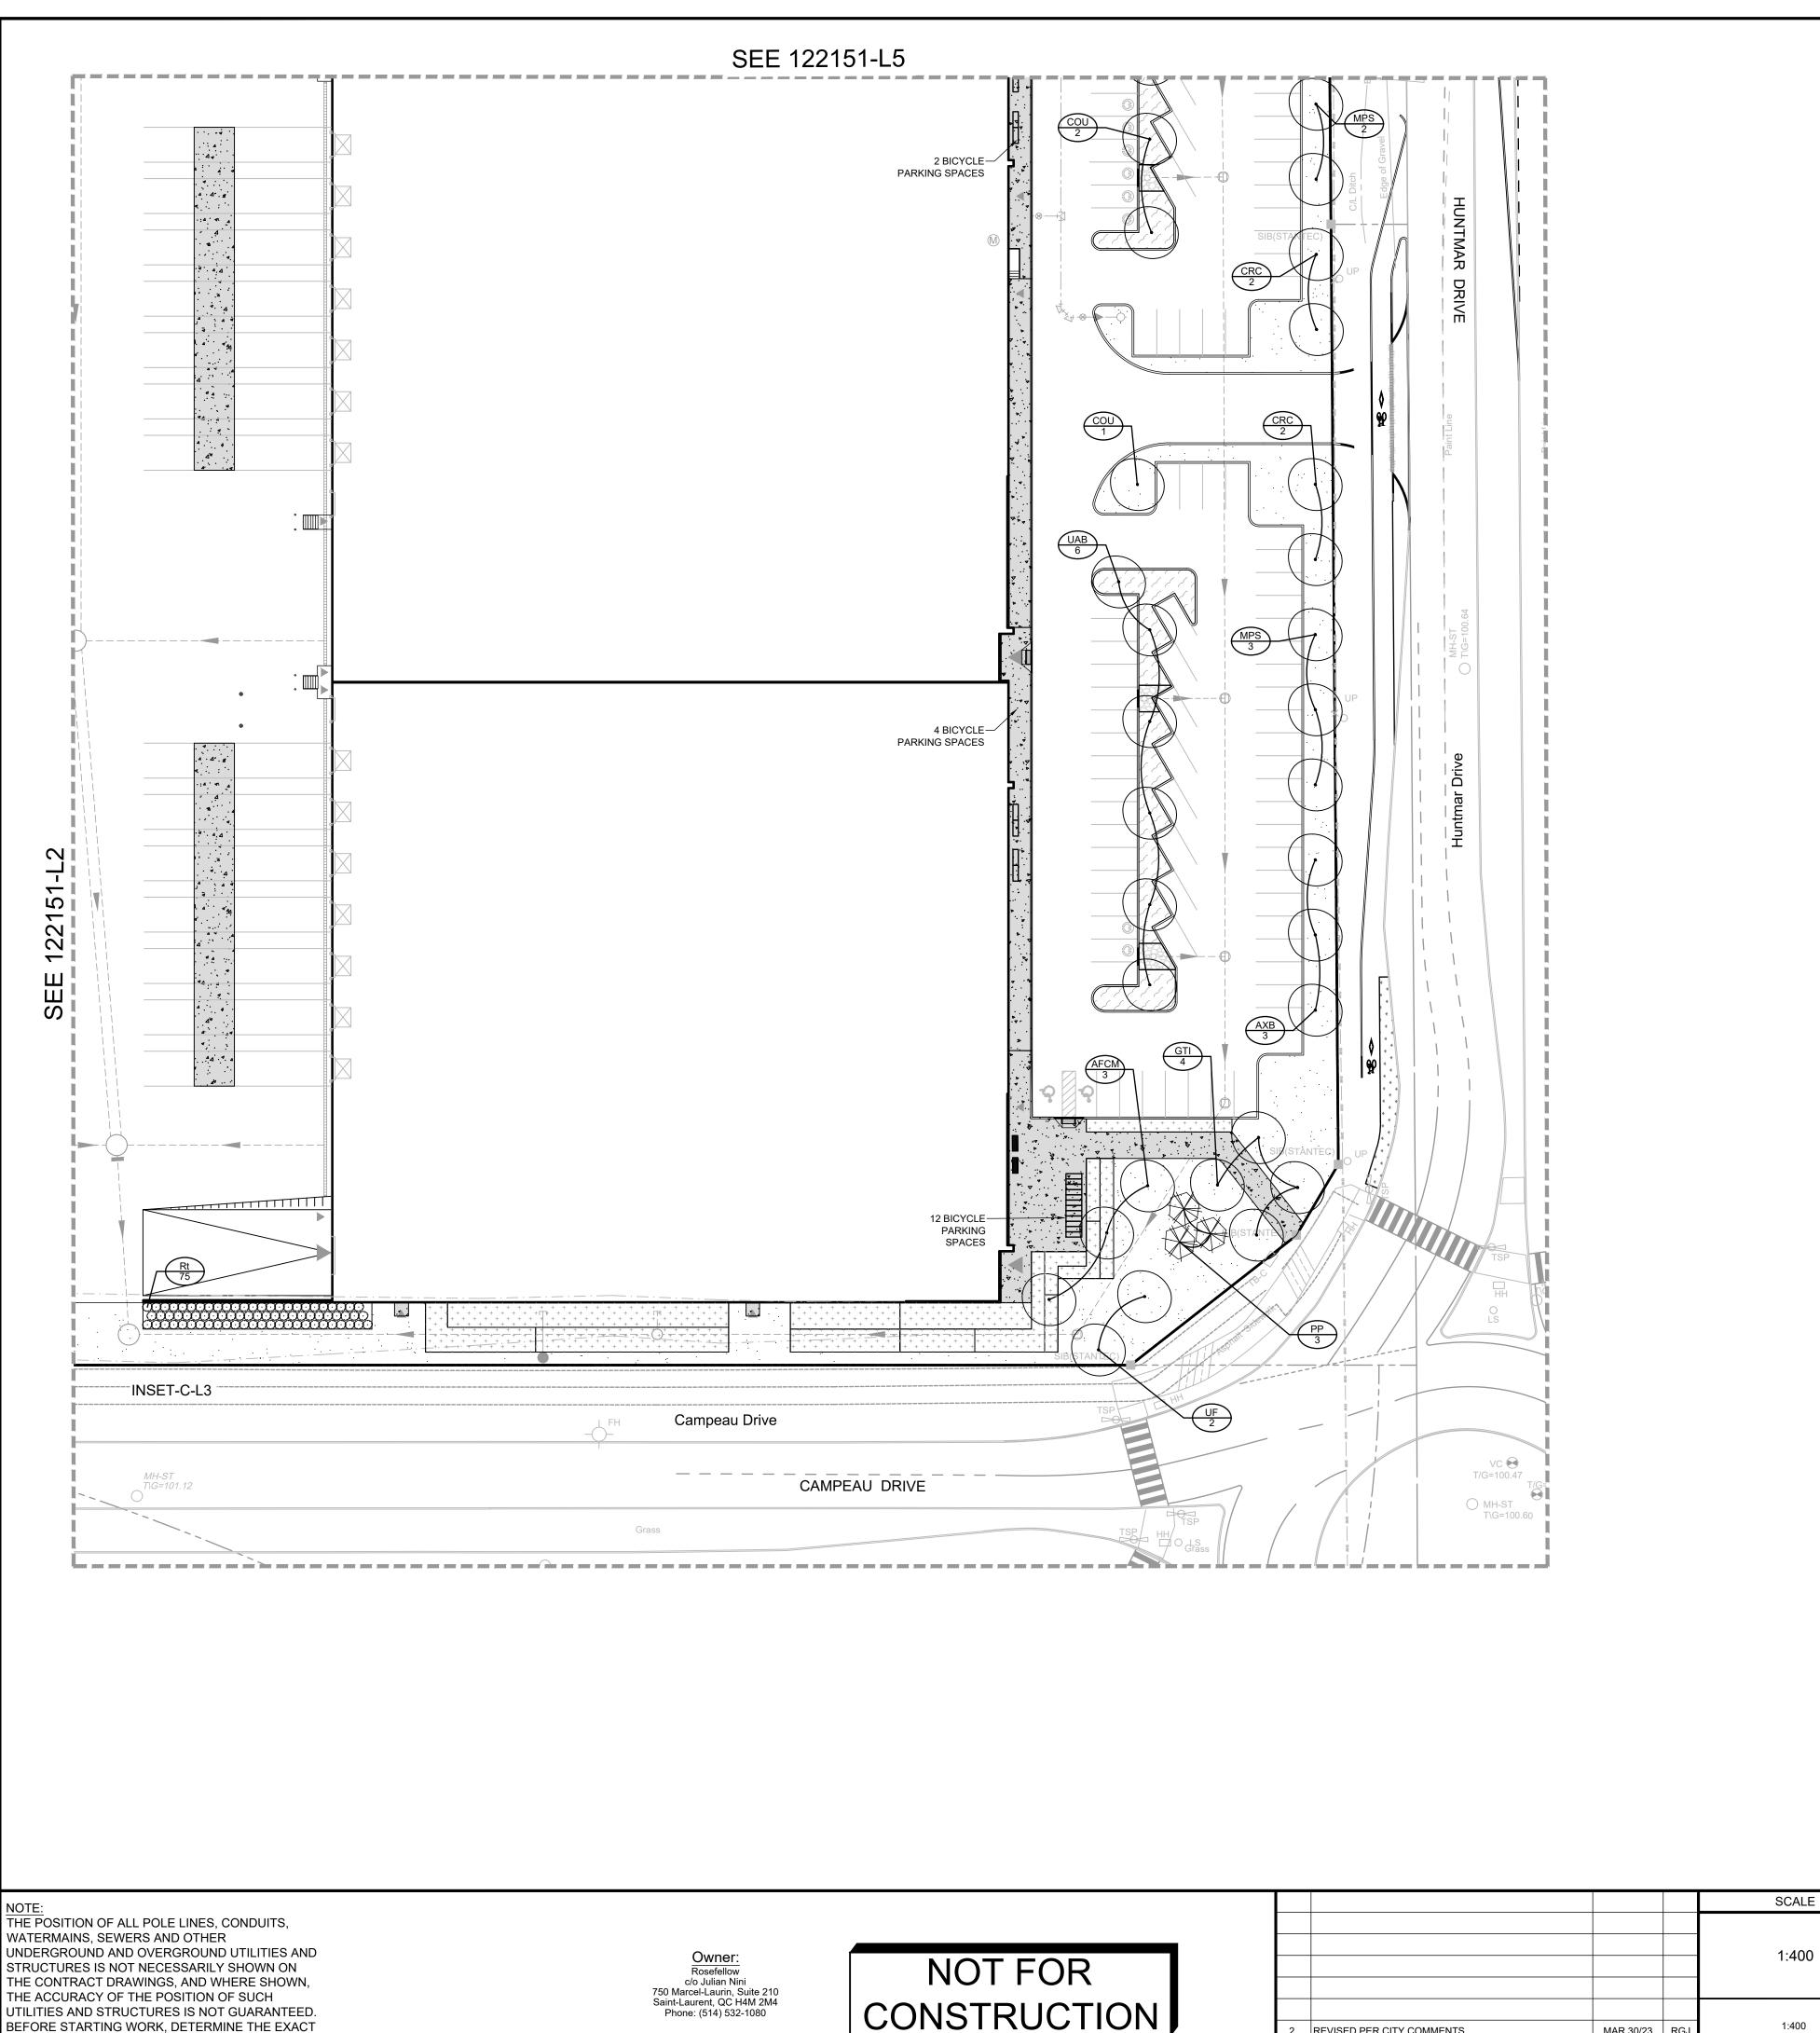

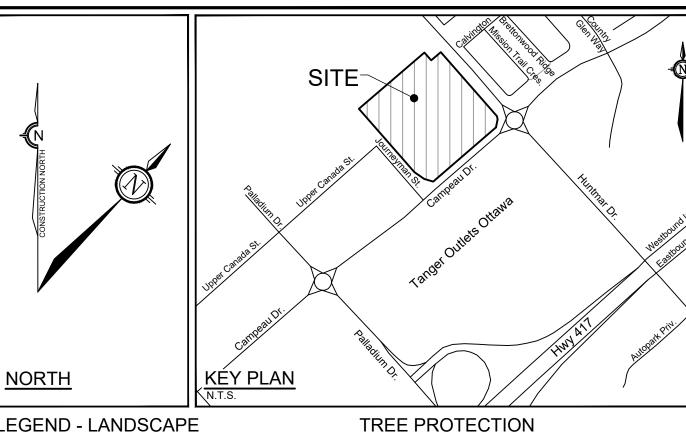

#### LEGEND - LANDSCAPE

— — — PROPERTY LIMIT

TREE PROTECTION FENCE

PROPOSED CONCRETE

RIVERSTONE

PROPOSED PLANTING BED

SEED MIX C - SEE NOTE

PROPOSED WET SHRUB MIX, REFER TO SHEET L6

PROPOSED DRY SHRUB MIX,

SEED MIX A - SEE NOTE

SEED MIX B - SEE NOTE

REFER TO SHEET L6 PROPOSED DECIDUOUS TREE

PROPOSED CONIFEROUS TREE

PROPOSED SHRUBS

EXISTING TREE TO REMAIN EXISTING HEDGEROW TO REMAIN

- SPECIES (SEE PLANT LIST)

### CITY DETAILS

Related details from City of Ottawa Standard Tender Documents Volume No. 2 Standard Detail Drawings.

SC4. Typical Concrete Sidewalk in Boulevard Sidewalk Construction Joints

### NOVATECH DETAILS

Found on Sheet L7.

- D1. Standard Deciduous Tree Planting D2. Standard Coniferous Tree Planting D3. Shrub and Perennial Planting
- D4. Tree Protection Fence D5. Bike Layout
- D6. Site furniture installation
- D7. Reforestation D8. Riverstone

### PARKING LOT - PLANT LIST

## SEED MIX AND APPLICATION

For areas steeper than 3:1, Contractor to apply erosion control blanket. Erosion control blanket to be machine woven mats made from natural wood, coco or cotton fiber, or combination depending on manufacturer, with stitching between two photo-degradable natural organic fiber nettings. Submit products for approval by Consultant. OPSS 804 applies except as may be amended and extended herein.

In addition to the specified seed mixes, all applications are to include a nurse crop as noted.

NURSE CROP 40% Oats (Avena sativa) 45% Barley (Hordeum vulgare) 15% Canada Wild Rye (Elymus canadensis) Seeding Rate: 15kg/hectare

SEED MIX C CUSTOM NATIVE PARKING ISLAND SEED MIX BY DLF Seeding Rate: 25kg/hectare

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60cm Ht PT 100cm O.0 Staghorn Sumac

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- 1. The Landscape Architect or Certified Arborist is to determine the location of the tree protection fencing and detail it on any associated plans for the site (e.g. tree conservation report,
- tree disclosure report, etc.). 2. Under the guidance of a Landscape Architect or Certified Arborist, erect a fence at the critical root zone (CRZ) of trees. Diameter at breast height (DBH) is the trunk diameter measured at 1.3m height on the tree trunk. The CRZ is calculated as DBH x 10. Refer to the Tree Protection Fence
- 3. Refer to the Tree Protection Plan for fence location. City Forestry Staff are to approve both the plan and the installed

fence prior to work commencement.

- 4. Do not place any material or equipment within 2m of the CRZ of any tree, including outhouses. 5. Do not attach any signs, notices, or posters to any tree.
- 6. Do not disturb, raise, or lower the existing grade within the CRZ without approval. 7. Only tunnel or bore when digging within the CRZ of a tree.
- Hand work only where required within the CRZ; absolutely no machinery permitted. 8. Do not damage the root system, trunk, or branches, or any
- 9. Do not extend hard surface or significantly change
- landscaping. 10. Ensure that exhaust fumes from all equipment are directed
- away from any tree canopy.
- 11. When trees marked for removal overlap with the CRZ of trees marked for preservation: cut roots at the edge of the CRZ and grind down stumps after tree removals, do not pull out stumps. Ensure there is not root pulling or disturbance of the
- ground within the CRZ. 12. Prior to work taking place, notify and consult the Landscape Architect and City Forestry Staff if roots must be cut. Roots 20mm or larger should be cut at right angles with clean, sharp horticultural tools without tearing, crushing, or pulling. Refer to
- City of Ottawa Specification S.P. F-8011 Tree Protection, Excavation of Root Zone. 13. If damaged or objectionable branches are observed, consult
- the Landscape Architect, before any work is conducted. Do not prune leaders. Do not prune more than 1/4 of crown. 14. Set up a water and fertilizing program, if trees are being affected by site works, to the satisfaction of the Landscape
- 15. The Landscape Architect is to prescribe mitigation measures construction. Measures may include the placement of
- plywood, wood chips, or steel plating over the roots for protection. City Forestry Staff are to approve said measures prior to fence movement. 16. City of Ottawa By-law: Protects municipal trees and municipal

natural areas in the City of Ottawa and trees on private

#### property in the urban area of the City of Ottawa (2020-340). PLANTING

- 1. Plant material to be No. 1 Grade and is to comply with Canadian Standards for Nursery Stock (latest edition) published by the Canadian Nursery Landscape Association.
- system free of disease, defects, and injuries. Use trees with straight trunks, well and characteristically branched for species. Obtain approval from consultant of plant material at source prior to digging. All trees and shrubs to be container grown, potted, W/B or B/B, as indicated on Plant List. Bare root plants are only acceptable for certain species and as

2. Use structurally sound plant material with strong fibrous root

- approved by the Landscape Architect. 3. Plant material substitutions are not be permitted without the written approval from the Consultant, with 48 hours notice, prior to shipping plant material.
- 4. Plant locations are schematic / approximate only. **Contractor** is to stake out locations on site for approval by the Landscape Architect prior to installation.
- 5. The illustrated number of plants shown in the Planting Plan supersedes the estimated number in the Plant List. Contractor to report any discrepancies to the Landscape Architect prior to installation. Contractor will assume full
- responsibility if the Landscape Architect is not notified. 6. Ensure trees are thoroughly watered following planting. Monitor material and ensure adequate moisture until acceptance.
- 7. In heavy clay or poorly drained soils, set root ball with root collar 75-100mm higher than finished grade.
- Approved topsoil depths are as follows: a. Plant Beds - **450mm** continuous depth. Applies to shrubs, perennials, vines, and groundcovers.
- b. Sod/ Seed Areas 100mm depth. Sod to be No. 1 Kentucky Bluegrass Sod grown from minimum mixture of 3 Kentucky Bluegrass cultivars. Quality and source are to comply with Canadian Standards for Nursery Stock, Section 17, (latest edition) published by the Canadian Nursery Landscape Nursery Landscape
- Association 10. Apply the following mineral fertilizer unless soil tests show other requirements: a. Plant Beds - (8-32-16), i.e. 8% Nitrogen, 32%
- Phosphorus, 16% Potash per manufacturer specifications. b. Sod Areas - (8-32-16), i.e. 8% Nitrogen, 32% Phosphorus, 16% Potash at a rate of 350kg/ha.
- 11. Where applicable, for any plant areas with a mix of species/ cultivars notes, Contractor is to cluster like plants in groups of 3-5 and evenly distribute these in the noted area.

Deciduous Shrubs Rt 75 Rhus typhina

**FOR REVIEW ONLY** 

Engineers, Planners & Landscape Architect Suite 200, 240 Michael Cowpland Drive Ottawa, Ontario, Canada K2M 1P6

Facsimile

LOCATION CITY of OTTAWA 105 HUNTMAR DRIVE - WAREHOUSE DEVELOPMENT

DRAWING NAME LANDSCAPE PLAN

122151 REV#2 122151-L3


LOCATION OF ALL SUCH UTILITIES AND


DAMAGE TO THEM.

STRUCTURES AND ASSUME ALL LIABILITY FOR

CONSTRUCTION

1:400 REVISED PER CITY COMMENTS MAR 30/23 ISSUED FOR CITY OF OTTAWA REVIEW DEC 16/22 DATE REVISION

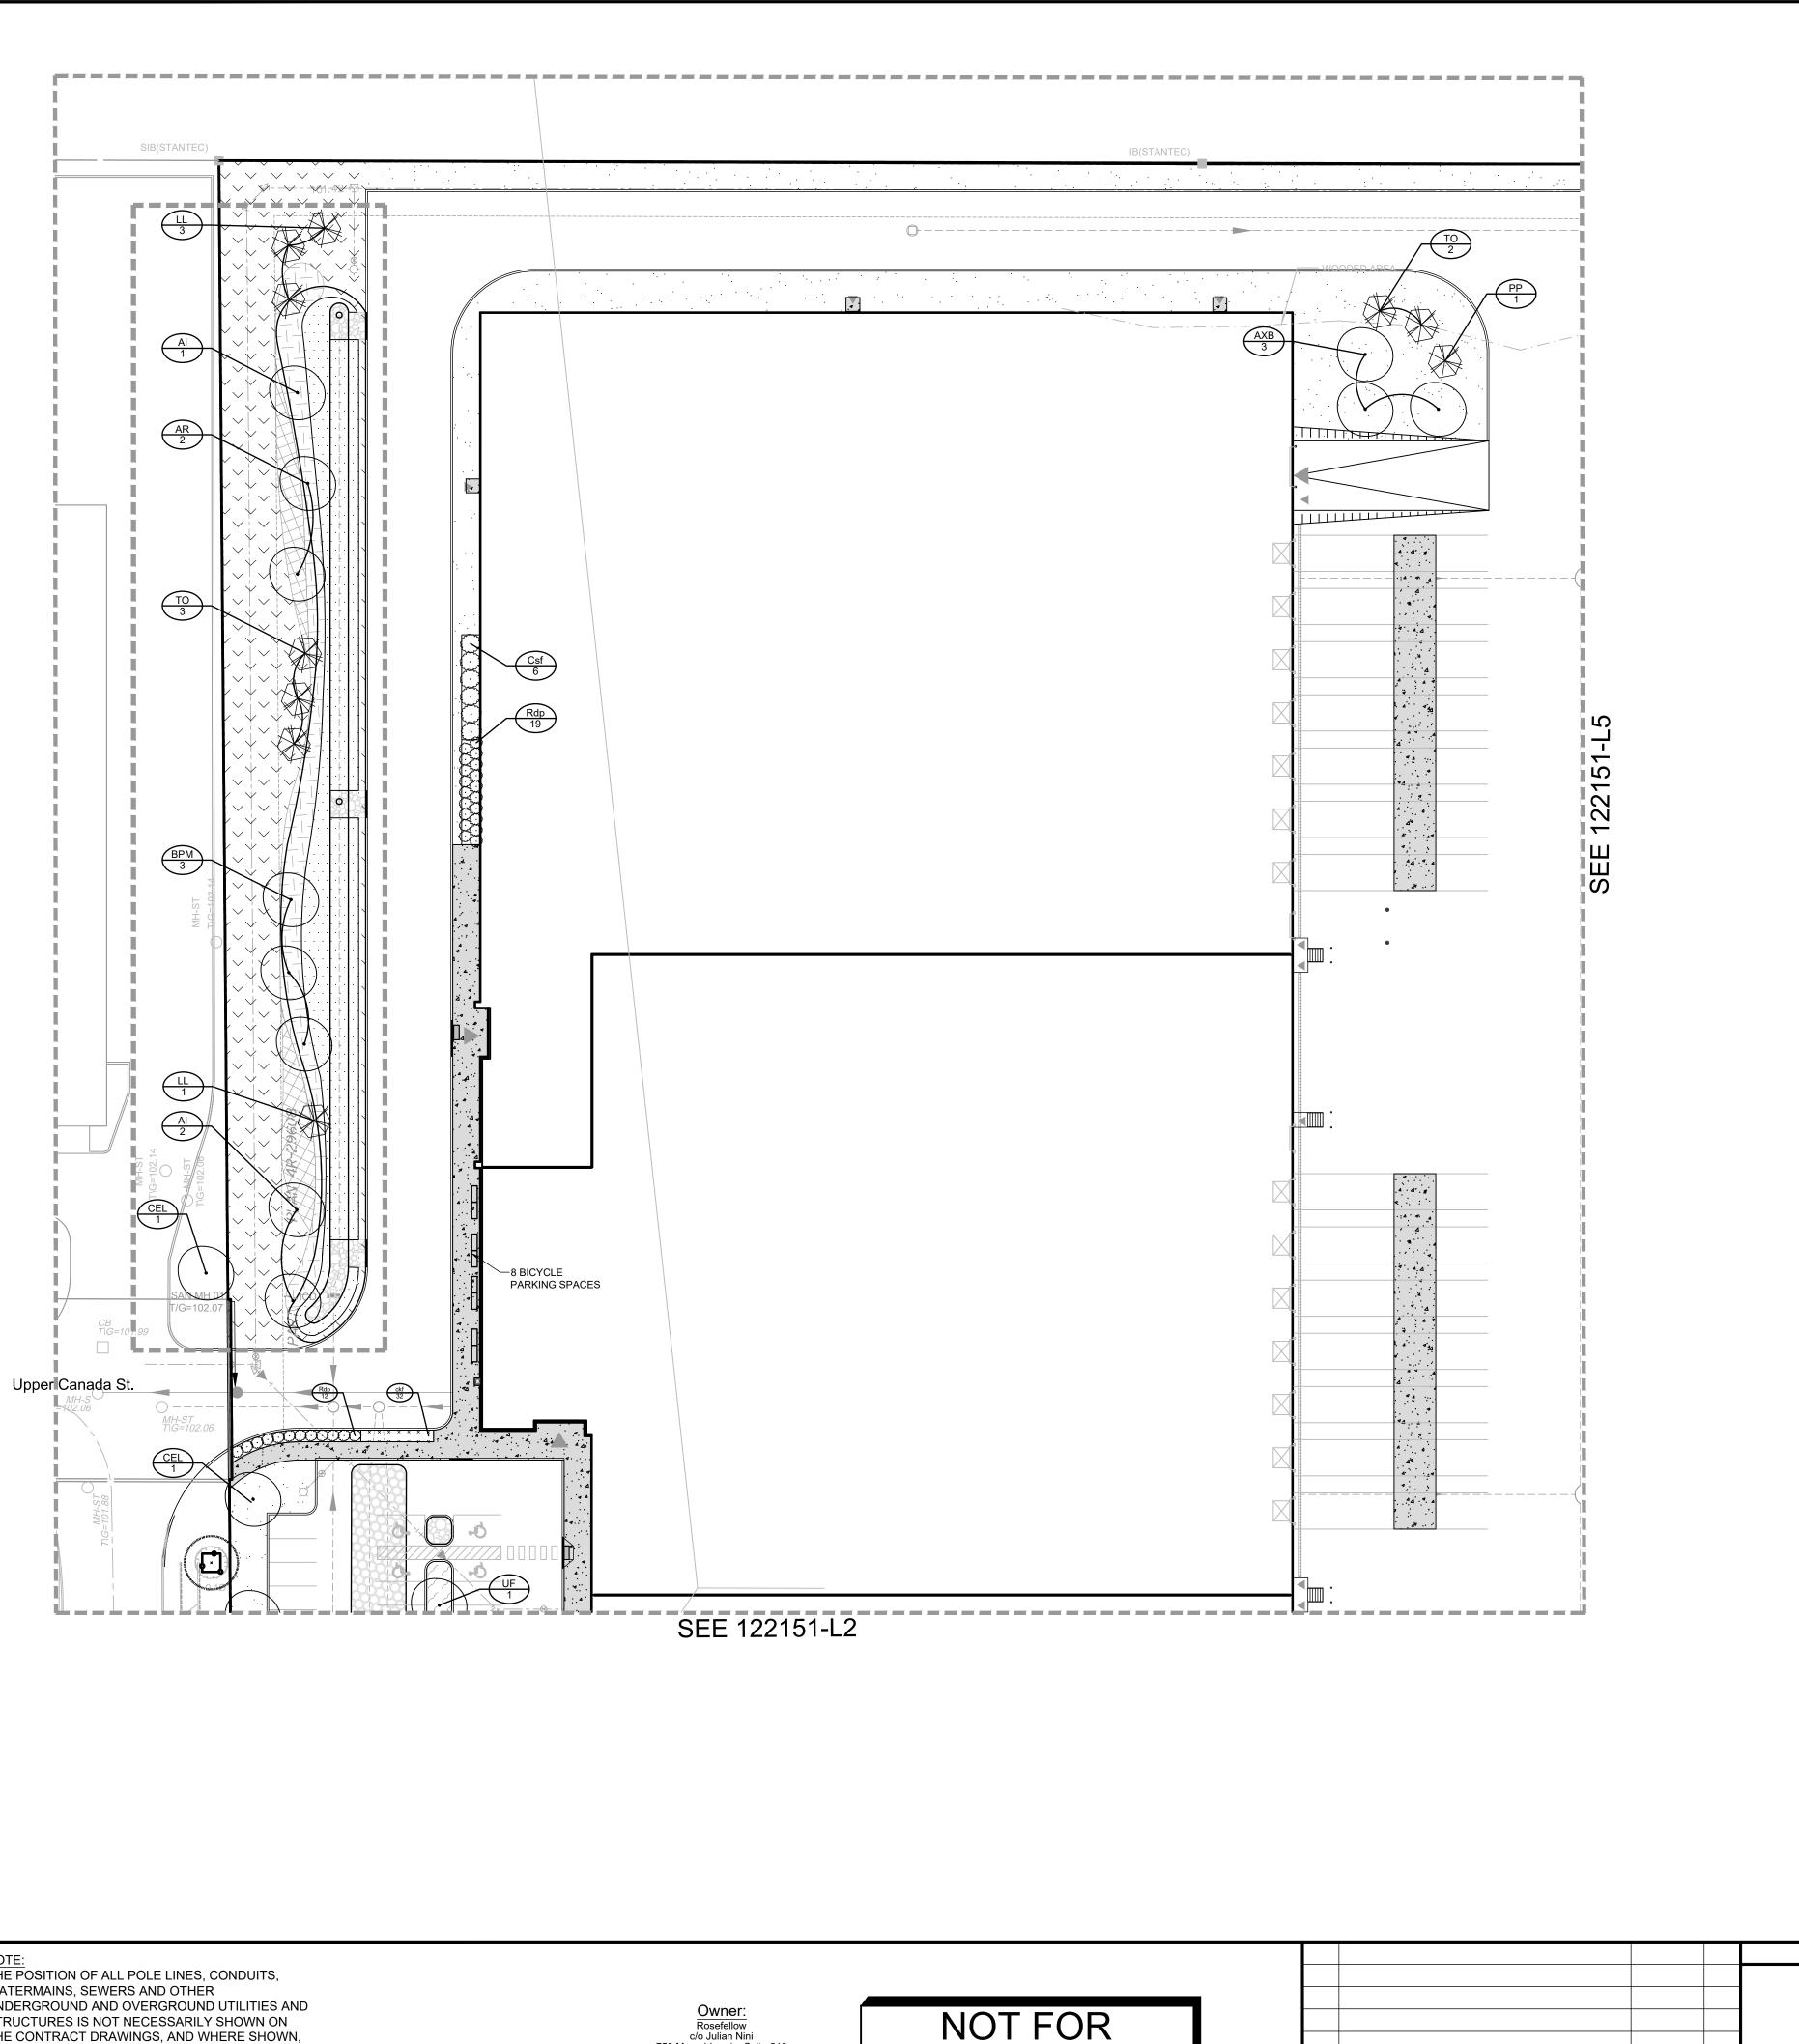

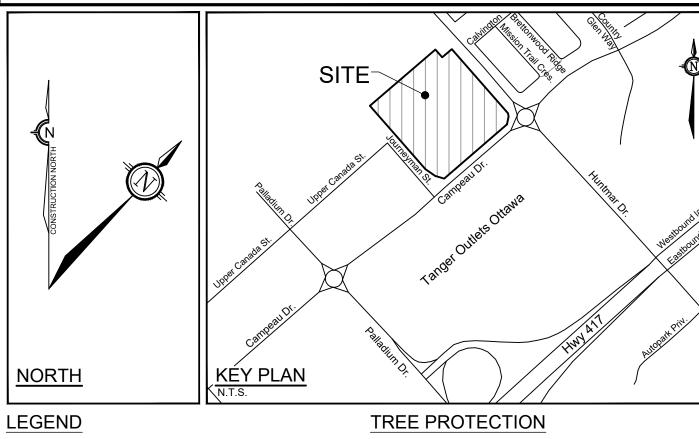

— — — PROPERTY LIMIT

TREE PROTECTION FENCE

PROPOSED CONCRETE

RIVERSTONE

PROPOSED PLANTING BED

SEED MIX A - SEE NOTE

SEED MIX B - SEE NOTE

PROPOSED WET SHRUB MIX, REFER TO SHEET L6

PROPOSED DRY SHRUB MIX,

REFER TO SHEET L6

SEED MIX C - SEE NOTE

PROPOSED DECIDUOUS TREE

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SEED MIX AND APPLICATION

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on manufacturer, with stitching between two photo-degradable

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CUSTOM NATIVE PARKING ISLAND SEED MIX BY DLF

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15% Canada Wild Rye (Elymus canadensis)

Consultant. OPSS 804 applies except as may be amended and

blanket. Erosion control blanket to be machine woven mats made

- SPECIES (SEE PLANT LIST)

extended herein.

include a nurse crop as noted.

40% Oats (Avena sativa)

45% Barley (Hordeum vulgare)

Seeding Rate: 15kg/hectare

Seeding Rate: 25kg/hectare

NURSE CROP

SEED MIX C

## CITY DETAILS

Related details from City of Ottawa Standard Tender Documents Volume No. 2 Standard Detail Drawings.

SC4. Typical Concrete Sidewalk in Boulevard SC5. Sidewalk Construction Joints

## NOVATECH DETAILS

Found on Sheet L7.

D8. Riverstone

- D1. Standard Deciduous Tree Planting D2. Standard Coniferous Tree Planting D3. Shrub and Perennial Planting
- D4. Tree Protection Fence D5. Bike Layout D6. Site furniture installation D7. Reforestation

# PARKING LOT - PLANT LIST

eciduous Shrubs			
Csf	6	Cornus sericea 'Flaviramea'	Yellow Twig Dogwood
Rdp	31	Rosa 'Dwarf Pavement'	Dwarf Pavement Rose
rnamental Grasses			
ckf	32	Calamagrostis acutiflora 'Karl Foerster'	Karl Foerster Feather Reed Grass

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- 6. Do not disturb, raise, or lower the existing grade within the CRZ without approval. 7. Only tunnel or bore when digging within the CRZ of a tree.
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- 14. Set up a water and fertilizing program, if trees are being affected by site works, to the satisfaction of the Landscape
- 15. The Landscape Architect is to prescribe mitigation measures construction. Measures may include the placement of plywood, wood chips, or steel plating over the roots for protection. City Forestry Staff are to approve said measures
- prior to fence movement. 16. City of Ottawa By-law: Protects municipal trees and municipal natural areas in the City of Ottawa and trees on private property in the urban area of the City of Ottawa (2020-340).

## PLANTING

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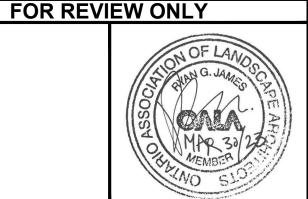
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750 Marcel-Laurin, Suite 210 Saint-Laurent, QC H4M 2M4 Phone: (514) 532-1080

NOT FOR CONSTRUCTION

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1.	ISSUED FOR CITY OF OTTAWA REVIEW	DEC 16/22	RGJ		APPROVED	1
No.	REVISION	DATE	BY		RGJ	J





Facsimile

CITY of OTTAWA DRAWING NAME

60cm Ht PT 200cm O.


60cm Ht PT 120cm O

1g PT 60cm O.C

LOCATION

105 HUNTMAR DRIVE - WAREHOUSE DEVELOPMENT LANDSCAPE PLAN 122151

REV#2 122151-L4

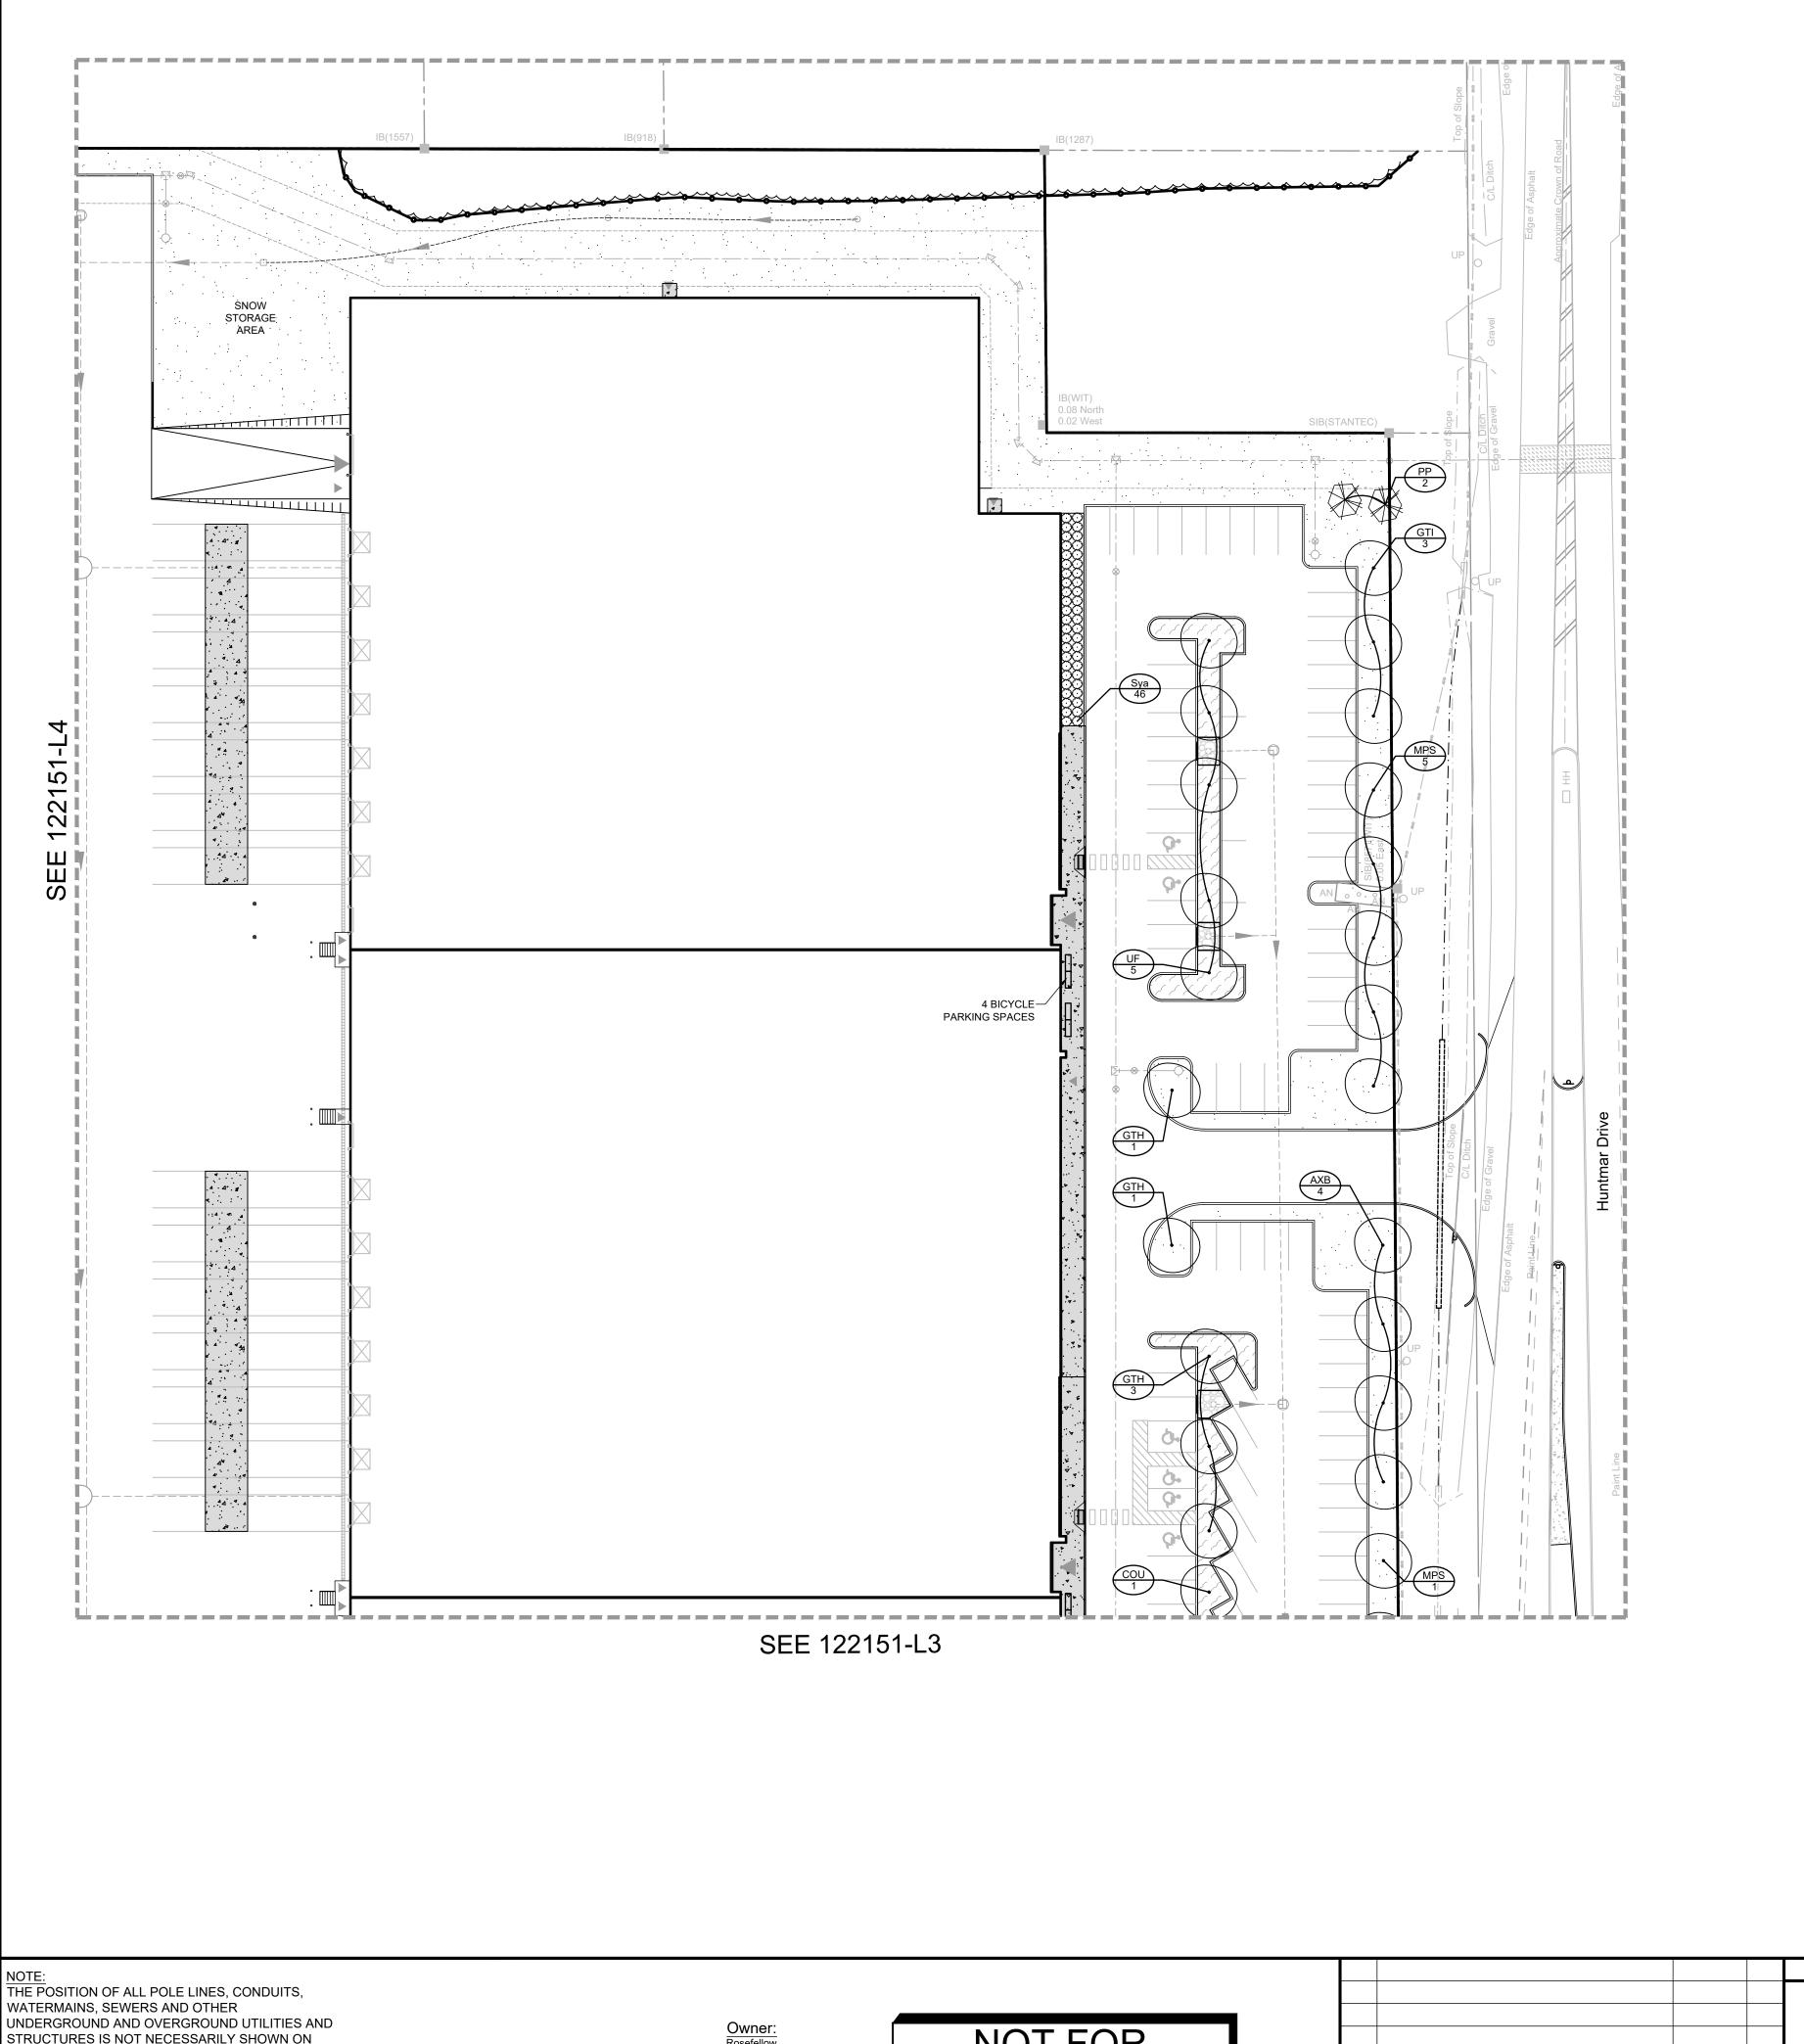

c/o Julian Nini

750 Marcel-Laurin, Suite 210 Saint-Laurent, QC H4M 2M4 Phone: (514) 532-1080

THE CONTRACT DRAWINGS, AND WHERE SHOWN.


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THE ACCURACY OF THE POSITION OF SUCH

LOCATION OF ALL SUCH UTILITIES AND

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1. The Landscape Architect or Certified Arborist is to determine

2. Under the guidance of a Landscape Architect or Certified

3. Refer to the Tree Protection Plan for fence location. City Forestry Staff are to approve both the plan and the installed
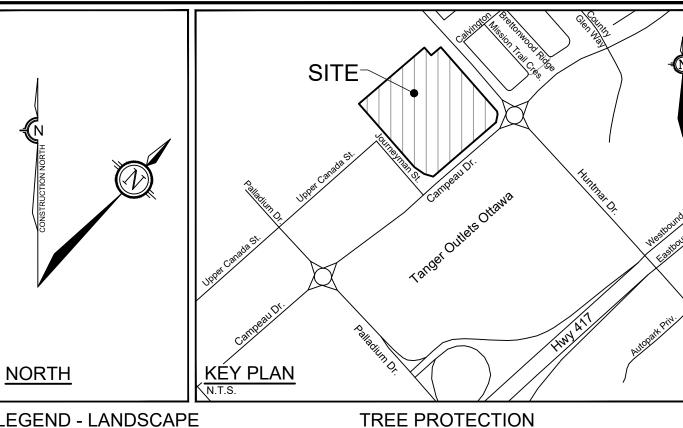
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In heavy clay or poorly drained soils, set root ball with root

a. Plant Beds - **450mm** continuous depth. Applies to

minimum mixture of 3 Kentucky Bluegrass cultivars. Quality

Nursery Stock, Section 17, (latest edition) published by the

and source are to comply with Canadian Standards for

Canadian Nursery Landscape Nursery Landscape

sod is not typically graphically shown on plans.

Phosphorus, 16% Potash at a rate of 350kg/ha.

10. Install a 1.2m sod strip adjacent to all hard surfaces. Note,

Apply the following mineral fertilizer unless soil tests show

a. Plant Beds - (8-32-16), i.e. 8% Nitrogen, 32% Phosphorus, 16% Potash per manufacturer specifications. b. Sod Areas - (8-32-16), i.e. 8% Nitrogen, 32%

Ensure trees are thoroughly watered following planting.

Monitor material and ensure adequate moisture until

5. The illustrated number of plants shown in the Planting Plan supersedes the estimated number in the Plant List. Contractor to report any discrepancies to the Landscape

natural areas in the City of Ottawa and trees on private property in the urban area of the City of Ottawa (2020-340).

1. Plant material to be No. 1 Grade and is to comply with Canadian Standards for Nursery Stock (latest edition)

approved by the Landscape Architect.

Landscape Architect prior to installation.

collar 75-100mm higher than finished grade.

shrubs, perennials, vines, and groundcovers.

9. Sod to be No. 1 Kentucky Bluegrass Sod grown from

b. Sod/ Seed Areas - 100mm depth.

Approved topsoil depths are as follows:

prior to shipping plant material.

acceptance.

Association.

other requirements:

marked for preservation: cut roots at the edge of the CRZ and grind down stumps after tree removals, do not pull out stumps. Ensure there is not root pulling or disturbance of the

horticultural tools without tearing, crushing, or pulling. Refer to

9. Do not extend hard surface or significantly change

4. Do not place any material or equipment within 2m of the CRZ

the location of the tree protection fencing and detail it on any associated plans for the site (e.g. tree conservation report,

Arborist, erect a fence at the critical root zone (CRZ) of trees. Diameter at breast height (DBH) is the trunk diameter measured at 1.3m height on the tree trunk. The CRZ is

calculated as DBH x 10. Refer to the Tree Protection Fence

both on site and on adjacent sites, prior to any work activity, including tree removal. Maintain tree protection fence in place and

in good condition for the duration of site works:

fence prior to work commencement.

of any tree, including outhouses.

CRZ without approval.

machinery permitted.

away from any tree canopy.

ground within the CRZ.

Excavation of Root Zone.

prior to fence movement.

PLANTING

landscaping.

tree disclosure report, etc.).

#### LEGEND - LANDSCAPE

DETAIL SHEET # NOVATECH OR CITY
EG. L<u>1</u>, L<u>2</u>, ETC. DETAIL NUMBER SEE LIST
FOR CODE

— — — PROPERTY LIMIT

TREE PROTECTION FENCE

PROPOSED CONCRETE

RIVERSTONE

PROPOSED PLANTING BED

SEED MIX A - SEE NOTE

SEED MIX B - SEE NOTE

SEED MIX C - SEE NOTE

PROPOSED WET SHRUB MIX, REFER TO SHEET L6

PROPOSED DRY SHRUB MIX, REFER TO SHEET L6

PROPOSED DECIDUOUS TREE

PROPOSED CONIFEROUS TREE

PROPOSED SHRUBS

EXISTING TREE TO REMAIN

EXISTING HEDGEROW TO REMAIN

SEED MIX AND APPLICATION

For areas steeper than 3:1, Contractor to apply erosion control

on manufacturer, with stitching between two photo-degradable

natural organic fiber nettings. Submit products for approval by

In addition to the specified seed mixes, all applications are to

15% Canada Wild Rye (Elymus canadensis)

Consultant. OPSS 804 applies except as may be amended and

CUSTOM NATIVE PARKING ISLAND SEED MIX BY DLF

(613) 254-5867

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blanket. Erosion control blanket to be machine woven mats made

from natural wood, coco or cotton fiber, or combination depending

- SPECIES (SEE PLANT LIST)

extended herein.

include a nurse crop as noted.

40% Oats (Avena sativa)

45% Barley (Hordeum vulgare)

Seeding Rate: 15kg/hectare

Seeding Rate: 25kg/hectare

NURSE CROP

SEED MIX C

## CITY DETAILS

Related details from City of Ottawa Standard Tender Documents Volume No. 2 Standard Detail Drawings.

Typical Concrete Sidewalk in Boulevard SC5. Sidewalk Construction Joints

## NOVATECH DETAILS

Found on Sheet L7.

- D1. Standard Deciduous Tree Planting D2. Standard Coniferous Tree Planting
- D3. Shrub and Perennial Planting D4. Tree Protection Fence
- D5. Bike Layout
- D6. Site furniture installation D7. Reforestation
- D8. Riverstone

## PARKING LOT - PLANT LIST

Deciduous Shrubs Sya 46 Symphoricarpos albus

> FOR REVIEW ONLY Suite 200, 240 Michael Cowpland Drive Ottawa, Ontario, Canada K2M 1P6 (613) 254-9643

Facsimile

Snowberry

# Engineers, Planners & Landscape Architect

LOCATION CITY of OTTAWA

12. Where applicable, for any plant areas with a mix of species/ cultivars notes, Contractor is to cluster like plants in groups of 50cm Ht PT 90cm O.C 3-5 and evenly distribute these in the noted area.


DRAWING NAME LANDSCAPE PLAN


105 HUNTMAR DRIVE - WAREHOUSE DEVELOPMENT 🦰 122151 REV#2

NOT FOR CONSTRUCTION

SCALE 1:400 REVISED PER CITY COMMENTS MAR 30/23 ISSUED FOR CITY OF OTTAWA REVIEW DEC 16/22 DATE REVISION

122151-L5 #18906

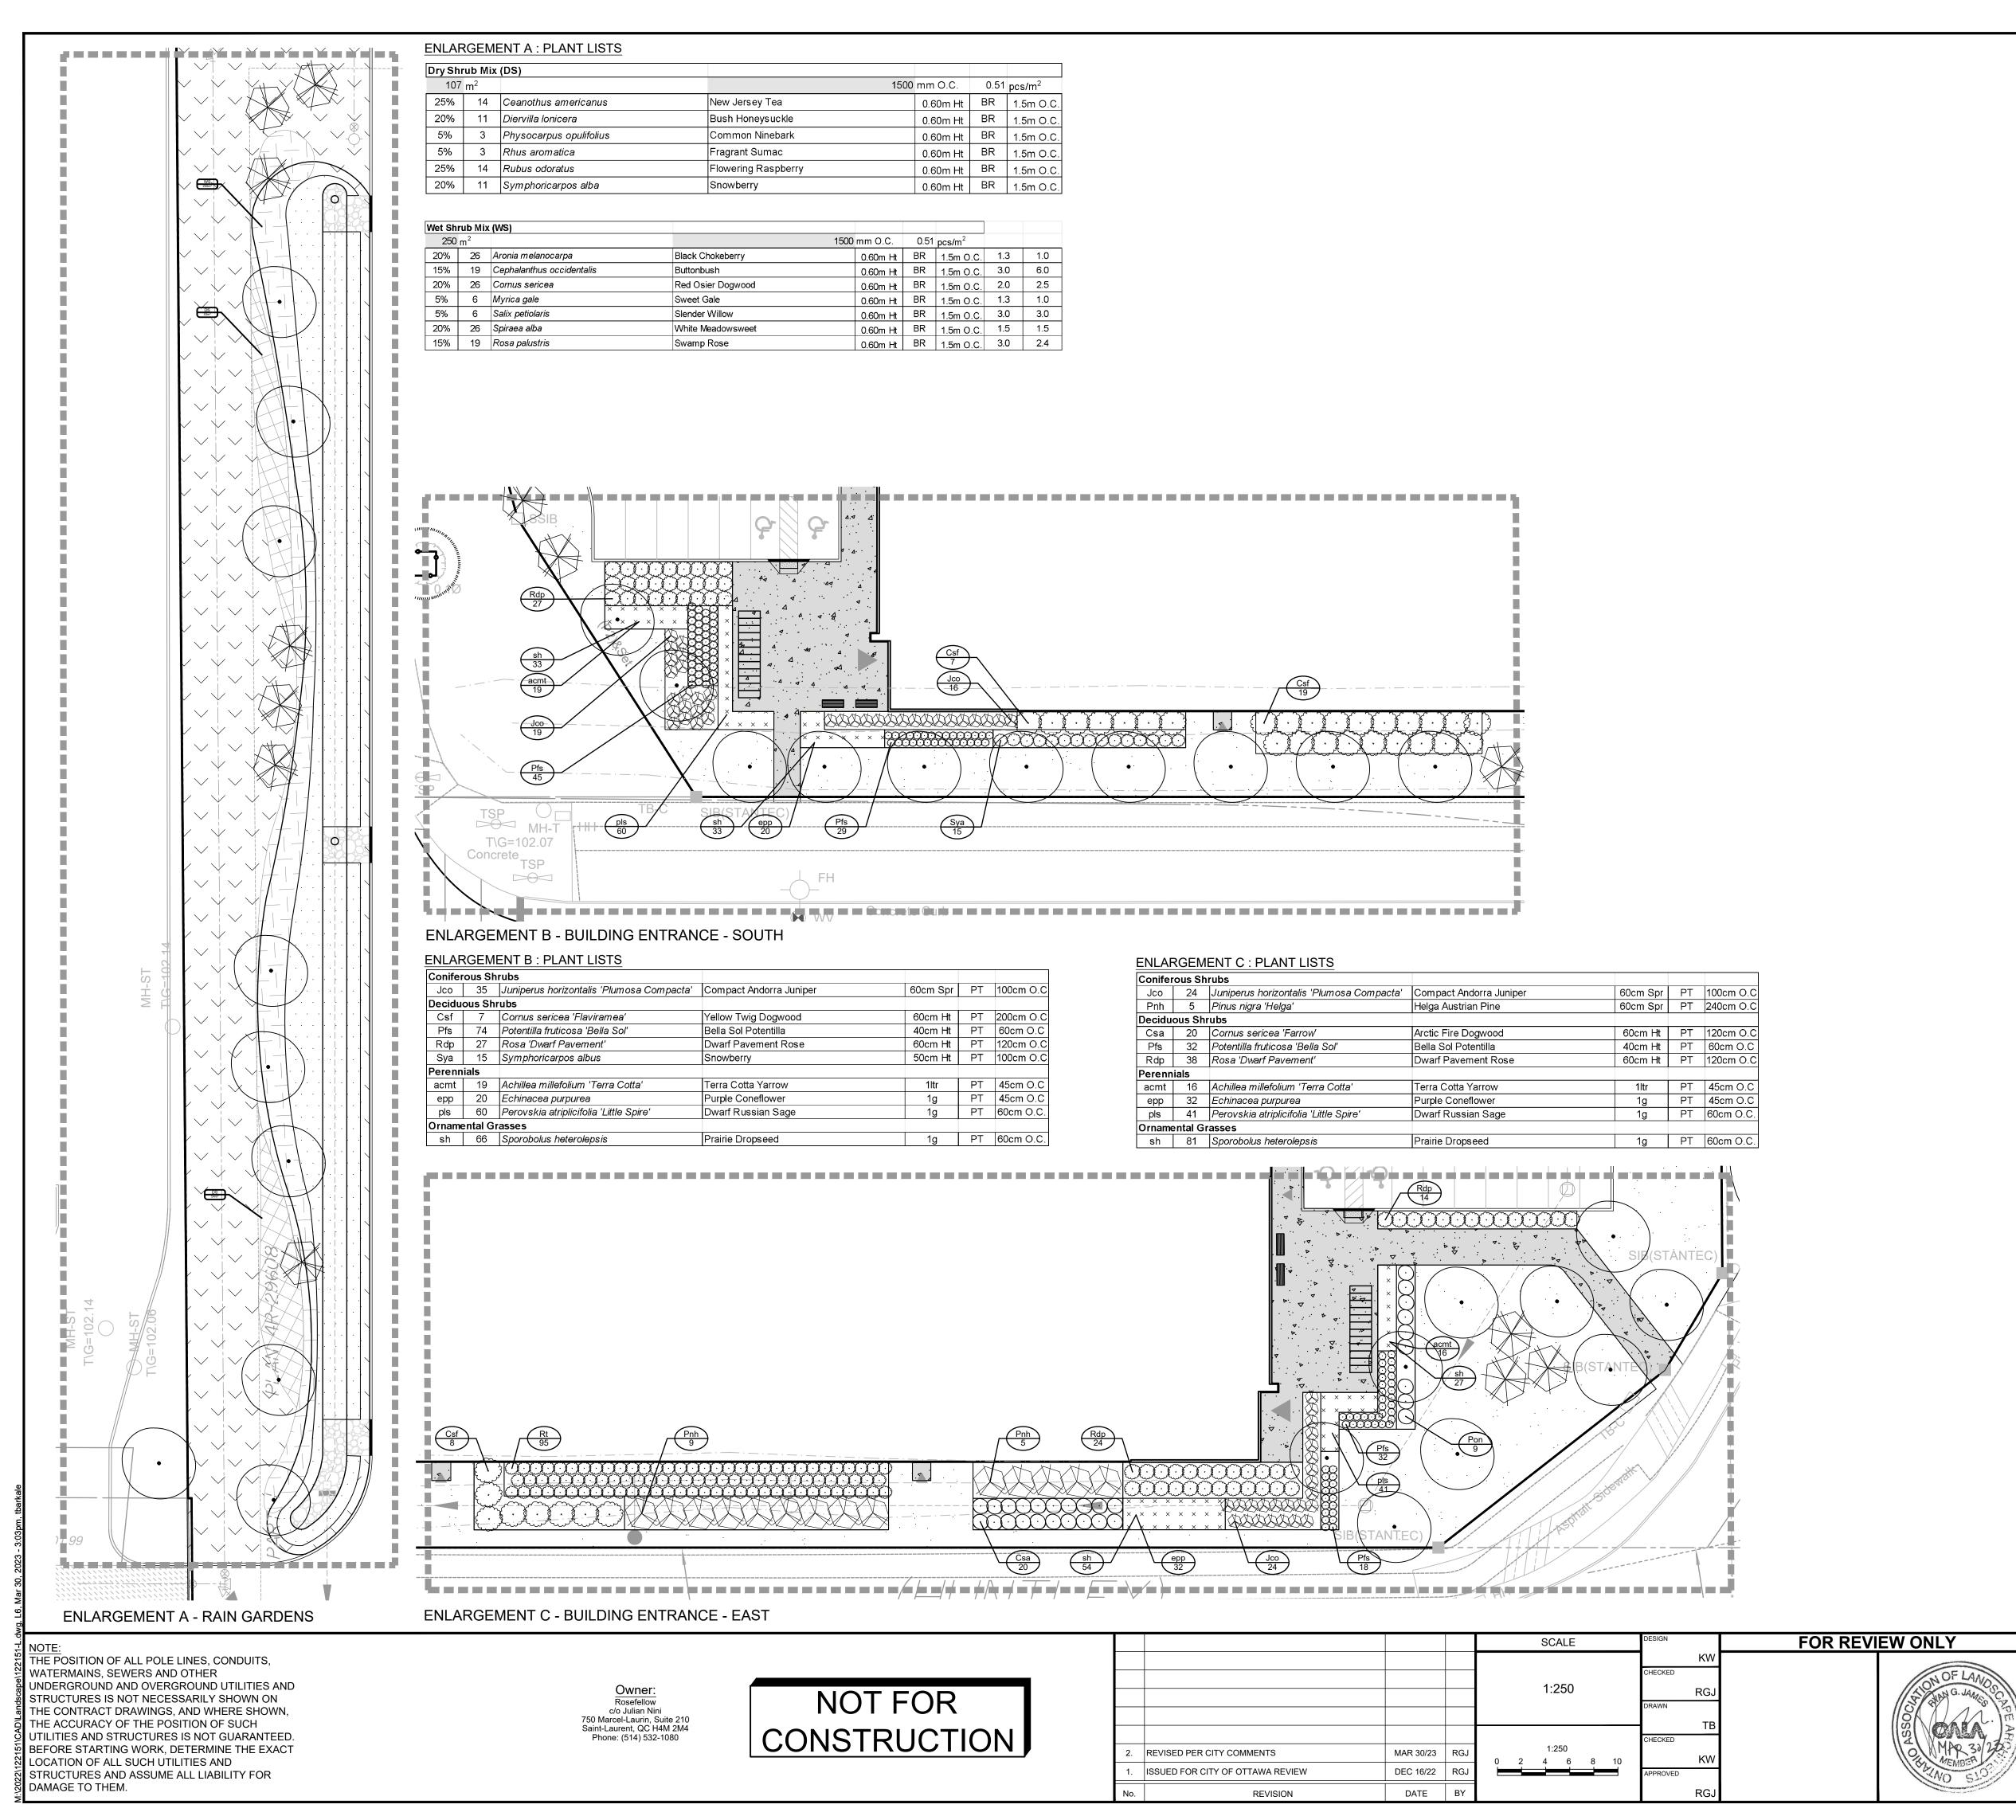

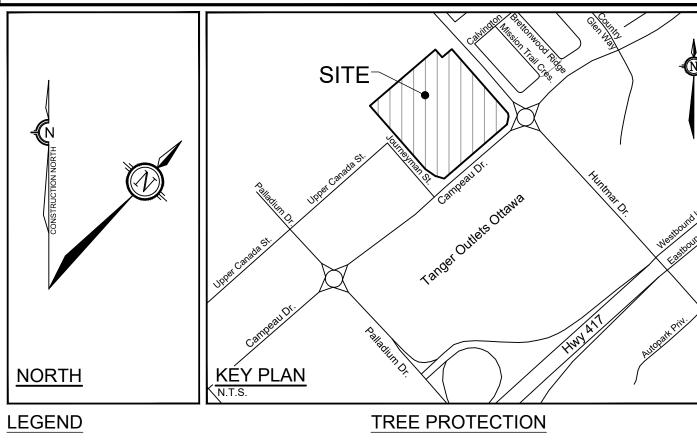

— PROPERTY LIMIT

PROPOSED CONCRETE

PROPOSED RIVER STONE

SOD

SEED MIX B

SEED MIX A

PROPOSED DRY SHRUB MIX

PROPOSED WET SHRUB MIX

PROPOSED DECIDUOUS TREE

PROPOSED CONIFEROUS TREE

PROPOSED SHRUBS

##

- NATURALIZATION

### CITY DETAILS

Related details from City of Ottawa Standard Tender Documents Volume No. 2 Standard Detail Drawings.

Typical Concrete Sidewalk in Boulevard Sidewalk Construction Joints

## NOVATECH DETAILS

Found on Sheet L7.

- D1. Standard Deciduous Tree Planting D2. Standard Coniferous Tree Planting
- D3. Shrub and Perennial Planting D4. Tree Protection Fence D5. Bike Layout
- D6. Site furniture installation D7. Reforestation D8. Riverstone

### SEED MIX AND APPLICATION

For areas steeper than 3:1, Contractor to apply erosion control blanket. Erosion control blanket to be machine woven mats made from natural wood, coco or cotton fiber, or combination depending on manufacturer, with stitching between two photo-degradable natural organic fiber nettings. Submit products for approval by Consultant. OPSS 804 applies except as may be amended and extended herein.

In addition to the specified seed mixes, all applications are to include a nurse crop as noted.

NURSE CROP 40% Oats (Avena sativa) 45% Barley (Hordeum vulgare) 15% Canada Wild Rye (Elymus canadensis) Seeding Rate: 15kg/hectare

SEED MIX A RETENTION AREA BY DLF Seeding Rate: 25kg/hectare

SEED MIX B CUSTOM GREENFIELD MIX (230314) BY DLF Seeding Rate: 25kg/hectare

Engineers, Planners & Landscape Architect

Suite 200, 240 Michael Cowpland Drive

Ottawa, Ontario, Canada K2M 1P6

DETAIL SHEET # SOVATECH OR CITY Implement the following protection measures for retained trees both on site and on adjacent sites, prior to any work activity, including tree removal. Maintain tree protection fence in place Implement the following protection measures for retained trees, including tree removal. Maintain tree protection fence in place and in good condition for the duration of site works:

- 1. The Landscape Architect or Certified Arborist is to determine the location of the tree protection fencing and detail it on any associated plans for the site (e.g. tree conservation report,
- tree disclosure report, etc.). 2. Under the guidance of a Landscape Architect or Certified Arborist, erect a fence at the critical root zone (CRZ) of trees. Diameter at breast height (DBH) is the trunk diameter measured at 1.3m height on the tree trunk. The CRZ is
- calculated as DBH x 10. Refer to the Tree Protection Fence 3. Refer to the Tree Protection Plan for fence location. City Forestry Staff are to approve both the plan and the installed
- fence prior to work commencement. 4. Do not place any material or equipment within 2m of the CRZ of any tree, including outhouses.
- 5. Do not attach any signs, notices, or posters to any tree. 6. Do not disturb, raise, or lower the existing grade within the CRZ without approval.
- 7. Only tunnel or bore when digging within the CRZ of a tree. Hand work only where required within the CRZ; absolutely no machinery permitted.
- 8. Do not damage the root system, trunk, or branches, or any
- 9. Do not extend hard surface or significantly change
- landscaping.
- 10. Ensure that exhaust fumes from all equipment are directed away from any tree canopy. 11. When trees marked for removal overlap with the CRZ of trees
- marked for preservation: cut roots at the edge of the CRZ and grind down stumps after tree removals, do not pull out stumps. Ensure there is not root pulling or disturbance of the ground within the CRZ.
- 12. Prior to work taking place, notify and consult the Landscape Architect and City Forestry Staff if roots must be cut. Roots 20mm or larger should be cut at right angles with clean, sharp horticultural tools without tearing, crushing, or pulling. Refer to City of Ottawa Specification S.P. F-8011 Tree Protection,
- Excavation of Root Zone. 13. If damaged or objectionable branches are observed, consult the Landscape Architect, before any work is conducted. Do
- not prune leaders. Do not prune more than 1/4 of crown. 14. Set up a water and fertilizing program, if trees are being affected by site works, to the satisfaction of the Landscape
- 15. The Landscape Architect is to prescribe mitigation measures construction. Measures may include the placement of plywood, wood chips, or steel plating over the roots for protection. City Forestry Staff are to approve said measures
- prior to fence movement. 16. City of Ottawa By-law: Protects municipal trees and municipal natural areas in the City of Ottawa and trees on private property in the urban area of the City of Ottawa (2020-340).

### PLANTING

1. Plant material to be No. 1 Grade and is to comply with Canadian Standards for Nursery Stock (latest edition)

- published by the Canadian Nursery Landscape Association Use structurally sound plant material with strong fibrous root system free of disease, defects, and injuries. Use trees with straight trunks, well and characteristically branched for species. Obtain approval from consultant of plant material at source prior to digging. All trees and shrubs to be container grown, potted, W/B or B/B, as indicated on Plant List. Bare
- root plants are only acceptable for certain species and as approved by the Landscape Architect. 3. Plant material substitutions are not be permitted without the written approval from the Consultant, with 48 hours notice,
- prior to shipping plant material. 4. Plant locations are schematic / approximate only. Contractor is to stake out locations on site for approval by the
- Landscape Architect prior to installation. 5. The illustrated number of plants shown in the Planting Plan supersedes the estimated number in the Plant List. Contractor to report any discrepancies to the Landscape
- Architect prior to installation. Contractor will assume full responsibility if the Landscape Architect is not notified. Ensure trees are thoroughly watered following planting. Monitor material and ensure adequate moisture until
- In heavy clay or poorly drained soils, set root ball with root collar 75-100mm higher than finished grade. Approved topsoil depths are as follows:
- a. Plant Beds **450mm** continuous depth. Applies to shrubs, perennials, vines, and groundcovers. b. Sod/ Seed Areas - 100mm depth. c. Reforestation - 300mm depth.
- Sod to be No. 1 Kentucky Bluegrass Sod grown from minimum mixture of 3 Kentucky Bluegrass cultivars. Quality and source are to comply with Canadian Standards for Nursery Stock, Section 17, (latest edition) published by the
- Canadian Nursery Landscape Nursery Landscape Association. 10. Apply the following mineral fertilizer unless soil tests show
- other requirements: a. Plant Beds - (8-32-16), i.e. 8% Nitrogen, 32% Phosphorus, 16% Potash per manufacturer specifications.
- b. Sod Areas (8-32-16), i.e. 8% Nitrogen, 32% Phosphorus, 16% Potash at a rate of 350kg/ha.
- 11. Where applicable, for any plant areas with a mix of species/ cultivars notes, Contractor is to cluster like plants in groups of 3-5 and evenly distribute these in the noted area.

**CITY of OTTAWA** 

05 HUNTMAR DRIVE - WAREHOUSE DEVELOPMENT


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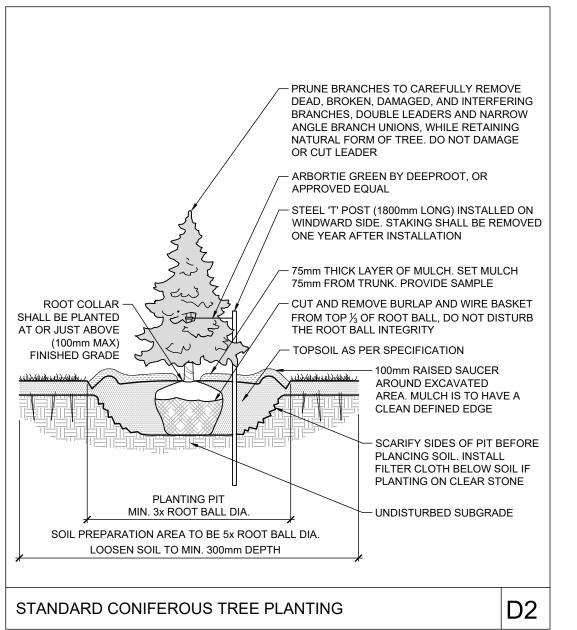
122151 REV # 2 122151-L6


(613) 254-9643 (613) 254-5867 Facsimile www.novatech-eng.com


LOCATION


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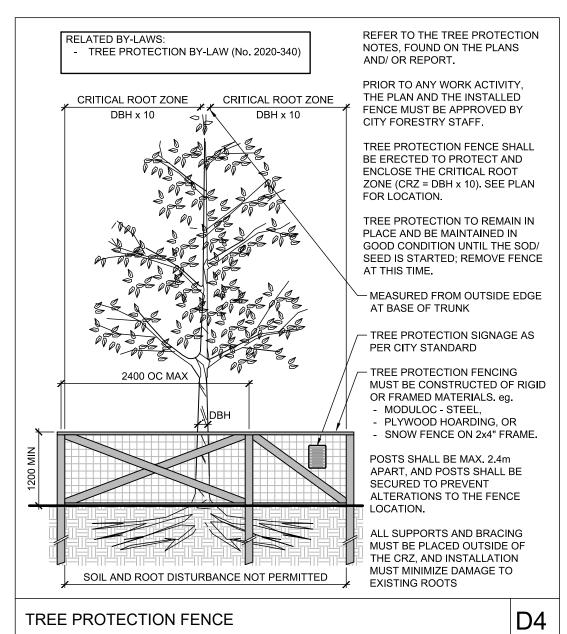





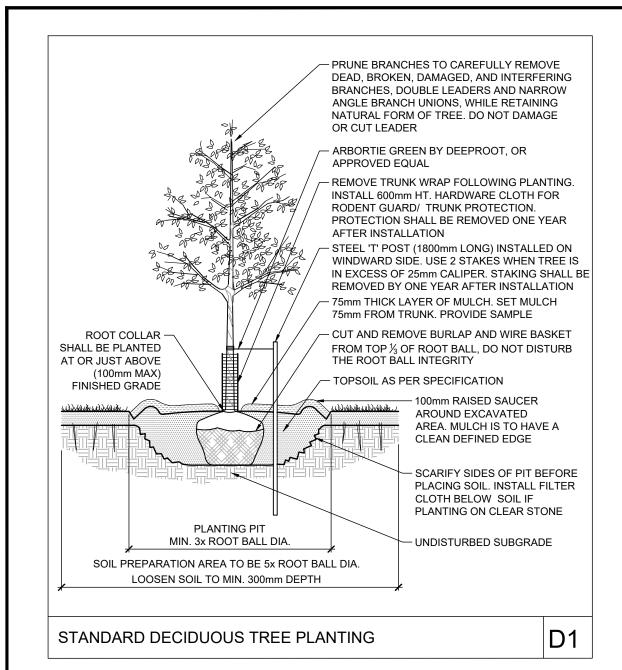

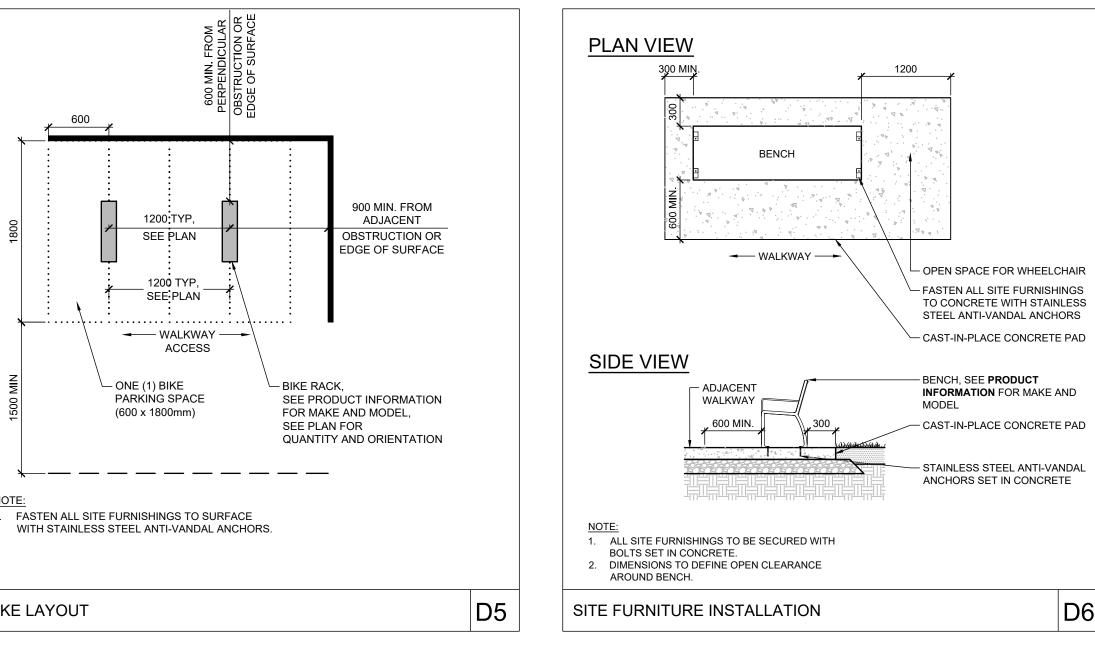

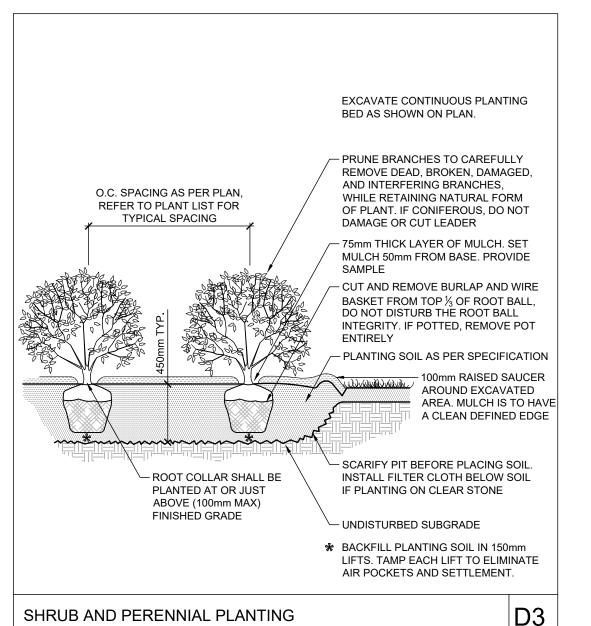

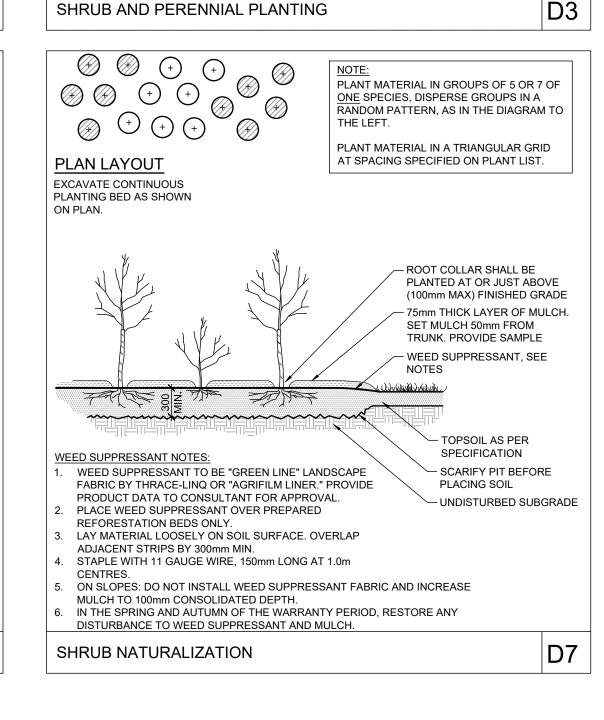

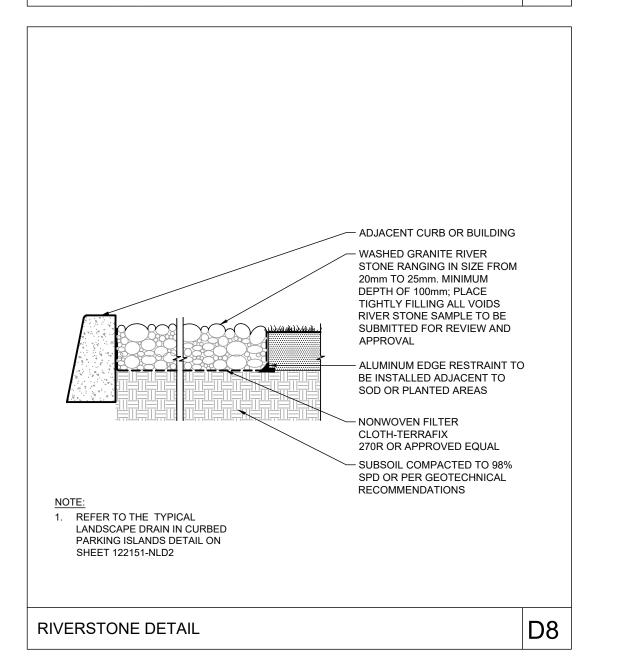

THE POSITION OF ALL POLE LINES, CONDUITS. WATERMAINS, SEWERS AND OTHER UNDERGROUND AND OVERGROUND UTILITIES AND STRUCTURES IS NOT NECESSARILY SHOWN ON THE CONTRACT DRAWINGS, AND WHERE SHOWN. THE ACCURACY OF THE POSITION OF SUCH UTILITIES AND STRUCTURES IS NOT GUARANTEED. BEFORE STARTING WORK, DETERMINE THE EXACT LOCATION OF ALL SUCH UTILITIES AND STRUCTURES AND ASSUME ALL LIABILITY FOR


DAMAGE TO THEM.

**BIKE LAYOUT** 

Owner: Rosefellow c/o Julian Nini 750 Marcel-Laurin, Suite 210 Saint-Laurent, QC H4M 2M4 Phone: (514) 532-1080

NOT FOR CONSTRUCTION

				SCALE	DESIGN		
						KW	
					CHECKED		
						RGJ	
					DRAWN		
					4	KW	
					CHECKED		
2.	REVISED PER CITY COMMENTS	MAR 30/23	RGJ			KW	
1.	ISSUED FOR CITY OF OTTAWA REVIEW	DEC 16/22	RGJ		APPROVED		
No.	REVISION	DATE	BY			RGJ	

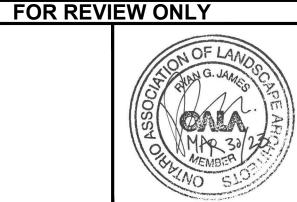

Engineers, Planners & Landscape Architects Suite 200, 240 Michael Cowpland Drive Ottawa, Ontario, Canada K2M 1P6

Facsimile

Website

(613) 254-9643

(613) 254-5867

www.novatech-eng.com

LOCATION CITY of OTTAWA 405 HUNTMAR DRIVE - WAREHOUSE DEVELOPMENT | DRAWING NAME LANDSCAPE DETAILS 122151