



PROPERTY DESCRIPTION:

Legal Description: Lot 7- Registered plan 127960 City of Ottawa Base on survey prepared by Surveyed by Annis, O'Sullivan, Vollebekk Ltd.

## **DEVELOPMENT DATA:**

Site Zoning Designation: TM11 Site area: 467.191 m² Frontage as per survey: 15.97 m. Depth as per survey: 29.45 m. Site Plan Control Approval for: three storey addition mixed use building Existing floor area: 349.3 m² New floor addition area: 527.8 m<sup>2</sup> New building footprint: 396.13 m² (85% lot coverage)

ZONING INFORMATION		
TM11		
PRINCIPAL DWELLING TYPE	REQUIRED FOR MIXED USE BUILDING	PROPOSED 3 STOREY
MINIMUM LOT WIDTH	NO	15.97 m
MINIMUM LOT AREA	NO	467.191 m²
MAXIMUM BUILDING HEIGHT	20m	8.96 m
FRONT YARD SETBACK	MAXIMUM: 3 M	0 m
CORNER SIDE YARD SETBACK	2.66m (AVE. OF EX. BUILDING & 3m)	2.31m (MATCH EXISTING) (ZBA. REQUIRED)
REAR YARD SETBACK	0	0.09
INTERIOR SIDE YARD SETBACK	MAX. 3m	0
ACTIVE ENTRANCES	MIN. ONE ACTIVE ENTRANCE PER EACH RESIDENTIAL OR NON-RESIDENTIAL USE ON GROUND FLR.	RESIDENTIAL: NOT REQUIRED AS RESIDENTIAL USE NOT ON GROUND FLOOR NON-RESIDENTIAL: ONE ENTRANCE/UNI
Parking Rate Area Y of Schedule 1A (Section 101, Table 101)		
Motor Vehicle	0	0
Min. Bicycle Parking (0.5/unit)	Residential: 0.5/unit = 1space (for new 2 unit only) Commercial: 1/250 m² = 1 space	2

NOTE: SNOW WILL BE REMOVED FROM THE SITE

# LEGEND:

SETBACK LINE

ENTRANCE PROPERTY LINE

**EXISTING BUILDING** 

NEW BUILDING ADDITION LANDSCAPE AREA

RIVER ROCK INTERLOCK WALKWAY

CLIENT:

WELLINGTON HURON COMMERCIAL INC.

371A RICHMOND RD. SUITE 1, OTTAWA, ONTARIO K2A 0B7

LRL ENGINEERING 5430 CANOTEK ROAD OTTAWA, ONTARIO K1J 9G2 T (613) 842-3434

FOTENN PLANNING + DESIGN 396 Cooper Street, Suite 300 Ottawa, ON K2P 2H7

SURVEYOR ANNIS, O'SULLIVAN, VOLLEBEKK Ltd. 14 Concourse Gate, Suite 500 Nepean, Ont. K2E 7S6 Phone: (613) 727-0850 Fax: (613) 727-1079

SUSAN D. SMITH ARCHITECT 941 Merivale Ottawa, Ontario K1Z 6A1 613-722-5327 s.smith@sdsarch.ca

NOTES: 1. All dimensions are to be checked on site. Discrepancies or ambiguities should be reported prior to work on site or ordering of materials. All work to be in accordance with the Ontario Building Code, latest edition. 3. All interior dimensions are to face of gypsum board

2	ISSUED FOR REVIEW	OCT. 11/22
1	ISSUED FOR SITE PLAN CONTROL	APR. 11/22
0	ISSUED FOR REVIEW	OCT. 22/21
No	DEVISION	DATE

PROPOSED ADDITION MIXED USE BUILDING 1248-1252 Wellington W

# SITE PLAN


DRAWN BY: TD & S.C.

JOB #: 2160

SEP/2021 DATE:

SCALE: AS NOTED



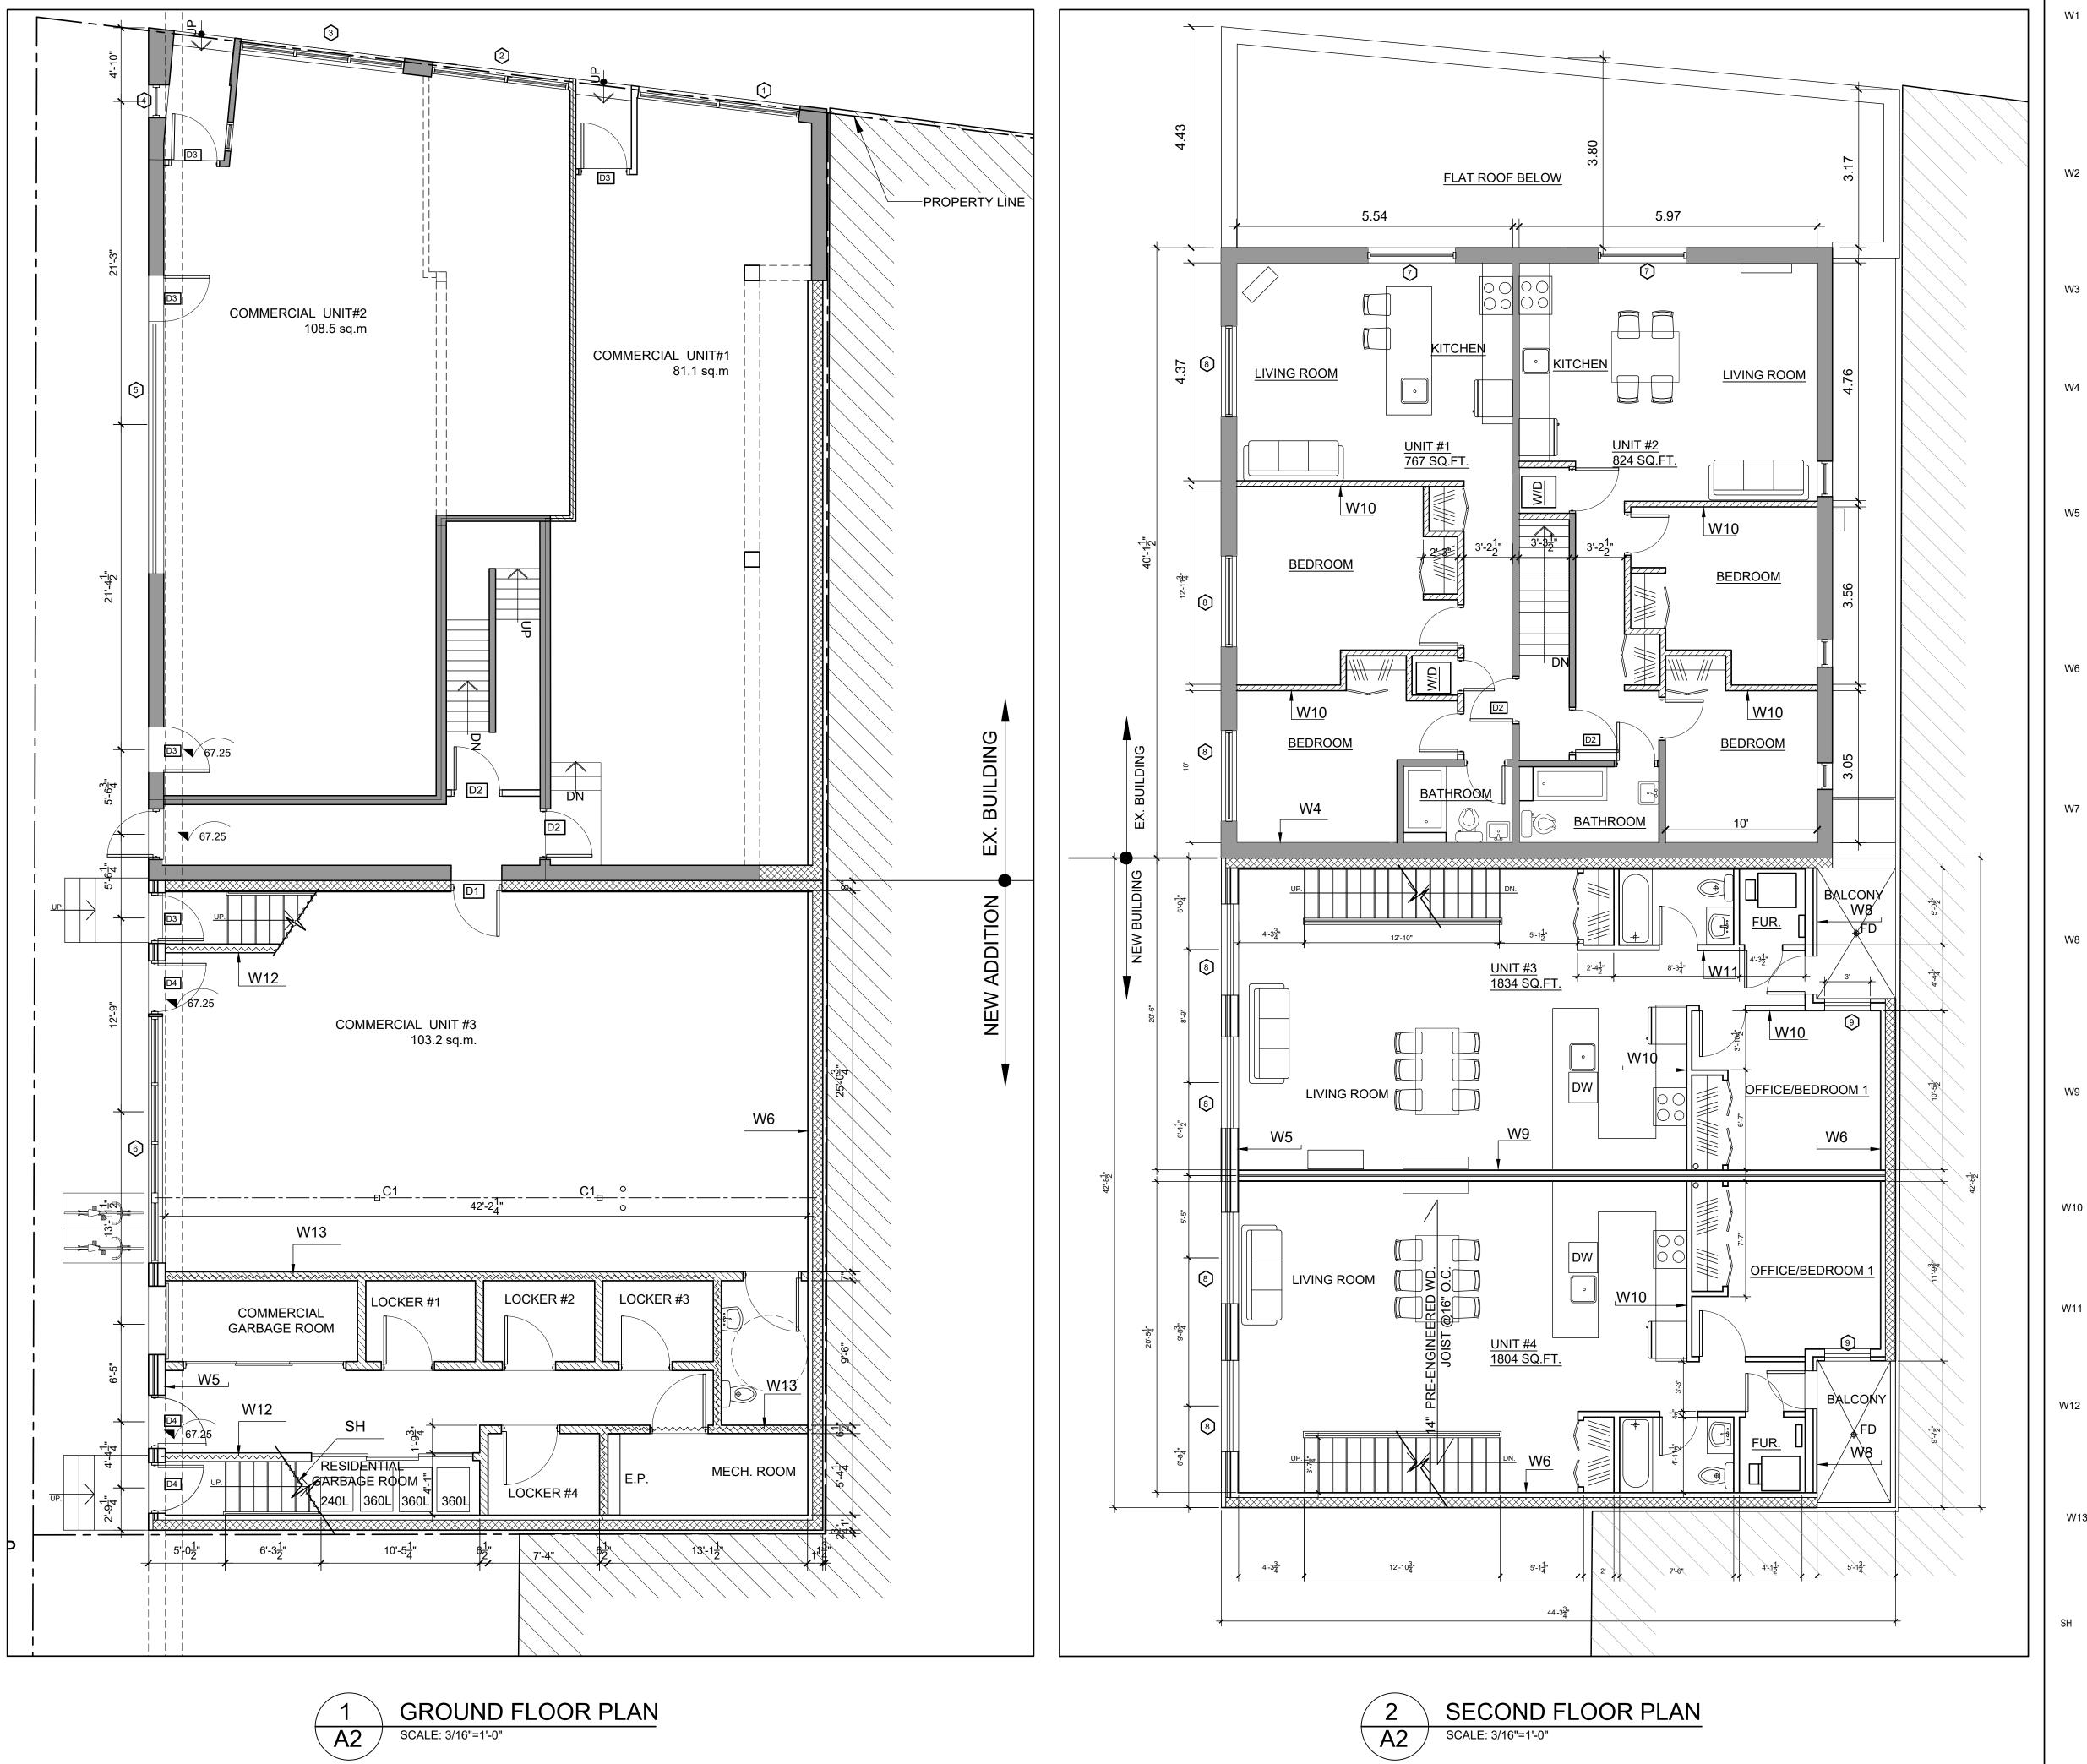

W1 FOUNDATION WALL WITH R20

- CEMENT PARGING ABOVE GRADE/'PLATON SYSTEM' DRAINAGE SHEET & BITUMINOUS DAMPROOFING LAYER BELOW GRADE
- CAST-IN-PLACE CONCRETE (SEE STRUCTURAL DWGS. FOR DETAILS)
- 1" AIR SPACE
- 2"x4" WOOD STUDS @ 16" 0.C. FILL W/ R20 SPRAY FOAM INSULATION
- 1/2" GYPSUM BOARD

W2 FOUNDATION WALL WITH R20

- CAST-IN-PLACE CONCRETE (SEE STRUCTURAL DWGS. FOR DETAILS) - 1" AIR SPACE - 2"x4" WOOD STUDS @ 16" 0.C. FILL W/ R20 SPRAY FOAM INSULATION - 1/2" GYPSUM BOARD

## FOUNDATION WALL MIN. 2HR. FRR AS PER

EXISTING CONC. FOUNDATION WALL NEW 8" CAST-IN-PLACE CONCRETE (SEE STRUCTURAL DWGS. FOR DETAILS)

W4 FIREWALL
MIN. 2HRS FRR - OBC SB-2

EX. PLASTER W/ WD. LATH
EX. 2x4 WD. STUDS @ 16"c/c
EX. WD SHEATHING
AIR SPACE
EX. 3.5" BRICK
NEW 8" THICK CONCRETE BLOCK (2HR. FRR)

W5 EXTERIOR WALL

√8" TYPE X GWB

VAPOUR BARRIER

2x6 WD. STUDS @ 16"c/c

BATT INSULATION B/W STUDS

√16 OSB SHEATHING

2.5" ROXUL INSULATION

AIR BARRIER

1" AIR SPACE & 3.5" BRICK OR

HARDIE BOARD SIDING

#### W6 EXTERIOR WALL. 2HR. FRR

2x4 WD. STUDS @ 16"c/c
R20 CLOSED CELL SPRAY FOAM INSULATION \(\frac{7}{16}\)
1" AIR SPACE
8" THICK CONCRETE BLOCK
(HARDIE BOARD WHERE EXPOSED WALL ON OUTSIDE)

### W7 FIREWALL

1" GWB
1x3 WD. STRAPPING
8" THICK CONCRETE BLOCK
BLUESKIN
4" Z-GIRT W/ ROXUL INSULATION (R20ci)
1" HARDIE BOARD

# W8 FXTERIOR WALL: 1HR FRR

5/8" TYPE X GWB
VAPOUR BARRIER
3 5/8" STEEL STUDS W/ ROXUL INSULATION (R12)

5" DENGLASS GOLD
2" Z-GIRT W/ ROXUL INSULATION (R10ci)
AIR BARRIER

1" HARDIE BOARD

# N9 1 HR. FRR/STC 60 TO OBC SB-3-W15

2 LAYERS OF  $\frac{1}{2}$ " TYPE X GWB 2x4 WD. STUDS @ 16"c/c ROXUL INSULATION B/W STUDS 1" AIR SPACE 2x4 WD. STUDS @ 16" C/C WITHOUT ISULATIONS 2 LAYERS OF  $\frac{1}{2}$ " TYPE X GWB

# W10 TYPICAL INTERIOR WALL:

-1/2" GYPSUM BOARD -2"x4" WOOD STUDS @ 16" o.c. -1/2" GYPSUM BOARD -(5/8" TYPE X G.B ON BOTH SIDE OF STUDS FOR LOAD BEARING WALLS)

# W11 TYPICAL BATHROOM WALL: 1/2" GYPSUM BOARD 2"x4" WOOD STUDS @ 16" o.c. FILL WITH BATT INSULATION 1/2" MOISTURE-RESISTANT GYP. BD.

(BATHROOM SIDE)

W12

INT. SOUND RES. STC 50+ & 45 MIN. FRR. WALL:
AS PER W4b OF O.B.C. SB-3
-5/8" 'TYPE X' GYPSUM BOARD
-2"x4" WOOD STUDS @ 16" o.c.
-FILL WITH BATT INSULATION
-HORIZONTAL RESILIENT METAL
CHANNELS @ 16' o.c.
-2 LAYERS OF 5/8" 'TYPE X'

# W13 1HR. FRR. SB2-2.3.4 -5/8" TYPE X GYPSUM BOARD (40 MIN) -2x4" WOOD STUD @16" o.c (20MIN)

-5/8" TYPE X GYPSUM BOARD

HORIZONTAL SHAFT WALL 2HR FRR. TEST NUMBER: OBMEC #89-1-118 (CGC SYSTEM)

1' SHEETROCK LINER PANELS
3" USG C-H STUD SPANNING HOR., 25 GA.
@24"O.C.
1" GYPSUM LINER PANELS SET INTO
ACOUSTICAL SEALANT
3 LAYERS OF 1/2" SHEETROCK FIRECODE C

R1 2% SLOPE ROOF CONST`N: 1HR FRR OBC SB2-2.3.12

-2 PLY MOD BITUMEN ROOF MEMBRANE
-PROTECTION BOARD TO MANUFACTURER'S
RECOMMENDATION
(Install protection board by embedding into beads
of adhesive 20mm wide on 300mm centres over
the polyisocyanurate foam insulation. Lay out
in rows in the same direction as the polyisocyanurate

insulation by with joints staggered at least 456mm in both direction, stagger joints in alternative rows 610mm from each other. Do not install more insulation than can be completely roofed in the same day).

-POSI SLOPE R-35ci MINIMUM
-3/4" EXT. GRADE T&G PLYWD
-WD JOISTS AS PER MANUFACTURER
-FILL WITH BATT INSULATION
-VAPOUR BARRIER
-1x3 WOOD STRAPPING @12 o.c
-2 LAYERS 5/8" TYPE "X" GYPSUM BOARD. (60 MINS)

#### CONCRETE SLAB-BELOW-GRADE

4" CAST-IN-PLACE CONCRETE SLAB. SEE STRUCTURAL FOR REINFORCEMENT. SMOOTH TROWEL FINISH 6 mil. POLY. VAPOUR BARRIER 6" CRUSHED STONE BASE COMPACTED TO 95% PROCTOR DENSITY

#### F2 FLOOR (ABOVE CRAWL SPACE).

Laminate or ceramic tiles floor

½" Elastomeric underlay such as Kinetics ISOLayment QT or equivalent

¾" T&G plywood sheathing

14" OJ-Triforce joist system as per manufacturer

#### 1HR FRR. FLOOR. (STC 55 SIMILAR TO nrc tlf-97-053a IIC 50+est.)

Laminate or ceramic tiles floor

¼" Elastomeric underlay such as Kinetics ISOLayment QT or equivalent

¾" T&G plywood sheathing

14" OJ-Triforce joist system as per manufacturer

12" Acoustic Batt Insulation

½" Resilient channel @ 24" o.c.

2-ply ⅓" type "X" gypsum board 60min.

#### F4 TYPICAL FLOOR (WITHIN UNIT):

-VINYL FLOORING
-3/4" T&G OSB SUBFLOOR, GLUED & SCREWED
PER MANUFACTURER'S INSTRUCTIONS
-FLOOR JOISTS AS PER SHOP DRAWINGS,
-1"x3" WOOD STRAPPING
-1/2" GYPSUM BOARD

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MIXED USE BUILDING
1248-1252 Wellington W

FLOOR PLANS

DRAWN BY: TD & S.C.

JOB #: 2160

DATE: SEP/2021

AS NOTED

SCALE:

AZ

