

No.	Y / M / D	REVISION
2.	2023.03.02	SITE PLAN COMMENTS
1.	2022.11.07	SITE PLAN APPLICATION

Consultants:

It is the responsibility of the appropriate contractor to check & verify all dimensions on site and report all errors &/or omissions to the architect. All contractors must comply with all pertinent codes & by-laws, & use proprietary products as directed by the manufacturer. Do not scale drawings. Copyright reserved.



3 STOREY MIXED USE BUILDING
180 Main Street, Ottawa, Ontario

ELEVATIONS

Drawn By: MP / RV
Date: NOV. 2022
Project No: 2208
Scale: 3/32" = 1'-0"


A2.1

- 580 5/8" T/O SECOND FLOOR
- 563 7/8" U/S SECOND FLOOR
- 454 3/4" T/O THIRD FLOOR
- 438" U/S THIRD FLOOR
- 328 7/8" T/O SECOND FLOOR
- 312 1/8" U/S SECOND FLOOR
- 203" T/O SECOND FLOOR
- 186 1/4" U/S SECOND FLOOR
- 98" T/O MEZZ FLOOR
- 87 3/4" U/S MEZZ FLOOR
- 0" (65.513) T/O GROUND FLOOR
- (65.325) AVERAGE GRADE




1 FRONT ELEVATION
SCALE: 3/32"=1'-0"

BUILDING AREA = 342 sqft (100%)
GLAZING AREA = 75 sqft (22%)

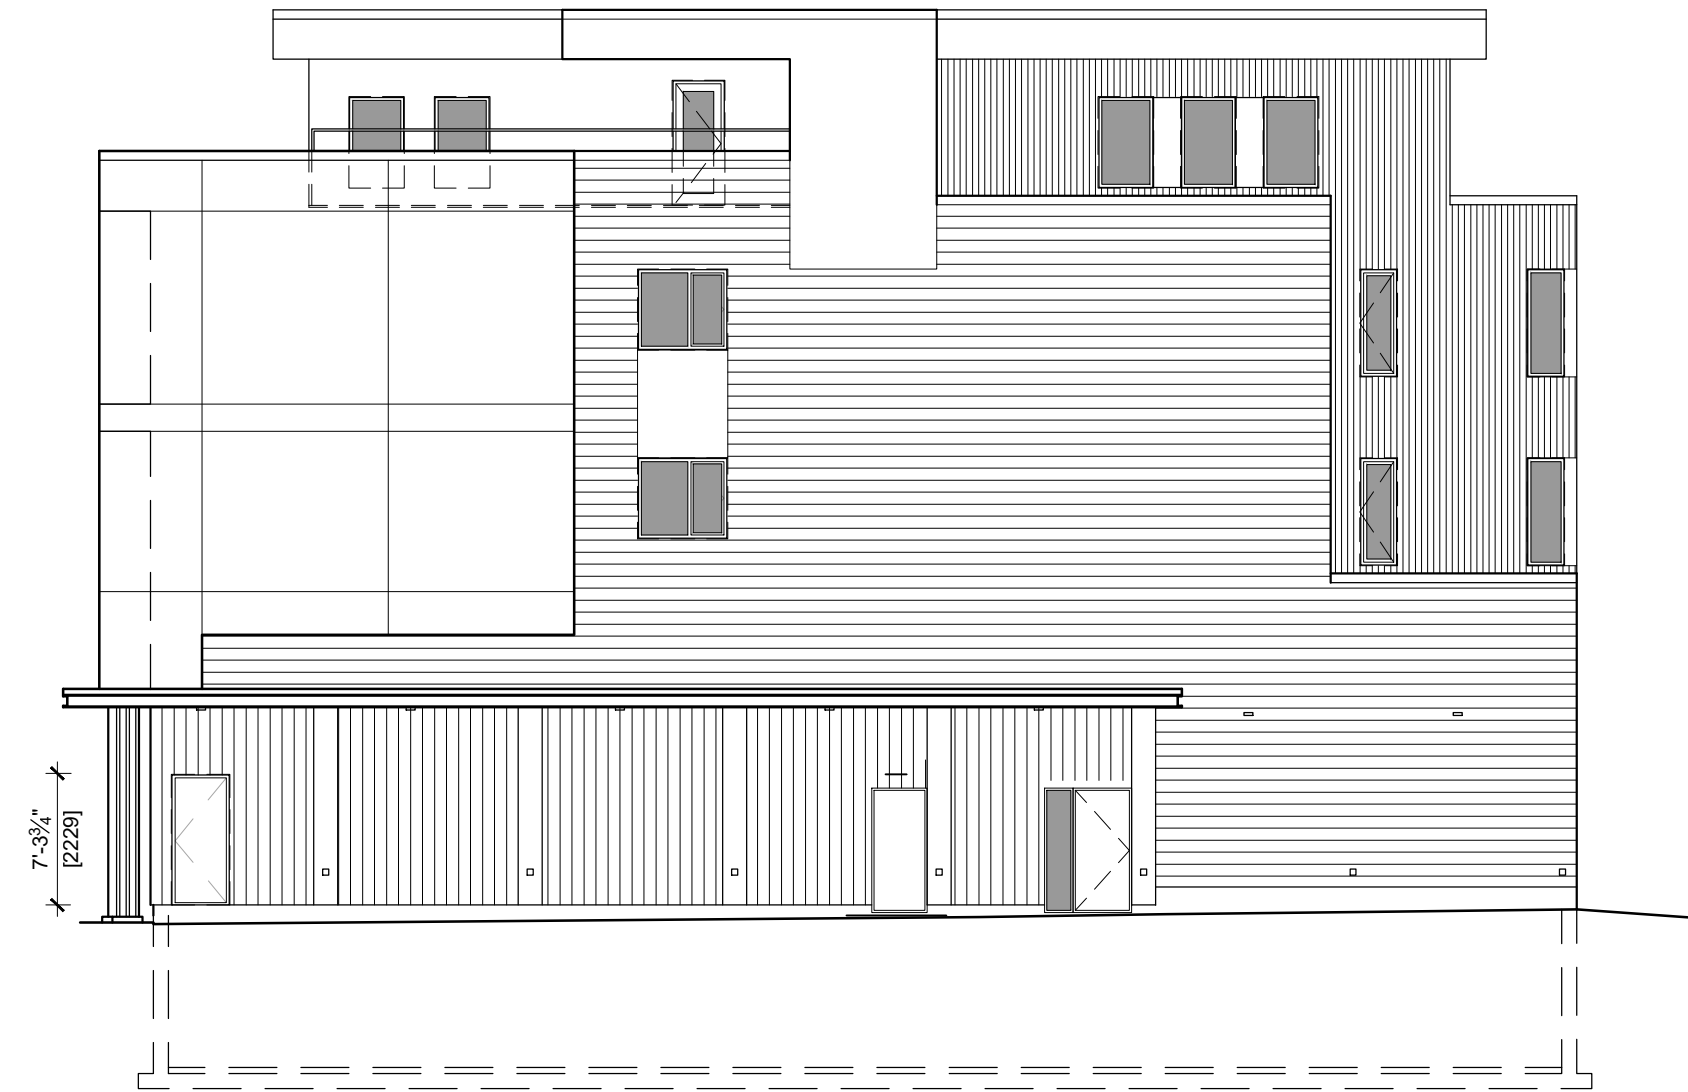


2 RIGHT ELEVATION
SCALE: 3/32"=1'-0"

- 580 5/8" T/O SECOND FLOOR
- 563 7/8" U/S SECOND FLOOR
- 454 3/4" T/O THIRD FLOOR
- 438" U/S THIRD FLOOR
- 328 7/8" T/O SECOND FLOOR
- 312 1/8" U/S SECOND FLOOR
- 203" T/O SECOND FLOOR
- 186 1/4" U/S SECOND FLOOR
- 98" T/O MEZZ FLOOR
- 87 3/4" U/S MEZZ FLOOR
- 0" (65.513) T/O GROUND FLOOR
- (65.325) AVERAGE GRADE

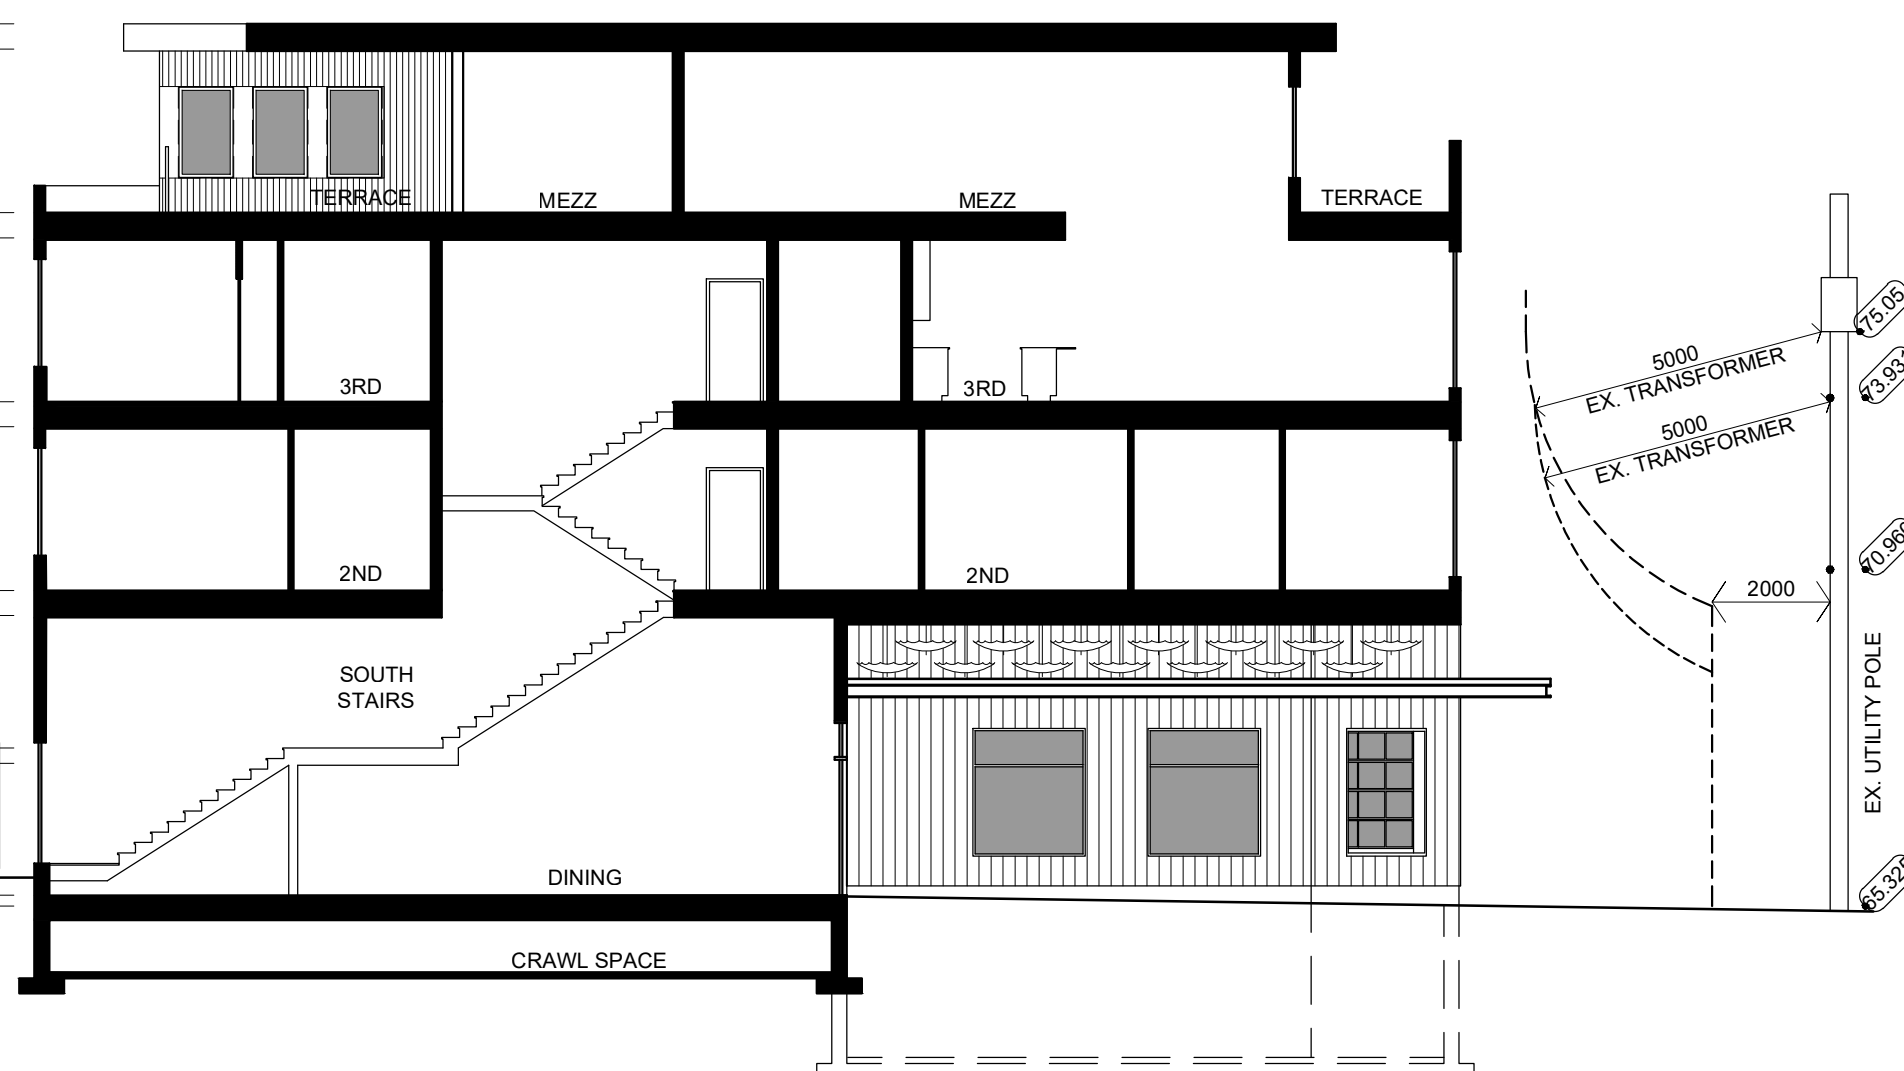

3 LEFT ELEVATION
SCALE: 3/32"=1'-0"

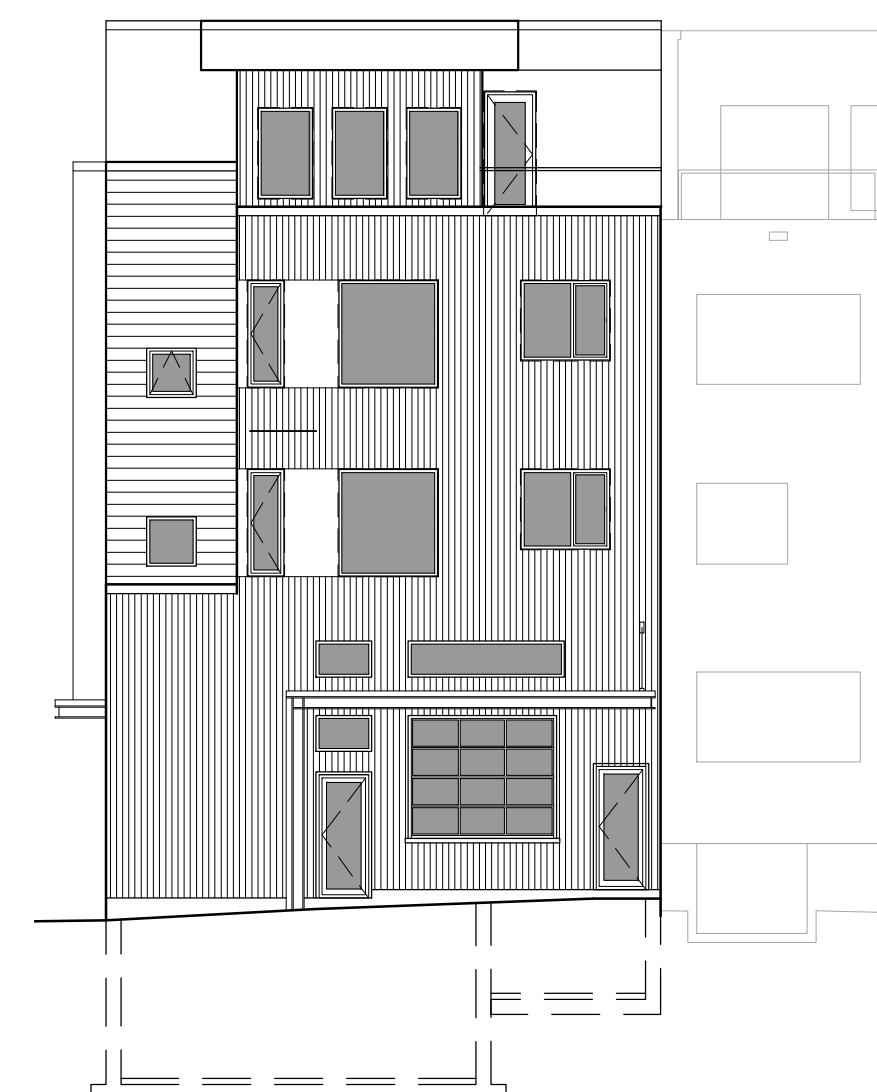

4 REAR ELEVATION
SCALE: 3/32"=1'-0"