SITE STATISTICS		
ZONING	IP - BUSINESS	PARK INDUSTRIAL
	IP [2265]H(1	2)
SETBACKS	MIN REQ'D (m)	PROVIDED (m)
FRONT YARD	6.0	35.1
REAR YARD	6.0	6.00
INTERIOR SIDE	3.0	3.00
INTERIOR SIDE	3.0	3.00
WIDTH OF LANDSCAPE STRIP		
ABUTTING A STREET	3.0	3.0
MAXIMUM FLOOR SPACE INDEX	2	1
HEIGHT OF BUILDING	MAX	PROVIDED
BUILDING HEIGHT	10.55	10-
(MEASURED FROM GRADE TO T/O ROOF DECK)	12m	12m
CONSTRUCTION AREAGROSS FLOOR AREA (GFA)	SM	SF
ground floor-banquet hall (140 person)	172	1,851
GROUND FLOOR-PRE FUNCTION	42	452
GROUND FLOOR-HOTEL	1,049	11,29
2ND FLOOR	1,284	13,82
3RD FLOOR	1,284	13,821
4TH FLOOR	1,284	13,82
TOTAL CONSTRUCTION AREA	5,115	55,057
PARKING REQUIREMENTS (BASED ON TABLE 101; AREA "C" ON SCHEDULE 1A) - SPACES @ 2.6W x 5.2L - 50% of stalls are compact stalls (size at 2.4W x 4.6L per zoning standards)	REQ'D	PROVIDED
HOTEL: 1 SPACE PER GUEST UNIT (88 ROOMS)	88	88
PLACE OF ASSEMBLY (10 PER 100sm OF GFA OF ASSEMBLY AREA)	20	20
BANQUET HALL + PRE FUNCTION AREA (200 S Q M) REDUCED PARKING SPACES (COMPACT CARS) UP TO 50% OF THE PARKING SPACES		51
TYPICAL PARCKING STALLS PROVIDED		52
ACC TYPICAL PARCKING STALLS PROVIDED		52
TOTAL NO. OF SPACES	108	108
TOTAL TIO. OF STATES	100	
	100	
ACCESSIBLE PARKING (CITY OF OTTAW A ACCESSIBILITY DESIGN STANDARDS)	REQ'D	
ACCESSIBLE PARKING (CITY OF OTTAW A ACCESSIBILITY DESIGN STANDARDS) 101-133 PARKING SPACES, THEN 5 ACCESSIBLE SPACES REQ'D	REQ'D	Ļ
ACCESSIBLE PARKING (CITY OF OTTAW A ACCESSIBILITY DESIGN STANDARDS)	REQ'D	2
ACCESSIBLE PARKING (CITY OF OTTAW A ACCESSIBILITY DESIGN STANDARDS) 101-133 PARKING SPACES, THEN 5 ACCESSIBLE SPACES REQ'D TYPE A (VAN), MIN WIDTH=3400 TYPE B, MIN WIDTH=2400	8 REQ'D 5 2 3	2
ACCESSIBLE PARKING (CITY OF OTTAW A ACCESSIBILITY DESIGN STANDARDS) 101-133 PARKING SPACES, THEN 5 ACCESSIBLE SPACES REQ'D TYPE A (VAN), MIN WIDTH=3400 TYPE B, MIN WIDTH=2400 BICYCLE PARKING (BASED ON TABLE 111A (g)&(i))	REQ'D	PROVIDE
ACCESSIBLE PARKING (CITY OF OTTAW A ACCESSIBILITY DESIGN STANDARDS) 101-133 PARKING SPACES, THEN 5 ACCESSIBLE SPACES REQ'D TYPE A (VAN), MIN WIDTH=3400 TYPE B, MIN WIDTH=2400	8 REQ'D 5 2 3	PROVIDE
ACCESSIBLE PARKING (CITY OF OTTAW A ACCESSIBILITY DESIGN STANDARDS) 101-133 PARKING SPACES, THEN 5 ACCESSIBLE SPACES REQ'D TYPE A (VAN), MIN WIDTH=3400 TYPE B, MIN WIDTH=2400 BICYCLE PARKING (BASED ON TABLE 111A (g)&(i)) HOTEL = 1 PER 1000sm OF GFA ALL OTHER (ie. PLACE OF ASSEMBLY) = 1 PER 1500sm OF GFA	REQ'D	PROVIDE
ACCESSIBLE PARKING (CITY OF OTTAW A ACCESSIBILITY DESIGN STANDARDS) 101-133 PARKING SPACES, THEN 5 ACCESSIBLE SPACES REQ'D TYPE A (VAN), MIN WIDTH=3400 TYPE B, MIN WIDTH=2400 BICYCLE PARKING (BASED ON TABLE 111A (g)&(i)) HOTEL = 1 PER 1000sm OF GFA ALL OTHER (ie. PLACE OF ASSEMBLY) = 1 PER 1500sm OF GFA	REQ'D 5 2 3 REQ'D 5 1	PROVIDE
ACCESSIBLE PARKING (CITY OF OTTAW A ACCESSIBILITY DESIGN STANDARDS) 101-133 PARKING SPACES, THEN 5 ACCESSIBLE SPACES REQ'D TYPE A (VAN), MIN WIDTH=3400 TYPE B, MIN WIDTH=2400 BICYCLE PARKING (BASED ON TABLE 111A (g)&(i)) HOTEL = 1 PER 1000sm OF GFA ALL OTHER (ie. PLACE OF ASSEMBLY) = 1 PER 1500sm OF GFA TOTAL NO. OF SPACES DRIVEWAYS AND AISLE REQUIREMENTS (SECTION 107)	REQ'D 5 REQ'D 5 1 6 REQ'D (MIN)	PROVIDE
ACCESSIBLE PARKING (CITY OF OTTAW A ACCESSIBILITY DESIGN STANDARDS) 101-133 PARKING SPACES, THEN 5 ACCESSIBLE SPACES REQ'D TYPE A (VAN), MIN WIDTH=3400 TYPE B, MIN WIDTH=2400 BICYCLE PARKING (BASED ON TABLE 111A (g)&(i)) HOTEL = 1 PER 1000sm OF GFA ALL OTHER (ie. PLACE OF ASSEMBLY) = 1 PER 1500sm OF GFA TOTAL NO. OF SPACES DRIVEWAYS AND AISLE REQUIREMENTS (SECTION 107) TW O-W AY DRIVEW AY	REQ'D 5 2 3 REQ'D 5 1 6 REQ'D 6 7 6 7 8 8 8 8 8 8 8 8 8 8 8 8	PROVIDED PROVIDED 6.7
ACCESSIBLE PARKING (CITY OF OTTAW A ACCESSIBILITY DESIGN STANDARDS) 101-133 PARKING SPACES, THEN 5 ACCESSIBLE SPACES REQ'D TYPE A (VAN), MIN WIDTH=3400 TYPE B, MIN WIDTH=2400 BICYCLE PARKING (BASED ON TABLE 111A (g)&(i)) HOTEL = 1 PER 1000sm OF GFA ALL OTHER (ie. PLACE OF ASSEMBLY) = 1 PER 1500sm OF GFA TOTAL NO. OF SPACES DRIVEWAYS AND AISLE REQUIREMENTS (SECTION 107) TW O-W AY DRIVEW AY	REQ'D 5 REQ'D 5 1 6 REQ'D (MIN)	PROVIDE
ACCESSIBLE PARKING (CITY OF OTTAW A ACCESSIBILITY DESIGN STANDARDS) 101-133 PARKING SPACES, THEN 5 ACCESSIBLE SPACES REQ'D TYPE A (VAN), MIN WIDTH=3400 TYPE B, MIN WIDTH=2400 BICYCLE PARKING (BASED ON TABLE 111A (g)&(i)) HOTEL = 1 PER 1000sm OF GFA ALL OTHER (ie. PLACE OF ASSEMBLY) = 1 PER 1500sm OF GFA TOTAL NO. OF SPACES DRIVEWAYS AND AISLE REQUIREMENTS (SECTION 107) TW O-W AY DRIVEW AY TW O-W AY PARKING AISLE	REQ'D 5 2 3 REQ'D 5 1 6 REQ'D 6 7 6 7 8 8 8 8 8 8 8 8 8 8 8 8	PROVIDED 6.7
ACCESSIBLE PARKING (CITY OF OTTAW A ACCESSIBILITY DESIGN STANDARDS) 101-133 PARKING SPACES, THEN 5 ACCESSIBLE SPACES REQ'D TYPE A (VAN), MIN WIDTH=3400 TYPE B, MIN WIDTH=2400 BICYCLE PARKING (BASED ON TABLE 111A (g)&(i)) HOTEL = 1 PER 1000sm OF GFA	REQ'D 5 2 3 REQ'D 5 1 6 REQ'D 6 7 6 7 8 8 8 8 8 8 8 8 8 8 8 8	PROVIDED 6.7 PROVIDED

1 SITE STATS
ASP-1 N.T.S

HOLIDAY INN OTTAWA- ROOM MIX								
	1st FLOOR	2nd FLOOR	3rd FLOOR	4th FLOOR	TOTAL	PERCENTAGAGE	MIX	
KING	3	6	6	6	21	24%	32%	
ACC KING	1	2	2	2	7	8%	32%	
QQ	0	15	15	15	45	51%	53%	
ACC JUNIOR SUITE	0	1	1	0	2	2%	53%	
JUNIOR SUITE	0	4	4	5	13	15%	15%	
TOTAL	4	28	28	28	88	100%	100%	
TOTAL ACC. ROOMS	1	3	3	2	9	10%	100%	

ROOM MIX


ASP-1 N.T.S


	SITE PLAN L	EGEND	
	PROPERTY LINE	#	RECESSED EXTERIOR LIGHT FIXTURE @ SOFFIT & PROTE COCHERE -REFER TO ELECTRICAL DWGS
	BUILDING SETBACK LINE	<i>;</i> ///,	NEW HEAVY DUTY ASPHALT PAVING (REMAINDER OF THE SITE TO RECEIVE
	- LANDSCAPE BUFFER	//:///	LIGHT DUTY ASPHALT PAVING)
CD	CURB DEPRESSION		DECORATIVE NON-SLIP SURFACE PAVING UNDER PORTE COCHERE (REFER TO LANDSCAPE DWGS)
	ENTRY/ EXIT ACCESS POINTS		(RELECTO BANDSON E BANDS)
¤	EXISTING TOWN HYDRANT		LANDSCAPED AREA
#©# •	PROPOSED LOCATION OF NEW FIRE HYDRANT W/ STEEL BOLLARDS -REFER TO CIVIL DWGS	4 44 4	POURED CONCRETE PAD AT LOADING AREA & WASTE COLLECTION
∑c	FIRE DEPARTMENT CONNECTION		STEEL BOLLARD (REFER TO DETAIL XX.X)
₩	HOSE BIB (REFER TO MECHANICAL DWGS)	(x)	PARKING COUNT
	PAD MOUNTED HYDRO TRANSFORMER W/ STEEL BOLLARDS	FRS	FIRE ROUTE SIGN TO BE POSTED UNDER DESIGNATED MUNICIPAL BYLAW 2003-499. REFER TO DETAI 2/A102
	DOUBLE HEADED LIGHT FIXTURE ON CONCRETE BASE -REFER TO ELECTRICAL	104.04×	PROPOSED GRADING (REFER TO CIVIL DWGS)
			CONDENSING UNIT ON 4" CONCRETE PAD (REFER TO MECH DWGS)
<u></u> —→	SINGLE HEADED LIGHT FIXTURE ON CONCRETE BASE -REFER TO ELECTRICAL DWGS	V/////////////////////////////////////	SNOW STORAGE AREA (OWNER TO TAKE NECESSARY PRECAUTIONS W, SNOW REMOVAL COMPANY)
	SINGLE HEADED LIGHT FIXTURE ON CONCRETE BASE W/ ELECTRICAL OUTLET -REFER TO ELECTRICAL DWGS		


CREDIT NOTES:	CREDIT NOTES:	SITE PLAN- GENERAL NOTES			NOTES
THIS SITEPLAN IS BASED UPONT AND MUST BE READ IN CONJUNCTION WITH THE SURVEY FOR THIS PROPERTY. MATAJ ARCHITECTS ACCEPTS	ANNIS, O'SULLIVAN, VOLLEBEKK LTD.	1	ALL EXISTING PAVEMENT, CURBS, SIDEWALKS, DRIVEWAYS AN DBOULEVARD AREAS DISTURBED BY THE CONSTRUCTION ME BE REINSTATED TO THE SATISFACTION	5	THE OWNER/ CONTRACTOR SHALL SUPPLY ALL FIRE ROUTE AND BARRIER-FREE SIGNS AS SET OUT IN THE TOWN BY-LAWS AND DESIGN CRITERIA
NO RESPONSIBILITY FOR THE ACCURACY, OR COMPLETENESS OF THE DATA SUPPLIED AND	14 CONCOURSE GATE, SUITE 500 NEPEAN, ONT. K2E 7S6		OF THE TOWN	6	ALL EXTERIOR ILLUMINATION TO BE DIRECTED DOWNWARD
SUCH DATA IS NOT INCLUDED UNDER SEALS OF CERTIFICATION, IF ANY.	PHONE: (613) 727-0850 / FAX: (613) 727-1079 EMAIL: NEPEAN@AOVLTD.COM	2	A MINIMUM SETBACK OF 1.0m FROM STREET FURNTIURE TO PROPOSED DRIVEWAYS AND SIDEWALKS SHALL BE MAINTAINED. ALL EXISTING STREET FURNITURE TO BE		AS WELL AS INWARD AND DESIGNED TO MAINAIN XERO CUTOFF LIGHT DISTRIBUTION AT THE PROPERTY LINE
RELOATED BY THE CONTRACTOR/OWNER TO A SETBACK OF 1.0m, THE COST OF RELCOATION OF ANY UTILITY IS THE RESPONSIBILITY OF THE DEVELOPER/ OWNER		7	ALL DOWNSPOUTS TO BE CONNECTED TO THE STORM DRAINAGE SYSTEM		
BLOCK 3 REGISTERED PLAN 4M-1634		3	THE CONTRACTOR/ OWNER IS RESPONSIBLE FOR ALL UTILITY LOCATES AND DAMAGE/ DISTURBANCE DURING	8	ALL CONDENSING UNITS TO BE SCREENED ON THE GROUND FLOOR
CITY OF OTTAWA	OTTAWA CONSTRUCTION.		9	SEPARATE PERMITS ARE REQUIRED FOR ANY SIGNAGE	
		4	4 ALL BARRIER-FREE ENTRANCES AND BARRIER FREE PATHS		ON THE PROPERY
OF TRAVEL MUST COMPLY WITH O.B.C. 3.8.		10	WHERE POSSIBLE TREES ARE TO BE PROTECTED FROM		




3 SITE LOCATION N.T.S

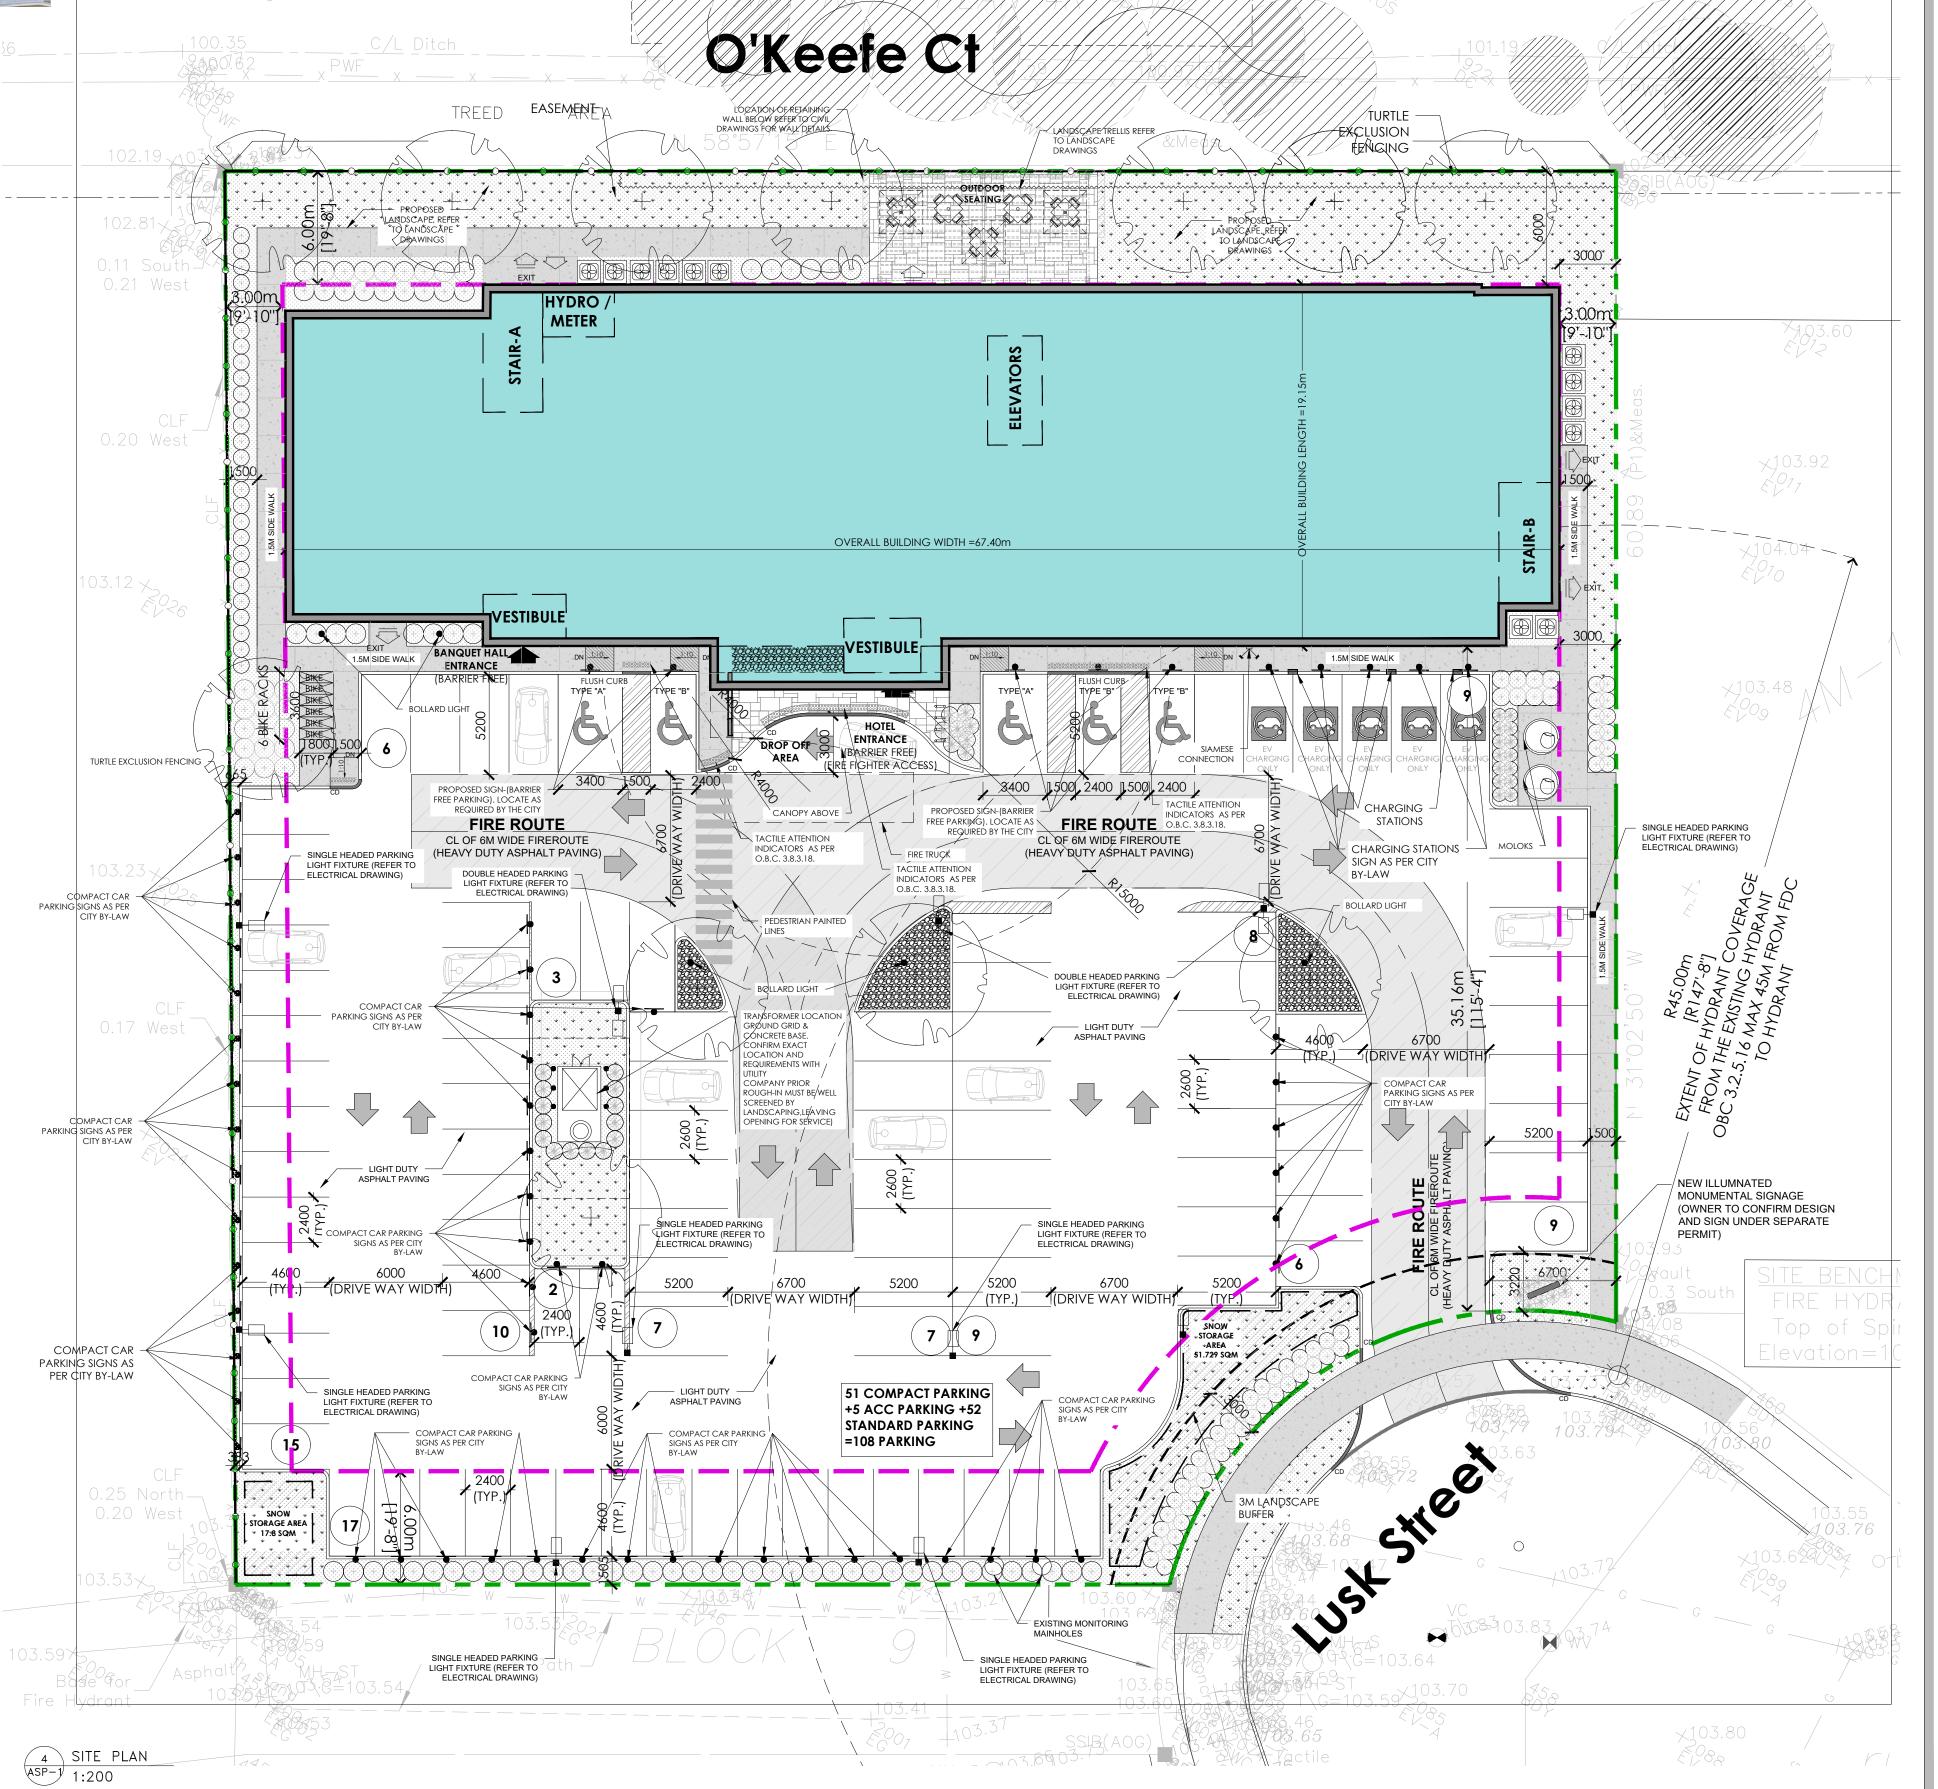

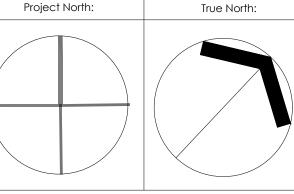

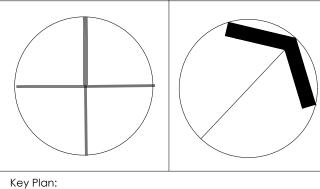

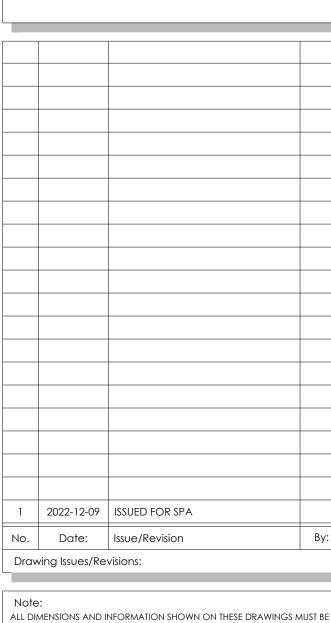

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SAME CHARACTER AS THOSE NOTED FOR SIMILAR CONDITIONS.

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WORK IN PROGRESS



Architect's Stamp



HOLIDAY INN OTTAWA

140 Lusk St, Ottawa, ON

HOLIDAY INN -SITE PLAN

Design By: M.A.	Drawn By: S.F.	Approved By: A.M.
Scale: AS SHOWN	Date: 22-10-15	Project No.: 22-027

Drawing No:

ASP-1

Drawing Series: ARCHITECTURAL - SPA





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Architect's Stamp

HOLIDAY INN OTTAWA

140 Lusk St, Ottawa, ON

PROPOSED SOUTH ELEVATION

Design By:

Drawn By: S.F.

1/8"=1'-0" 22-10-15 22-027

A.301

Approved By:

Project No.:

A.M.

	EXTERIOR FINISH SCHEDULE		
	MATERIAL/FINISH	COLOR	NOTES
EIFS			
1	EIFS BY CORNERPOINT OR EQUIVALENT, SMOOTH FINISH	BLACK	
2	EIFS BY CORNERPOINT OR EQUIVALENT, SANDSTONE FINISH	BM, KENDALL CHARCOAL HC-166	
3	WOOD VENEER & EPOXY OVER EIFS SYSTEM, BY CORNER POINT	TIMBER TEAK EQUIVALENT	
4	EIFS BY CORNERPOINT OR EQUIVALENT, GEMSTONE FINISH	BLACK MAINE	
5	EIFS BY CORNERPOINT OR EQUIVALENT, METALLIC FINISH	WHITE DOVE, BM OC 151	
6	EIFS BY CORNERPOINT OR EQUIVALENT, SMOOTH FINISH	WHITE DOVE, BM OC 151	
7	EIFS PANEL BY DURABOND OR EQUIVALENT, SANDSTONE FINISH	BM, MOZART BLUE 1665	
8	EIFS BY CORNERPOINT OR EQUIVALENT, SMOOTH METALLIC FINISH	BM, FIELD STONE 1558	
9	EIFS 3/4" REVEAL		
10	EXTERIOR GRADE PAINT ON 3" DIAMETER GALVANIZED STEEL COLUMNS, MATTE FINISH	WHITE	
11	EIFS BY CORNERPOINT OR EQUIVALENT, SMOOTH FINISH	BM, Classic Burgundy HC-182	
12	STAC-BOND ALUMINUM COMPOSITE PANEL, NATURAL MIRROR FINISH	STB-M01	
LIGHT	ING		
20	2 LINEAR WHITE STRIPS WITH LENS ON A DIMMER	3000 K	
21	4" X 4" LED LIGHT	3000 K, WHITE LENS	
22	DECORATIVE WALL SCONCE	3000 K	
23	ILLUMINATED SIGNAGE		
24	3x12 SS LED SURFACE MOUNTED DOWNLIGHT	3000 K	

	SPECIAL INSTRUCTIONS
Α	TYPICAL WALL PLANE, 0.00 (6" EIFS)
В	+6" PROJECTING FROM 'A' PLANE
С	-1" RECESSED FROM 'A' PLANE
D	-2" RECESSED FROM 'A' PLANE
E	-3" RECESSED FROM 'A' PLANE
F	-4" RECESSED FROM 'A' PLANE

GENERAL NOTES:

- 1. ALL GRILLS IN EXTERIOR ELEVATION PAINTED TO MATCH ADJACENT COLOR.
- 2. SAMPLES OF ALL EXTERIOR FINISHES AND COLORS SHOULD BE SUBMITTED TO ARCHITECT FOR REVIEW AND APPROVAL BEFORE PROCEEDING WITH CONSTRUCTION
- 3. CM/BUILDER SHALL PROVIDE ACTUAL SAMPLE FINISHES ON EXTERIOR WALLS FOR OWNERSHIP APPROVAL BEFORE WORK COMMENCES ON FINAL EXTERIOR FINISHES REGARDLESS OF ARCHITECT'S OR OWNERSHIP'S EARLIER SAMPLE APPROVAL IN REGARDS, ESPECIALLY AS IT PERTAINS TO STUCCO COLORS.
- 4. FOR FIELD APPLIED EIFS, CM/GC TO PROVIDE SHOP DRAWING INDICATING ALL EXTERIOR MECHANICAL PENETRATION AS IT PERTAINS TO THEIR SIZE/LOCATION & FINISH/COLOR



3 2023-02-08 ISSUED FOR MINOR VARIANCE SUB. 2 2022-12-09 ISSUED FOR SPA 1 2022-10-25 ISSUED FOR MINOR VARIANCE SUB. No. Date: Issue/Revision Drawing Issues/Revisions:

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WORK IN PROGRESS



Architect's Stamp

206-418 Iroquois Shore Ro O akville O ntario L 6 H 0X7 T .9 0 5. 2 8 1.4 4 4

HOLIDAY INN OTTAWA

140 Lusk St, Ottawa, ON

Sheet Title:

PROPOSED SOUTH ELEVATION

Drawn By: Design By:

S.F. 1/8"=1'-0" 22-10-15 22-027

A.301a

Approved By:

Project No.:

A.M.





Key Plan:

3	2023-02-08	ISSUED FOR MINOR VARIANCE SUB.	
1	2022-10-25	ISSUED FOR MINOR VARIANCE SUB.	
No.	Date:	Issue/Revision	By:
Draw	ving Issues/Re	visions:	ı
	<u> </u>		

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MATAJ**ARCHITECTS**NCORPORATED

206-418 Iroquois Shore Rd
Oakville Ontario
L6H 0X7

Project:

HOLIDAY INN OTTAWA

140 Lusk St, Ottawa, ON

Sheet T

PROPOSED EAST & WEST ELEVATIONS

Design By: Drawn By: Approved By: M.A. S.F. A.M.

Scale: Date: Project No.: 22-027

Drawina No:

A.302


	EXTERIOR FINISH SCHEDULE		
	MATERIAL/FINISH	COLOR	NOTES
EIFS			
1	EIFS BY CORNERPOINT OR EQUIVALENT, SMOOTH FINISH	BLACK	
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4	EIFS BY CORNERPOINT OR EQUIVALENT, GEMSTONE FINISH	BLACK MAINE	
5	EIFS BY CORNERPOINT OR EQUIVALENT, METALLIC FINISH	WHITE DOVE, BM OC 151	
6	EIFS BY CORNERPOINT OR EQUIVALENT, SMOOTH FINISH	WHITE DOVE, BM OC 151	
7	EIFS PANEL BY DURABOND OR EQUIVALENT, SANDSTONE FINISH	BM, MOZART BLUE 1665	
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10	EXTERIOR GRADE PAINT ON 3" DIAMETER GALVANIZED STEEL COLUMNS, MATTE FINISH	WHITE	
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LIGHT	ING		
20	2 LINEAR WHITE STRIPS WITH LENS ON A DIMMER	3000 K	
21	4" X 4" LED LIGHT	3000 K, WHITE LENS	
22	DECORATIVE WALL SCONCE	3000 K	
23	ILLUMINATED SIGNAGE		
24	3x12 SS LED SURFACE MOUNTED DOWNLIGHT	3000 K	

	SPECIAL INSTRUCTIONS
Α	TYPICAL WALL PLANE, 0.00 (6" EIFS)
В	+6" PROJECTING FROM 'A' PLANE
С	-1" RECESSED FROM 'A' PLANE
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APPROVAL IN REGARDS, ESPECIALLY AS IT PERTAINS TO STUCCO COLORS.



3 2023-02-08 ISSUED FOR MINOR VARIANCE SUB. 2 2022-12-09 ISSUED FOR SPA 2022-10-25 ISSUED FOR MINOR VARIANCE SUB.

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No. Date: Issue/Revision

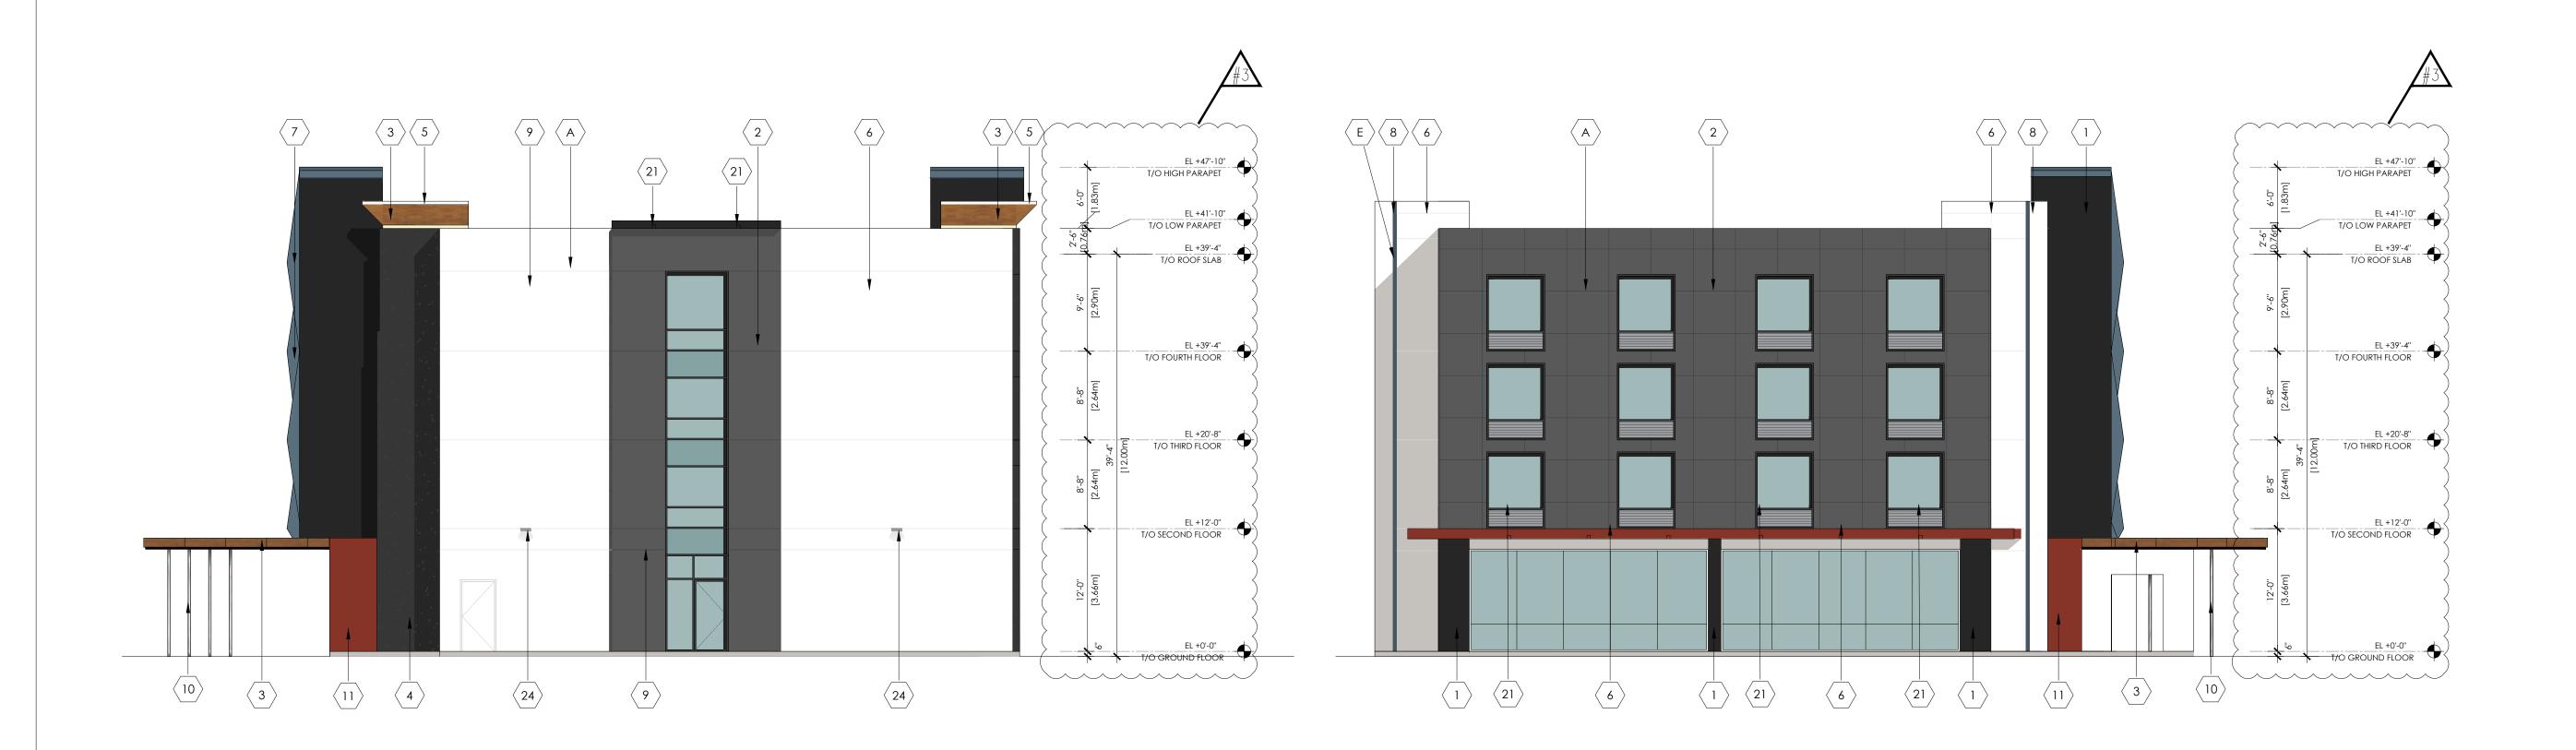Drawing Issues/Revisions:

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WORK IN PROGRESS



Architect's Stamp



HOLIDAY INN OTTAWA

140 Lusk St, Ottawa, ON

PROPOSED EAST & WEST ELEVATIONS

Drawn By: Design By: S.F.

1/8"=1'-0" 22-10-15 22-027

A.302a

Approved By:

Project No.:

A.M.





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WORK IN PROGRESS



Architect's Stamp

HOLIDAY INN OTTAWA

140 Lusk St, Ottawa, ON

Sheet Title:

PROPOSED NORTH ELEVATION

Drawn By: Design By: S.F. M.A. 1/8"=1'-0" 22-10-15 22-027

A.303

Approved By:

Project No.:


A.M.

	EXTERIOR FINISH SCHEDULE		
	MATERIAL/FINISH	COLOR	NOTES
EIFS			
1	EIFS BY CORNERPOINT OR EQUIVALENT, SMOOTH FINISH	BLACK	
2	EIFS BY CORNERPOINT OR EQUIVALENT, SANDSTONE FINISH	BM, KENDALL CHARCOAL HC-166	
3	WOOD VENEER & EPOXY OVER EIFS SYSTEM, BY CORNER POINT	TIMBER TEAK EQUIVALENT	
4	EIFS BY CORNERPOINT OR EQUIVALENT, GEMSTONE FINISH	BLACK MAINE	
5	EIFS BY CORNERPOINT OR EQUIVALENT, METALLIC FINISH	WHITE DOVE, BM OC 151	
6	EIFS BY CORNERPOINT OR EQUIVALENT, SMOOTH FINISH	WHITE DOVE, BM OC 151	
7	EIFS PANEL BY DURABOND OR EQUIVALENT, SANDSTONE FINISH	BM, MOZART BLUE 1665	
8	EIFS BY CORNERPOINT OR EQUIVALENT, SMOOTH METALLIC FINISH	BM, FIELD STONE 1558	
9	EIFS ¾" REVEAL		
10	EXTERIOR GRADE PAINT ON 3" DIAMETER GALVANIZED STEEL COLUMNS, MATTE FINISH	WHITE	
11	EIFS BY CORNERPOINT OR EQUIVALENT, SMOOTH FINISH	BM, Classic Burgundy HC-182	
12	STAC-BOND ALUMINUM COMPOSITE PANEL, NATURAL MIRROR FINISH	STB-M01	
LIGHT	ING		
20	2 LINEAR WHITE STRIPS WITH LENS ON A DIMMER	3000 K	
21	4" X 4" LED LIGHT	3000 K, WHITE LENS	
22	DECORATIVE WALL SCONCE	3000 K	
23	ILLUMINATED SIGNAGE		
24	3x12 SS LED SURFACE MOUNTED DOWNLIGHT	3000 K	

	SPECIAL INSTRUCTIONS
Α	TYPICAL WALL PLANE, 0.00 (6" EIFS)
В	+6" PROJECTING FROM 'A' PLANE
С	-1" RECESSED FROM 'A' PLANE
D	-2" RECESSED FROM 'A' PLANE
E	-3" RECESSED FROM 'A' PLANE
F	-4" RECESSED FROM 'A' PLANE

GENERAL NOTES:

- 1. ALL GRILLS IN EXTERIOR ELEVATION PAINTED TO MATCH ADJACENT COLOR.
- 2. SAMPLES OF ALL EXTERIOR FINISHES AND COLORS SHOULD BE SUBMITTED TO ARCHITECT FOR REVIEW AND APPROVAL BEFORE PROCEEDING WITH CONSTRUCTION
- 3. CM/BUILDER SHALL PROVIDE ACTUAL SAMPLE FINISHES ON EXTERIOR WALLS FOR OWNERSHIP APPROVAL BEFORE WORK COMMENCES ON FINAL EXTERIOR FINISHES REGARDLESS OF ARCHITECT'S OR OWNERSHIP'S EARLIER SAMPLE APPROVAL IN REGARDS, ESPECIALLY AS IT PERTAINS TO STUCCO COLORS.
- 4. FOR FIELD APPLIED EIFS, CM/GC TO PROVIDE SHOP DRAWING INDICATING ALL EXTERIOR MECHANICAL PENETRATION AS IT PERTAINS TO THEIR SIZE/LOCATION & FINISH/COLOR

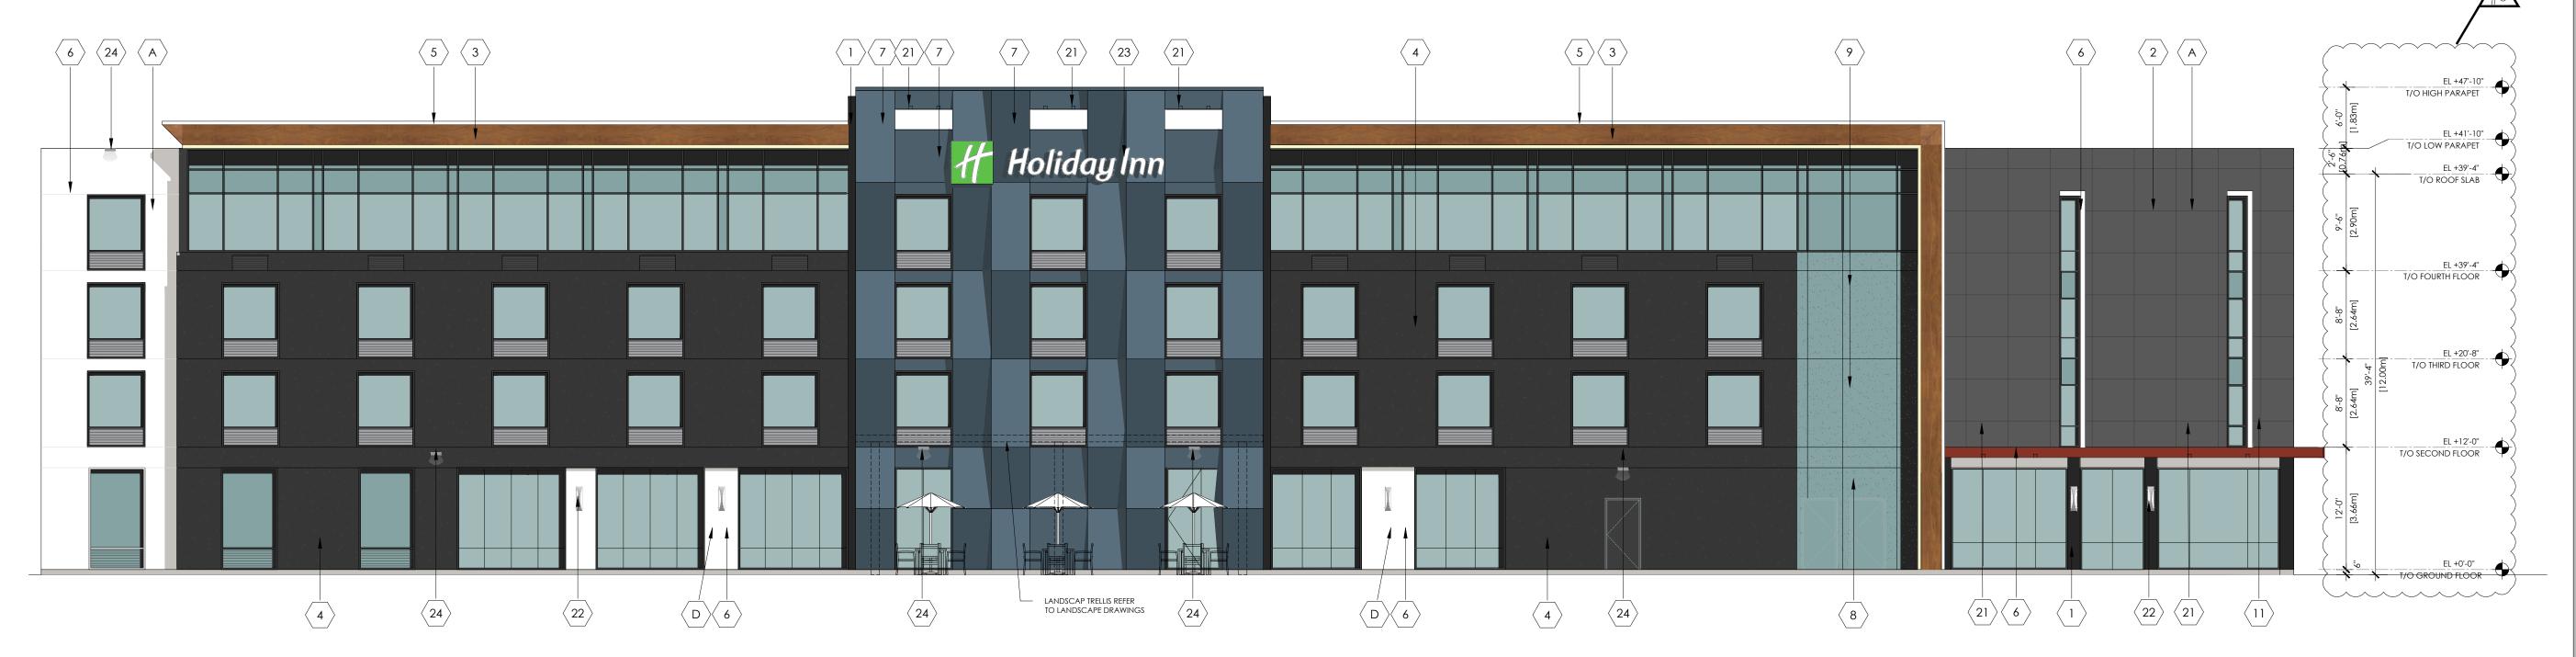

Key Plan:

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3 | 2023-02-08 | ISSUED FOR MINOR VARIANCE SUB.

1 2022-10-25 ISSUED FOR MINOR VARIANCE SUB.

2 2022-12-09 ISSUED FOR SPA

No. Date: Issue/Revision

Drawing Issues/Revisions:

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