

MontgomerySisam

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ARCH CORP LONG TERM CARE ORLEANS

1161 OLD MONTREAL RD, ORLEANS, ON. K4A 3N6

RE-ISSUED FOR SITE PLAN CONTROL APPLICATION & ZONING BY-LAW AMENDMENT JANUARY 27, 2023

Г			
TYPICAL ABBREVIATION			
A/D A/HK A/PNL A/S AB ABLK ACB	ACCESS DOOR (HINGED APRON HOOK ACCESS PANEL (NON-H ADJUSTABLE SHELF AIR BARRIER ARCHITECTURAL BLOCK ACOUSTIC BAFFLE		

ACBLK

ACI ACP

ACR

ACS

ACT

ADD

ADJ

ADO

ADO/M

ADO/P

ADT

AGG

ALC/D

ALUM

ALUMB

BPD

BPR

BRK

BW

BSMT

AFF

ACCESS DOOR (HINGED) APRON HOOK	C/C C/T	CENTRE TO CENTRE CLAY TILE (BLOCK)
ACCESS PANEL (NON-HINGED) ADJUSTABLE SHELF	C/ROD C/TRK	CURTAIN ROD CURTAIN TRACK
AIR BARRIER	C/TKK	COMPLETE WITH
ARCHITECTURAL BLOCK		CHART RACK
ACOUSTIC BAFFLE		COMPRESSED AIR
ACOUSTIC BLOCK	CB	CATCH BASIN
AMERICAN CONCRETE INSTITUTE	CB/SV	INTEGRATED/PRE-FAB COVE BA
ALUMINUM COMPOSITE PANEL		CHALKBOARD PAINT
ACRYLIC	_	CHEMICAL DISPENSING UNIT
ADULT CHANGE STATION	CEM	CEMENT
ACOUSTIC PANEL CEILING		CEMENTITIOUS BOARD
AREA DRAIN		CEMENT FINISH
ADDENDUM	CEM/PLAS	CEMENT PLASTER
ADJUSTABLE	CG	CORNER GUARD
AUTOMATIC DOOR OPERATOR	CGSB	CANADIAN GENERAL STANDARD
AUTOMATIC DOOR OPERATOR - MOTION DETECTOR	CH	COAT HOOK
AUTOMATIC DOOR OPERATOR - PUSH PLATE	CH/RL	CHAIR RAIL
ACOUSTIC DOOR TREATMENT	CIP	CAST-IN-PLACE
ACCESS FLOORING	CIR	CIRCULATION
AGGREGATE	CJ	CONSTRUCTION JOINT
ABOVE FINISHED FLOOR	CKB	CHALKBOARD
ALCOHOL DISPENSER		CORK TILE
ALUMINUM	-	CENTRE LINE
ALUMINUM BASE	CLG	CEILING
AUTOMATED MEDICATION DISPENSING UNIT	CLR	CLEAR
ANTI-MICROBIAL HAND RINSE	CLR/GL	CLEAR GLASS
ACOUSTIC METAL PANEL	CLS	CLOSURE
ANNUNCIATOR PANEL	CMU	CONCRETE MASONRY UNIT
ANODIZED	COL	COLOUR
AMERICAN NATIONAL STANDARDS	COL/CON	COLOURED CONCRETE
ACOUSTIC PANEL	COLN	COLUMN

COMM

CONC

CON/FL

CONT

CPT

CR

CRL

CRCI

CSCI

CRK CSA

CSS CT CTJ CUH CUP

CABINET UNIT HEATER

CUPBOARD

INDICATES

DRAWING

INDICATES

LEVEL 3 9500

REFERENCE TO

DETAIL DRAWING

PROJECT ELEVATION

GEODETIC ELEVATION

ROOM NAME & ROOM NUMBER TAG

ROOF TYPE

WINDOW TYPE

MATERIAL TAG

REVISION NUMBER

CURTAIN WALL TYPE

REFERENCE TO A

SIMILAR DETAIL

CONTROL JOINT

CONSTR CONSTRUCTION

/ (LOIVID	ALCOMINATION BATCE
AMD	AUTOMATED MEDICATION DISPENSING UNIT
AMHR	ANTI-MICROBIAL HAND RINSE
AMP	ACOUSTIC METAL PANEL
ANNUN	ANNUNCIATOR PANEL
ANOD	ANODIZED
ANSI	AMERICAN NATIONAL STANDARDS
AP	ACOUSTIC PANEL
APPROX	APPROXIMATE
AR	ACCENT RAIL
ASB	ASBESTOS
ASTM	AMERICAN SOCIETY FOR TESTING AND MATERIALS
ASV	ANTI-SLIP VINYL
AVB	AIR BARRIER & VAPOUR RETARDER
AVS	AUDIO AND VISUAL SIGNAL DEVICE
AWI	ARCHITECTURAL WOODWORK INSTITUTE
AWMAC	ARCHITECTURAL WOODWORK MANUFACTURERS
	ASSOCIATION OF CANADA
AWP	ACOUSTIC WOOD PANEL
B/PL	BASE PLATE
BAS	BUILDING AUTOMATION SYSTEM
BB	BLACK BOARD

ACCOUNT WOOD I AINEE
BASE PLATE BUILDING AUTOMATION SYSTEM BLACK BOARD BOTTOM OF CURB BEDROOM BEDROOM GENERAL BEDROOM SPECIAL
BARRIER-FREE
BARRIER-FREE ROBE HOOK
BACKER BOARD
BORE HOLE
BUSHHAMMERED CONCRETE
BUILKHEAD
BED LOCATOR
BLOCK
BUILDING
BULLNOSE
BOLLARD

- INDICATES SECTION / DETAIL NUMBER

TO A SIMILAR DETAIL

- INDICATES DRAWING

BUILDING SECTION REFERENCE

WALL SECTION REFERENCE

DETAIL REFERENCE

BUILDING ELEVATION REFERENCE

INTERIOR ELEVATION REFERENCE

- INDICATES ELEVATION #

INDICATES DRAWING

MILLWORK TAG

SHEET NUMBER

INDICATES REFERENCE

DRAWING

SYMBOL LEGEND

DEDITOOM CENERAL	001	001 207 (102
BEDROOM SPECIAL	CUP/D	CUP DISPENSER
BARRIER-FREE	CW	CURTAIN WALL
BARRIER-FREE ROBE HOOK		
BACKER BOARD	D	DATA
BORE HOLE	D/P	DIAPER PAIL
BUSHHAMMERED CONCRETE	DA	DOOR ALARM
BUILKHEAD	DB	DOOR BUZZER
BED LOCATOR	DBL	DOUBLE
BLOCK	DC	DOOR CONTACT
BUILDING	DCS	DIAPER CHANGE STATION
BULLNOSE	DECF	DECORATIVE FINISH
BOLLARD	DEPT	DEPARTMENT
BEDPAN DISINFECTOR	DF	DRINKING FOUNTAIN
BED PAN RACK	DFP	DOOR FRAME PROTECTION
BUMP RAIL	DFP-F	DOOR FRAME PROTECTION FULL HEIGHT
BRICK	DFP-H	DOOR FRAME PROTECTION HALF HEIGHT
BASEMENT	DIA	DIAMETER
BRICK VENT	DIS	DISINFECTOR
BOTTOM OF WALL	DL	DOME LIGHT
	DLC	DELAYED CLOSING

	CENTRE TO CENTRE CLAY TILE (BLOCK) CURTAIN ROD CURTAIN TRACK COMPLETE WITH CHART RACK COMPRESSED AIR CATCH BASIN INTEGRATED/PRE-FAB COVE BASE CHALKBOARD PAINT CHEMICAL DISPENSING UNIT CEMENT	DN DO DP DP-F DP-H DP-K DS DSB DV DW DWG
;	CEMENTITIOUS BOARD CEMENT FINISH CEMENT PLASTER CORNER GUARD CANADIAN GENERAL STANDARDS COAT HOOK CHAIR RAIL CAST-IN-PLACE CIRCULATION CONSTRUCTION JOINT CHALKBOARD CORK TILE CENTRE LINE CEILING CLEAR CLEAR GLASS CLOSURE CONCRETE MASONRY UNIT COLOUR COLOURED CONCRETE COLUMN COMMUNICATION COMMUNICATION CONSTRUCTION CONSTRUCTION CONCRETE CONCRETE COLUMN COMMUNICATION CONCRETE CONC	E/O E/PT E/TER EAA ECS EF EIFS ELV ELEV EMERG EMP ENT EPH EPX EPXS EQ EX/ST EXAM EXP EXT EW
	CRASH HAND RAIL CONTRACTOR REMOVED, CONTRACTOR INSTALLED	F/GL

DP-K DS DSB DV DW DWG	
E/TER EAA ECS EF EIFS EJ EL ELV ELEC ELEV EMERG	EMERGENCY CALL SYSTEM EXHAUST FAN (REFER TO MECH) EXTERIOR INSULATION AND FINISH EXPANSION JOINT ELEVATION (ABOVE DATUM) ELEVATION (VIEW) ELECTRICAL ELEVATOR EMERGENCY EMERGENCY POWER ENTRANCE ELECTRICAL PANEL ELECTRIFIED PANIC HARDWARE EPOXY FLOOR EPOXY FLOOR

DOWN

DOOR OPERATOR

DOOR PROTECTION

DOOR PROTECTION FULL HEIGHT

DOOR PROTECTION HALF HEIGHT

0/101 1111 2/102		_, ,
CIRCULATION	EL	ELEVATION (ABOVE DA
CONSTRUCTION JOINT	ELV	ELEVATION (VIEW)
CHALKBOARD	ELEC	ELECTRICAL
CORK TILE	ELEV	ELEVATOR
CENTRE LINE	EMERG	EMERGENCY
CEILING	EMP	EMERGENCY POWER
CLEAR	ENT	ENTRANCE
CLEAR GLASS	EP	ELECTRICAL PANEL
CLOSURE	EPH	ELECTRIFIED PANIC HA
CONCRETE MASONRY UNIT	EPX	EPOXY FLOOR
COLOUR	EPXS	EPOXY FLOOR SYSTEM
COLOURED CONCRETE	EQ	EQUAL
COLUMN	ER	ELECTRICAL RECEPTA
COMMUNICATION	ES	ELECTRIC STRIKE
CONCRETE	EX	EXISTING
CONCRETE FLOOR	EX/C	EXPOSED CONCRETE
CONSTRUCTION	EX/ST	EXPOSED STRUCTURE
CONTINUOUS	EXAM	EXAMINATION
CARPET	EXP	EXPOSED
CARD READER	EXT	EXTERIOR
CRASH RAIL	EW	EYE WASH
CRASH HAND RAIL		
CONTRACTOR REMOVED, CONTRACTOR INSTALLED	F/GL	
CONTRACTOR SUPPLIED, CONTRACTOR INSTALLED	F/MIR	
COAT RACK	F/TGL	FROSTED TEMPERED (
CANADIAN STANDARDS ASSOCIATION	F/O	FACE OF
CLINIC SERVICE SINK	F/S	
CERAMIC TILE	F/WX	FIBERGLASS WALL CO
CONTROL IOINT		ELLIID ADDLIED ELOOD

KEYNOTE

GRID LINE

CONSTRUCTION

INDICATES DOOR

- INDICATES CEILING

- INDICATES CEILING HEIGHT (mm) A.F.F.

WALL / PARTITION TYPE

CENTRELINE MARK

1200 DIMENSION

NUMBER

ASSEMBLY TYPE

SPEC.#

ITEM NAME

	EXP EXT EW	EXPOSED EXTERIOR EYE WASH
ED ED	F/GL F/MIR F/TGL F/O F/S F/WX FAF FD FE FFE FFL FG FH FHC FIN FL FLS	FROSTED TEMPERED GLASS FACE OF FOLDING CHART SHELF FIBERGLASS WALL COVERING FLUID APPLIED FLOORING FLOOR DRAIN FIRE EXTINGUISHER (SURFACE MOUNTED FIRE EXTINGUISHER CABINET FINISH FLOOR ELEVATION FORCE FLOW HEATER FINISH FLOOR FLOOR GRILLE

ГС	FIRE EXTINGUISHER (SURFACE MICUNTED)
FEC	FIRE EXTINGUISHER CABINET
FFE	FINISH FLOOR ELEVATION
FFH	FORCE FLOW HEATER
FFL	FINISH FLOOR
FG	FLOOR GRILLE
FGL	FLOAT GLASS
FH	FIRE HYDRANT
FHC	FIRE HOSE CABINET
FIN	FINISH
FL	FLOOR
FLS	FLOOR SCRUBBER
FOB	FACE OF BRICK
FOS	FACE OF STEEL
FP	FRAME PROTECTION
FPL	FILLER PANEL
FR	FLOOR RECEPTACLE
FRT	FIRE RETARDANT / FIRE RATED
FRGL	FIRE-RATED GLASS
FRP	FIBERGLASS REINFORCED PLASTIC PANELS
FRPL	FIREPLACE

EVATION TER	
ΕT	
3	
ON	
CLE / FIRE RATED S FORCED PLASTIC PANELS	
FURUED FLAGIIU PANELO	

FRR

FSS

L/H

KILOPASCALS

KEY SWITCH

LEFT HAND

LAB LABORATORY

GF

FIRE RESISTANCE RATING

FOLDING SHOWER SEAT

FIRE SEPARATION

GAUGE

LAM

LD/GL

LEX/GL

LGL

LKR

LTGL

LVR

M/PNL

M/RK

MATL

MARB

MECH

MGPNL

MHO

MIN

MISC

MOL

MOLTC

MPa

MRL-CH

MRL-FL

MRL-SS

MTBL

MTL

MWO

MPW

N/A

NBC

ND

MAX

LINO

LAMINATE / LAMINATED

LAMINATED GLASS BALUSTRADE

LAMINATED TEMPERED GLASS

LAVATORY

LEADED GLASS

LEXAN GLAZING

LIGHT FIXTURE

LINOLEUM

LOOSE LINTEL

LIGHT STANDARD

LUXURY VINYL TILE

LOCKER

LOUVRE

METRE

MOP BRACKET

MAKE GOOD

METAL PANEL

MATERIAL

MARBLE

MAXIMUM

MEMORY BOX

MESH/CLG MESH CEILING

MET/LIN METAL LINEAR

MICROWAVE OVEN

NOT APPLICABLE

NARCOTIC CABINET

NURSE CALL LIGHT

NOT IN CONTRACT NIGHT LIGHT

NOMINAL PIPE SIZE

NAPKIN RECEPTOR

NUMBER

NTS NOT TO SCALE

NAPKIN DISPENSER

NON-FREEZE HOSE BIE

NATIONAL BUILDING CODE

NURSE CALL EMERGENCY STATION

METAL WALL PANEL

MILLWORK

NATURAL

NURSE CALL

MAGAZINE RACK

LAMINATED GLASS

GWB/IR	GAUGE GALVANIZED GRAB BAR GLAZED BALUSTRADE SYSTEM GLOVE DISPENSER GENERIC ACCESSORY GLASS FILM GROUND FAULT CIRCUIT INTERRUPTERS GLASS (FLOAT) GLASS MOSIAC TILE GLASS BLOCK GYPSUM BOARD GYPSUM BOARD, ABUSE RESISTANT GYPSUM BOARD, MOISTURE RESISTANT	
HD HDN/CON HEW HM HN/D HO HO-CLR HO-MAG HOR HPC HR HR/DR HR/DR HRL HS HSGL HSKP HST HT HWC HWU	HOUR HAIR DRYER HAND RAIL HAND SANITIZER HEAT STRENGTHENED GLASS HOUSEKEEPING HOOK STRIP (610mm, 3 HOOKS) HEIGHT	
IB IC ICS ID IGL IGU INSUL INT IP IV/T	INFORMATION BOARD INTERCOM INFANT CHANGE STATION INSIDE DIAMETER INTERIOR GLASS INSULATED GLASS UNIT INSULATION INTERIOR INTUMESCENT PAINT INTRAVENOUS TRACK	
JAN JAN/S JT	JANITOR JANITOR'S SHELF JOINT	
kg km KP	KILOGRAM KILOMETRE KEYPAD	

OAA OBC O/C OD OFF OGCA OL OPSS OR ORCI OSCI OSB OSOI OW/GL OWSJ	ASSOCIATION OF ARCHITECTS ONTARIO BUILDING CODE ON CENTRE OUTSIDE DIAMETER OFFICE ONTARIO GENERAL CONTRACTORS ASSOCIATION OCCUPIED INDICATOR ONTARIO PROVINCIAL STANDARD SPECIFICATION OPERATING ROOM OWNER REMOVED, CONTRACTOR INSTALLED OWNER SUPPLIED, CONTRACTOR INSTALLED ORIENT STRAND BOARD OWNER SUPPLIED, OWNER INSTALLED ONE-WAY GLASS OPEN WEB STEEL JOISTS
P P/BRK P/CAB P/CT P/LKR PA PAP PB PC PCD PCD PCP PCT PD PEW PF PHL PGB	

P/BRK	PAPER BRACKET
P/CAB	PRESENTATION CAB
P/CT	PLASTER COATING
P/LKR	PURSE LOCKER
PA	PUBLIC AMENITIES
PAP	PREFINISHED ALUMI
PB	PUSH BUTTON
PC	PRECAST CONCRETI
PCD	PAPER CUP DISPENS
PCP	PRECAST CONCRETI
PCT	PORCELAIN TILE
PD	POCKET DOOR
PEW	PORTABLE EYE WAS
PF	PROTECTIVE FLOOR
PHL	PHYSICAL LOCK
PGB	PEGBOARD
PLAM	PLASTIC LAMINATE
PLAS	PLASTER
PLIFT	PATIENT LIFT
PL	PUSH TO LOCK
PLYWD	PLYWOOD
PM/RK	PAMPHLET/MAGAZIN
PORC	PORCELAIN
POSN	POSITION


	MANUAL BLINDS	PC
	MEDICINE CABINET	PCD
	MASK DISPENSER	PCP
	MECHANICAL	PCT
G	MESH CEILING	PD
	METAL LINEAR	PEW
	METAL FLASHING	PF
	MEDICAL GAS PANEL	PHL
	MANHOLE	PGB
	MASK HOLDER	PLAN
	MAGNETIC HOLD OPEN	PLAS
	MINIMUM	PLIF7
	MIRROR	PL
	MIRROR W/ SHELF	PLYV
	MISCELLANEOUS	PM/R
	MILLIMETRE	POR
	MAGNETIC LOCK	POSI
	MASONRY OPENING	PP
	MINISTRY OF LABOUR	PPE
	MINISTRY OF LONG TERM CARE	PPR
	MEGAPASCAL	PPT
	MOP HOLDER	PR
	MOBILE RESIDENT LIFT - CHARGER	PR/C
	MOBILE RESIDENT LIFT - FLOOR LIFT	PR/S
	MOBILE RESIDENT LIFT - SIT TO STAND	PR/P
	MOP SINK	PR.V
	MOTORIZED BLINDS	PRJ
	METAL	PROI


1 - 1 - 1 - 1 - 1	LIWOOD
PM/RK	PAMPHLET/MAGAZINE RACK
PORC	PORCELAIN
POSN	POSITION
PP	PUSH PLATE
PPE	PERSONAL PROTECTION EQUIPMENT
PPR	PEDESTAL PERIMETER RADIATOR
PPT	PARAPET
PR	PERIMETER RADIATOR
PR/C	PRIVACY CURTAIN & ROD
PR/SC	PROJECTION SCREEN
PR/PT	PRIME PAINT
PR.VEST	PRESSURIZED VESTIBULE
PRJ	PROJECTOR
PROF	PROFILE
PROJ	PROJECT
PS	PULL STATION
PT	PAINT
PTD	PAPER TOWEL DISPENSER
PTD/R	PAPER TOWEL DISPENSER/RECEPTOR
PTL	PUSH TO LOCK
PTO	PUSH TO OPEN
PTR	PAPER TOWEL RECEPTOR
PTS	PNEUMATIC TUBE STATION
PTS/R	PNEUMATIC TUBE RISER

PR/SC PR/PT PR.VEST	PRESSURIZED VESTIBULE
PRJ PROF	PROJECTOR PROFILE
PROJ	
PS	PULL STATION
PT	PAINT
PTD	PAPER TOWEL DISPENSER
PTD/R	PAPER TOWEL DISPENSER
PTL	PUSH TO LOCK
PTO	PUSH TO OPEN
PTR	PAPER TOWEL RECEPTOR
PTS	PNEUMATIC TUBE STATION
PTS/R	PNEUMATIC TUBE RISER
QRY	QUARRY TILE
R R/GL R/I	RADIUS REFLECTIVE GLASS ROUGH-IN

PS	PULL STATION
PT	PAINT
PTD	PAPER TOWEL DISPENSER
PTD/R	PAPER TOWEL DISPENSER/RECEPTOR
PTL	PUSH TO LOCK
PTO	PUSH TO OPEN
PTR	PAPER TOWEL RECEPTOR
PTS	PNEUMATIC TUBE STATION
PTS/R	PNEUMATIC TUBE RISER
QRY	QUARRY TILE
R	RADIUS
R/GL	REFLECTIVE GLASS
R/I	ROUGH-IN
R/S	ROD AND SHELF LINIT

PTO PTR PTS PTS/R	PUSH TO OPEN PAPER TOWEL RECEPTOR PNEUMATIC TUBE STATION PNEUMATIC TUBE RISER
QRY	QUARRY TILE
R R/GL R/I R/S	RADIUS REFLECTIVE GLASS ROUGH-IN ROD AND SHELF UNIT

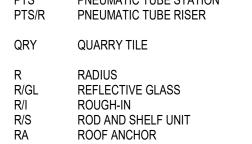

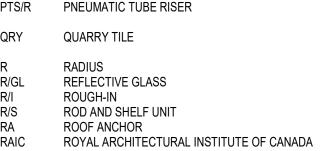

RRY TILE US ECTIVE GLASS GH-IN	STR STR/U SV SVC SW	STRUCTURAL STORAGE UNIT SHEET VINYL SPRINKLER VALVE CABINE SWITCH
AND SHELF UNIT	T/MIR	TRANSPARENT (ONE WAY
F ANCHOR	T/O	TOP OF
AL ARCHITECTURAL INSTITUTE OF CANADA	T&G	TONGUE AND GROOVE



SH/CD	SHOWER CADDY
SH/H	SHOWER HEAD
SH/R	SHOWER ROD AND CURTAIN
SH/S	SHOWER SEAT
SHCH	SHAMPOO CHAIR
SIM	SIMILAR
SLV	SLEEVE
SM	SQUARE METERS
SMM	SNOW MELT MANIFOLD
SND	SANITARY NAPKIN DISPOSAL
SNV	SANITARY NAPKIN VENDOR
SOE	SUPPORT OF EXCAVATION
SOG	SLAB-ON-GRADE
SP	SPANDREL PANEL
SPEC	SPECIFICATION
SPK	SPRINKLER
SPL	SPECIAL
SPL/S	SPECIALTY SHELF
SS	SOLID SURFACING MATERIAL
SSG	STRUCTURAL SILICONE GLAZED
SST	STAINLESS STEEL
SSS	STAINLESS STEEL SHELF
ST	STAIN
STL	STEEL
STN	STONE
STOR	STORAGE
STR	STRUCTURAL
STR/U	STORAGE UNIT
SV	SHEET VINYL

RESILIENT FLOOR BASE

REQUEST TO EXIT DEVICE

ROBE HOOK AND SHELF

RADIANT HEAT PANEL

ROUGH OPENING

ROLLER SHADE

REMOTE RELEASE

RESILIENT SHEET FLOOR

RESILIENT TILE FLOORING

RAIN WATER LEADER

SCRUB BRUSH HOLDER

SEALED CONCRETE

STEEL BOLLARD

SOLID CORE WOOD

SOAP DISPENSER

SOLID CORE

RESILIENT SHEET SAFETY FLOOR

RESIDENT WANDERING SYSTEM

SHARPS DISPOSAL CONTAINER

SPRINKLER CONTROL CABINET

SOUND ATTENUATION BATT (INSULATION)

RUBBER SHEET

RECEPTACLE

ROOF DRAIN

REFRIGERATOR

ROBE HOOK

RISER

ROOM

REVISION

RCPT

RD

REV

REX

RH/S RHP

RM

RO

RS

RSF

RSSF RTF

RWL

RWS

S/BRH

S/CON SAB

S/C

SB

SCC

SD

SCW

VHD VIF VM VNL VR VSD VTC	VISOR HOLDER VERIFIED IN FIELD VENDING MACHINE VINYL SHEET VAPOUR RETARDER VINYL ELECTRO STATIC DISSIPATIVE TILE VEHICULAR TRAFFIC COATING
W/COV WB WC WD WDF WDP WDS	WALL COVER WHITEBOARD WATER CLOSET / WASHROOM WOOD (SOLID) WOOD FLOORING WOOD PANEL WOOD SLAT
WIN/C WM WP WPF WPR WR WRB	WINDOW COVERING WIRE MESH WALL PROTECTION WATERPROOF FLOORING WALL-MOUNTED PERIMETER RADIATOR WASTE RECEPTACLE WEATHER RESISTANT BARRIER WOOD VENEER

TACKBOARD

TB/S

TBD

TBR

TEMP

TEX FIN

TER

TGL

TI/GL

TID

TOC

TOS

TOSTL

TOW

TPGL

TRAN

TRD

TSD

TV/BRK

TWSI

TYP

U/C

ULC

UNO

VERT

VEST

VDM

UR

TACKBOARD STRIP

TO BE DETERMINED

TOILET BACK REST

TELEPHONE OUTLET

TEXTURED FINISH

TEMPERED GLASS

THERMOSTAT

TINTED GLASS

TAG ID SYSTEM

TOP OF CURB

TOP OF SLAB

TOP OF STEEL

TOP OF WALL

TOWEL ROD

TREAD

TYPICAL

URINAL

UTILITY

VERTICAL

VESTIBULE

UNDERCUT

TRANSPARENT

ALUMINUM TRACK

TRANSITION STRIP

TOILET SEAT DISPENSER

TELEVISION OUTLET

TELEVISION BRACKET

TOWEL WARMER

UNDERSIDE (OF)

TO MATCH EXISTING

TOILET/SHOWER PARTITION

TEMPERED PATTERNED GLASS

TACTILE WARNING SURFACE INDICATOR

UNDERWRITERS' LABORATORIES OF CANADA

UNDERCOUNTER REFRIGERATOR

UNLESS NOTED OTHERWISE

VINYL COMPOSITE TILE

VENDING MACHINE

TOILET PAPER DISPENSER

TONGUE DEPRESSOR HOLDER

TRENCH DRAIN

TEMPERED

TERRAZZO



MBER	SHEET NAME			
	COVERSHEET			
	SURVEY			
	GENERAL INFORMATION			
	SITE CONTEXT PLAN AND PROJECT STATISTICS			
	SITE PLAN			
	SITE DETAILS			
	SITE DETAILS			
	FLOOR PLAN - LEVEL B1			
	FLOOR PLAN - LEVEL 01			
	FLOOR PLAN - LEVEL 02-04			
	ROOF PLAN	40	0000104107	DE 10
	EXTERIOR ELEVATIONS	12	2023/01/27	RE-IS
	COURTYARD ELEVATIONS	8	2022/08/19	RE-IS
•	BUILDING SECTIONS	0	2022/00/19	APPL
	PERSPECTIVES	#	date:	· · · · -

MontgomerySisam

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-ISSUED FOR SITE PLAN CONTROL PLICATION & ZONING BY-LAW AMENDMENT -ISSUED FOR SITE PLAN CONTROL LICATION & ZONING BY-LAW AMENDMENT revisions

> All drawing and specifications are the property of the architect. The contractor shall verify all dimensions and information on site and report any discrepancy to architect before

Arch Corp - Orleans

1161 OLD MONTREAL RD, ORLEANS ON, K4A 3N6

GENERAL INFORMATION


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drawing number:

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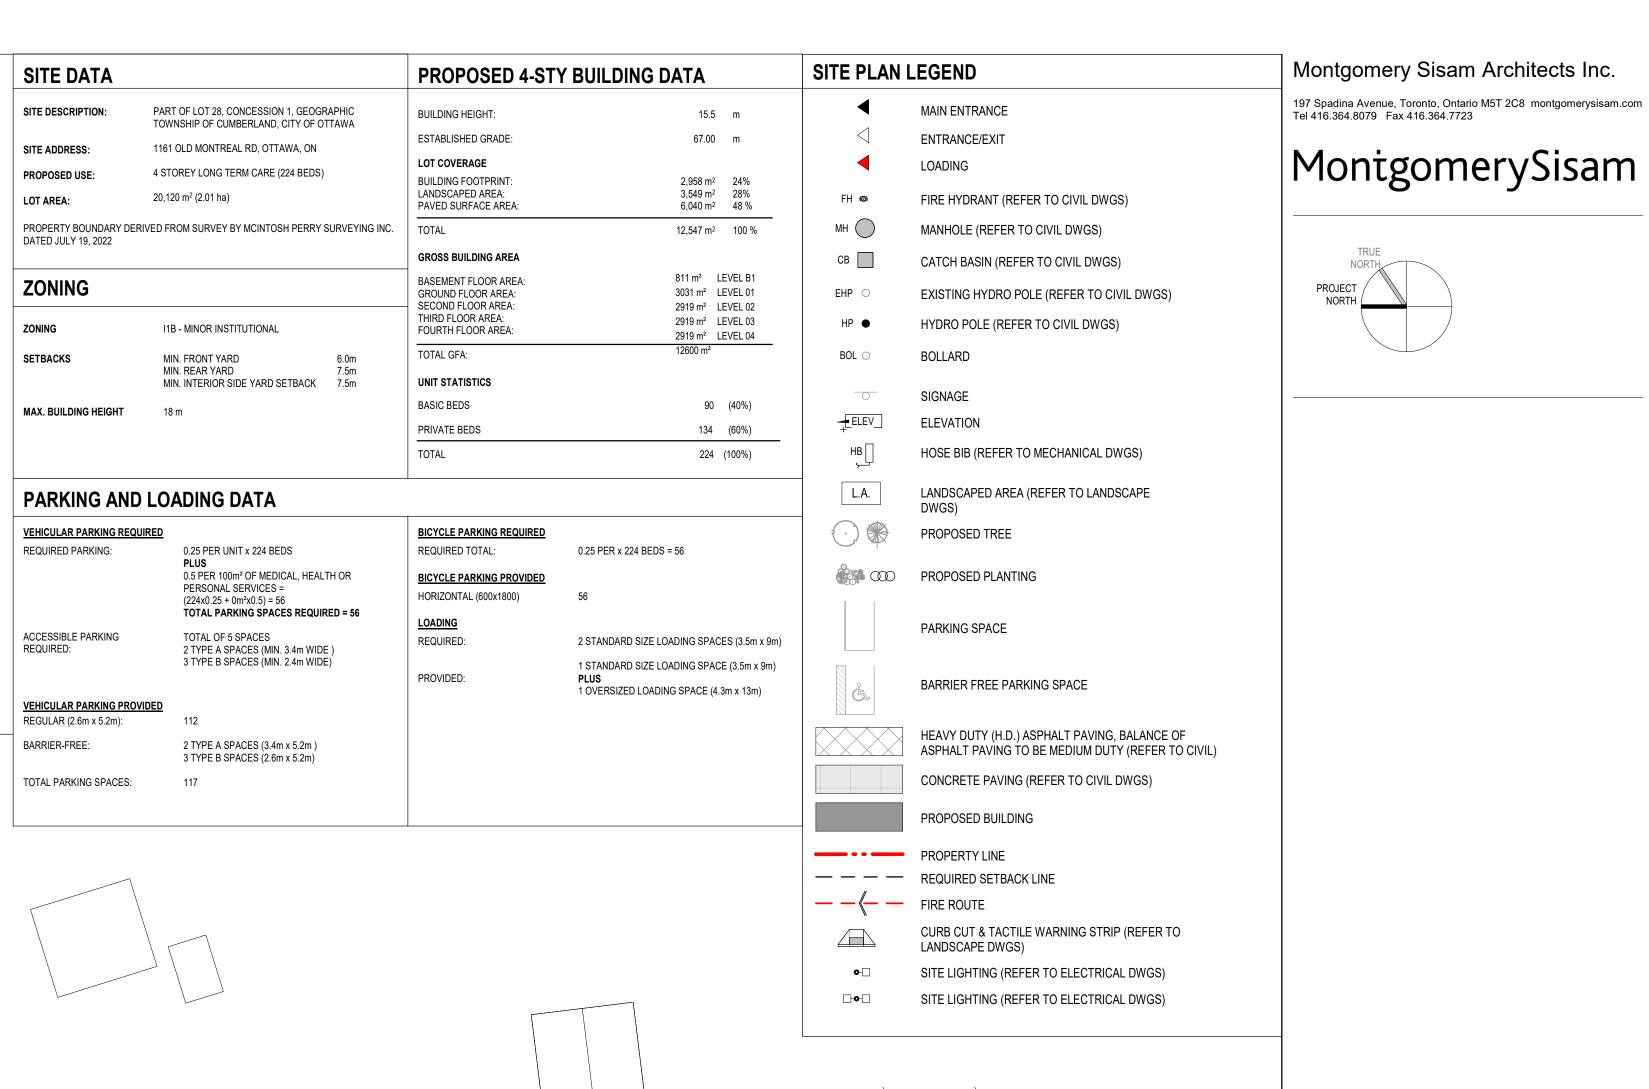
2 <(A410)>

CABINET TYPE WIDTH DEPTH



OUTDOOR ROOFTOP

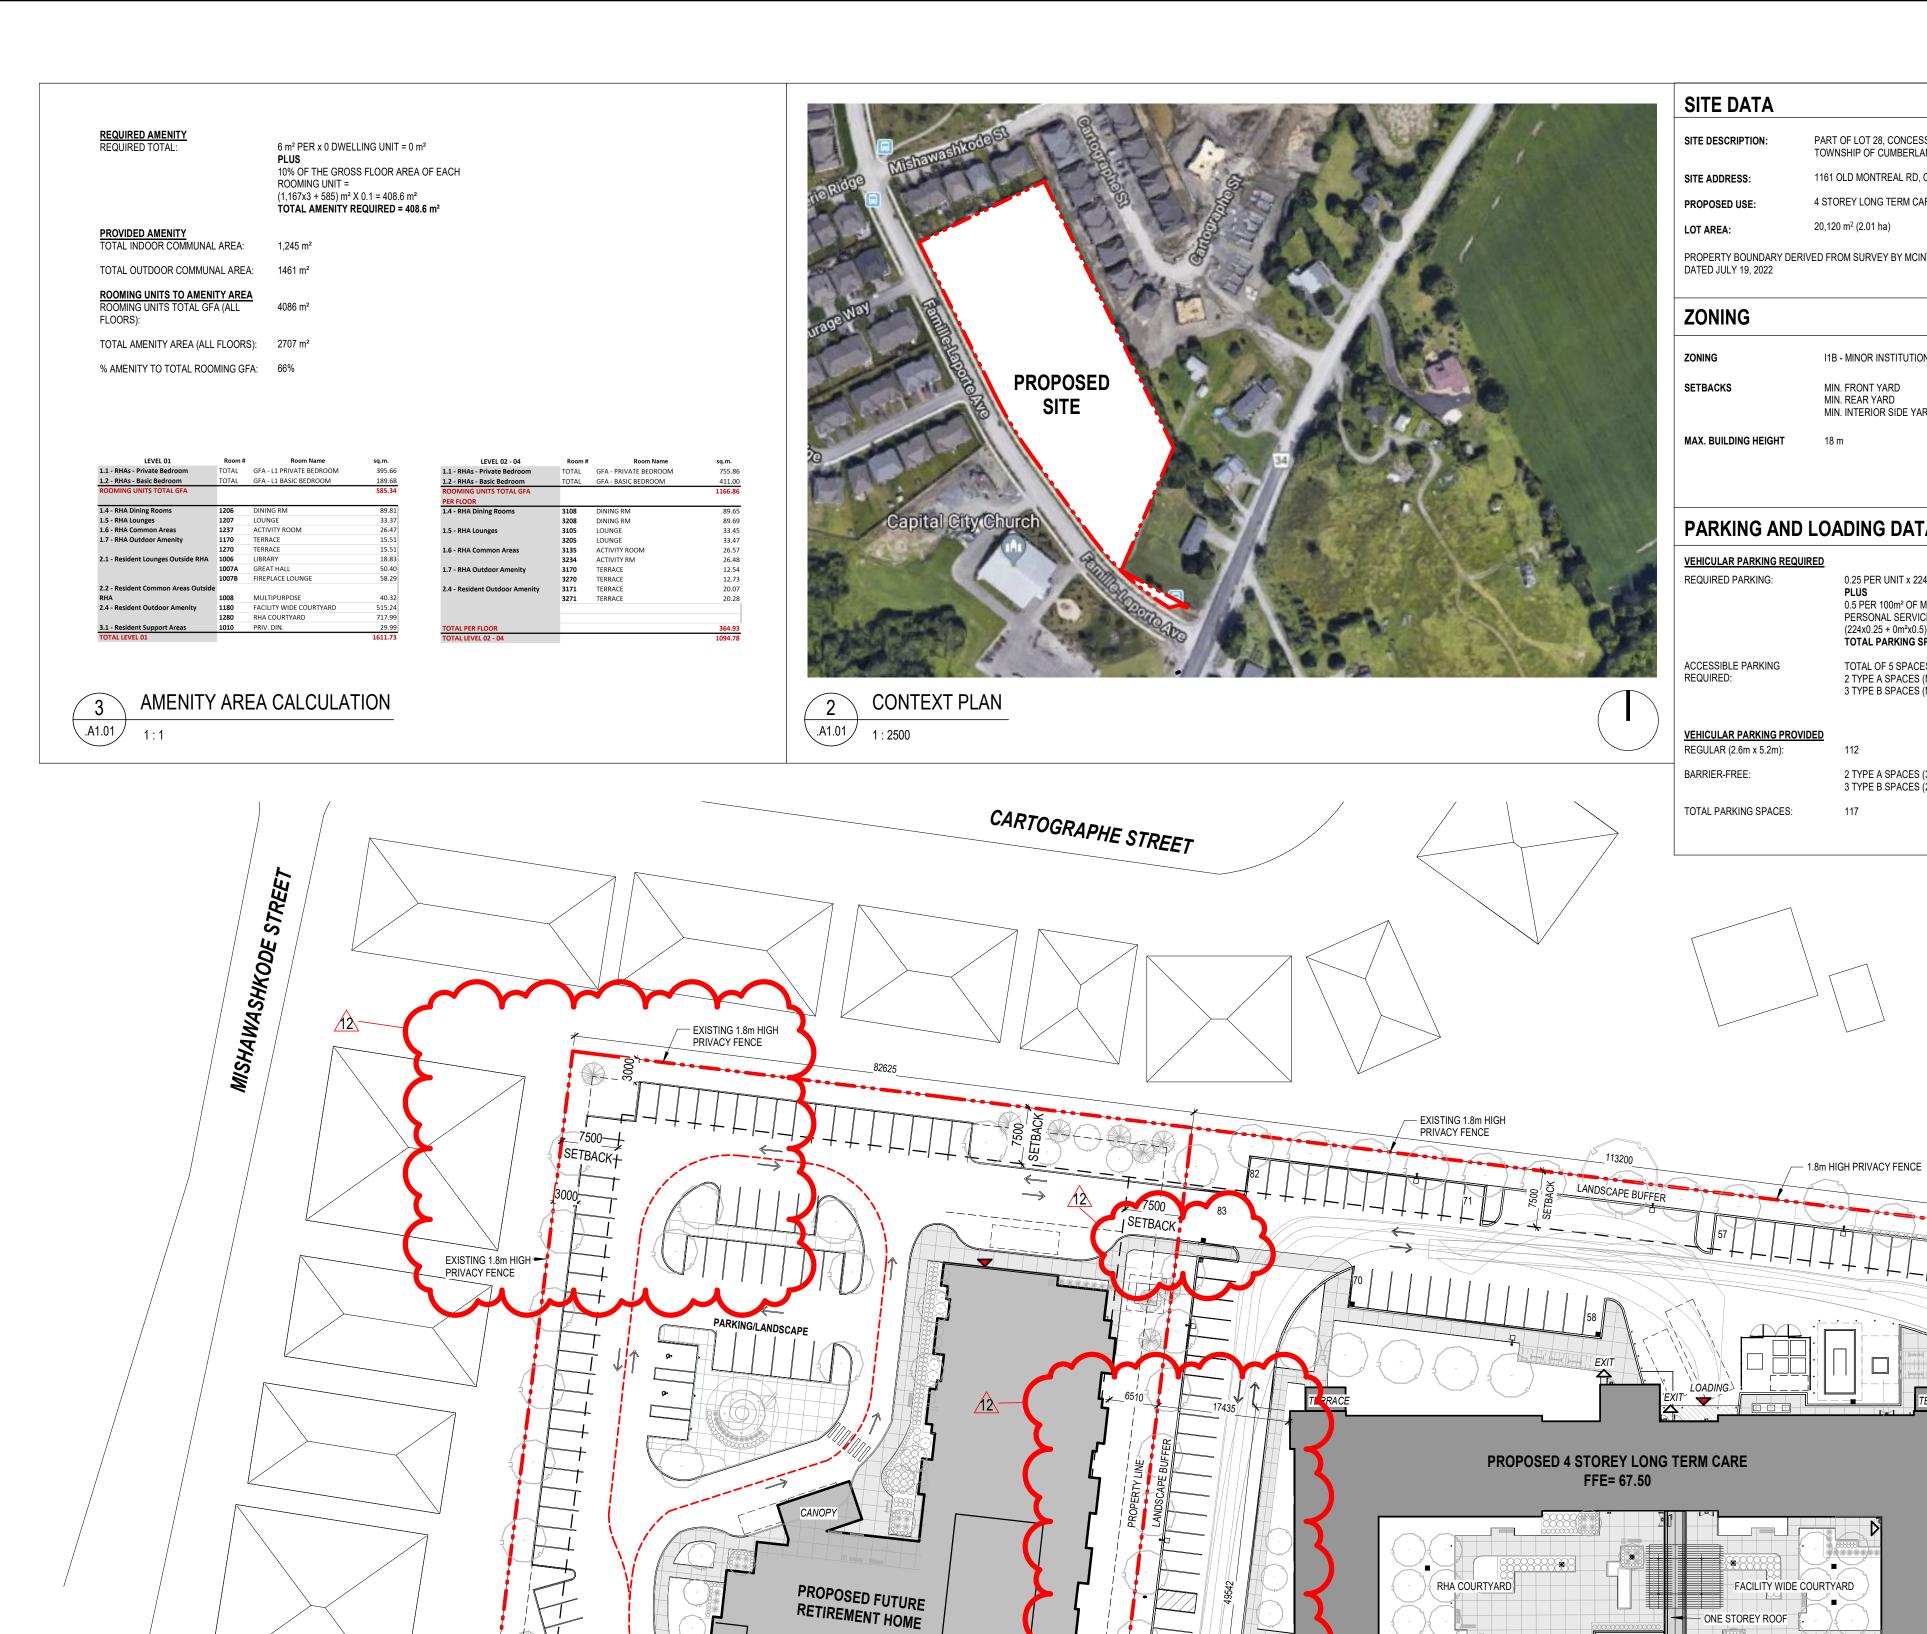WAY



1.8m HIGH PRIVACY FENCE

- ARMOUR STONE WALL (REFER TO LANDSCAPE)

FAMILLE-LAPORTE AVENUE

CAPITAL CITY CHURCH

CROWN OF ROAD

12 2023/01/27 RE-ISSUED FOR SITE PLAN CONTROL MSA APPLICATION & ZONING BY-LAW AMENDMENT

8 2022/08/19 RE-ISSUED FOR SITE PLAN CONTROL MSA APPLICATION & ZONING BY-LAW AMENDMENT

date: revision: by:
revisions

Arch Corp - Orleans

All drawing and specifications are the

architect before

property of the architect.

verify all dimensions and information on site and

report any discrepancy to

1161 OLD MONTREAL RD, ORLEANS ON, K4A 3N6


EXISTING RETAINING WALL

SITE CONTEXT PLAN AND PROJECT STATISTICS

scale: As indicated drawn by: MSA reviewed by: MSA job number: 21024 plot date: 21-08-27

plot date: 21-08-27
drawing number:

.A1.01

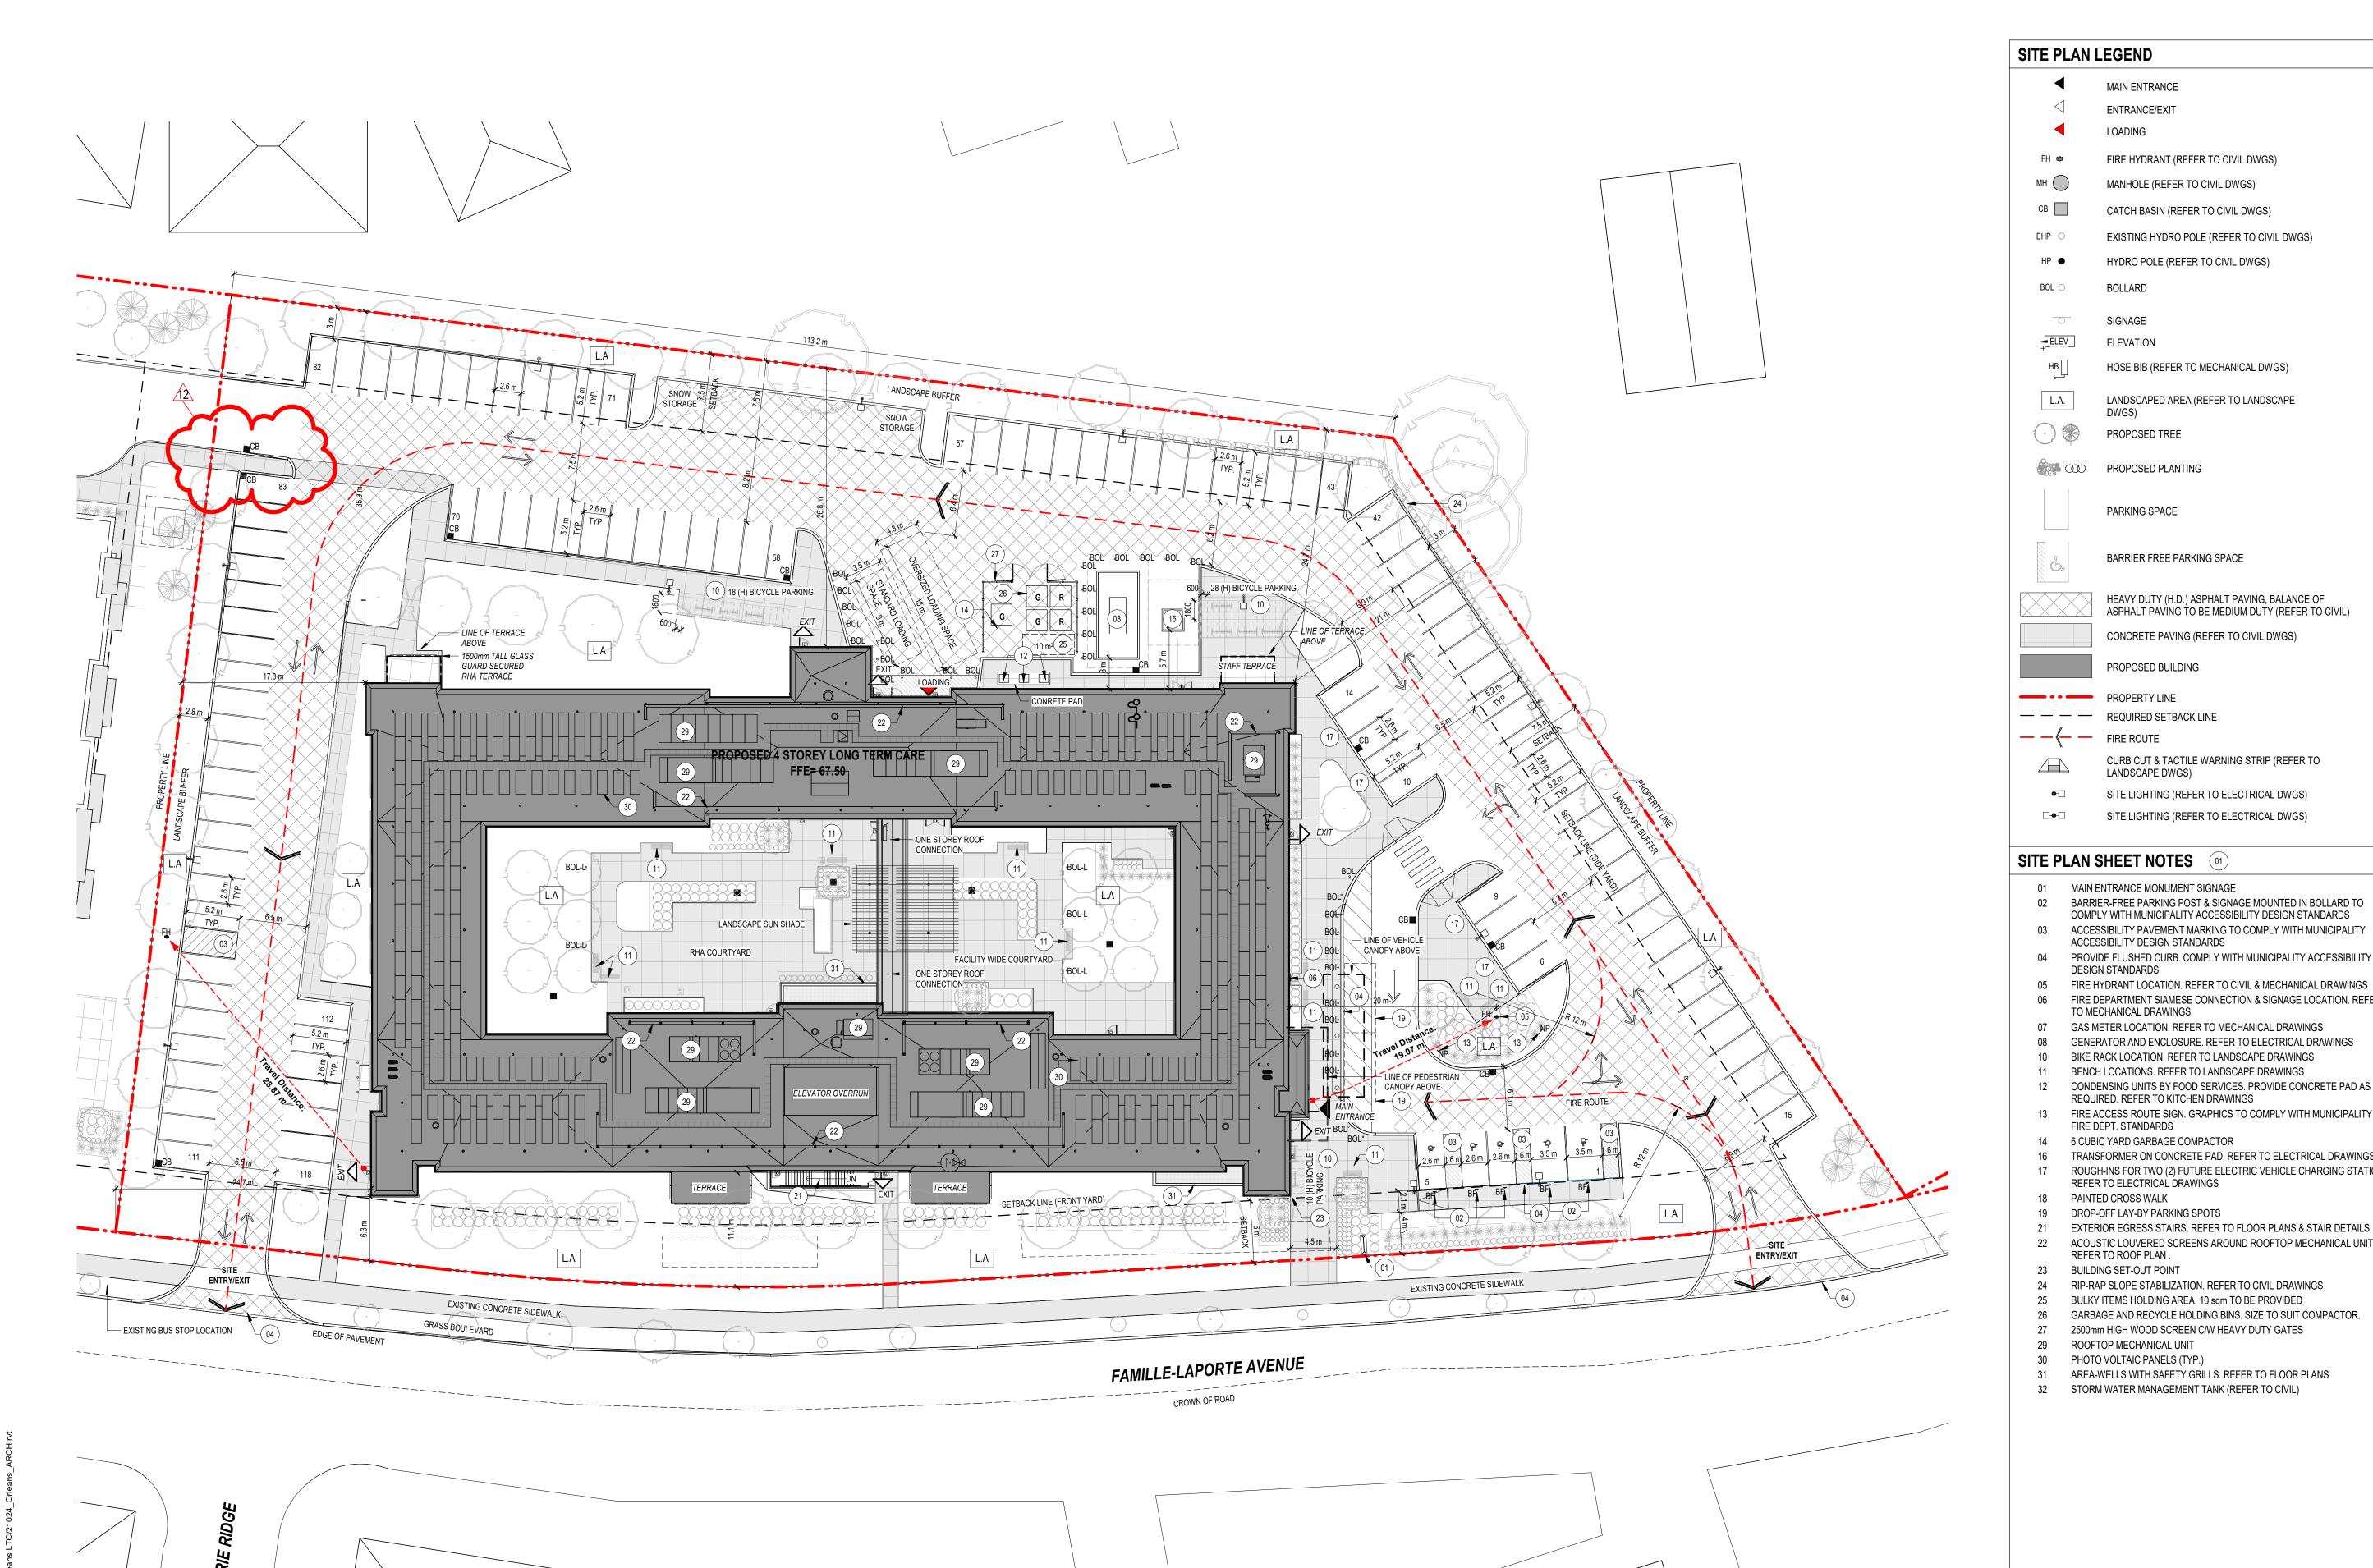

MAIN ENTRANCE

ENTRANCE/EXIT

SIGNAGE

PROPOSED TREE

PARKING SPACE

PROPOSED BUILDING

LANDSCAPE DWGS)

MAIN ENTRANCE MONUMENT SIGNAGE

ACCESSIBILITY DESIGN STANDARDS

DESIGN STANDARDS

TO MECHANICAL DRAWINGS

FIRE DEPT. STANDARDS

REFER TO ROOF PLAN .

BUILDING SET-OUT POINT

ROOFTOP MECHANICAL UNIT

PHOTO VOLTAIC PANELS (TYP.)

BARRIER FREE PARKING SPACE

HEAVY DUTY (H.D.) ASPHALT PAVING, BALANCE OF ASPHALT PAVING TO BE MEDIUM DUTY (REFER TO CIVIL)

CONCRETE PAVING (REFER TO CIVIL DWGS)

CURB CUT & TACTILE WARNING STRIP (REFER TO

SITE LIGHTING (REFER TO ELECTRICAL DWGS)

SITE LIGHTING (REFER TO ELECTRICAL DWGS)

BARRIER-FREE PARKING POST & SIGNAGE MOUNTED IN BOLLARD TO COMPLY WITH MUNICIPALITY ACCESSIBILITY DESIGN STANDARDS

ACCESSIBILITY PAVEMENT MARKING TO COMPLY WITH MUNICIPALITY

PROVIDE FLUSHED CURB. COMPLY WITH MUNICIPALITY ACCESSIBILITY

FIRE HYDRANT LOCATION. REFER TO CIVIL & MECHANICAL DRAWINGS FIRE DEPARTMENT SIAMESE CONNECTION & SIGNAGE LOCATION. REFER

GENERATOR AND ENCLOSURE. REFER TO ELECTRICAL DRAWINGS

CONDENSING UNITS BY FOOD SERVICES. PROVIDE CONCRETE PAD AS

TRANSFORMER ON CONCRETE PAD. REFER TO ELECTRICAL DRAWINGS

ACOUSTIC LOUVERED SCREENS AROUND ROOFTOP MECHANICAL UNITS.

GARBAGE AND RECYCLE HOLDING BINS. SIZE TO SUIT COMPACTOR.

RIP-RAP SLOPE STABILIZATION. REFER TO CIVIL DRAWINGS

AREA-WELLS WITH SAFETY GRILLS. REFER TO FLOOR PLANS

BULKY ITEMS HOLDING AREA. 10 sqm TO BE PROVIDED

2500mm HIGH WOOD SCREEN C/W HEAVY DUTY GATES

ROUGH-INS FOR TWO (2) FUTURE ELECTRIC VEHICLE CHARGING STATIONS,

FIRE ACCESS ROUTE SIGN. GRAPHICS TO COMPLY WITH MUNICIPALITY AND

GAS METER LOCATION. REFER TO MECHANICAL DRAWINGS

BIKE RACK LOCATION. REFER TO LANDSCAPE DRAWINGS BENCH LOCATIONS. REFER TO LANDSCAPE DRAWINGS

REQUIRED. REFER TO KITCHEN DRAWINGS

6 CUBIC YARD GARBAGE COMPACTOR

REFER TO ELECTRICAL DRAWINGS

DROP-OFF LAY-BY PARKING SPOTS

FIRE HYDRANT (REFER TO CIVIL DWGS)

CATCH BASIN (REFER TO CIVIL DWGS)

HYDRO POLE (REFER TO CIVIL DWGS)

HOSE BIB (REFER TO MECHANICAL DWGS)


LANDSCAPED AREA (REFER TO LANDSCAPE

EXISTING HYDRO POLE (REFER TO CIVIL DWGS)

MANHOLE (REFER TO CIVIL DWGS)

197 Spadina Avenue, Toronto, Ontario M5T 2C8 montgomerysisam.com Tel 416.364.8079 Fax 416.364.7723

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12 2023/01/27 RE-ISSUED FOR SITE PLAN CONTROL APPLICATION & ZONING BY-LAW AMENDMENT 8 2022/08/19 RE-ISSUED FOR SITE PLAN CONTROL APPLICATION & ZONING BY-LAW AMENDMENT

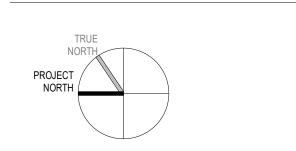revisions

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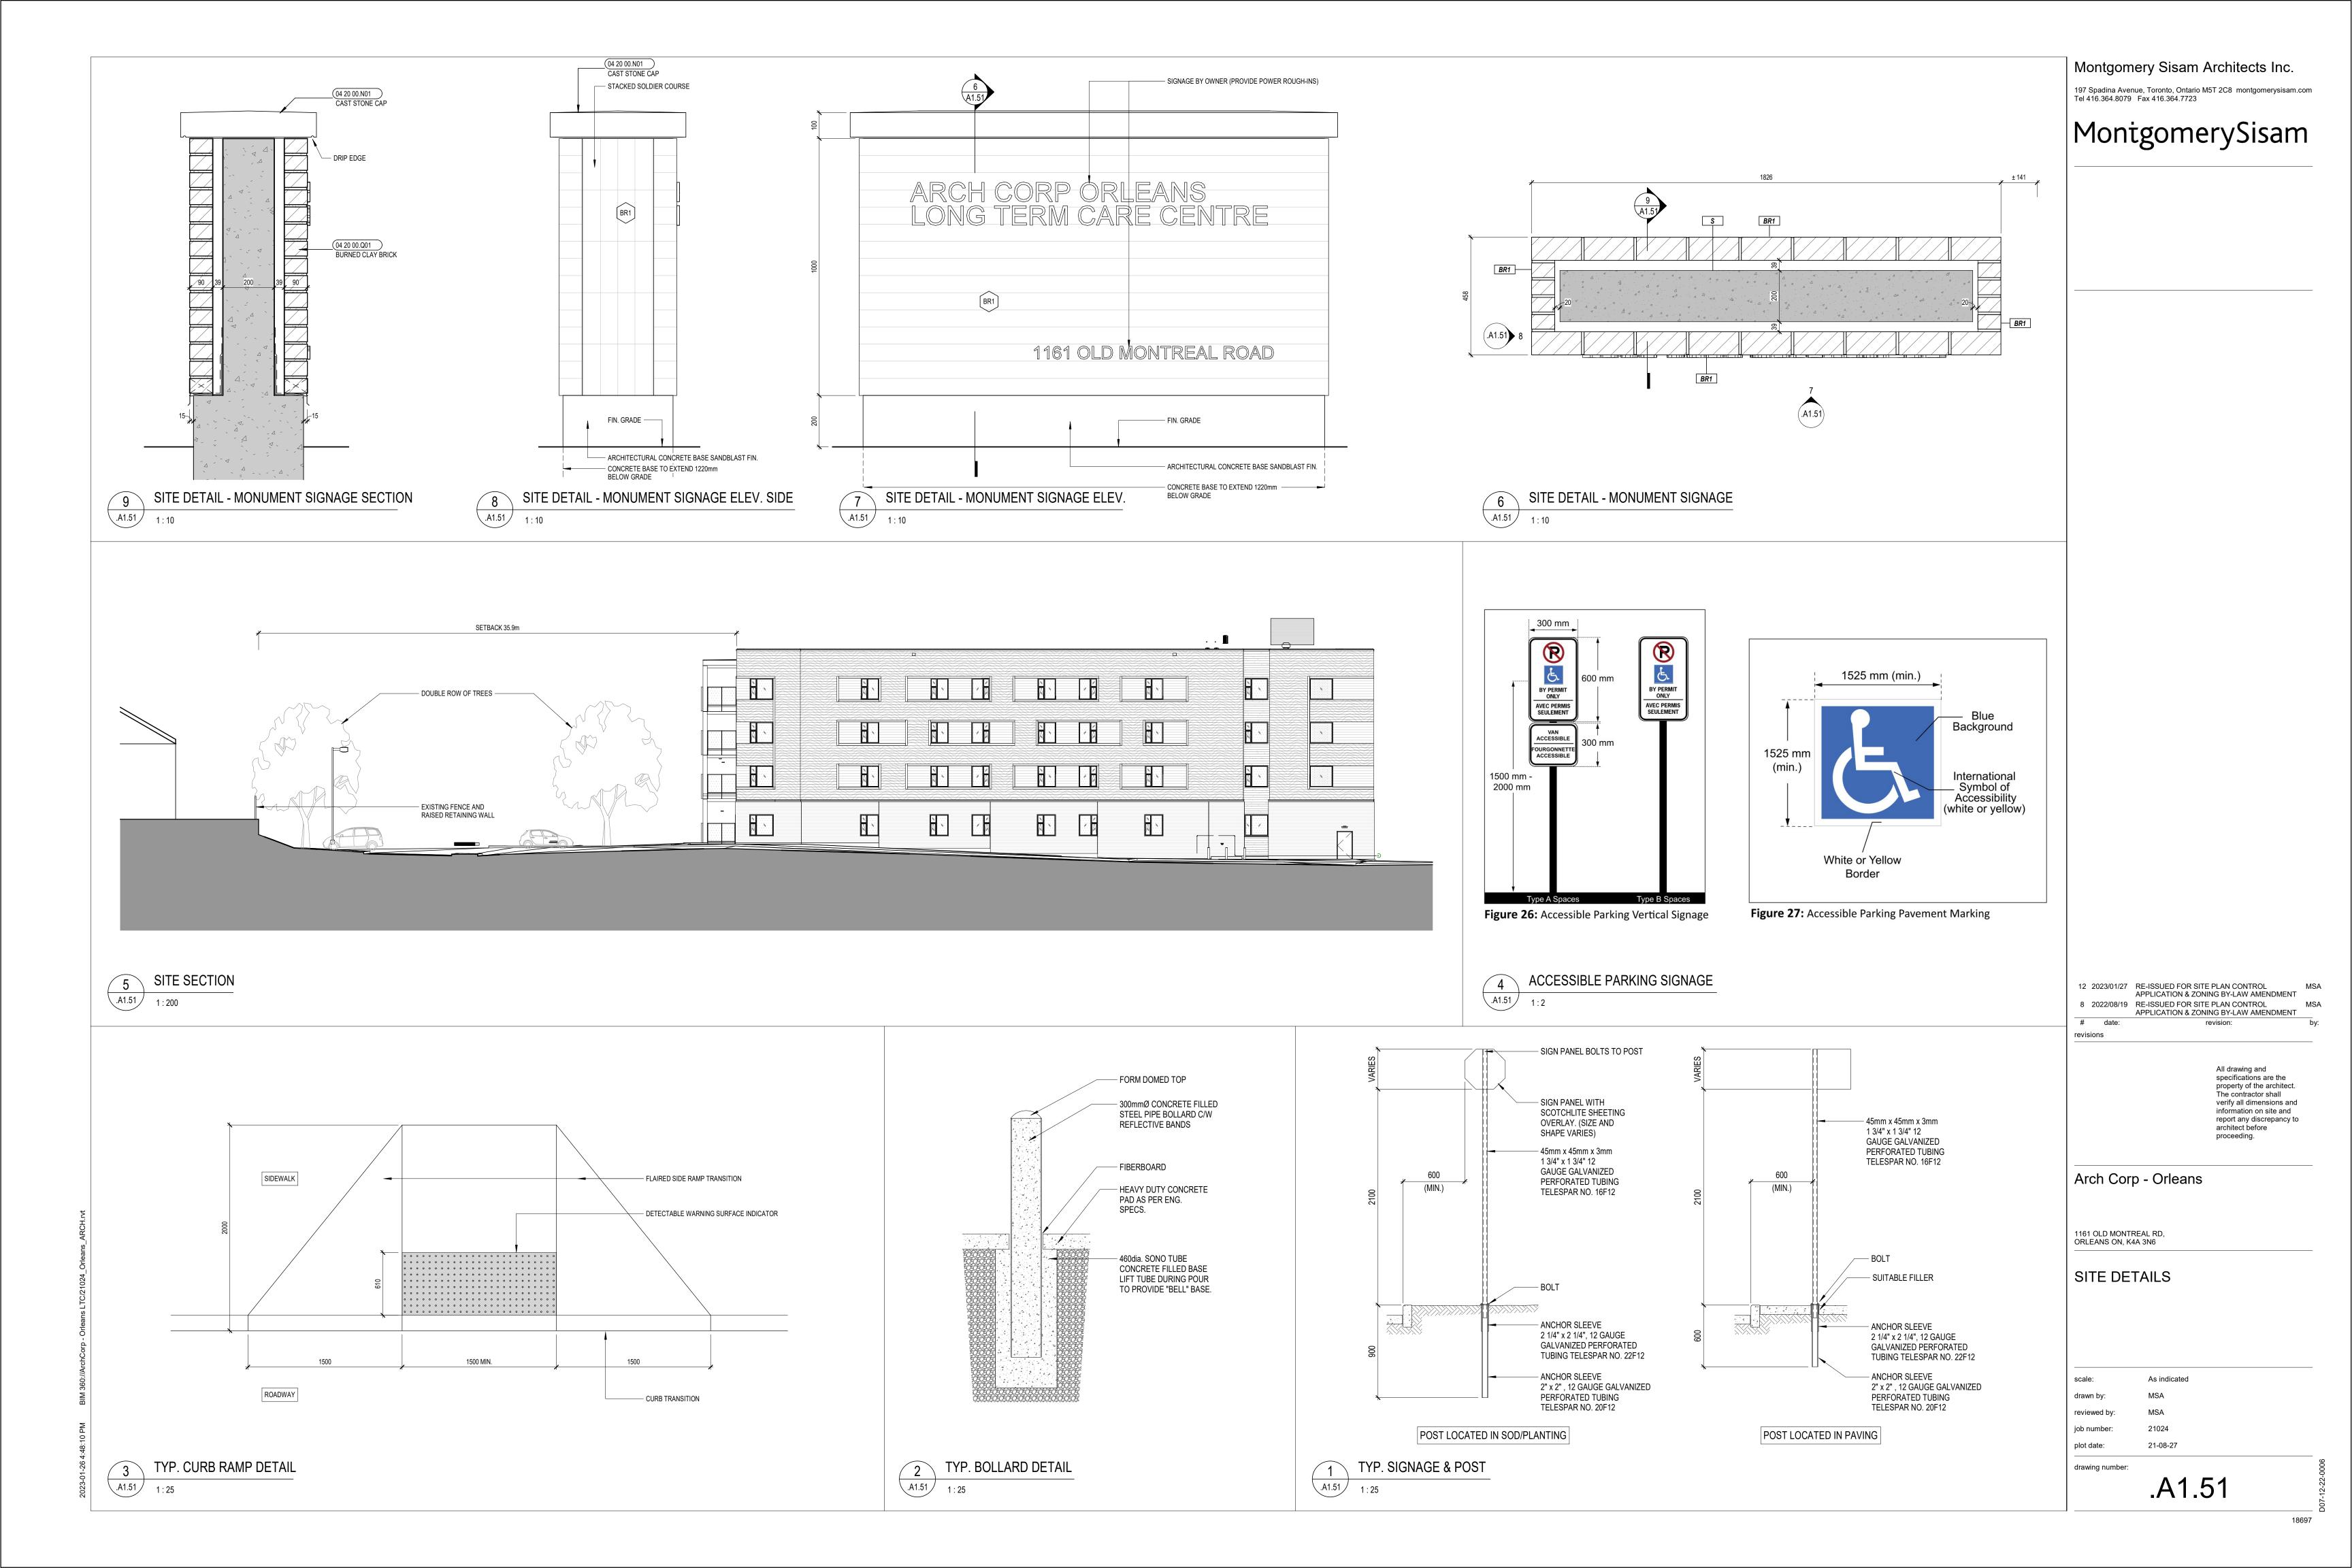
1161 OLD MONTREAL RD, ORLEANS ON, K4A 3N6

SITE PLAN

As indicated drawn by: reviewed by:


job number: 21024 21-08-27 plot date: drawing number:

.A1.02



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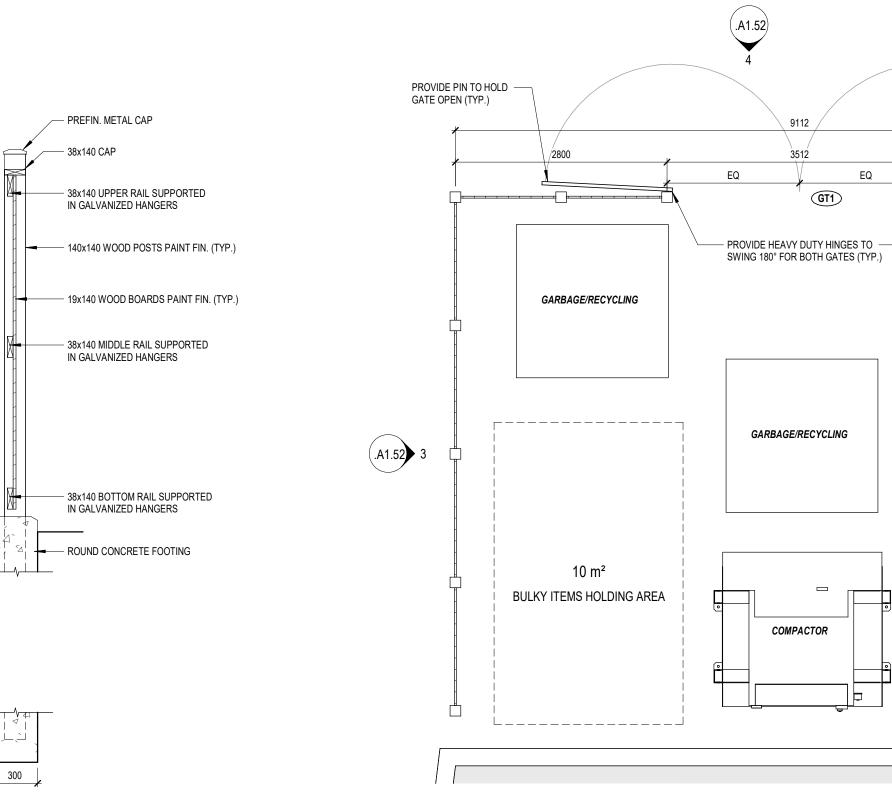
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4 SITE DETAIL - GARBAGE ENCLOSURE EAST ELEVATION

SITE DETAIL - GARBAGE ENCLOSURE NORTH & SOUTH ELEVATION

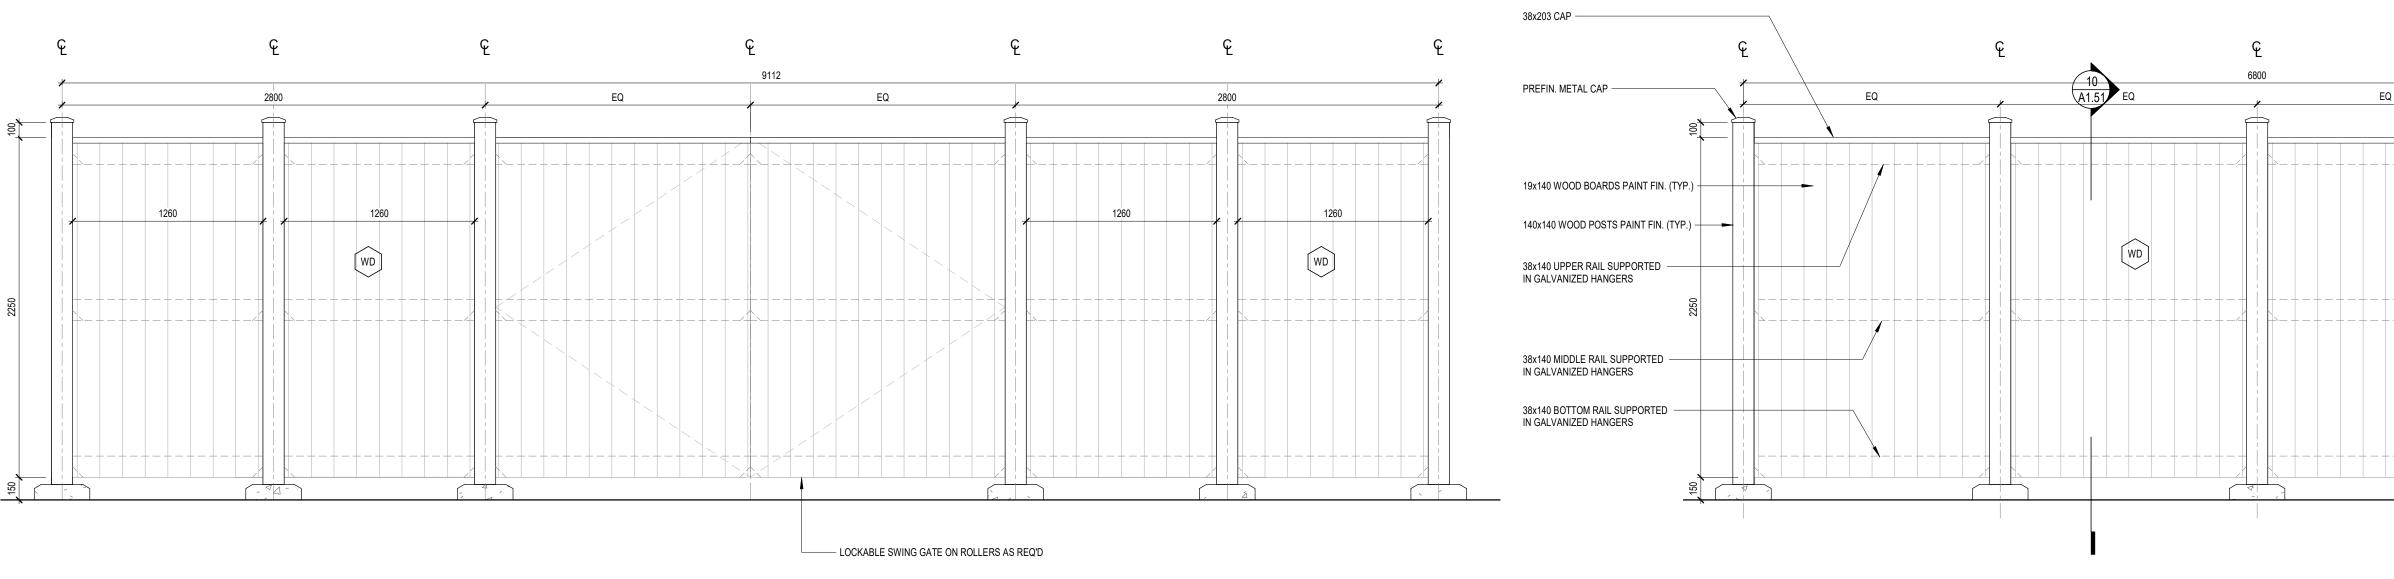1:25



GARBAGE/RECYCLING

GARBAGE/RECYCLING

GARBAGE/RECYCLING

EQ

PROVIDE WHEEL TO SUPPORT GATES (TYP.)

As indicated drawn by: reviewed by: 21024 job number: 21-08-27 plot date:

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1161 OLD MONTREAL RD, ORLEANS ON, K4A 3N6

SITE DETAILS

drawing number: .A1.52

12 2023/01/27 RE-ISSUED FOR SITE PLAN CONTROL

8 2022/08/19 RE-ISSUED FOR SITE PLAN CONTROL

revisions

APPLICATION & ZONING BY-LAW AMENDMENT

APPLICATION & ZONING BY-LAW AMENDMENT

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architect before

2 SITE DETAIL - GARBAGE ENCLOSURE SECTION DETAIL
1:25

18697

SITE DETAIL - GARBAGE ENCLOSURE ENLARGED PLAN .A1.52 1 : 50

FLOOR PLAN LEGEND ACS ADULT CHANGE STATION MRL-CH MOBILE RESIDENT LIFT -ADO AUTO DOOR OPERATOR BPD MOBILE RESIDENT LIFT -BEDPAN DISINFECTOR CD CHEMICAL DISPENSING UNIT FLOOR LIFT CG1 ACROVYN CORNER GUARD MRL-SS MOBILE RESIDENT LIFT -CG2 SIT TO STAND STAINLESS STEEL CORNER MOP SINK ACROVYN CORNER GUARD CG3 NURSE CALL CG4 STAINLESS STEEL CORNER PRIVACY CURTAIN PAPER TOWEL DISPENSER CLINIC SERVICE SINK PVP PHOTO VOLTAIC PANEL ROOF DRAIN EXHAUST FAN REFRIGERATOR EW EYE WASH FLOOR DRAIN RAIN WATER LEADER FEC1 SOAP DISPENSER FIRE EXTINGUISHER CABINET | SD FEC2 SHAMPOO CHAIR SHCH FIRE EXTINGUISHER FLS SHAMPOO SINK FLOOR SCRUBBER FRPL1 ELECTRIC FIREPLACE SANITARY NAPKING DISPOSAL FRPL2 STAINLESS STEEL SHELF GAS FIREPLACE GB1 SPRINKLER VALVE CABINET GRAB BAR 1 GB2 **GRAB BAR 2** (REFER TO MECH) GB3 **GRAB BAR 3** TRENCH DRAIN GB4 TOWEL ROD GRAB BAR 4 GB5 **GRAB BAR 5** TPD TOILET PAPER DISPENSER HDRL HANDRAIL RAPSODY TUB (TBD) HAND SANITIZER TELEVISION TELEVISION BRACKET HST HOOK STRIP TV/BRK LKR VDM VENDING MACHINE LOCKER MB MEMORY BOX (RECESSED) MANUAL BLINDS MEDICINE CABINET

MIRROR

MOP HOLDER

MPH

FLOOR PLAN GENERAL NOTES 1. ALL OVERALL CONSTRUCTION PLANS TO BE READ IN CONJUNCTION WITH

ENLARGED PLANS. DIMENSIONS, UNLESS NOTED OTHERWISE, ARE MEASURED IN ORDER OF IMPORTANCE TO: A. GRID LINES

B. FACE OF CONCRETE/PARTITION CONTRACTOR SHALL PROTECT EXISTING FINISHES FROM DAMAGE DURING CONSTRUCTION. CONTRACTOR SHALL BE RESPONSIBILE TO REPAIR AND MAKE GOOD ANY SURFACES AFFECTED B DEMOLITION AND/OR CONSTRUCTION. CONTRACTOR TO CORE SLAB FOR IN-SLAB RECESSED FLOOR BOXES.

REFER TO ELEC. DRAWINGS FOR TYPE/QUANTITY. CONTRACTOR TO SCAN SLAB AS REQUIRED AND CONFIRM FINAL LOCATIONS FOR EACH FLOOR BOX WITH CONSULTANT FOR COORDINATION W/ FURNITURE PLACEMENT. CONTRACOR SHALL PROVIDE PARTITION CHALK LINE LAYOUT ON SLAB FOR REVIEW AND APPROVAL BY DESIGNER PRIOR TO PROCEEDING WITH

INSTALLATION OF TRACK AND STUDS. SOUND ATTENUATION BLANKETS SHALL BE INSTALLED CONTINUOUSLY BEHIND ALL POWER, VOICE, AND DATA OUTLETS AND OTHER DEVICES RECESSED INTO PARTITIONS.

COORDINATE ALL BASE TYPES WITH GWB CONSTRUCTION. REFER TO ROOM FINISH SCHEDULE AND DRAWINGS. 8. ALL PARTITIONS SCHEDULED TO RECEIVE RESILENT BASE ARE TO BE COMPLETELY FINISHED SMOOTH TO THE SLAB.

UNLESS NOTED OTHERWISE, DOOR LOCATIONS SHALL BE 100mm FROM FACE OF WALL TO OUTSIDE OF DOOR FRAME AND NOT LESS THAN 100mm.

10. CONTRACTOR SHALL PATCH AND REPAIR ALL EXISTING GWB SURFACES AS REQUIRED TO MAKE GOOD AND MAKE READY TO RECEIVE NEW FINISHES.

11. CONTRACTOR SHALL REFER TO ROOM FINISH SCHEDULE AND FINISH SPECIFICATIONS FOR ALL BASE TYPES AND HEIGHTS. 12. WHERE FIRE SEPARATIONS OCCUR, EXTEND PARTITIONS TO UNDERSIDE OF SLAB. PACK ANY OPENINGS BETWEEN STRUCTURE OR ROOF AND

THROUGH FIRE SEPARATIONS WITH FIRE STOPPING MATERIAL.

PARTITIONS WITH FIRE STOPPING MATERIAL. PACK AROUND PENETRATIONS

13. AT RECESSED PANELS AND EQUIPMENT IN FIRE SEPARATIONS, MAINTAIN THE CONTINUITY OF THE REQUIRED IFRE SEPARATIONS BEHIND THE EQUIPMENT.

14. WRAP PLUMBING PIPES WITH NON-COMBUSTIBLE INSULATION TO MUFFLE SOUND TRANSMISSION. 15. PROVIDE 400mm HIGH 26 GA. SHEET METAL BLOCKING OR 16mm PLYWOOD

SHEATHING BLOCKING AT ALL LOCATIONS WHERE EQUIPMENT TO BE INSTALLED. BLOCKING HEIGHT TO SUIT EQUIPMENT. 16. WHERE PARTITIONS OF VARYING THICKNESS ALIGN, STEP THE FLOOR AND CEILING TRACKS AS REQUIRED TO ENSURE A FLUSH FINISHED CONDITION

ON THE EXPOSED FACE. 17. REFER TO MILLWORK REFERENCE PLAN FOR MILLWORK DETAILS. 18. FOR FIRE EXTINGUISHER CABINETS, REFER ALSO TO MECHANICAL DRAWINGS.

POSSIBLE UNLESS NOTED OTHERWISE. 20. CONTRACTOR TO MARK OUT ALL THERMOSTAT AND SWITCHING LOCATIONS ON SITE FOR DESIGNER APPROVAL PRIOR TO INSTALLATION. 21. TYPICAL RESIDENT ROOM DETAILS: UNLESS NOTED OTHERWISE, FURRING AND PARTITION TYPES, INTERIOR ELEVATION REFERENCES, PLAN DETAIL REFERENCES, AND DIMENSIONS, NOTES, ACCESSORIES AND ANYTHING ELSE NOTED IN TYPICAL DRAWINGS ON A7.01 ARE TYPICAL FOR ALL

19. FURRING WALLS AROUND COLUMNS AND PIPES TO BE BUILT AS TIGHT AS

RESIDENT ROOMS ON ALL FLOORS. 22. TYPICAL TUB AND SHOWER ROOM DETAILS: UNLESS NOTED OTHERWISE, FURRING AND PARTITION TYPES, INTERIOR ELEVATION REFERENCES, PLAN DETAIL REFERENCES AND DIMENSIONS, NOTES, ACCESSORIES AND ANYTHING ELSE NOTED IN TYPICAL DRAWINGS ON A7.02 ARE TYPICAL FOR ALL TUB AND SHOWER ROOMS ON ALL FLOORS.

23. WALL PARTITIONS, FURRING TYPES, DIMENSIONS, NOTES, TAGS, INTERIOR ELEVATION REFERENCES, AND OTHER INFORMATION INDICATED ON THE SECOND FLOOR ARE TYPICAL FOR FLOORS 2-3 UNLESS INDICATED OTHERWISE, OR AT AREAS SHOWING DIFFERENT LAYOUTS. 24. ALL CLOSETS TO HAVE ROD AND SHELF UNLESS NOTED OTHERWISE.

25. ALL CLOSETS TO BE 600MM CLEAR INSIDE UNLESS NOTED OTHERWISE.

26. UNLESS OTHERWISE NOTED, ALWAYS PROVIDE F14 FURRING AT ENDS OF CONCRETE WALLS (WHERE CONCRETE WALL IS TO BE CLAD IN GWB). 27. ANY NON-STRUCTURAL PARTITION WHICH ARE NOT LABELLED SHOULD BE

ASSUMED TO BE THE FOLLOWING: 28. FIRESPRAY ALL STRUCTURAL STEEL SUPPORTING SECOND, THIRD, AND ROOF TO ACHIEVE A 1HR FIRE RATING UNLESS SPECIFICALLY NOTED OTHERWISE

10. FOR STEEL COLUMN DRYWALL AND FIRE PROTECTION DETAILS, REFER 29. FLOOR FINISHES ARE ONLY INDICATED ON PLAN WHERE FLOORING

TRANSITION OCCURS AT AN ATYPICAL LOCATION. REFER TO ROOM FINISH SCHEDULE AND FLOOR FINISH PLANS FOR FLOOR FINISH. 30. ALL MECHANICAL AND ELECTRICAL RISERS NOT RUNNING INSIDE SHAFTS TO BE FURRED OUT WITH GWB FURRING ASSEMBLIES UNLESS INDICATED OTHERWISE

31. PROVIDE ONE MEMORY BOX (MB) AT EVERY RESIDENT ROOM DOOR. REFER TO DETAIL

32. APPLY CRYSTALLINE WATERPROOFING TO ALL ELEVATOR PITS.

FLOOR PLAN SHEET NOTES (01)

MAIN ENTRANCE ANNUNCIATOR PANEL. REFER TO ELECTRICAL

SOLID PHENOLIC WASHROOM/SHOWER PARTITION STALL

TRENCH DRAIN RECESSED IN CONCRETE, PROVIDE FLOOR REPRESSION. REFER TO SLAB EDGE, STRUCTURAL, AND MECHANICAL

ELEVATOR PIT LADDER AS PER ELEVATOR CODE REQUIREMENTS PROVIDE CEMENT BOARD UP TO 2440mm BEHIND EXHAUST HOOD.

EXTEND CEMENT BOARD 76mm HORIZONTALLY BEYOND EACH END OF HOOD. REFER TO FOOD SERVICES DRAWINGS FOR FINISH

750mmØ LINEN CHUTE W/ INTAKE DOORS AT EVERY FLOOR LEVEL ABOVE BASEMENT. COORDINATE DIMENSIONS OF SHAFT W/ LAUNDRY CHUTE MANUFACTURER

GENERATOR AND ENCLOSURE. REFER TO ELECTRICAL DRAWINGS BASE RAIL TO ALL SERVICE CORRIDOR PARTITION WALLS

BENCH LOCATIONS. REFER TO LANDSCAPE DRAWINGS 150mm THICK CONCRETE HOUSEKEEPING PAD. REFER TO SLAB EDGE, STRUCTURAL, MECHANICAL, ELECTRICAL, AND KITCHEN DRAWINGS SLAB DEPRESSION, REFER TO SLAB EDGE AND STRUCTURAL DRAWINGS

LOCATION OF VACCINE FRIDGE ON EMERGENCY POWER, REFER TO ELECTRICAL DRAWINGS CRICKET BUILD UP OF TAPERED FIBERBOARD INSULATION (TYP.) MIN. 1% SLOPED CONRETE TOPPING ON ALL TERRACES, SLOPING AWAY

FROM FACE OF BUILDING PROVIDE DUCT/SHAFT PENETRATION DOGHOUSE ENCLOSURE, REFER TO ARCHITECTURAL DETAILS AND MECHANICAL DRAWINGS

GREASE INTERCEPTOR, REFER TO MECHANICAL & KITCHEN DRAWINGS ROOF ANCHORS (RA) WITH GALVANIZED CABLE AND SHOCK ABSORBERS, REFER TO SPECIFICATIONS (TYPICAL)

MECHANICAL UNIT LOUVERED SCREENING, REFER TO DETAILS AND

SPECIFICATIONS ROOF EMERGENCY RELIEF SCUPPERS. REFER TO DETAILS AND SPECIFICATIONS

610x610mm PRECAST CONCRETE ROOF PAVERS ON SUPPORTS

ROOF LADDER ON LEVEL 04 ONLY AND ACCESS HATCH ABOVE

ROOFTOP UNITS, REFER TO MECHANICAL (TYP.) PV PANELS ON BALLASTED SUPPORT STRUCTURE, REFER TO ELECTRICAL (TYP.)

AIR HANDLING UNIT, REFER TO MECHANICAL (TYP.) PUNCH CLOCK (S&I BY OWNER, REFER TO ELEC. FOR ROUGH-INS) STAINLESS STEEL CABINETS

ENTRANCE MAT (REFER TO SPEC) 1HR RATED HORIZONTAL & VERTICAL SHAFT ENCLOSURE AT BASE OF MECHANICAL SHAFT ABOVE

INTUMESCENT PAINT ON STRUCTURAL COLUMN HOSE BIB (REFER TO MECHANICAL DRAWINGS) FREE-STANDING NON-FREEZE HOSE BIB (REFER TO MECH) LOCATION OF GAS FIREPLACE CONTROLS. CONTRACTOR TO

COORDINATE ON SITE AS DIRECTED BY CONSULTANT.

FIRE DEPARTMENT SIAMESE CONNECTION & SIGNAGE LOCATION. REFER TO MECHANICAL DRAWINGS

TRANSFORMER ON CONCRETE PAD. REFER TO ELECTRICAL DRAWINGS 150mm BOLLARD

PROVIDE BLOCKING FOR OWNER-SUPPLIED 1525mm LONG BALLET

PROVIDE BLOCKING FOR OWNER-SUPPLIED WALL-MOUNTED MAIL SLOTS SUMP PUMP, REFER TO MECH.



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1161 OLD MONTREAL RD, ORLEANS ON, K4A 3N6

FLOOR PLAN - LEVEL B1

job number: 21-08-27 plot date:

drawing number:

.A2.00

FLOOR PLAN LEGEND ACS MRL-CH MOBILE RESIDENT LIFT -ADULT CHANGE STATION ADO AUTO DOOR OPERATOR BPD MOBILE RESIDENT LIFT -BEDPAN DISINFECTOR CD CHEMICAL DISPENSING UNIT FLOOR LIFT CG1 ACROVYN CORNER GUARD MRL-SS MOBILE RESIDENT LIFT -CG2 STAINLESS STEEL CORNER SIT TO STAND MOP SINK ACROVYN CORNER GUARD CG3 NURSE CALL CG4 STAINLESS STEEL CORNER PRIVACY CURTAIN PAPER TOWEL DISPENSER CSS PVP CLINIC SERVICE SINK PHOTO VOLTAIC PANEL ROOF DRAIN EXHAUST FAN REFRIGERATOR EW EYE WASH FLOOR DRAIN RAIN WATER LEADER FEC1 FIRE EXTINGUISHER CABINET | SD SOAP DISPENSER FIRE EXTINGUISHER FEC2 SHAMPOO CHAIR SHCH FLS SHAMPOO SINK FLOOR SCRUBBER FRPL1 ELECTRIC FIREPLACE SANITARY NAPKING DISPOSAL FRPL2 GAS FIREPLACE STAINLESS STEEL SHELF GB1 SPRINKLER VALVE CABINET GRAB BAR 1 GB2 **GRAB BAR 2** (REFER TO MECH) GB3 **GRAB BAR 3** TRENCH DRAIN GB4 TOWEL ROD GRAB BAR 4 GB5 GRAB BAR 5 TPD TOILET PAPER DISPENSER HDRL HANDRAIL RAPSODY TUB (TBD) HAND SANITIZER TELEVISION TELEVISION BRACKET HST HOOK STRIP TV/BRK LKR VDM VENDING MACHINE LOCKER MEMORY BOX (RECESSED) MB

MANUAL BLINDS

MIRROR

MOP HOLDER

MPH

MEDICINE CABINET

FLOOR PLAN GENERAL NOTES

- 1. ALL OVERALL CONSTRUCTION PLANS TO BE READ IN CONJUNCTION WITH
- DIMENSIONS, UNLESS NOTED OTHERWISE, ARE MEASURED IN ORDER OF IMPORTANCE TO:
- A. GRID LINES
- FACE OF CONCRETE/PARTITION CONTRACTOR SHALL PROTECT EXISTING FINISHES FROM DAMAGE DURING CONSTRUCTION. CONTRACTOR SHALL BE RESPONSIBILE TO REPAIR AND MAKE GOOD ANY SURFACES AFFECTED B DEMOLITION AND/OR CONSTRUCTION.
- CONTRACTOR TO CORE SLAB FOR IN-SLAB RECESSED FLOOR BOXES. REFER TO ELEC. DRAWINGS FOR TYPE/QUANTITY. CONTRACTOR TO SCAN SLAB AS REQUIRED AND CONFIRM FINAL LOCATIONS FOR EACH FLOOR BOX WITH CONSULTANT FOR COORDINATION W/ FURNITURE PLACEMENT. CONTRACOR SHALL PROVIDE PARTITION CHALK LINE LAYOUT ON SLAB FOR
- REVIEW AND APPROVAL BY DESIGNER PRIOR TO PROCEEDING WITH INSTALLATION OF TRACK AND STUDS. SOUND ATTENUATION BLANKETS SHALL BE INSTALLED CONTINUOUSLY
- BEHIND ALL POWER, VOICE, AND DATA OUTLETS AND OTHER DEVICES RECESSED INTO PARTITIONS. COORDINATE ALL BASE TYPES WITH GWB CONSTRUCTION. REFER TO ROOM
- FINISH SCHEDULE AND DRAWINGS. 8. ALL PARTITIONS SCHEDULED TO RECEIVE RESILENT BASE ARE TO BE COMPLETELY FINISHED SMOOTH TO THE SLAB.
- UNLESS NOTED OTHERWISE, DOOR LOCATIONS SHALL BE 100mm FROM FACE OF WALL TO OUTSIDE OF DOOR FRAME AND NOT LESS THAN 100mm.
- 10. CONTRACTOR SHALL PATCH AND REPAIR ALL EXISTING GWB SURFACES AS REQUIRED TO MAKE GOOD AND MAKE READY TO RECEIVE NEW FINISHES.
- 11. CONTRACTOR SHALL REFER TO ROOM FINISH SCHEDULE AND FINISH SPECIFICATIONS FOR ALL BASE TYPES AND HEIGHTS. 12. WHERE FIRE SEPARATIONS OCCUR, EXTEND PARTITIONS TO UNDERSIDE OF SLAB. PACK ANY OPENINGS BETWEEN STRUCTURE OR ROOF AND PARTITIONS WITH FIRE STOPPING MATERIAL. PACK AROUND PENETRATIONS

THROUGH FIRE SEPARATIONS WITH FIRE STOPPING MATERIAL.

.A2.01 1 : 200

13. AT RECESSED PANELS AND EQUIPMENT IN FIRE SEPARATIONS, MAINTAIN

15. PROVIDE 400mm HIGH 26 GA. SHEET METAL BLOCKING OR 16mm PLYWOOD

THE CONTINUITY OF THE REQUIRED IFRE SEPARATIONS BEHIND THE EQUIPMENT. 14. WRAP PLUMBING PIPES WITH NON-COMBUSTIBLE INSULATION TO MUFFLE

SOUND TRANSMISSION

DRAWINGS.

- SHEATHING BLOCKING AT ALL LOCATIONS WHERE EQUIPMENT TO BE INSTALLED. BLOCKING HEIGHT TO SUIT EQUIPMENT. 16. WHERE PARTITIONS OF VARYING THICKNESS ALIGN, STEP THE FLOOR AND
- CEILING TRACKS AS REQUIRED TO ENSURE A FLUSH FINISHED CONDITION ON THE EXPOSED FACE. 17. REFER TO MILLWORK REFERENCE PLAN FOR MILLWORK DETAILS. 18. FOR FIRE EXTINGUISHER CABINETS, REFER ALSO TO MECHANICAL
- 19. FURRING WALLS AROUND COLUMNS AND PIPES TO BE BUILT AS TIGHT AS POSSIBLE UNLESS NOTED OTHERWISE. 20. CONTRACTOR TO MARK OUT ALL THERMOSTAT AND SWITCHING LOCATIONS ON SITE FOR DESIGNER APPROVAL PRIOR TO INSTALLATION.
- 21. TYPICAL RESIDENT ROOM DETAILS: UNLESS NOTED OTHERWISE, FURRING AND PARTITION TYPES, INTERIOR ELEVATION REFERENCES, PLAN DETAIL REFERENCES, AND DIMENSIONS, NOTES, ACCESSORIES AND ANYTHING ELSE NOTED IN TYPICAL DRAWINGS ON A7.01 ARE TYPICAL FOR ALL RESIDENT ROOMS ON ALL FLOORS.
- 22. TYPICAL TUB AND SHOWER ROOM DETAILS: UNLESS NOTED OTHERWISE, FURRING AND PARTITION TYPES, INTERIOR ELEVATION REFERENCES, PLAN DETAIL REFERENCES AND DIMENSIONS, NOTES, ACCESSORIES AND ANYTHING ELSE NOTED IN TYPICAL DRAWINGS ON A7.02 ARE TYPICAL FOR ALL TUB AND SHOWER ROOMS ON ALL FLOORS.
- 23. WALL PARTITIONS, FURRING TYPES, DIMENSIONS, NOTES, TAGS, INTERIOR ELEVATION REFERENCES, AND OTHER INFORMATION INDICATED ON THE SECOND FLOOR ARE TYPICAL FOR FLOORS 2-3 UNLESS INDICATED OTHERWISE, OR AT AREAS SHOWING DIFFERENT LAYOUTS. 24. ALL CLOSETS TO HAVE ROD AND SHELF UNLESS NOTED OTHERWISE.

25. ALL CLOSETS TO BE 600MM CLEAR INSIDE UNLESS NOTED OTHERWISE.

- 26. UNLESS OTHERWISE NOTED, ALWAYS PROVIDE F14 FURRING AT ENDS OF CONCRETE WALLS (WHERE CONCRETE WALL IS TO BE CLAD IN GWB).
- 27. ANY NON-STRUCTURAL PARTITION WHICH ARE NOT LABELLED SHOULD BE ASSUMED TO BE THE FOLLOWING: 28. FIRESPRAY ALL STRUCTURAL STEEL SUPPORTING SECOND, THIRD, AND ROOF TO ACHIEVE A 1HR FIRE RATING UNLESS SPECIFICALLY NOTED
- OTHERWISE 10. FOR STEEL COLUMN DRYWALL AND FIRE PROTECTION DETAILS, REFER
- 29. FLOOR FINISHES ARE ONLY INDICATED ON PLAN WHERE FLOORING TRANSITION OCCURS AT AN ATYPICAL LOCATION. REFER TO ROOM FINISH SCHEDULE AND FLOOR FINISH PLANS FOR FLOOR FINISH.
- 30. ALL MECHANICAL AND ELECTRICAL RISERS NOT RUNNING INSIDE SHAFTS TO BE FURRED OUT WITH GWB FURRING ASSEMBLIES UNLESS INDICATED OTHERWISE
- 31. PROVIDE ONE MEMORY BOX (MB) AT EVERY RESIDENT ROOM DOOR. REFER TO DETAIL
- 32. APPLY CRYSTALLINE WATERPROOFING TO ALL ELEVATOR PITS.

FLOOR PLAN SHEET NOTES (01)

- MAIN ENTRANCE
- ANNUNCIATOR PANEL. REFER TO ELECTRICAL SOLID PHENOLIC WASHROOM/SHOWER PARTITION STALL
- TRENCH DRAIN RECESSED IN CONCRETE, PROVIDE FLOOR REPRESSION. REFER TO SLAB EDGE, STRUCTURAL, AND MECHANICAL
- ELEVATOR PIT LADDER AS PER ELEVATOR CODE REQUIREMENTS
- PROVIDE CEMENT BOARD UP TO 2440mm BEHIND EXHAUST HOOD. EXTEND CEMENT BOARD 76mm HORIZONTALLY BEYOND EACH END OF
- HOOD. REFER TO FOOD SERVICES DRAWINGS FOR FINISH 750mmØ LINEN CHUTE W/ INTAKE DOORS AT EVERY FLOOR LEVEL
- ABOVE BASEMENT. COORDINATE DIMENSIONS OF SHAFT W/ LAUNDRY CHUTE MANUFACTURER
- GENERATOR AND ENCLOSURE. REFER TO ELECTRICAL DRAWINGS
- BASE RAIL TO ALL SERVICE CORRIDOR PARTITION WALLS BENCH LOCATIONS. REFER TO LANDSCAPE DRAWINGS
- 150mm THICK CONCRETE HOUSEKEEPING PAD. REFER TO SLAB EDGE, STRUCTURAL, MECHANICAL, ELECTRICAL, AND KITCHEN DRAWINGS
- SLAB DEPRESSION, REFER TO SLAB EDGE AND STRUCTURAL DRAWINGS LOCATION OF VACCINE FRIDGE ON EMERGENCY POWER, REFER TO ELECTRICAL DRAWINGS
- CRICKET BUILD UP OF TAPERED FIBERBOARD INSULATION (TYP.) MIN. 1% SLOPED CONRETE TOPPING ON ALL TERRACES, SLOPING AWAY FROM FACE OF BUILDING
- PROVIDE DUCT/SHAFT PENETRATION DOGHOUSE ENCLOSURE, REFER TO ARCHITECTURAL DETAILS AND MECHANICAL DRAWINGS
- GREASE INTERCEPTOR. REFER TO MECHANICAL & KITCHEN DRAWINGS ROOF ANCHORS (RA) WITH GALVANIZED CABLE AND SHOCK ABSORBERS, REFER TO SPECIFICATIONS (TYPICAL)

- MECHANICAL UNIT LOUVERED SCREENING, REFER TO DETAILS AND SPECIFICATIONS
- ROOF EMERGENCY RELIEF SCUPPERS. REFER TO DETAILS AND
- SPECIFICATIONS 610x610mm PRECAST CONCRETE ROOF PAVERS ON SUPPORTS
- ROOF LADDER ON LEVEL 04 ONLY AND ACCESS HATCH ABOVE
- ROOFTOP UNITS, REFER TO MECHANICAL (TYP.) PV PANELS ON BALLASTED SUPPORT STRUCTURE, REFER TO
- ELECTRICAL (TYP.)
- AIR HANDLING UNIT, REFER TO MECHANICAL (TYP.)
- PUNCH CLOCK (S&I BY OWNER, REFER TO ELEC. FOR ROUGH-INS) STAINLESS STEEL CABINETS
- ENTRANCE MAT (REFER TO SPEC) 1HR RATED HORIZONTAL & VERTICAL SHAFT ENCLOSURE AT BASE OF
- MECHANICAL SHAFT ABOVE
- INTUMESCENT PAINT ON STRUCTURAL COLUMN HOSE BIB (REFER TO MECHANICAL DRAWINGS)
- FREE-STANDING NON-FREEZE HOSE BIB (REFER TO MECH) LOCATION OF GAS FIREPLACE CONTROLS. CONTRACTOR TO COORDINATE ON SITE AS DIRECTED BY CONSULTANT.
- FIRE DEPARTMENT SIAMESE CONNECTION & SIGNAGE LOCATION. REFER TO MECHANICAL DRAWINGS
- TRANSFORMER ON CONCRETE PAD. REFER TO ELECTRICAL DRAWINGS 150mm BOLLARD
- PROVIDE BLOCKING FOR OWNER-SUPPLIED 1525mm LONG BALLET
- PROVIDE BLOCKING FOR OWNER-SUPPLIED WALL-MOUNTED MAIL SLOTS SUMP PUMP, REFER TO MECH.


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12 2023/01/27 RE-ISSUED FOR SITE PLAN CONTROL APPLICATION & ZONING BY-LAW AMENDMENT 8 2022/08/19 RE-ISSUED FOR SITE PLAN CONTROL APPLICATION & ZONING BY-LAW AMENDMENT revisions

> All drawing and specifications are the property of the architect. verify all dimensions and information on site and report any discrepancy to architect before

Arch Corp - Orleans

1161 OLD MONTREAL RD,

ORLEANS ON, K4A 3N6

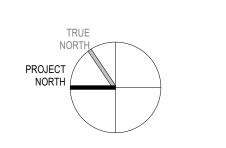FLOOR PLAN - LEVEL 01

job number: 21-08-27 plot date:

drawing number: .A2.01

FLOOR PLAN LEGEND ACS ADULT CHANGE STATION MRL-CH MOBILE RESIDENT LIFT -ADO AUTO DOOR OPERATOR BPD MOBILE RESIDENT LIFT -BEDPAN DISINFECTOR CD CHEMICAL DISPENSING UNIT FLOOR LIFT CG1 ACROVYN CORNER GUARD MRL-SS MOBILE RESIDENT LIFT -CG2 SIT TO STAND STAINLESS STEEL CORNER MOP SINK ACROVYN CORNER GUARD CG3 NURSE CALL CG4 STAINLESS STEEL CORNER PRIVACY CURTAIN PAPER TOWEL DISPENSER CLINIC SERVICE SINK PVP PHOTO VOLTAIC PANEL EXHAUST FAN ROOF DRAIN REFRIGERATOR EW EYE WASH FLOOR DRAIN RAIN WATER LEADER FEC1 SOAP DISPENSER FIRE EXTINGUISHER CABINET | SD FEC2 SHAMPOO CHAIR SHCH FIRE EXTINGUISHER FLS SHAMPOO SINK FLOOR SCRUBBER FRPL1 ELECTRIC FIREPLACE SANITARY NAPKING DISPOSAL FRPL2 GAS FIREPLACE STAINLESS STEEL SHELF GB1 SPRINKLER VALVE CABINET GRAB BAR 1 GB2 GRAB BAR 2 (REFER TO MECH) GB3 **GRAB BAR 3** TRENCH DRAIN GB4 TOWEL ROD GRAB BAR 4 GB5 GRAB BAR 5 TPD TOILET PAPER DISPENSER HDRL HANDRAIL RAPSODY TUB (TBD) HAND SANITIZER TELEVISION TELEVISION BRACKET HST HOOK STRIP TV/BRK LKR VDM VENDING MACHINE LOCKER MEMORY BOX (RECESSED)

MANUAL BLINDS

MIRROR

MOP HOLDER

MPH

MEDICINE CABINET

FLOOR PLAN GENERAL NOTES 1. ALL OVERALL CONSTRUCTION PLANS TO BE READ IN CONJUNCTION WITH

ENLARGED PLANS. DIMENSIONS, UNLESS NOTED OTHERWISE, ARE MEASURED IN ORDER OF IMPORTANCE TO: A. GRID LINES

B. FACE OF CONCRETE/PARTITION

.A2.02

CONTRACTOR SHALL PROTECT EXISTING FINISHES FROM DAMAGE DURING CONSTRUCTION. CONTRACTOR SHALL BE RESPONSIBILE TO REPAIR AND MAKE GOOD ANY SURFACES AFFECTED B DEMOLITION AND/OR CONSTRUCTION. CONTRACTOR TO CORE SLAB FOR IN-SLAB RECESSED FLOOR BOXES.

REFER TO ELEC. DRAWINGS FOR TYPE/QUANTITY. CONTRACTOR TO SCAN SLAB AS REQUIRED AND CONFIRM FINAL LOCATIONS FOR EACH FLOOR BOX WITH CONSULTANT FOR COORDINATION W/ FURNITURE PLACEMENT. CONTRACOR SHALL PROVIDE PARTITION CHALK LINE LAYOUT ON SLAB FOR REVIEW AND APPROVAL BY DESIGNER PRIOR TO PROCEEDING WITH INSTALLATION OF TRACK AND STUDS.

SOUND ATTENUATION BLANKETS SHALL BE INSTALLED CONTINUOUSLY BEHIND ALL POWER, VOICE, AND DATA OUTLETS AND OTHER DEVICES RECESSED INTO PARTITIONS. COORDINATE ALL BASE TYPES WITH GWB CONSTRUCTION. REFER TO ROOM

FINISH SCHEDULE AND DRAWINGS. 8. ALL PARTITIONS SCHEDULED TO RECEIVE RESILENT BASE ARE TO BE COMPLETELY FINISHED SMOOTH TO THE SLAB.

UNLESS NOTED OTHERWISE, DOOR LOCATIONS SHALL BE 100mm FROM FACE OF WALL TO OUTSIDE OF DOOR FRAME AND NOT LESS THAN 100mm.

10. CONTRACTOR SHALL PATCH AND REPAIR ALL EXISTING GWB SURFACES AS

REQUIRED TO MAKE GOOD AND MAKE READY TO RECEIVE NEW FINISHES. 11. CONTRACTOR SHALL REFER TO ROOM FINISH SCHEDULE AND FINISH

SPECIFICATIONS FOR ALL BASE TYPES AND HEIGHTS. 12. WHERE FIRE SEPARATIONS OCCUR, EXTEND PARTITIONS TO UNDERSIDE OF SLAB. PACK ANY OPENINGS BETWEEN STRUCTURE OR ROOF AND PARTITIONS WITH FIRE STOPPING MATERIAL. PACK AROUND PENETRATIONS THROUGH FIRE SEPARATIONS WITH FIRE STOPPING MATERIAL.

13. AT RECESSED PANELS AND EQUIPMENT IN FIRE SEPARATIONS, MAINTAIN THE CONTINUITY OF THE REQUIRED IFRE SEPARATIONS BEHIND THE EQUIPMENT.

14. WRAP PLUMBING PIPES WITH NON-COMBUSTIBLE INSULATION TO MUFFLE SOUND TRANSMISSION 15. PROVIDE 400mm HIGH 26 GA. SHEET METAL BLOCKING OR 16mm PLYWOOD

SHEATHING BLOCKING AT ALL LOCATIONS WHERE EQUIPMENT TO BE INSTALLED. BLOCKING HEIGHT TO SUIT EQUIPMENT. 16. WHERE PARTITIONS OF VARYING THICKNESS ALIGN, STEP THE FLOOR AND CEILING TRACKS AS REQUIRED TO ENSURE A FLUSH FINISHED CONDITION ON THE EXPOSED FACE. 17. REFER TO MILLWORK REFERENCE PLAN FOR MILLWORK DETAILS.

18. FOR FIRE EXTINGUISHER CABINETS, REFER ALSO TO MECHANICAL DRAWINGS. 19. FURRING WALLS AROUND COLUMNS AND PIPES TO BE BUILT AS TIGHT AS POSSIBLE UNLESS NOTED OTHERWISE.

20. CONTRACTOR TO MARK OUT ALL THERMOSTAT AND SWITCHING LOCATIONS ON SITE FOR DESIGNER APPROVAL PRIOR TO INSTALLATION. 21. TYPICAL RESIDENT ROOM DETAILS: UNLESS NOTED OTHERWISE, FURRING AND PARTITION TYPES, INTERIOR ELEVATION REFERENCES, PLAN DETAIL REFERENCES, AND DIMENSIONS, NOTES, ACCESSORIES AND ANYTHING ELSE NOTED IN TYPICAL DRAWINGS ON A7.01 ARE TYPICAL FOR ALL

RESIDENT ROOMS ON ALL FLOORS. 22. TYPICAL TUB AND SHOWER ROOM DETAILS: UNLESS NOTED OTHERWISE, FURRING AND PARTITION TYPES, INTERIOR ELEVATION REFERENCES, PLAN DETAIL REFERENCES AND DIMENSIONS, NOTES, ACCESSORIES AND ANYTHING ELSE NOTED IN TYPICAL DRAWINGS ON A7.02 ARE TYPICAL FOR

ALL TUB AND SHOWER ROOMS ON ALL FLOORS. 23. WALL PARTITIONS, FURRING TYPES, DIMENSIONS, NOTES, TAGS, INTERIOR ELEVATION REFERENCES, AND OTHER INFORMATION INDICATED ON THE SECOND FLOOR ARE TYPICAL FOR FLOORS 2-3 UNLESS INDICATED OTHERWISE, OR AT AREAS SHOWING DIFFERENT LAYOUTS.

24. ALL CLOSETS TO HAVE ROD AND SHELF UNLESS NOTED OTHERWISE. 25. ALL CLOSETS TO BE 600MM CLEAR INSIDE UNLESS NOTED OTHERWISE. 26. UNLESS OTHERWISE NOTED, ALWAYS PROVIDE F14 FURRING AT ENDS OF

CONCRETE WALLS (WHERE CONCRETE WALL IS TO BE CLAD IN GWB). 27. ANY NON-STRUCTURAL PARTITION WHICH ARE NOT LABELLED SHOULD BE

ASSUMED TO BE THE FOLLOWING: 28. FIRESPRAY ALL STRUCTURAL STEEL SUPPORTING SECOND, THIRD, AND ROOF TO ACHIEVE A 1HR FIRE RATING UNLESS SPECIFICALLY NOTED OTHERWISE

10. FOR STEEL COLUMN DRYWALL AND FIRE PROTECTION DETAILS, REFER 29. FLOOR FINISHES ARE ONLY INDICATED ON PLAN WHERE FLOORING TRANSITION OCCURS AT AN ATYPICAL LOCATION. REFER TO ROOM FINISH

SCHEDULE AND FLOOR FINISH PLANS FOR FLOOR FINISH. 30. ALL MECHANICAL AND ELECTRICAL RISERS NOT RUNNING INSIDE SHAFTS TO BE FURRED OUT WITH GWB FURRING ASSEMBLIES UNLESS INDICATED OTHERWISE

31. PROVIDE ONE MEMORY BOX (MB) AT EVERY RESIDENT ROOM DOOR. REFER TO DETAIL

32. APPLY CRYSTALLINE WATERPROOFING TO ALL ELEVATOR PITS.

FLOOR PLAN SHEET NOTES (01)

MAIN ENTRANCE

ANNUNCIATOR PANEL. REFER TO ELECTRICAL SOLID PHENOLIC WASHROOM/SHOWER PARTITION STALL

TRENCH DRAIN RECESSED IN CONCRETE, PROVIDE FLOOR REPRESSION. REFER TO SLAB EDGE, STRUCTURAL, AND MECHANICAL

ELEVATOR PIT LADDER AS PER ELEVATOR CODE REQUIREMENTS PROVIDE CEMENT BOARD UP TO 2440mm BEHIND EXHAUST HOOD.

EXTEND CEMENT BOARD 76mm HORIZONTALLY BEYOND EACH END OF HOOD. REFER TO FOOD SERVICES DRAWINGS FOR FINISH

750mmØ LINEN CHUTE W/ INTAKE DOORS AT EVERY FLOOR LEVEL ABOVE BASEMENT. COORDINATE DIMENSIONS OF SHAFT W/ LAUNDRY CHUTE MANUFACTURER

GENERATOR AND ENCLOSURE. REFER TO ELECTRICAL DRAWINGS BASE RAIL TO ALL SERVICE CORRIDOR PARTITION WALLS BENCH LOCATIONS. REFER TO LANDSCAPE DRAWINGS 150mm THICK CONCRETE HOUSEKEEPING PAD. REFER TO SLAB EDGE,

STRUCTURAL, MECHANICAL, ELECTRICAL, AND KITCHEN DRAWINGS SLAB DEPRESSION, REFER TO SLAB EDGE AND STRUCTURAL DRAWINGS LOCATION OF VACCINE FRIDGE ON EMERGENCY POWER, REFER TO ELECTRICAL DRAWINGS

CRICKET BUILD UP OF TAPERED FIBERBOARD INSULATION (TYP.) MIN. 1% SLOPED CONRETE TOPPING ON ALL TERRACES, SLOPING AWAY FROM FACE OF BUILDING

PROVIDE DUCT/SHAFT PENETRATION DOGHOUSE ENCLOSURE, REFER TO ARCHITECTURAL DETAILS AND MECHANICAL DRAWINGS GREASE INTERCEPTOR, REFER TO MECHANICAL & KITCHEN DRAWINGS

ROOF ANCHORS (RA) WITH GALVANIZED CABLE AND SHOCK ABSORBERS, REFER TO SPECIFICATIONS (TYPICAL)

MECHANICAL UNIT LOUVERED SCREENING, REFER TO DETAILS AND

SPECIFICATIONS ROOF EMERGENCY RELIEF SCUPPERS. REFER TO DETAILS AND

SPECIFICATIONS

610x610mm PRECAST CONCRETE ROOF PAVERS ON SUPPORTS

ROOF LADDER ON LEVEL 04 ONLY AND ACCESS HATCH ABOVE ROOFTOP UNITS, REFER TO MECHANICAL (TYP.)

PV PANELS ON BALLASTED SUPPORT STRUCTURE, REFER TO ELECTRICAL (TYP.) AIR HANDLING UNIT, REFER TO MECHANICAL (TYP.)

PUNCH CLOCK (S&I BY OWNER, REFER TO ELEC. FOR ROUGH-INS) STAINLESS STEEL CABINETS

ENTRANCE MAT (REFER TO SPEC) 1HR RATED HORIZONTAL & VERTICAL SHAFT ENCLOSURE AT BASE OF MECHANICAL SHAFT ABOVE

INTUMESCENT PAINT ON STRUCTURAL COLUMN HOSE BIB (REFER TO MECHANICAL DRAWINGS) FREE-STANDING NON-FREEZE HOSE BIB (REFER TO MECH)

COORDINATE ON SITE AS DIRECTED BY CONSULTANT.

FIRE DEPARTMENT SIAMESE CONNECTION & SIGNAGE LOCATION. REFER TO MECHANICAL DRAWINGS

LOCATION OF GAS FIREPLACE CONTROLS. CONTRACTOR TO

TRANSFORMER ON CONCRETE PAD. REFER TO ELECTRICAL DRAWINGS 150mm BOLLARD

PROVIDE BLOCKING FOR OWNER-SUPPLIED 1525mm LONG BALLET


PROVIDE BLOCKING FOR OWNER-SUPPLIED WALL-MOUNTED MAIL SLOTS SUMP PUMP, REFER TO MECH.

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APPLICATION & ZONING BY-LAW AMENDMENT

APPLICATION & ZONING BY-LAW AMENDMENT

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FLOOR PLAN - LEVEL 02-04

job number: 21-08-27 plot date:

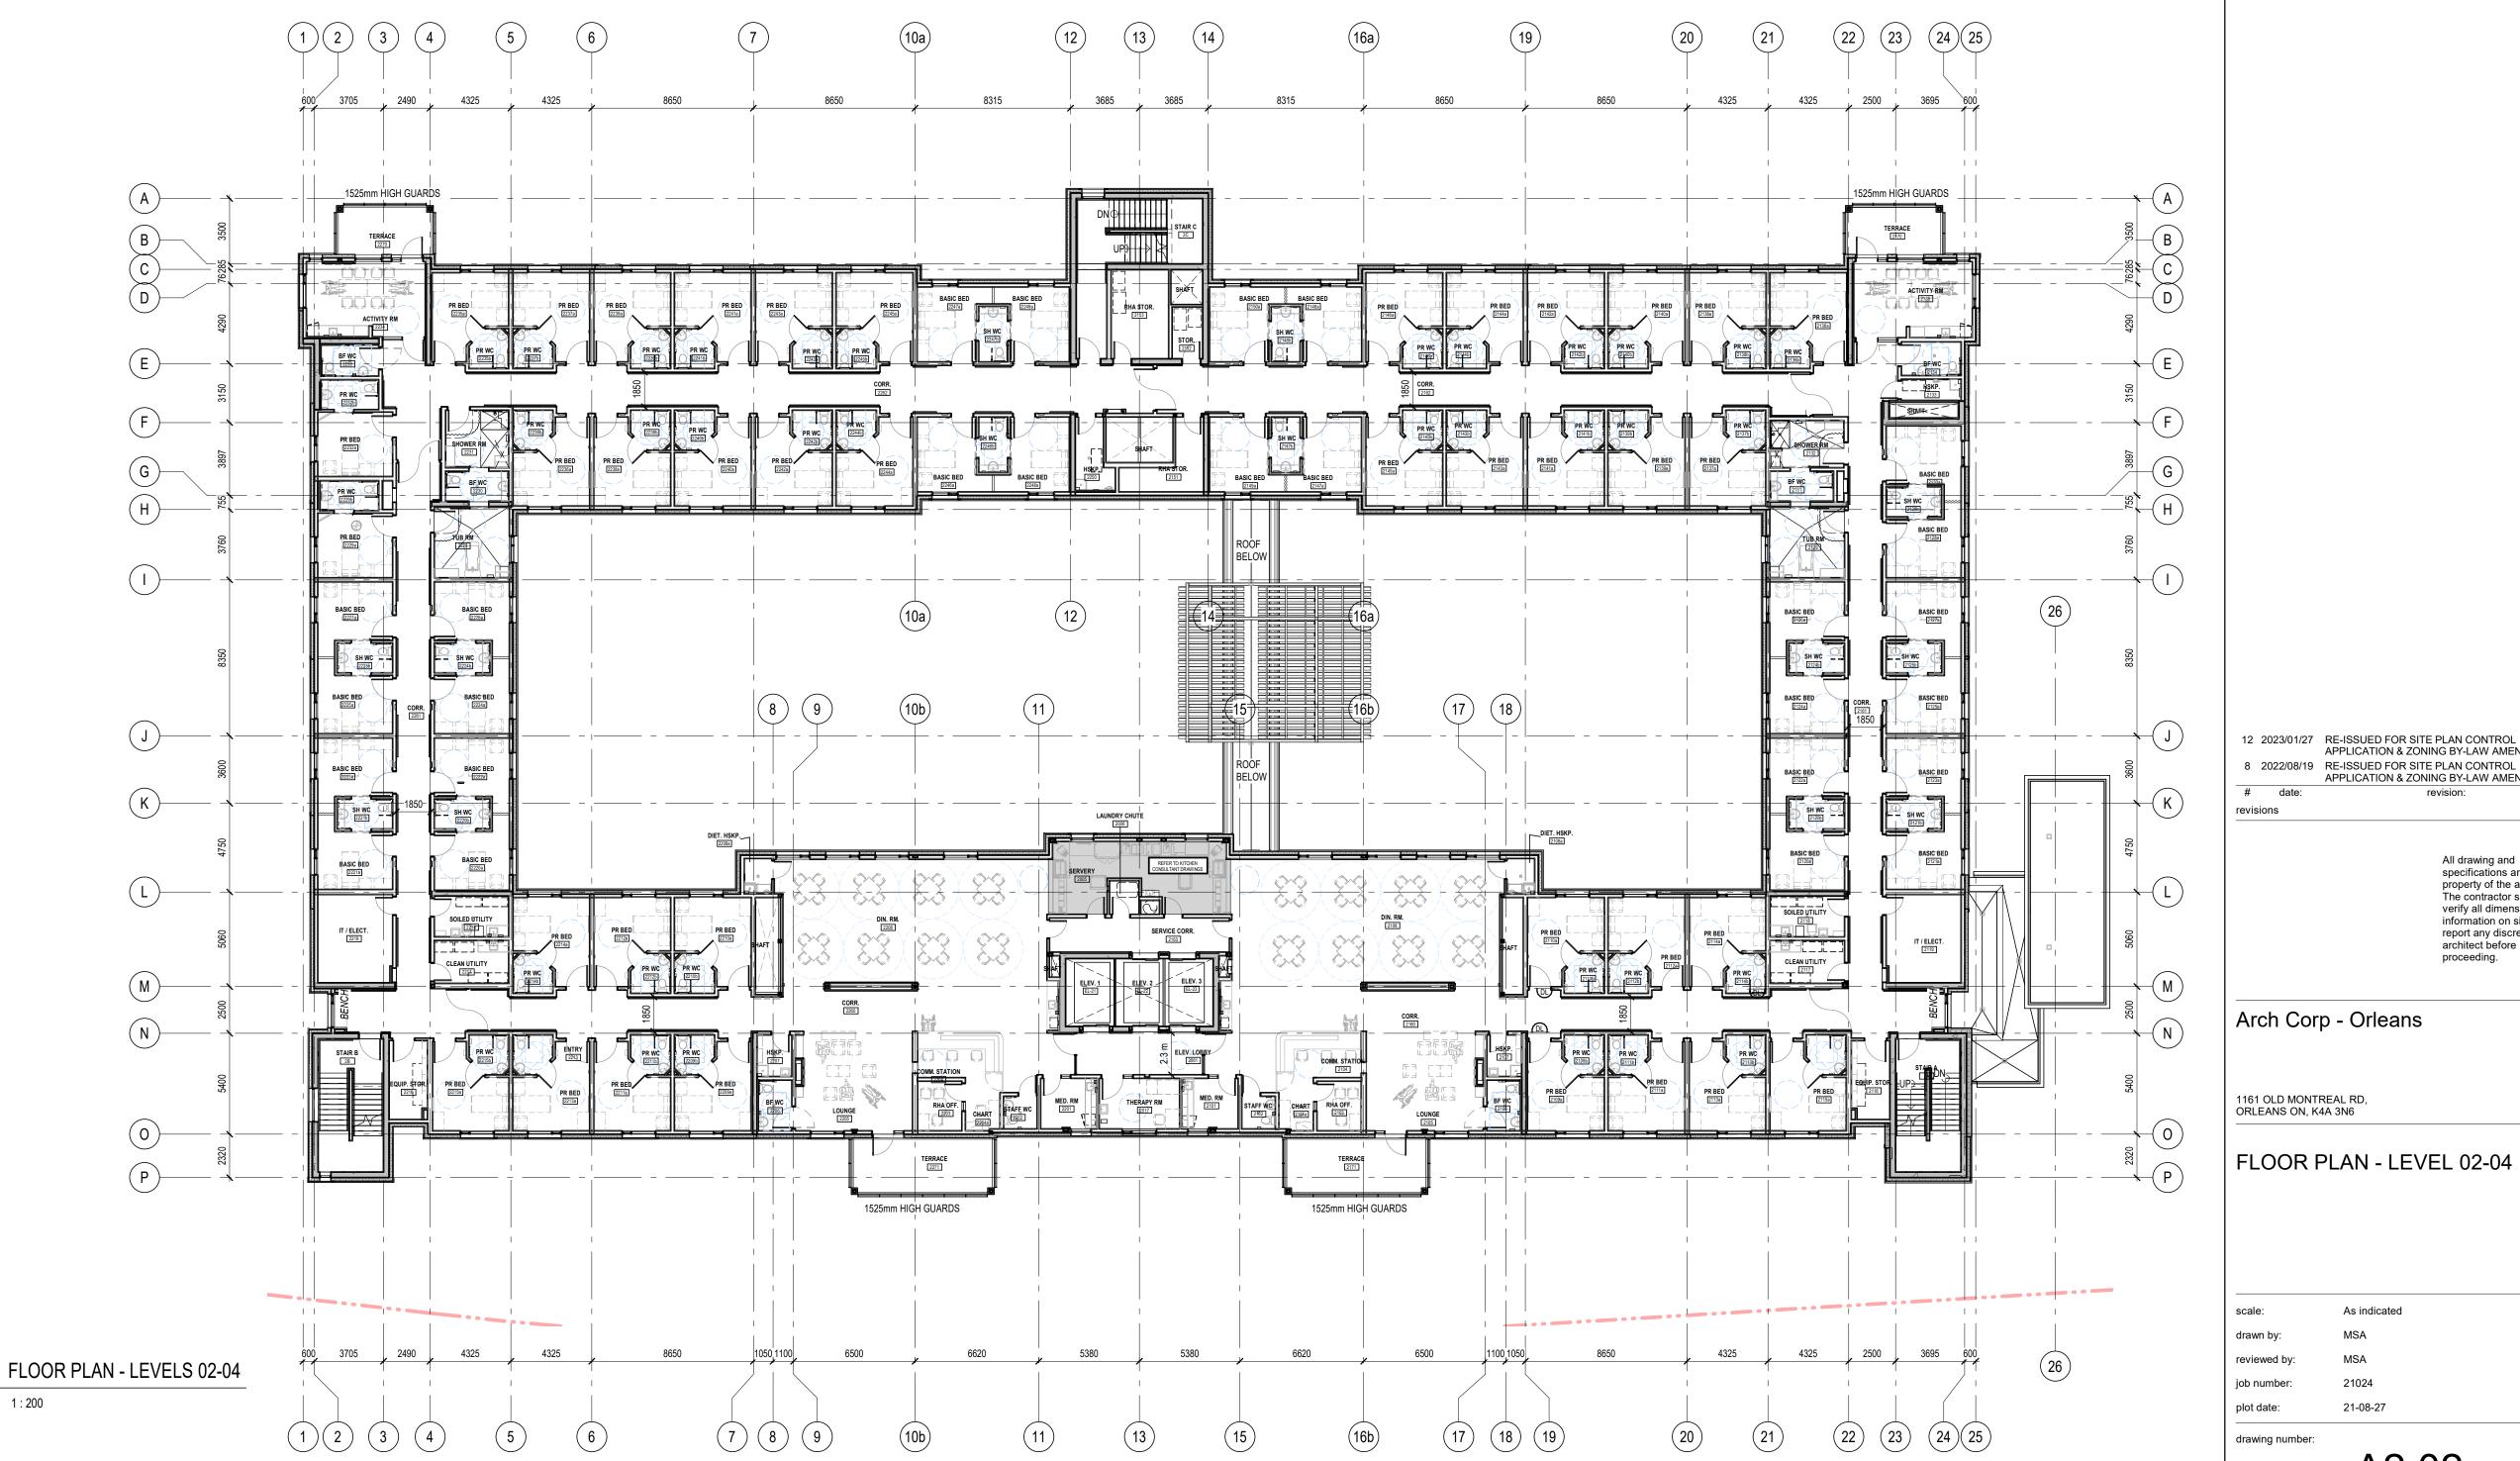.A2.02

FLOOR PLAN LEGEND ACS ADULT CHANGE STATION MRL-CH MOBILE RESIDENT LIFT -ADO BPD AUTO DOOR OPERATOR MRL-FL MOBILE RESIDENT LIFT -BEDPAN DISINFECTOR CD CHEMICAL DISPENSING UNIT FLOOR LIFT CG1 ACROVYN CORNER GUARD MRL-SS MOBILE RESIDENT LIFT -CG2 STAINLESS STEEL CORNER SIT TO STAND MOP SINK ACROVYN CORNER GUARD CG3 NURSE CALL CG4 PRIVACY CURTAIN STAINLESS STEEL CORNER PAPER TOWEL DISPENSER CSS PVP CLINIC SERVICE SINK PHOTO VOLTAIC PANEL ROOF DRAIN EXHAUST FAN EW REFRIGERATOR EYE WASH FLOOR DRAIN RAIN WATER LEADER FEC1 FIRE EXTINGUISHER CABINET | SD SOAP DISPENSER FIRE EXTINGUISHER FEC2 SHCH SHAMPOO CHAIR FLS SHAMPOO SINK FLOOR SCRUBBER FRPL1 ELECTRIC FIREPLACE SANITARY NAPKING DISPOSAL FRPL2 GAS FIREPLACE STAINLESS STEEL SHELF GB1 SPRINKLER VALVE CABINET GRAB BAR 1 GB2 (REFER TO MECH) **GRAB BAR 2** GB3 **GRAB BAR 3** TRENCH DRAIN GB4 GRAB BAR 4 TOWEL ROD GB5 GRAB BAR 5 TPD TOILET PAPER DISPENSER HDRL HANDRAIL RAPSODY TUB (TBD) HAND SANITIZER TELEVISION TELEVISION BRACKET HST HOOK STRIP TV/BRK LKR LOCKER VDM VENDING MACHINE MEMORY BOX (RECESSED) MB MANUAL BLINDS

MEDICINE CABINET

MIRROR

MOP HOLDER

MPH

FLOOR PLAN GENERAL NOTES 1. ALL OVERALL CONSTRUCTION PLANS TO BE READ IN CONJUNCTION WITH

- DIMENSIONS, UNLESS NOTED OTHERWISE, ARE MEASURED IN ORDER OF EQUIPMENT.
- CONTRACTOR SHALL PROTECT EXISTING FINISHES FROM DAMAGE DURING SHEATHING BLOCKING AT ALL LOCATIONS WHERE EQUIPMENT TO BE CONSTRUCTION. CONTRACTOR SHALL BE RESPONSIBILE TO REPAIR AND MAKE GOOD ANY SURFACES AFFECTED B DEMOLITION AND/OR CONTRACTOR TO CORE SLAB FOR IN-SLAB RECESSED FLOOR BOXES. REFER TO ELEC. DRAWINGS FOR TYPE/QUANTITY. CONTRACTOR TO SCAN
- SLAB AS REQUIRED AND CONFIRM FINAL LOCATIONS FOR EACH FLOOR BOX WITH CONSULTANT FOR COORDINATION W/ FURNITURE PLACEMENT. CONTRACOR SHALL PROVIDE PARTITION CHALK LINE LAYOUT ON SLAB FOR REVIEW AND APPROVAL BY DESIGNER PRIOR TO PROCEEDING WITH INSTALLATION OF TRACK AND STUDS.

IMPORTANCE TO:

CONSTRUCTION.

.A2.03

FACE OF CONCRETE/PARTITION

A. GRID LINES

- SOUND ATTENUATION BLANKETS SHALL BE INSTALLED CONTINUOUSLY BEHIND ALL POWER, VOICE, AND DATA OUTLETS AND OTHER DEVICES RECESSED INTO PARTITIONS.
- COORDINATE ALL BASE TYPES WITH GWB CONSTRUCTION. REFER TO ROOM FINISH SCHEDULE AND DRAWINGS. ALL PARTITIONS SCHEDULED TO RECEIVE RESILENT BASE ARE TO BE
- COMPLETELY FINISHED SMOOTH TO THE SLAB. UNLESS NOTED OTHERWISE, DOOR LOCATIONS SHALL BE 100mm FROM
- FACE OF WALL TO OUTSIDE OF DOOR FRAME AND NOT LESS THAN 100mm.
- 10. CONTRACTOR SHALL PATCH AND REPAIR ALL EXISTING GWB SURFACES AS REQUIRED TO MAKE GOOD AND MAKE READY TO RECEIVE NEW FINISHES.

11. CONTRACTOR SHALL REFER TO ROOM FINISH SCHEDULE AND FINISH

SPECIFICATIONS FOR ALL BASE TYPES AND HEIGHTS. 12. WHERE FIRE SEPARATIONS OCCUR, EXTEND PARTITIONS TO UNDERSIDE OF SLAB. PACK ANY OPENINGS BETWEEN STRUCTURE OR ROOF AND PARTITIONS WITH FIRE STOPPING MATERIAL. PACK AROUND PENETRATIONS THROUGH FIRE SEPARATIONS WITH FIRE STOPPING MATERIAL.

- 13. AT RECESSED PANELS AND EQUIPMENT IN FIRE SEPARATIONS, MAINTAIN THE CONTINUITY OF THE REQUIRED IFRE SEPARATIONS BEHIND THE
- 14. WRAP PLUMBING PIPES WITH NON-COMBUSTIBLE INSULATION TO MUFFLE SOUND TRANSMISSION. 15. PROVIDE 400mm HIGH 26 GA. SHEET METAL BLOCKING OR 16mm PLYWOOD
- INSTALLED. BLOCKING HEIGHT TO SUIT EQUIPMENT. 16. WHERE PARTITIONS OF VARYING THICKNESS ALIGN, STEP THE FLOOR AND CEILING TRACKS AS REQUIRED TO ENSURE A FLUSH FINISHED CONDITION ON THE EXPOSED FACE.
- 17. REFER TO MILLWORK REFERENCE PLAN FOR MILLWORK DETAILS. 18. FOR FIRE EXTINGUISHER CABINETS, REFER ALSO TO MECHANICAL DRAWINGS.
- 19. FURRING WALLS AROUND COLUMNS AND PIPES TO BE BUILT AS TIGHT AS POSSIBLE UNLESS NOTED OTHERWISE. 20. CONTRACTOR TO MARK OUT ALL THERMOSTAT AND SWITCHING LOCATIONS
- ON SITE FOR DESIGNER APPROVAL PRIOR TO INSTALLATION. 21. TYPICAL RESIDENT ROOM DETAILS: UNLESS NOTED OTHERWISE, FURRING AND PARTITION TYPES, INTERIOR ELEVATION REFERENCES, PLAN DETAIL REFERENCES, AND DIMENSIONS, NOTES, ACCESSORIES AND ANYTHING ELSE NOTED IN TYPICAL DRAWINGS ON A7.01 ARE TYPICAL FOR ALL RESIDENT ROOMS ON ALL FLOORS.
- 22. TYPICAL TUB AND SHOWER ROOM DETAILS: UNLESS NOTED OTHERWISE, FURRING AND PARTITION TYPES, INTERIOR ELEVATION REFERENCES, PLAN DETAIL REFERENCES AND DIMENSIONS, NOTES, ACCESSORIES AND ANYTHING ELSE NOTED IN TYPICAL DRAWINGS ON A7.02 ARE TYPICAL FOR ALL TUB AND SHOWER ROOMS ON ALL FLOORS.
- 23. WALL PARTITIONS, FURRING TYPES, DIMENSIONS, NOTES, TAGS, INTERIOR ELEVATION REFERENCES, AND OTHER INFORMATION INDICATED ON THE SECOND FLOOR ARE TYPICAL FOR FLOORS 2-3 UNLESS INDICATED OTHERWISE, OR AT AREAS SHOWING DIFFERENT LAYOUTS. 24. ALL CLOSETS TO HAVE ROD AND SHELF UNLESS NOTED OTHERWISE.

25. ALL CLOSETS TO BE 600MM CLEAR INSIDE UNLESS NOTED OTHERWISE.

- 26. UNLESS OTHERWISE NOTED, ALWAYS PROVIDE F14 FURRING AT ENDS OF CONCRETE WALLS (WHERE CONCRETE WALL IS TO BE CLAD IN GWB). 27. ANY NON-STRUCTURAL PARTITION WHICH ARE NOT LABELLED SHOULD BE
- ASSUMED TO BE THE FOLLOWING: 28. FIRESPRAY ALL STRUCTURAL STEEL SUPPORTING SECOND, THIRD, AND ROOF TO ACHIEVE A 1HR FIRE RATING UNLESS SPECIFICALLY NOTED OTHERWISE 10. FOR STEEL COLUMN DRYWALL AND FIRE PROTECTION DETAILS, REFER
- 29. FLOOR FINISHES ARE ONLY INDICATED ON PLAN WHERE FLOORING
- SCHEDULE AND FLOOR FINISH PLANS FOR FLOOR FINISH. 30. ALL MECHANICAL AND ELECTRICAL RISERS NOT RUNNING INSIDE SHAFTS TO BE FURRED OUT WITH GWB FURRING ASSEMBLIES UNLESS INDICATED OTHERWISE.

(10a)

31. PROVIDE ONE MEMORY BOX (MB) AT EVERY RESIDENT ROOM DOOR. REFER

(13)

TRANSITION OCCURS AT AN ATYPICAL LOCATION. REFER TO ROOM FINISH

TO DETAIL 32. APPLY CRYSTALLINE WATERPROOFING TO ALL ELEVATOR PITS.

FLOOR PLAN SHEET NOTES (9)

- MAIN ENTRANCE
- ANNUNCIATOR PANEL. REFER TO ELECTRICAL SOLID PHENOLIC WASHROOM/SHOWER PARTITION STALL
- TRENCH DRAIN RECESSED IN CONCRETE, PROVIDE FLOOR REPRESSION. REFER TO SLAB EDGE, STRUCTURAL, AND MECHANICAL
- ELEVATOR PIT LADDER AS PER ELEVATOR CODE REQUIREMENTS
- PROVIDE CEMENT BOARD UP TO 2440mm BEHIND EXHAUST HOOD. EXTEND CEMENT BOARD 76mm HORIZONTALLY BEYOND EACH END OF
- HOOD. REFER TO FOOD SERVICES DRAWINGS FOR FINISH 750mmØ LINEN CHUTE W/ INTAKE DOORS AT EVERY FLOOR LEVEL
- ABOVE BASEMENT. COORDINATE DIMENSIONS OF SHAFT W/ LAUNDRY CHUTE MANUFACTURER
- GENERATOR AND ENCLOSURE. REFER TO ELECTRICAL DRAWINGS BASE RAIL TO ALL SERVICE CORRIDOR PARTITION WALLS
- BENCH LOCATIONS. REFER TO LANDSCAPE DRAWINGS 150mm THICK CONCRETE HOUSEKEEPING PAD. REFER TO SLAB EDGE, STRUCTURAL, MECHANICAL, ELECTRICAL, AND KITCHEN DRAWINGS
- SLAB DEPRESSION, REFER TO SLAB EDGE AND STRUCTURAL DRAWINGS LOCATION OF VACCINE FRIDGE ON EMERGENCY POWER, REFER TO ELECTRICAL DRAWINGS
- CRICKET BUILD UP OF TAPERED FIBERBOARD INSULATION (TYP.) MIN. 1% SLOPED CONRETE TOPPING ON ALL TERRACES, SLOPING AWAY FROM FACE OF BUILDING
- PROVIDE DUCT/SHAFT PENETRATION DOGHOUSE ENCLOSURE, REFER TO ARCHITECTURAL DETAILS AND MECHANICAL DRAWINGS
- GREASE INTERCEPTOR, REFER TO MECHANICAL & KITCHEN DRAWINGS ROOF ANCHORS (RA) WITH GALVANIZED CABLE AND SHOCK ABSORBERS, REFER TO SPECIFICATIONS (TYPICAL)

- MECHANICAL UNIT LOUVERED SCREENING, REFER TO DETAILS AND SPECIFICATIONS
- ROOF EMERGENCY RELIEF SCUPPERS. REFER TO DETAILS AND

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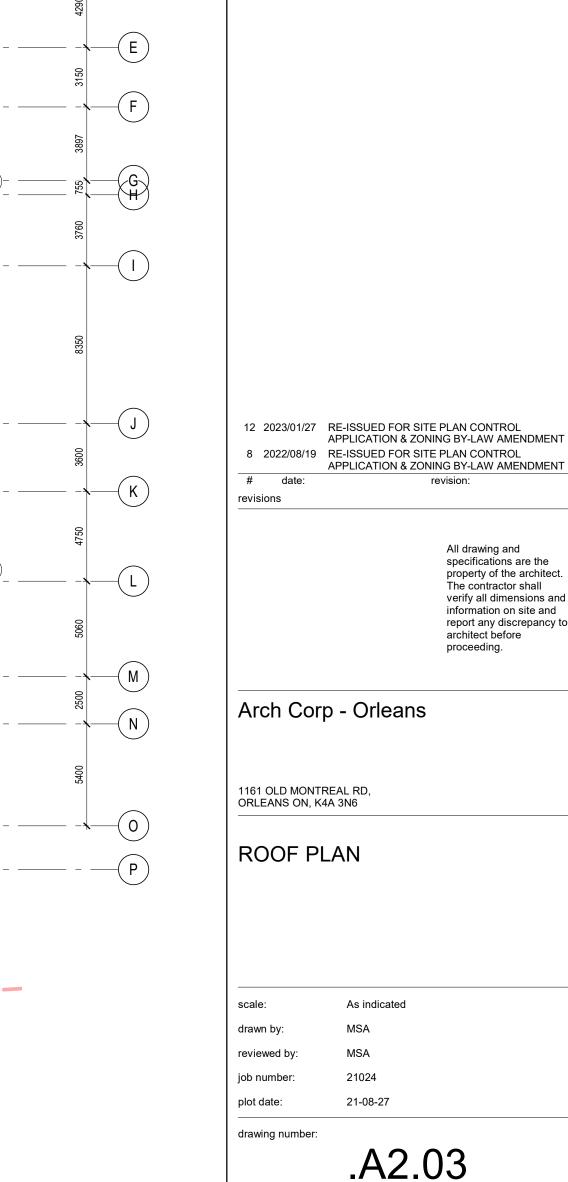
- SPECIFICATIONS 610x610mm PRECAST CONCRETE ROOF PAVERS ON SUPPORTS
- ROOF LADDER ON LEVEL 04 ONLY AND ACCESS HATCH ABOVE ROOFTOP UNITS, REFER TO MECHANICAL (TYP.)
- PV PANELS ON BALLASTED SUPPORT STRUCTURE, REFER TO
- ELECTRICAL (TYP.)
- AIR HANDLING UNIT, REFER TO MECHANICAL (TYP.)
- PUNCH CLOCK (S&I BY OWNER, REFER TO ELEC. FOR ROUGH-INS)
- STAINLESS STEEL CABINETS ENTRANCE MAT (REFER TO SPEC)
- 1HR RATED HORIZONTAL & VERTICAL SHAFT ENCLOSURE AT BASE OF MECHANICAL SHAFT ABOVE
- INTUMESCENT PAINT ON STRUCTURAL COLUMN HOSE BIB (REFER TO MECHANICAL DRAWINGS)


FREE-STANDING NON-FREEZE HOSE BIB (REFER TO MECH)

- LOCATION OF GAS FIREPLACE CONTROLS. CONTRACTOR TO COORDINATE ON SITE AS DIRECTED BY CONSULTANT. FIRE DEPARTMENT SIAMESE CONNECTION & SIGNAGE LOCATION. REFER
- TO MECHANICAL DRAWINGS TRANSFORMER ON CONCRETE PAD. REFER TO ELECTRICAL DRAWINGS
- 150mm BOLLARD
- PROVIDE BLOCKING FOR OWNER-SUPPLIED 1525mm LONG BALLET


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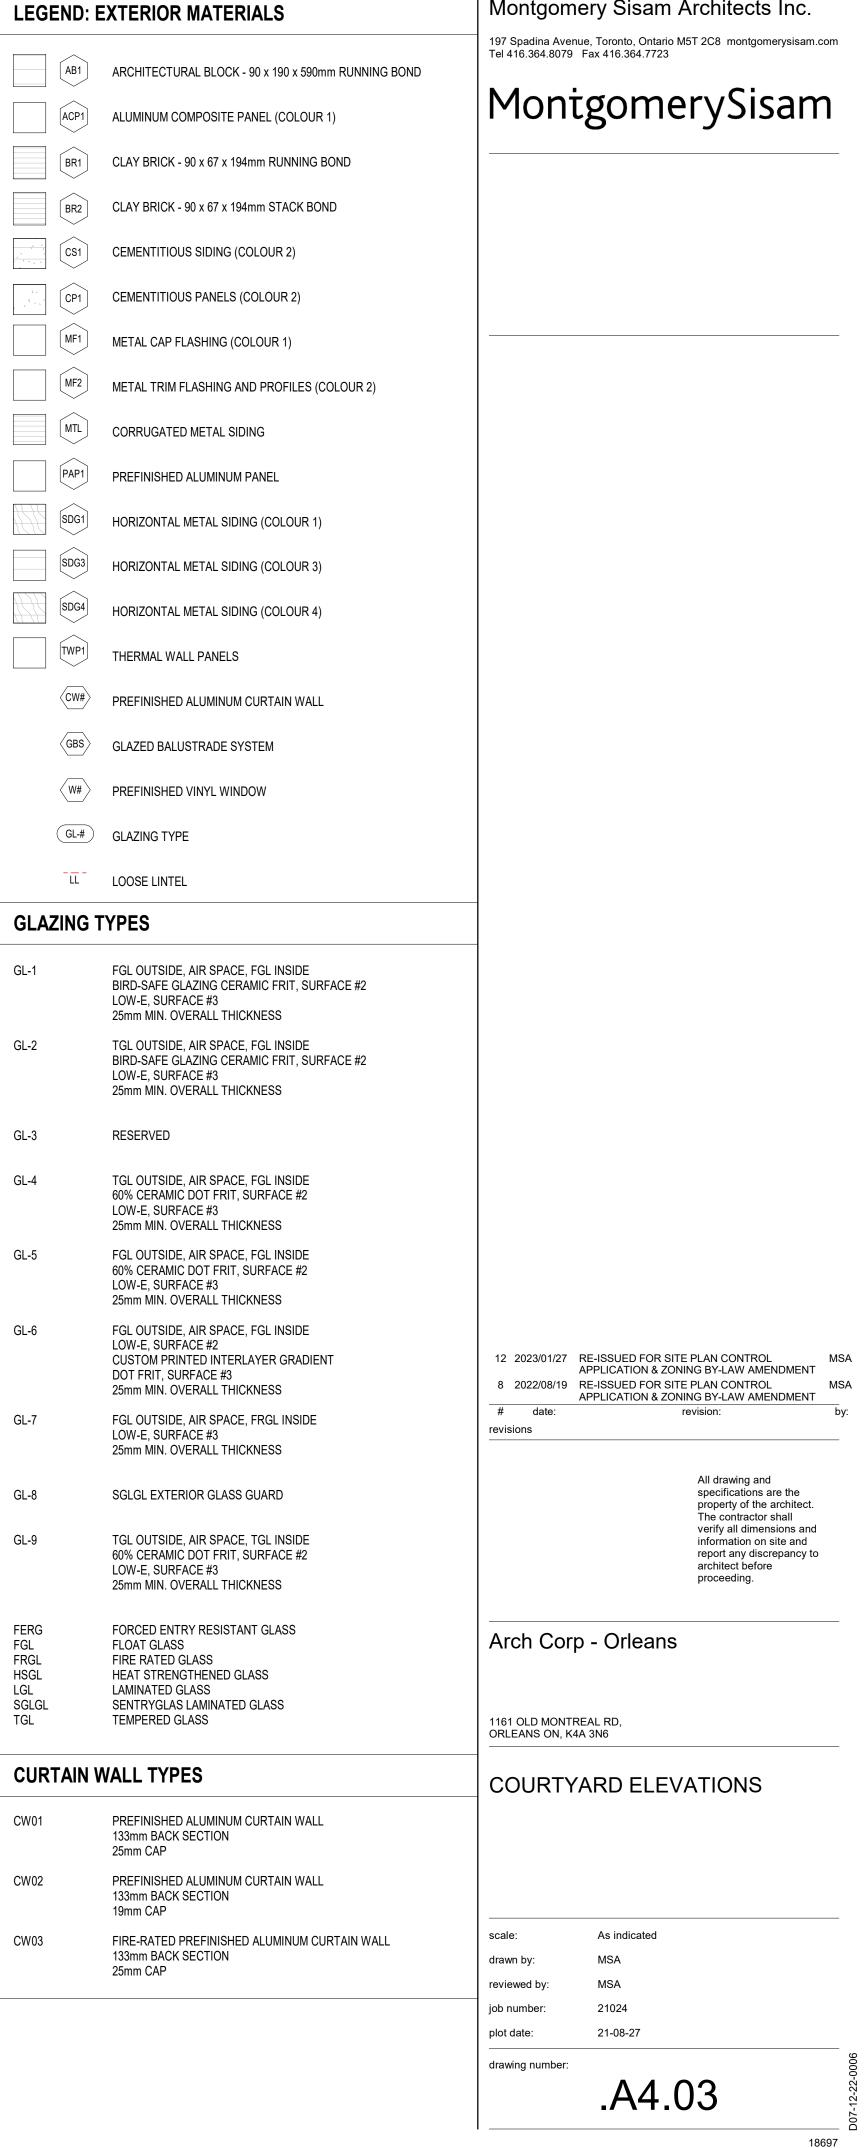
PROVIDE BLOCKING FOR OWNER-SUPPLIED WALL-MOUNTED MAIL SLOTS SUMP PUMP, REFER TO MECH.



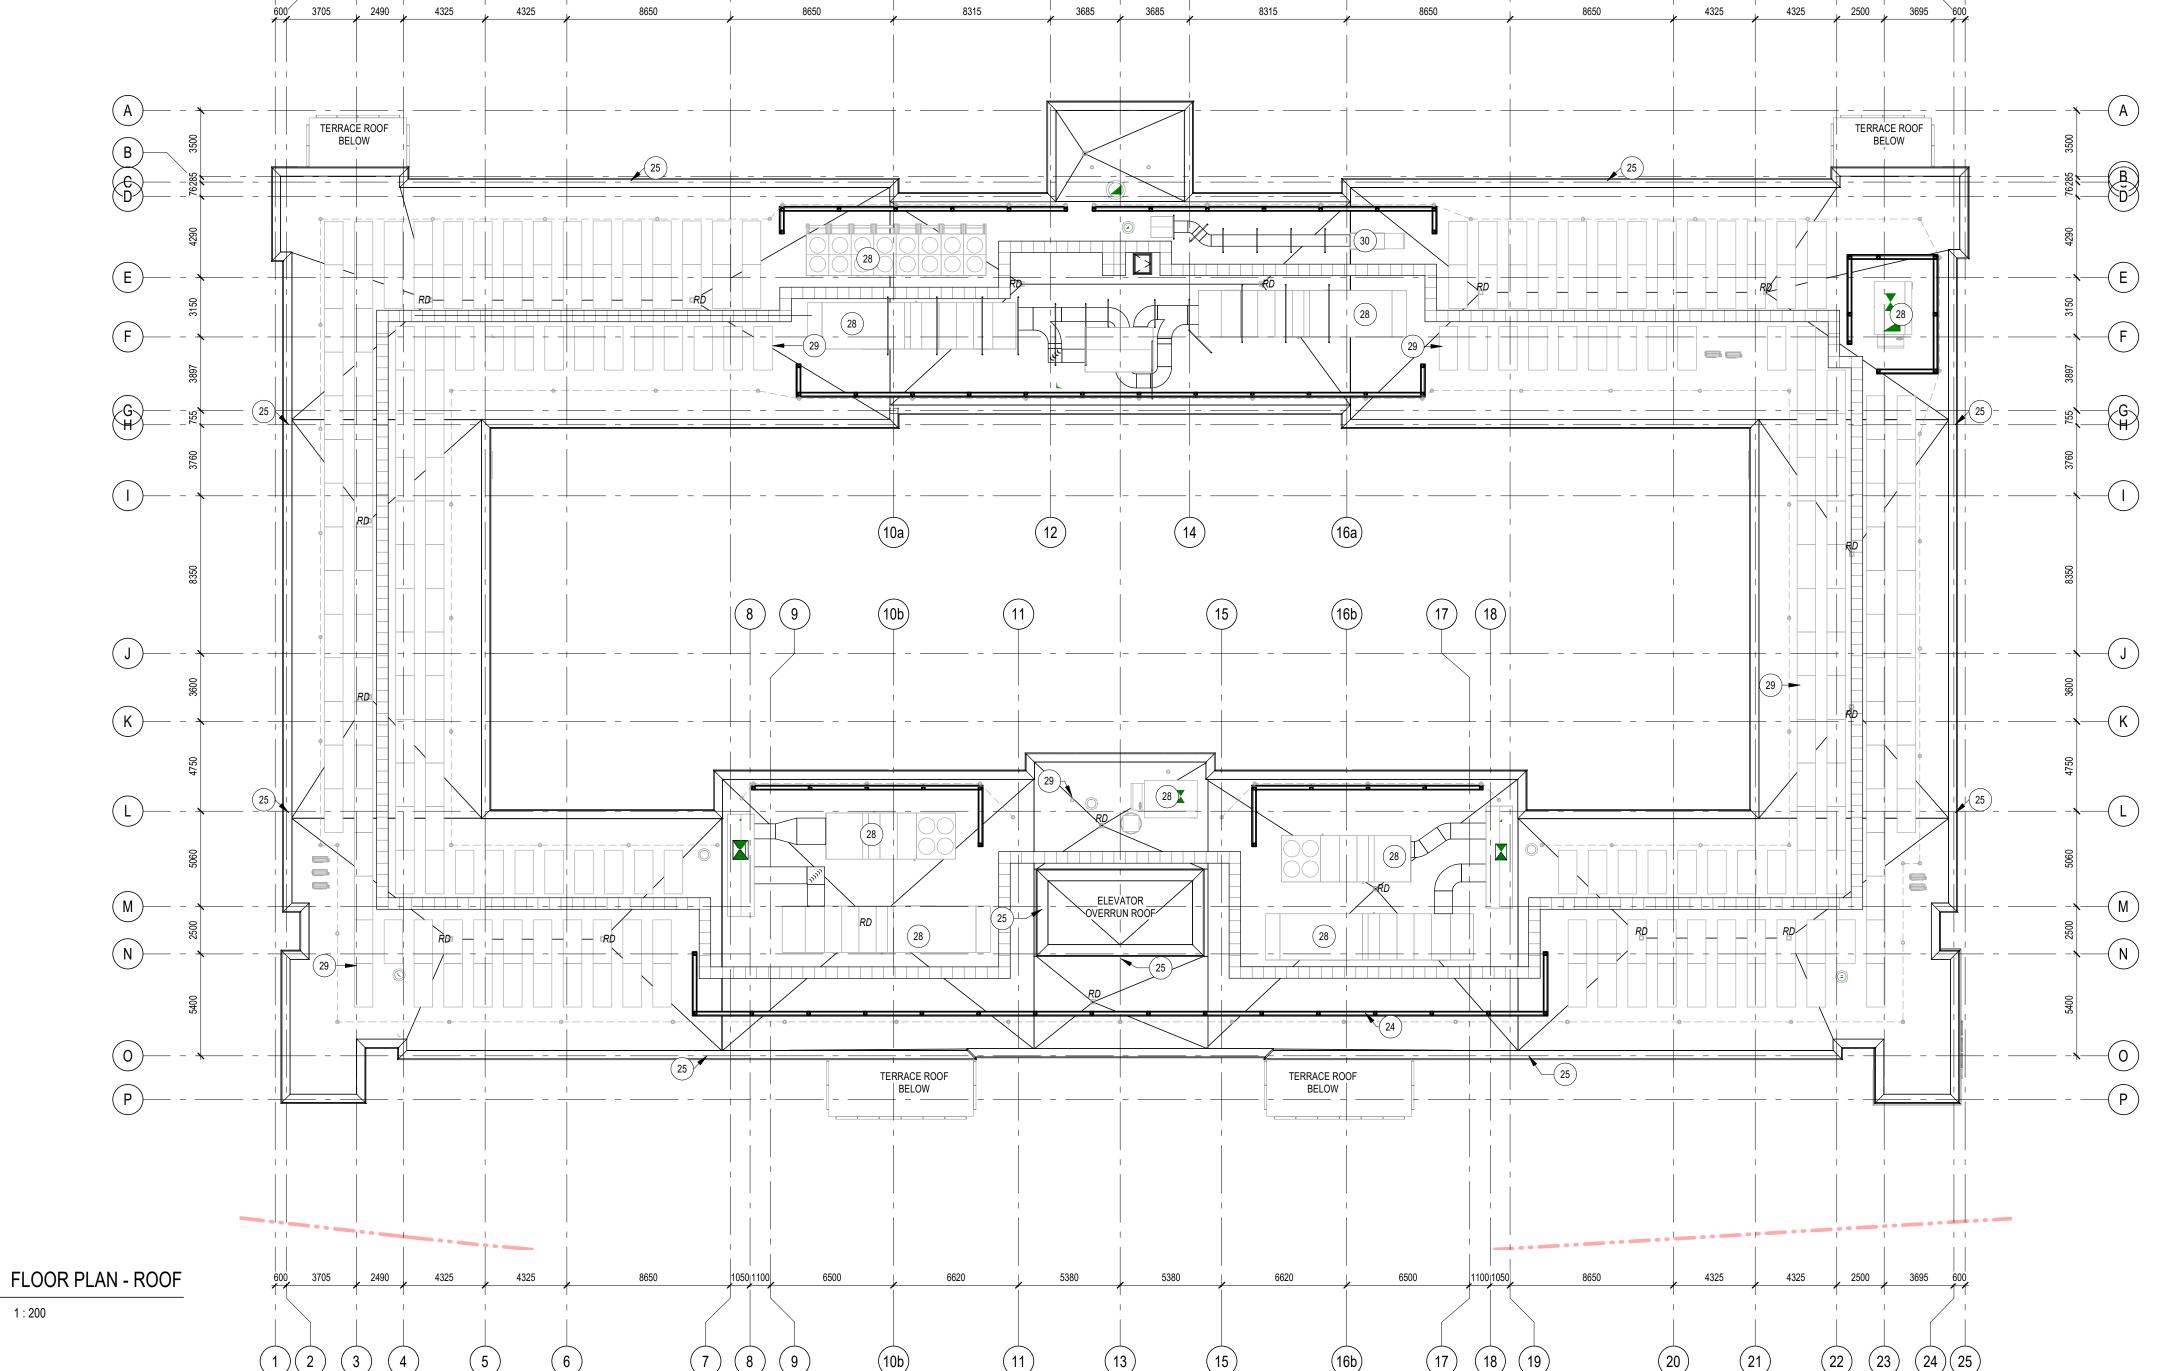

18697



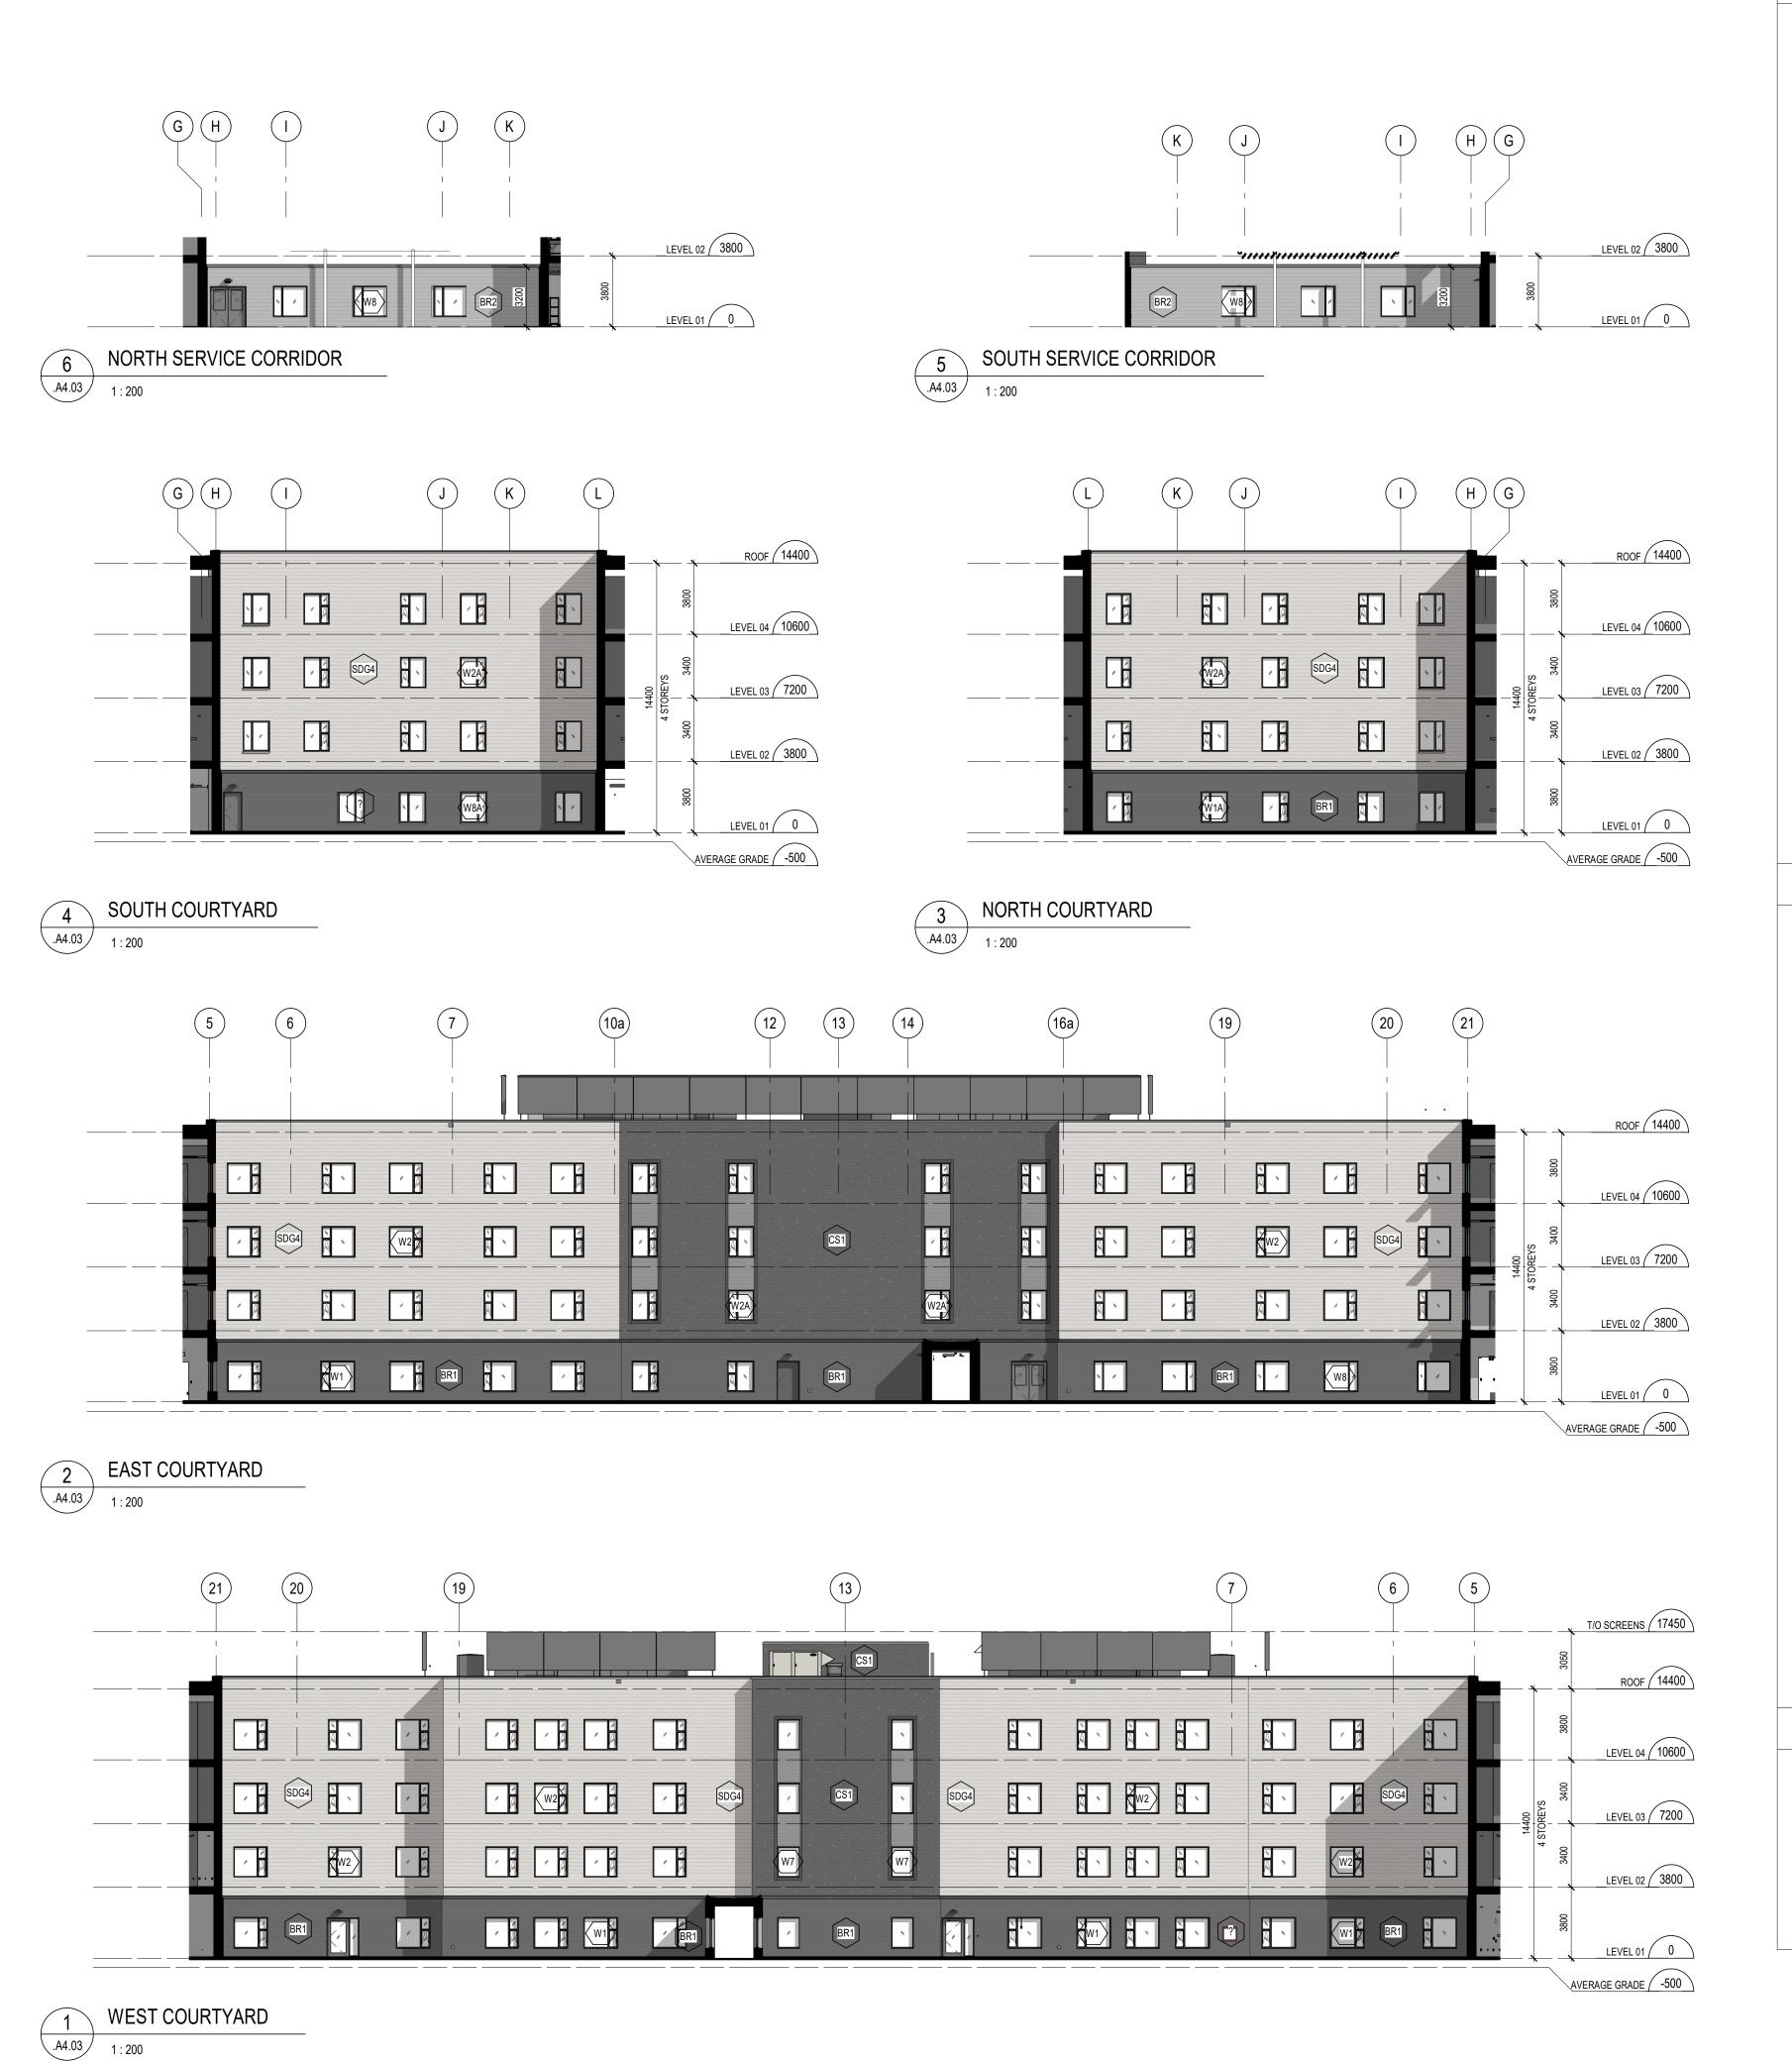

12 2023/01/27 RE-ISSUED FOR SITE PLAN CONTROL APPLICATION & ZONING BY-LAW AMENDMENT 8 2022/08/19 RE-ISSUED FOR SITE PLAN CONTROL APPLICATION & ZONING BY-LAW AMENDMENT revisions All drawing and specifications are the property of the architect. verify all dimensions and information on site and report any discrepancy to architect before Arch Corp - Orleans 1161 OLD MONTREAL RD, ORLEANS ON, K4A 3N6 BUILDING SECTIONS 1:200 drawn by: job number: 21-08-27 plot date: drawing number: .A5.01

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.A5.01 1 : 200



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12 2023/01/27 RE-ISSUED FOR SITE PLAN CONTROL APPLICATION & ZONING BY-LAW AMENDMENT 8 2022/08/19 RE-ISSUED FOR SITE PLAN CONTROL
APPLICATION & ZONING BY-LAW AMENDMENT
5 2021/12/02 ISSUED FOR SITE PLAN CONTROL
APPLICATION & ZONING BY-LAW AMENDMENT 4 2021/11/19 ISSUED FOR 100% DESIGN DEVELOPMENT MSA

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PERSPECTIVES


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12 2023/01/27 RE-ISSUED FOR SITE PLAN CONTROL APPLICATION & ZONING BY-LAW AMENDMENT 8 2022/08/19 RE-ISSUED FOR SITE PLAN CONTROL APPLICATION & ZONING BY-LAW AMENDMENT

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SOLAR STUDY

.A10.02





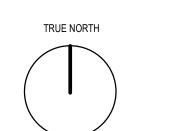



