


NEW SITE PLAN LEGEND	
	EXISTING BUILDING TO REMAIN
	DEMOLISH EXISTING BUILDING AND OBJECTS
	EXISTING BUILDING NOT IN CONTRACT
	NEW ADDITION BUILDING
	EXISTING ASPHALT TO REMAIN
	NEW ASPHALT
	EXISTING CONCRETE SIDEWALK TO REMAIN
	NEW CONCRETE SIDEWALK
	EXISTING CRUSHED STONE PARCKING TO REMAIN
	NEW GRANULAR PER LANDSCAPING
	EXISTING PLANTING TO REMAIN

NEW SITE PLAN LEGEND	
	EXISTING BUILDING TO REMAIN
	DEMOLISH EXISTING BUILDING AND OBJECTS
	EXISTING BUILDING NOT IN CONTRACT
	NEW ADDITION BUILDING
	EXISTING ASPHALT TO REMAIN
	NEW ASPHALT
	EXISTING CONCRETE SIDEWALK TO REMAIN
	NEW CONCRETE SIDEWALK
	EXISTING CRUSHED STONE PARCKING TO REMAIN
	NEW GRANULAR PER LANDSCAPING
	EXISTING PLANTING TO REMAIN
	NEW PLANTING

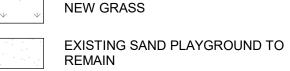

# NEW SAND PLAYGROUND

MUD SLAB PER CIVIL. (TEMPORARY CONSTRUCTION)

# PROPERTY LINE

ROAD SETBACK

---- OVERHEAD

—— - - — SETBACK LINE

# ——x——x——x—— EXISTING FENCE TO REMAIN

——x——x—— NEW FENCE

#### CONSTRUCTION TP—TP—TP—TREE PROTECTION PER LANDSCAPING

—wtr——wtr——wtr— EXISTING WATER SUPPLY TO REMAIN

## 

——SAN——SAN——SAN—— EXISTING SANITARY TO REMAIN 

## ——san——san—— NEW SANITARY

—st—st—st— NEW STORM

#### EXISTING ELECTRICAL SERVICE TO REMAIN (BELOW GRADE) NEW ELECTRICAL SERVICE (BELOW GRADE)

BUILDING ENTRANCE / EXIT

#### LIGHT STAND - EXISTING ⊕ Ls LIGHT STAND - NEW

MANHOLE - EXISTING

## MANHOLE - NEW

UTILITY POLE - NEW

TREE - EXISTING

UTILITY POLE - EXISTING

TREE - NEW

### **SITE PLAN KEYNOTES:**

1 EXISTING SKATING RING TO REMAIN

2 EXISTING SOCCER FIELD TO REMAIN

3 EXISTING BASEBALL DIAMOND TO REMAIN

4 EXISTING COVERED DECK TO REMAIN

5 EXISTING STORAGE UNIT TO REMAIN

7 EXISTING DRILLED WELL TO REMAIN. VERIFY LOCATION ON

6 EXISTING ROOF OVERHANG ABOVE TO REMAIN

8 EXISTING ASPHALT PAVING TO REMAIN

9 EXISTING CURB TO REMAIN

10 EXISTING ASPHALT SIDEWALK TO REMAIN

11 EXISTING SEPTIC TANK TO REMAIN

12 EXISTING SEPTIC DRAIN FIELD TO REMAIN. ELIMINATE AUTOMOBILE AND EQUIPMENT MOVEMENT OVER THIS

13 PARKING SPACES RESERVED FOR SOCCER TEAMS DURING

CONSTRUCTION 14 EXISTING GRAVEL PARKING TO REMAIN

15 EXISTING ACCESSIBLE CONCRETE CURB RAMP AND DEPRESSED CURB TO REMAIN

16 EXISTING HOSE BIB TO REMAIN. ENSURE RUNNING WATER FOR HOCKEY RING DURING CONSTRUCTION.

17 EXISTING PLAYGROUND TO REMAIN

18 EXISTING BENCH TO REMAIN EXISTING SEPTIC FIELD AND SANITARY SERVICE. SHOWN LOCATIONS ARE APPROXIMATE. VERIFY LOCATIONS ON

20 PORTION OF EXISTING LUMBER FENCE TO REMAIN. COORDINATE EXTENT ON SITE.

21 PORTION OF EXISTING ASPHALT SIDEWALK TO REMAIN

22 PORTION OF EXISTING CONCRETE CURB TO REMAIN PORTION OF EXISTING ASPHALT PAVING TO REMAIN

51 REQUIRED STRUCTURE SETBACK

52 NEW CONCRETE PAVING PER LANDSCAPING

53 NEW GRANULAR PER LANDSCAPING

54 NEW ROOF OVERHANG ABOVE

12000mm MIN.

55 NEW HEAT PUMP AND CONDENSING UNITS PER MECHANICAL ON CONCRETE PAD. SURROUND BY LINK FENCE WITH LOCKABLE ACCESS GATE.

NEW TOP SOIL AND GRASS AT AREA AFFECTED BY

CONSTRUCTION AND PER LANDSCAPING NEW ACCESS ROUTE FOR FIRE DEPARTMENT (SHOWN DASHED). CLEAR WIDTH 6000mm MIN., CENTERLINE RADIUS

NEW HEAVY DUTY GRAVEL PAVEMENT STRUCTURE DESIGNED TO SUPPORT FIREFIGHTING EQUIPMENT AND PERMIT ACCESSIBILITY UNDER ALL CLIMATIC CONDITIONS PER CIVIL

NEW ASPHALT HEAVY DUTY PAVEMENT STRUCTURE DESIGNED TO SUPPORT FIRE FIGHTING EQUIPMENT PER

60 EXTEND DRIVEWAY PER CIVIL AS REQUIRED. VERIFY

EXTENT OF EXISTING DRIVEWAY ON SITE. 61 EXTEND CULVERT PER CIVIL AS REQUIRED. VERIFY EXTENT OF EXISTING CULVERT ON SITE.

62 TEMPORARY FENCING COMPLETED WITH ACCESS GATES FOR PERIOD OF CONSTRUCTION

63 NEW POST AND ACCESSIBLE PARKING SIGN.

64 NEW SANITARY SEWAGE PER CIVIL

65 NEW PLANTING PER LANDSCAPING 66 INSTALL SALVAGED BICYCLE RACKS. ADJUST AS REQUIRED.

67 INSTALL SALVAGED SWINGS PER LANDSCAPING

68 INSTALL SALVAGED PLAY STRUCTURES PER LANDSCAPING

69 NEW PLAY GROUND EXTENSION PER LANDSCAPING 70 AREA FOR FUTURE SEPTIC FIELD EXPANSION PER

LANDSCAPING 71 POND PER CIVIL

> TEMPORARY CONSTRUCTION. MUD MAT PER CIVIL ON TOP OF EXISTING ASPHALT SITE ENTRANCE.

73 NEW HOLDING TANKS FOR FIRE PROTECTION PER CIVIL C/W FIRE SERVICE CONNECTIONS AND ROUND ACCESS

74 COVERED DRAINAGE PIPE PER CIVIL

75 NEW POST AND SIGN C/W WORDING: " 6 METER WIDE FIRE ROUTE WITHIN PARKING AISLE. NO PARKING ON FIRE

76 NEW POST AND SIGN C/W WORDING: "END OF FIRE

77 SNOW STORAGE AREA

78 PROVIDE NEW CONCRETE CURB AS REQUIRED FOR NEW ACCESSIBLE PARKING CONSTRUCTION. REINSTATE ASPHALT PAVING AND BASE COURSES, MATCH EXISTING CONCRETE CURB AND EXISTING PAVING ASSEMBLIES AT SIDEWALK AND PARKING SPOTS. MAKE ALL JUNCTION SMOOTH AND IN STRAIGHT LINES

79 PROVIDE NEW CONTRASTING PAINTING AT FACE OF ASPHALT WITHIN 1500mm ACCESS AISLE. REINSTATE

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CLIENT

## **CITY OF OTTAWA**

OTTAWA ONTARIO, CANADA

PROJECT

## **CORKERY COMMUNITY** HALL EXPANSION

3447 OLD ALMONTE RD., CARP, ON K0A 1L0

# **SITE PLAN**

TITLE

PROJECT NO: 2020-0640 DRAWN: APPROVED: SCALE: As indicated


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REV

A100

DRAWING NO.

PAVING MARKINGS CONTAINING INTERNATIONAL SYMBOL OF ACCESSIBILITY.

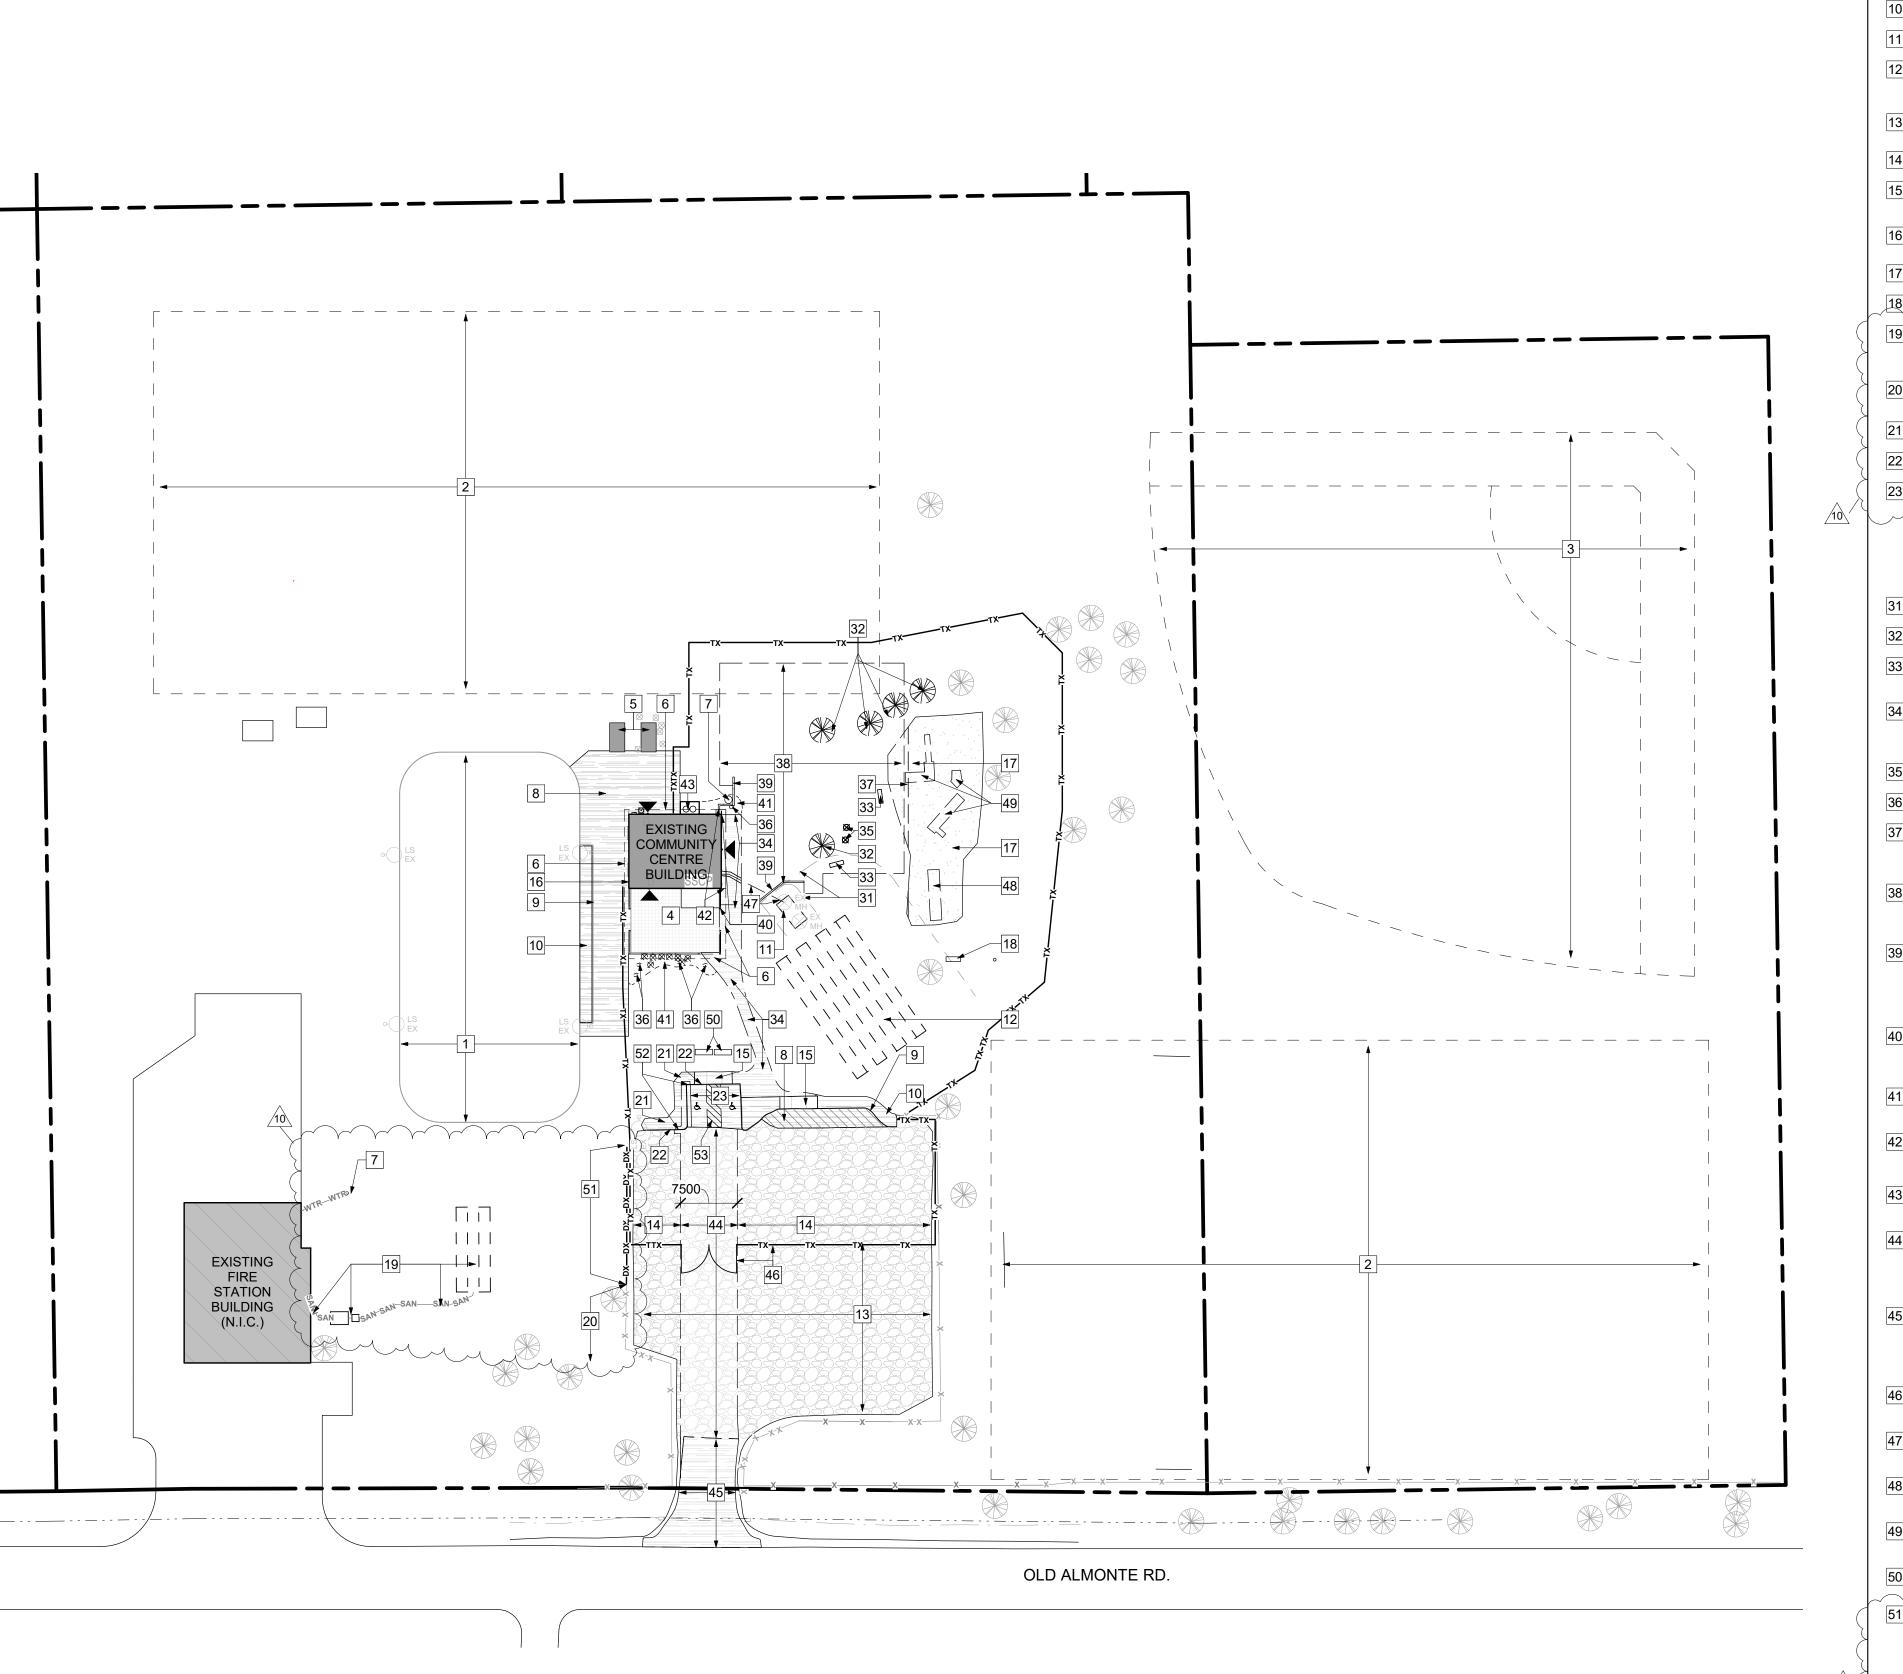

### **DEMOLITION SITE PLAN KEYNOTES:**

- 1 EXISTING SKATING RING TO REMAIN
- 2 EXISTING SOCCER FIELD TO REMAIN
- 3 EXISTING BASEBALL DIAMOND TO REMAIN
- 4 EXISTING COVERED DECK TO REMAIN
- 5 EXISTING STORAGE UNIT TO REMAIN
- 6 EXISTING ROOF OVERHANG ABOVE TO REMAIN
- 7 EXISTING DRILLED WELL TO REMAIN
- 8 EXISTING ASPHALT PAVING TO REMAIN

- 9 EXISTING CURB TO REMAIN
- 10 EXISTING ASPHALT SIDEWALK TO REMAIN
- 11 EXISTING SEPTIC TANK TO REMAIN
- EXISTING SEPTIC DRAIN FIELD TO REMAIN. ELIMINATE AUTOMOBILE AND EQUIPMENT MOVEMENT OVER THIS
- 13 PARKING SPACES RESERVED FOR SOCCER TEAMS DURING CONSTRUCTION
- 14 EXISTING GRAVEL PARKING TO REMAIN
- 15 EXISTING ACCESSIBLE CONCRETE CURB RAMP AND DEPRESSED CURB TO REMAIN
- 16 EXISTING HOSE BIB TO REMAIN. ENSURE RUNNING WATER FOR HOCKEY RING DURING CONSTRUCTION.
- 17 EXISTING PLAYGROUND TO REMAIN
- EXISTING BENCH TO REMAIN EXISTING SEPTIC FIELD AND SANITARY SERVICE. SHOWN
- LOCATIONS ARE APPROXIMATE. VERIFY LOCATIONS ON
- 20 PORTION OF EXISTING LUMBER FENCE TO REMAIN. COORDINATE EXTENT ON SITE.
- 21 PORTION OF EXISTING ASPHALT SIDEWALK TO REMAIN
- PORTION OF EXISTING CONCRETE CURB TO REMAIN
- 23 PORTION OF EXISTING ASPHALT PAVING TO REMAIN
- 31 REQUIRED STRUCTURE SETBACK
- 32 REMOVE EXISTING TREE
- REMOVE EXISTING BENCH. REPAIR, CLEAN AND STORE FOR RE-USE AT NEW CONSTRUCTION
- REMOVE EXISTING ASPHALT PAVING AND BASE COURSES AS REQUIRED FOR NEW CONSTRUCTION. CUT ASPHALT IN
- 35 REMOVE EXISTING SHRUBS

STRAIGHT LINE.

- 36 REMOVE EXISTING BOULDER
- REMOVE PORTION OF EXISTING PLAYGROUND AS REQUIRED FOR FOUNDATION EXCAVATION AND NEW LANDSCAPING. MINIMIZE REMOVAL ON SITE.
- 38 EXCAVATE AS REQUIRED FOR FOUNDATION CONSTRUCTION PER GEOTECHNICAL. CONSIDER EXTENT OF EXCAVATION SLOPES PER GEOTECHNICAL.
- 39 NEW SHORING AS REQUIRED TO PROTECT EXISTING WATER WELL / SANITARY TANK FOR PERIOD OF WORK. REMOVE UPPER PORTION OF SHORING FOR PROPER LANDSCAPING WHEN SAFE FOR WELL AT THE END OF CONSTRUCTION.
- 40 PROTECT EXISTING FOUNDATION FOR PERIOD OF WORK. PROVIDE ADEQUATE UNDERPINNING AND SHORING AS
- REMOVE EXISTING PLANTING AS REQUIRED FOR EXCAVATION.
- 42 REMOVE EXISTING ROOF AS REQUIRED FOR NEW CONSTRUCTION.

AND ALL ASSOCIATED COMPONENTS

ROUTE ASSEMBLY.

- REMOVE PROPANE TANKS SURROUNDED BY LINK FENCE
- VERIFY EXISTING GRAVEL THICKNESS ON SITE. REMOVE EXISTING GRAVEL AND SOIL IF REQUIRED TO ACCOMMODATE NEW HEAVY DUTY GRAVEL ACCESS
- VERIFY EXISTING ROAD ASSEMBLY ON SIDE. REMOVE EXISTING ASPHALT PAVING, ASSOCIATED BASE COURSES AND SOIL IF REQUIRED FOR NEW ACCESS ROUTE HEAVY DUTY PAVING STRUCTURE.
- TEMPORARY FENCING COMPLETED WITH ACCESS GATES FOR PERIOD OF CONSTRUCTION
- 47 REMOVE EXISTING SANITARY MAIN FROM EXISTING BUILDING TO EXISTING SEPTIC TANK TO REMAIN
- 48 REMOVE EXISTING SWING. INSPECT, REPAIR, CLEAN AND STORE FOR RE-USE AT NEW CONSTRUCTION
- 49 REMOVE EXISTING PLAY STRUCTURE. INSPECT, REPAIR,

CLEAN AND STORE FOR RE-USE AT NEW CONSTRUCTION

- 50 REMOVE EXISTING BICYCLE RACKS. INSPECT, REPAIR, CLEAN AND STORE FOR RE-USE AT NEW CONSTRUCTION
- REMOVE EXISTING LUMBER FENCE AND POSTS. COORDINATE ON SITE EXTENT OF REMOVAL TO THE NEAREST POST PASSING THE EXISTING TREE. FILL AND COMPACT THE HOLES AFTER POST REMOVAL. REINSTATE TOP SOIL AND SEED GRASS AT AFFECTED AREAS.
- REMOVE PORTION OF EXISTING CURB AND ASPHALT PAVING AND BASE COURSES AS REQUIRED FOR NEW CURB CONSTRUCTION. CUT ASPHALT IN STRAIGHT LINE. MINIMIZE .
- 53 REMOVE EXISTING PAINTING FROM THE FACE OF ASPHALT. PROTECT EXISTING TO REMAIN ASPHALT

#### SITE PLAN GENERAL NOTES

- A. DO NOT SCALE THIS DRAWING B. REPORT ANY DISCREPANCIES PRIOR TO COMMENCING WORK. NO RESPONSIBILITY IS BORN BY THE CONSULTANT FOR
- UNKNOWN SUBSURFACE CONDITIONS C. CONTRACTOR TO CHECK AND VERIFY ALL DIMENSIONS ON SITE AND REPORT ANY ERRORS AND/OR OMISSIONS TO THE
- CONSULTANT D. REINSTATE ALL AREAS AND ITEMS DAMAGED AS A RESULT OF CONSTRUCTION ACTIVITIES TO THE SATISFACTION OF THE 2611 Queensview Dr, Suite 300

EXISTING BUILDING TO REMAIN

EXISTING ASPHALT TO REMAIN

**EXISTING ASPHALT TO REMOVE** 

EXISTING CONCRETE SIDEWALK TO

EXISTING CRUSHED STONE PARCKING

EXISTING CRUSHED STONE PARCKING

EXISTING PLANTING TO REMAIN

EXISTING SAND PLAYGROUND TO

OBJECTS

TO REMAIN

TO REMOVE

**NEW SHORING** 

PROPERTY LINE

—— · · · — SETBACK LINE

---- OVERHEAD

——x———x———x—— EXISTING FENCE TO REMAIN

——DX——DX——DX——DEMOLISH EXISTING FENCE

REMAIN (BELOW GRADE)

——WTR——WTR——WTR—— EXISTING WATER SUPPLY TO REMAIN

——SAN——SAN——SAN—— EXISTING SANITARY TO REMAIN

--H---H--EXISTING ELECTRICAL SERVICE TO  $\stackrel{/10}{-}$ 

BUILDING ENTRANCE / EXIT

LIGHT STAND - EXISTING TO REMAIN

UTILITY POLE - EXISTING TO REMAIN

MANHOLE - EXISTING TO REMAIN

TREE - EXISTING TO REMAIN

SHRUB - EXISTING OT REMAIN

TREE - DEMOLITION

SHRUB - DEMOLITION

DEMOLISH EXISTING BUILDING AND

**EXISTING BUILDING NOT IN CONTRACT** 

- CONSULTANT E. CONTRACTOR TO LAYOUT PLANTING BEDS. PATHWAYS ETC. TO APPROVAL OF CONSULTANT PRIOR TO ANY JOB
- **EXCAVATION** F. THE ACCURACY OF THE POSITION OF UTILITIES IS NOT GUARANTEED - CONTRACTOR TO VERIFY PRIOR TO
- EXCAVATION G. INDIVIDUAL UTILITY COMPANY MUST BE CONTACTED FOR CONFIRMATION OF UTILITY EXISTENCE AND LOCATION PRIOR
- TO DIGGING H. ALL DISTURBED AREAS TO BE RESTORED TO ORIGINAL
- CONDITION OR BETTER UNLESS OTHERWISE NOTED

**DEMOLITION SITE PLAN LEGEND** 

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- 10 2022/11/08 ISSUED FOR SITE PLAN CONTROL
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**CITY OF OTTAWA** 

OTTAWA ONTARIO, CANADA

PROJECT

**CORKERY COMMUNITY** HALL EXPANSION

3447 OLD ALMONTE RD., CARP, ON K0A 1L0

**DEMOLITION SITE PLAN** 

PROJECT NO: 2020-0640 DRAWN: APPROVED: JS As indicated


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D101

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1 SITE PLAN - DEMOLITION



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CLIENT

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OTTAWA ONTARIO, CANADA
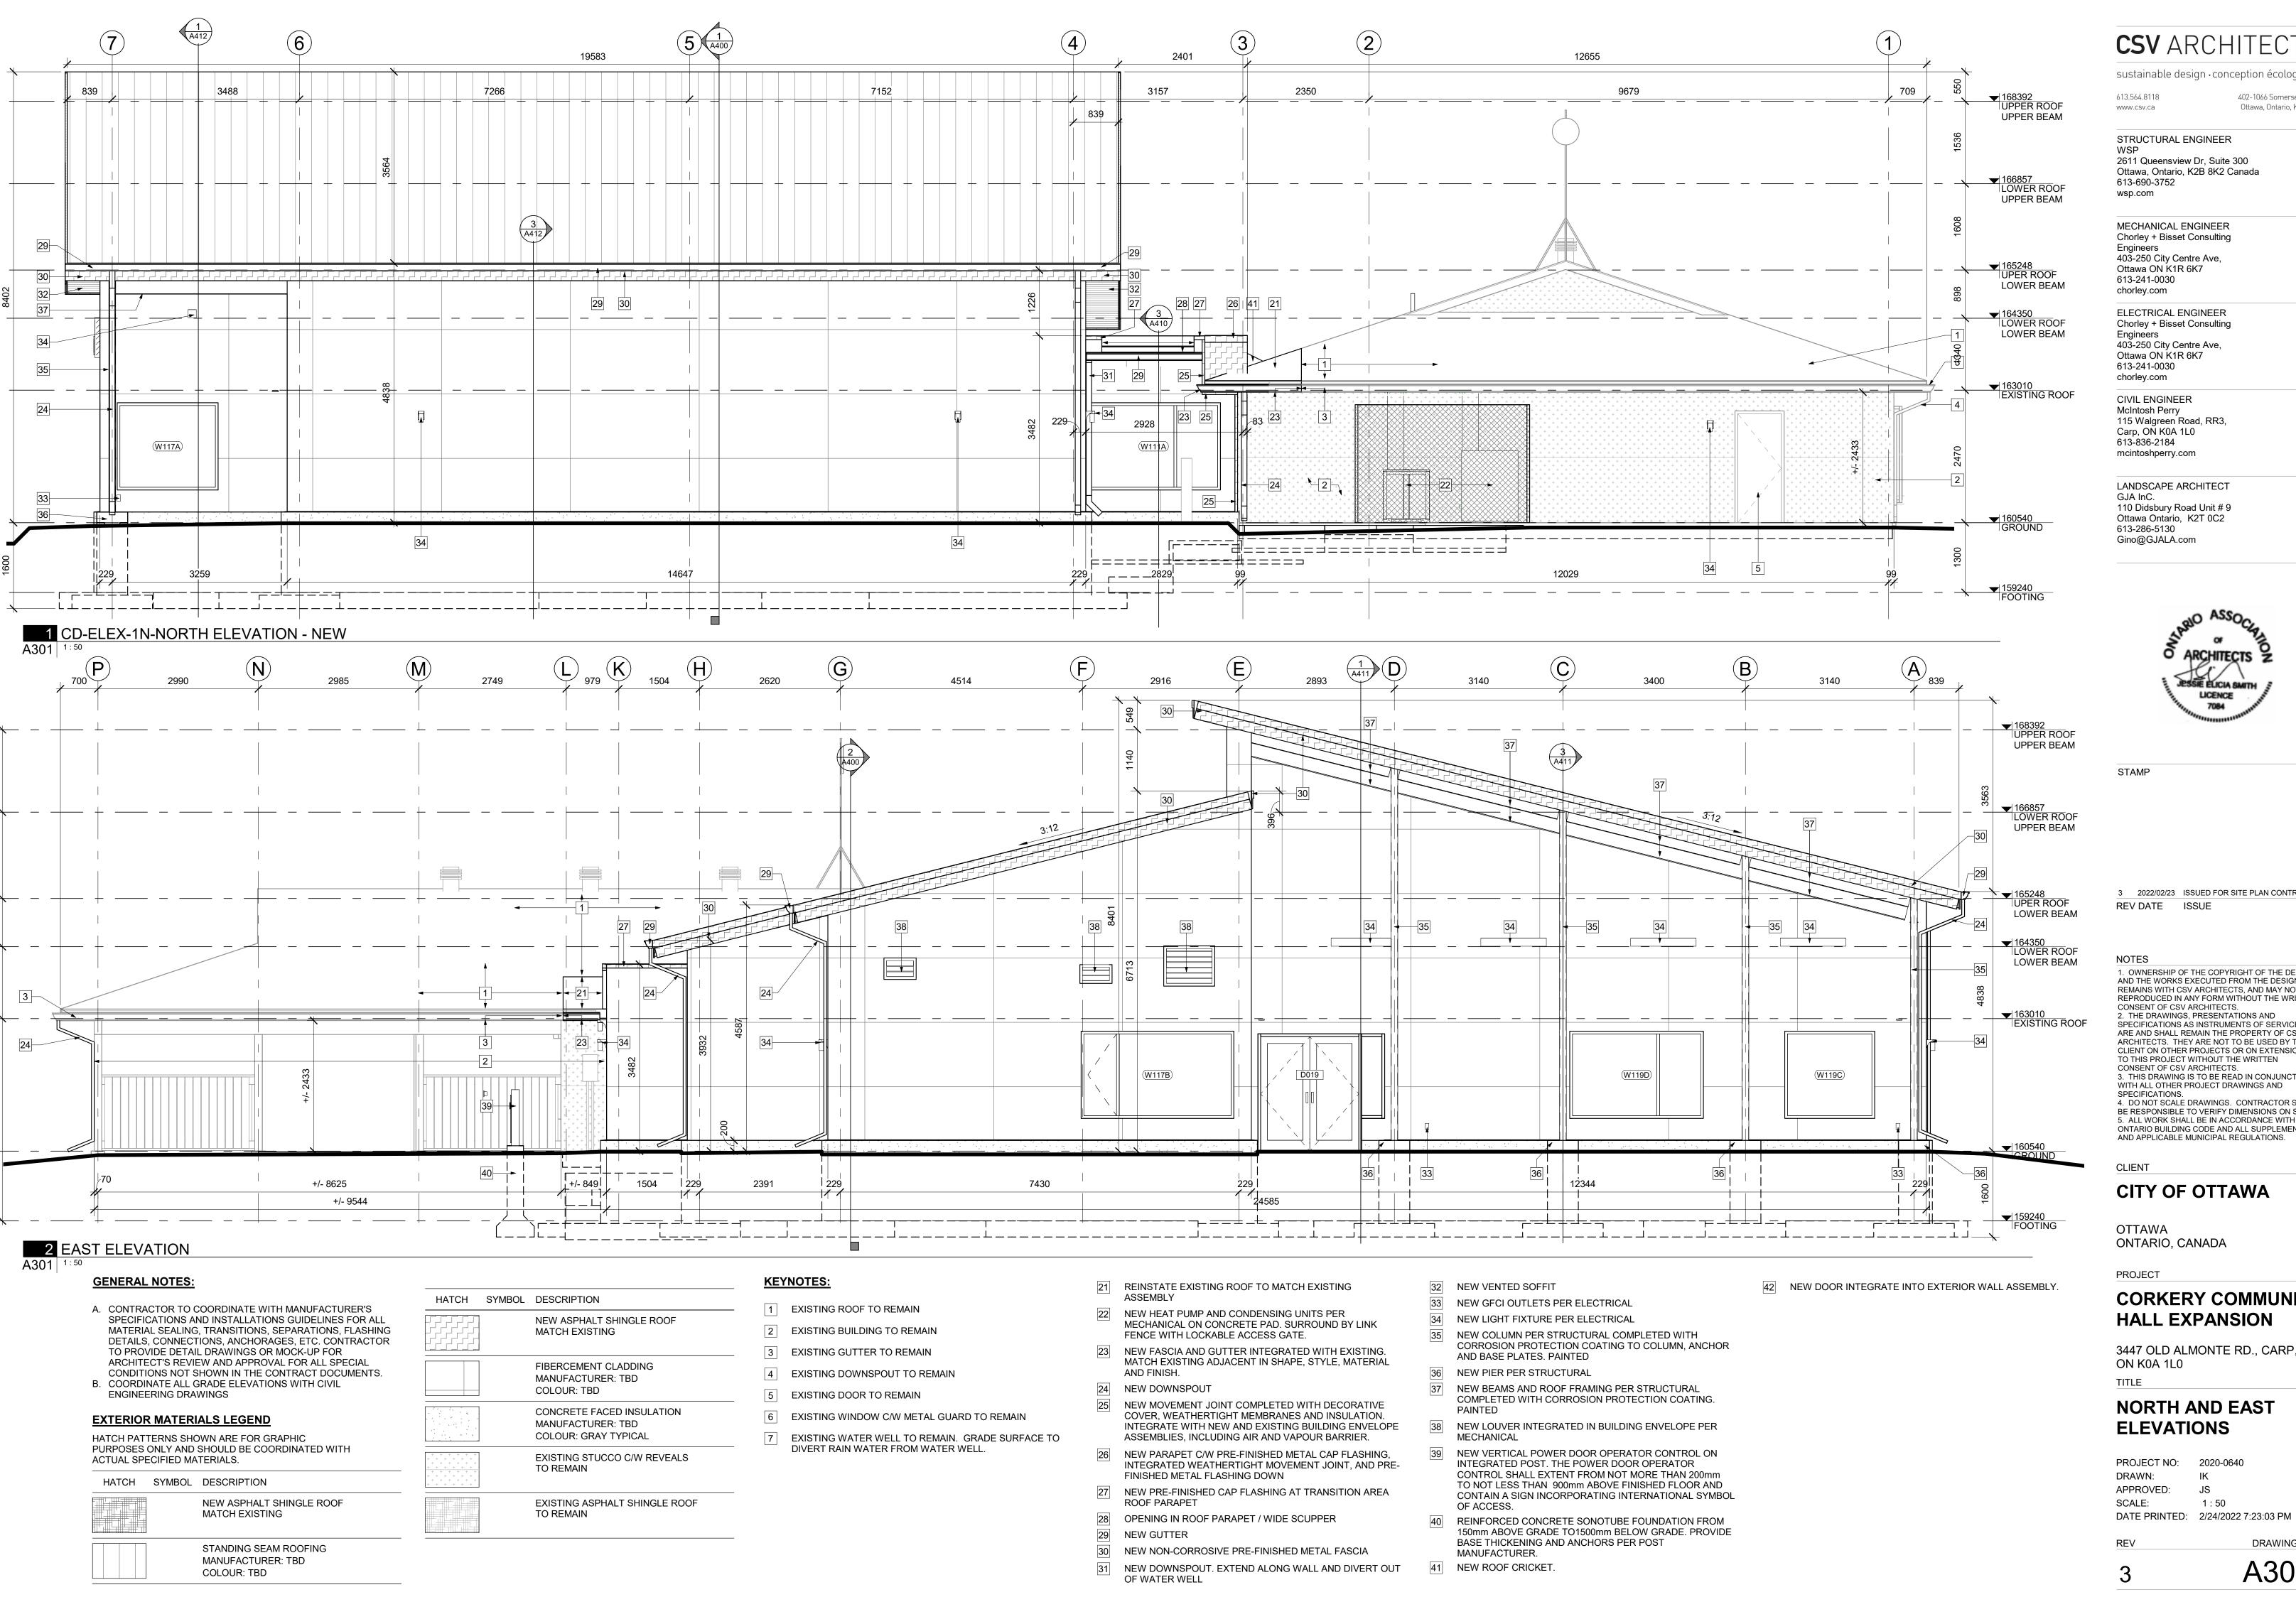
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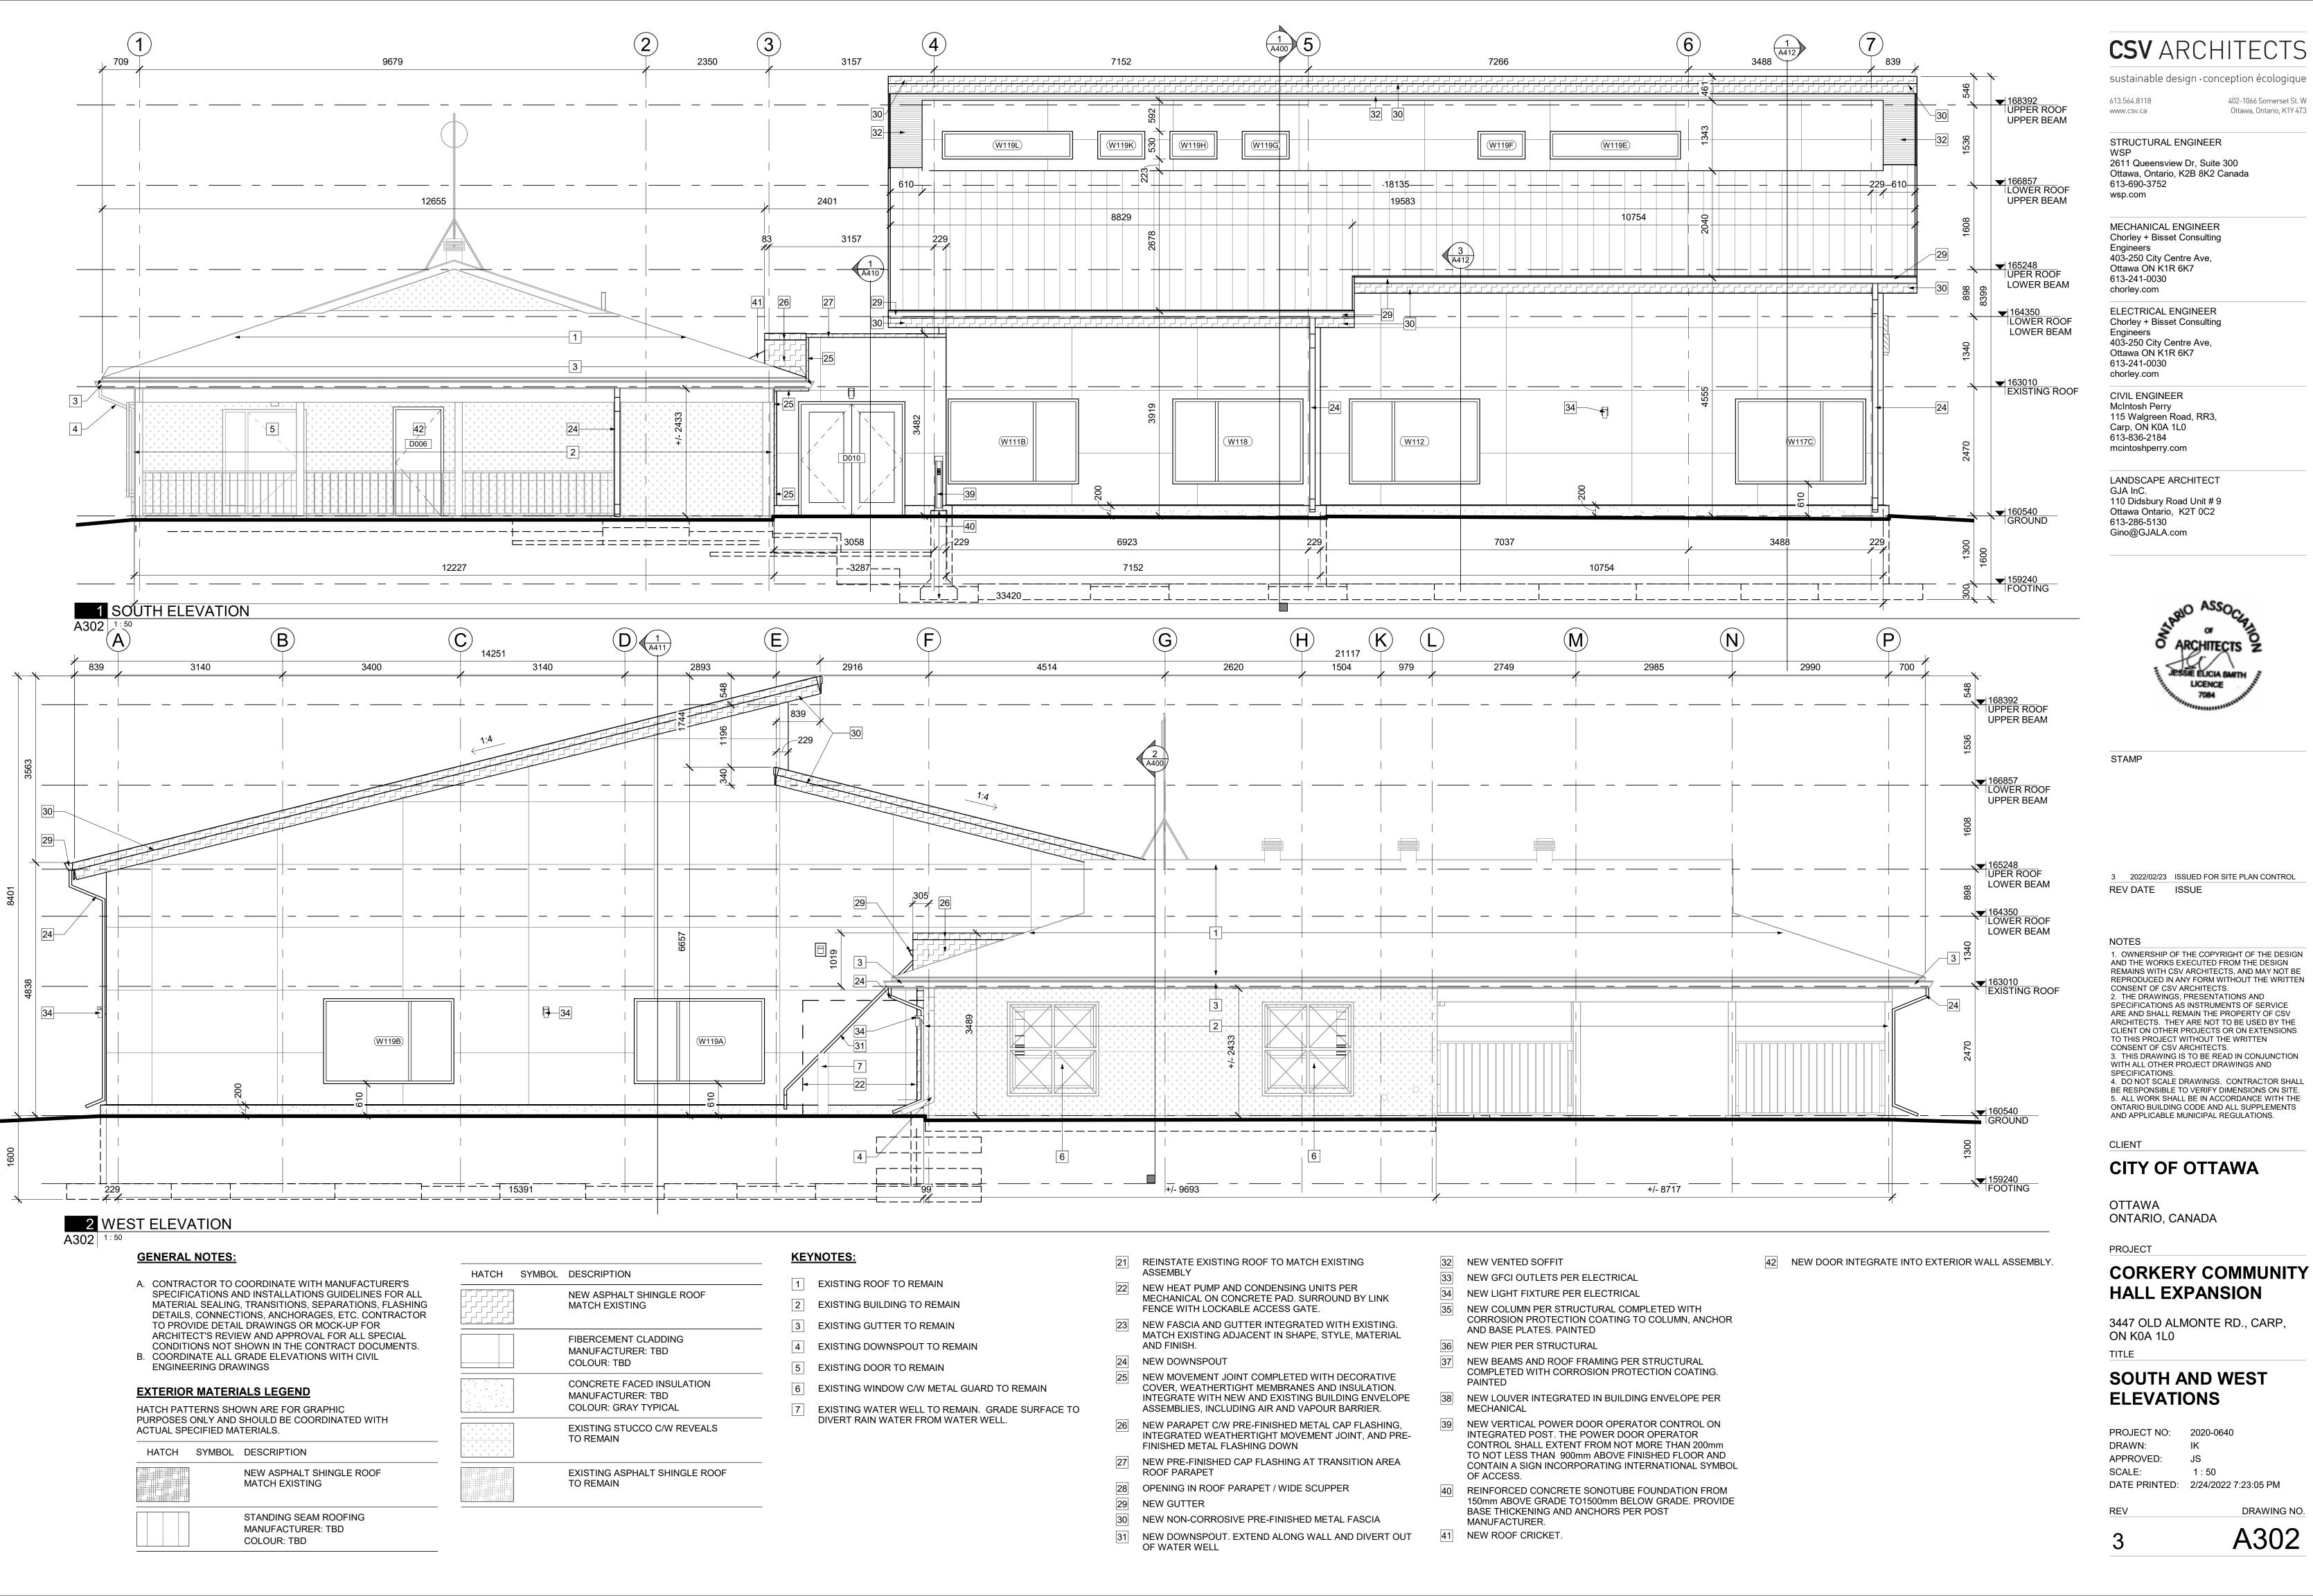
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## **NORTH AND EAST ELEVATIONS**

PROJECT NO: 2020-0640 DRAWN: APPROVED: JS 1:50

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A301



**CSV** ARCHITECTS

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1:50

DRAWING NO.

A302

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