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A099
PARKING LEVEL P2
1:100

GENERAL NOTES

- ALL WINDOW AND DOOR DIMENSIONS ARE TO ROUGH STUD/MASONRY OPENING
- ALL OUTSIDE DIMENSIONS ARE TO OUTSIDE FACE OF SHEATHING.
- REFER TO STRUCTURAL DRAWINGS FOR ALL BEAMS, LINTELS, POSTS, FLOOR AND ROOF FRAMING.
- ALL ELECTRICAL AND MECHANICAL ITEMS SHOWN ON DRAWINGS FOR LOCATIONS ONLY. COORD. W/ MECH. & ELEC. DRAWINGS.
- CAULK AND SEAL AT ALL MECHANICAL AND ELECTRICAL PENETRATIONS.
- PROVIDE FIRE-STOPPING FOR ALL MECHANICAL AND ELECTRICAL PENETRATIONS THROUGH FIRE-RATED ASSEMBLIES. INFILL ANY UNUSED PENETRATIONS WITH FIRESTOPPING TO SUIT ASSEMBLY.
- VERIFY ALL DOOR AND WINDOW SIZES PRIOR TO FRAMING OF OPENINGS
- SOILS CONSULTANT TO REVIEW AND VERIFY SOILS CONDITIONS PRIOR TO POURING FOOTINGS.
- BACKFILL MATERIAL TO BE APPROVED. CLEAR SAND TO MEET REQUIREMENTS OF A DRAINAGE LAYER.
- REFER TO RCP FOR BULKHEAD LOCATIONS AND DEPTHS.
- SEE WINDOW SCHEDULE FOR TYPICAL WINDOW TIE-IN DETAILS.
- FURNITURE SHOWN FOR REFERENCE PURPOSES ONLY.
- PROVIDE PREFINISHED TRANSITION STRIPS AT JOINTS OF DISSIMILAR MATERIALS.
- ALL ELECTRICAL CONTROL HEIGHTS WITHIN BARRIER-FREE PATH OF TRAVEL AREAS THROUGHOUT THE BUILDING AND UNITS TO COMPLY WITH OBC 3.8.1.5
- REFER TO CIVIL & MECHANICAL DRAWINGS FOR WEeping TILE DRAINAGE CONNECTIONS
- PROVIDE SOUNDPROOF FIBERGLASS MATS IN ALL PARTITIONS WITH SUPPLY PIPES, SANITARY DRAIN OR RAINWATER LEADERS. COORD. W/ MECH.
- UNIT NAME: "XBD-X-B/F" INDICATES B/F REQUIREMENTS AS PER CAN/CSA NATIONAL STANDARD OF CANADA, AND ACTION OTTAWA'S ACCESSIBLE UNIT REQUIREMENTS

GENERAL NOTES - PARTITION

- EXCEPT AS OTHERWISE INDICATED, DOORS ARE INSTALLED 4" FROM ADJACENT WALLS.
- PROVIDE BLOCKING AND NAILERS FOR ALL PARTITIONS SUPPORTING MILLWORK, SHELVES ETC
- COORDINATE DIMENSIONS OF OPENINGS WITH SPECIFICATIONS FOR EQUIPMENT SUPPLIED AND INSTALLED.
- WATER RESISTANT GYPSUM BOARD, 1219 AFF REQUIRED IN ALL LOCATIONS WITH EXPOSURE TO WATER OR HUMIDITY. THIS INCLUDES BUT IS NOT LIMITED TO WASHROOMS, JANITOR ROOMS & KITCHEN WALLS ABOVE MILLWORK, CABINETS, INCLUDING SINKS UP TO UNDERSIDE OF UPPER CABINETS.
- ALL PARTITIONS THAT EXTEND FROM SUBFLOOR TO UNDERSIDE FLOOR ASSEMBLY ABOVE ARE TO BE ALIGNED WITH GEOMETRY OF THE ASSEMBLIES TO ENSURE THAT THE ENTIRE PERIMETER IS SEALED AS REQUIRED TO ATTAIN THE NECESSARY FIRE RESISTANCE RATING AND ACOUSTICAL PERFORMANCE.

LEGEND - CONSTRUCTION

- ALI ALIGN DESIGNATED SURFACES
- DIM CLEAR INDICATED CLEAR DIMENSION REQUIRED BETWEEN FINISHED SURFACES
- FD FLOOR DRAIN (REFER TO MECH.)
- RD ROOF DRAIN (REFER TO MECH.)
- EP ELECTRICAL PANEL (REFER TO ELEC.)
- TACTILE ATTENTION INDICATOR AS PER OBC 3.8.3.18
- BARRIER-FREE OPERATOR - REFER TO ELEC.
- 152 DIA. GEOTEXTILE ENCAPSULATED WEeping TILE - SEE GENERAL NOTES
- HATCH INDICATED LOCATION OF FOUNDATION CHECK TO ACCOMMODATE EXTERIOR DOORS. COORD. W/ DOOR SCHEDULE
- RECESSED ENTRANCE FLOOR GRILLE. DIMENSIONS AS INDICATED ON DRAWINGS. PROVIDE 64 mm DEPRESSION. ENSURE SLAB DEPRESSION IS 76 mm LARGER THAN FLOOR GRILLE SIZE.
- FDC FIRE DEPARTMENT CONNECTION COORD W/ MECH
- FHC FIRE HOSE CABINET. COORD W/ MECH
- CONCRETE REFER TO STRUCTURE
- SUSPENDED CONCRETE SLAB WITH WATERPROOFING MEMBRANE FOR VEHICLES
- CONCRETE SLAB WITH SEALANT (INTERIOR SPACES)
- SLAB ON GRADE WITH SEALANT (NO MEMBRANE WATERPROOFING)

No.	Date	Événement / Object
8	2020-10-29	FOR COORD
9	2020-11-06	FOR COORD
11	2020-11-20	FOR COORD
15	2021-01-13	FOR COORD
16	2021-01-15	FOR STRUCT. COORD
19	2021-02-10	FOR COORD
20	2021-02-18	FOR COORD
21	2021-02-19	SITE PLAN CONTROL RESPONSE
25	2021-10-08	SITE PLAN CONTROL RESPONSE
26	2022-01-22	SITE PLAN CONTROL RESPONSE

Ingenieur / Engineer
(Mechanical & Electrical / Mechanical & Electrical)

Smith + Andersen
Ingenieur / Engineer
(Structure / Structure)

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ENGINEERING LTD
200, 1000 BROADVIEW AVE. TORONTO, ONT. M4W 1G7
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(Paysagiste / Landscape)

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McINTOSH PERRY
115 Walgreen Rd, Carp, ON K0A 1L0

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Architecte / Architect

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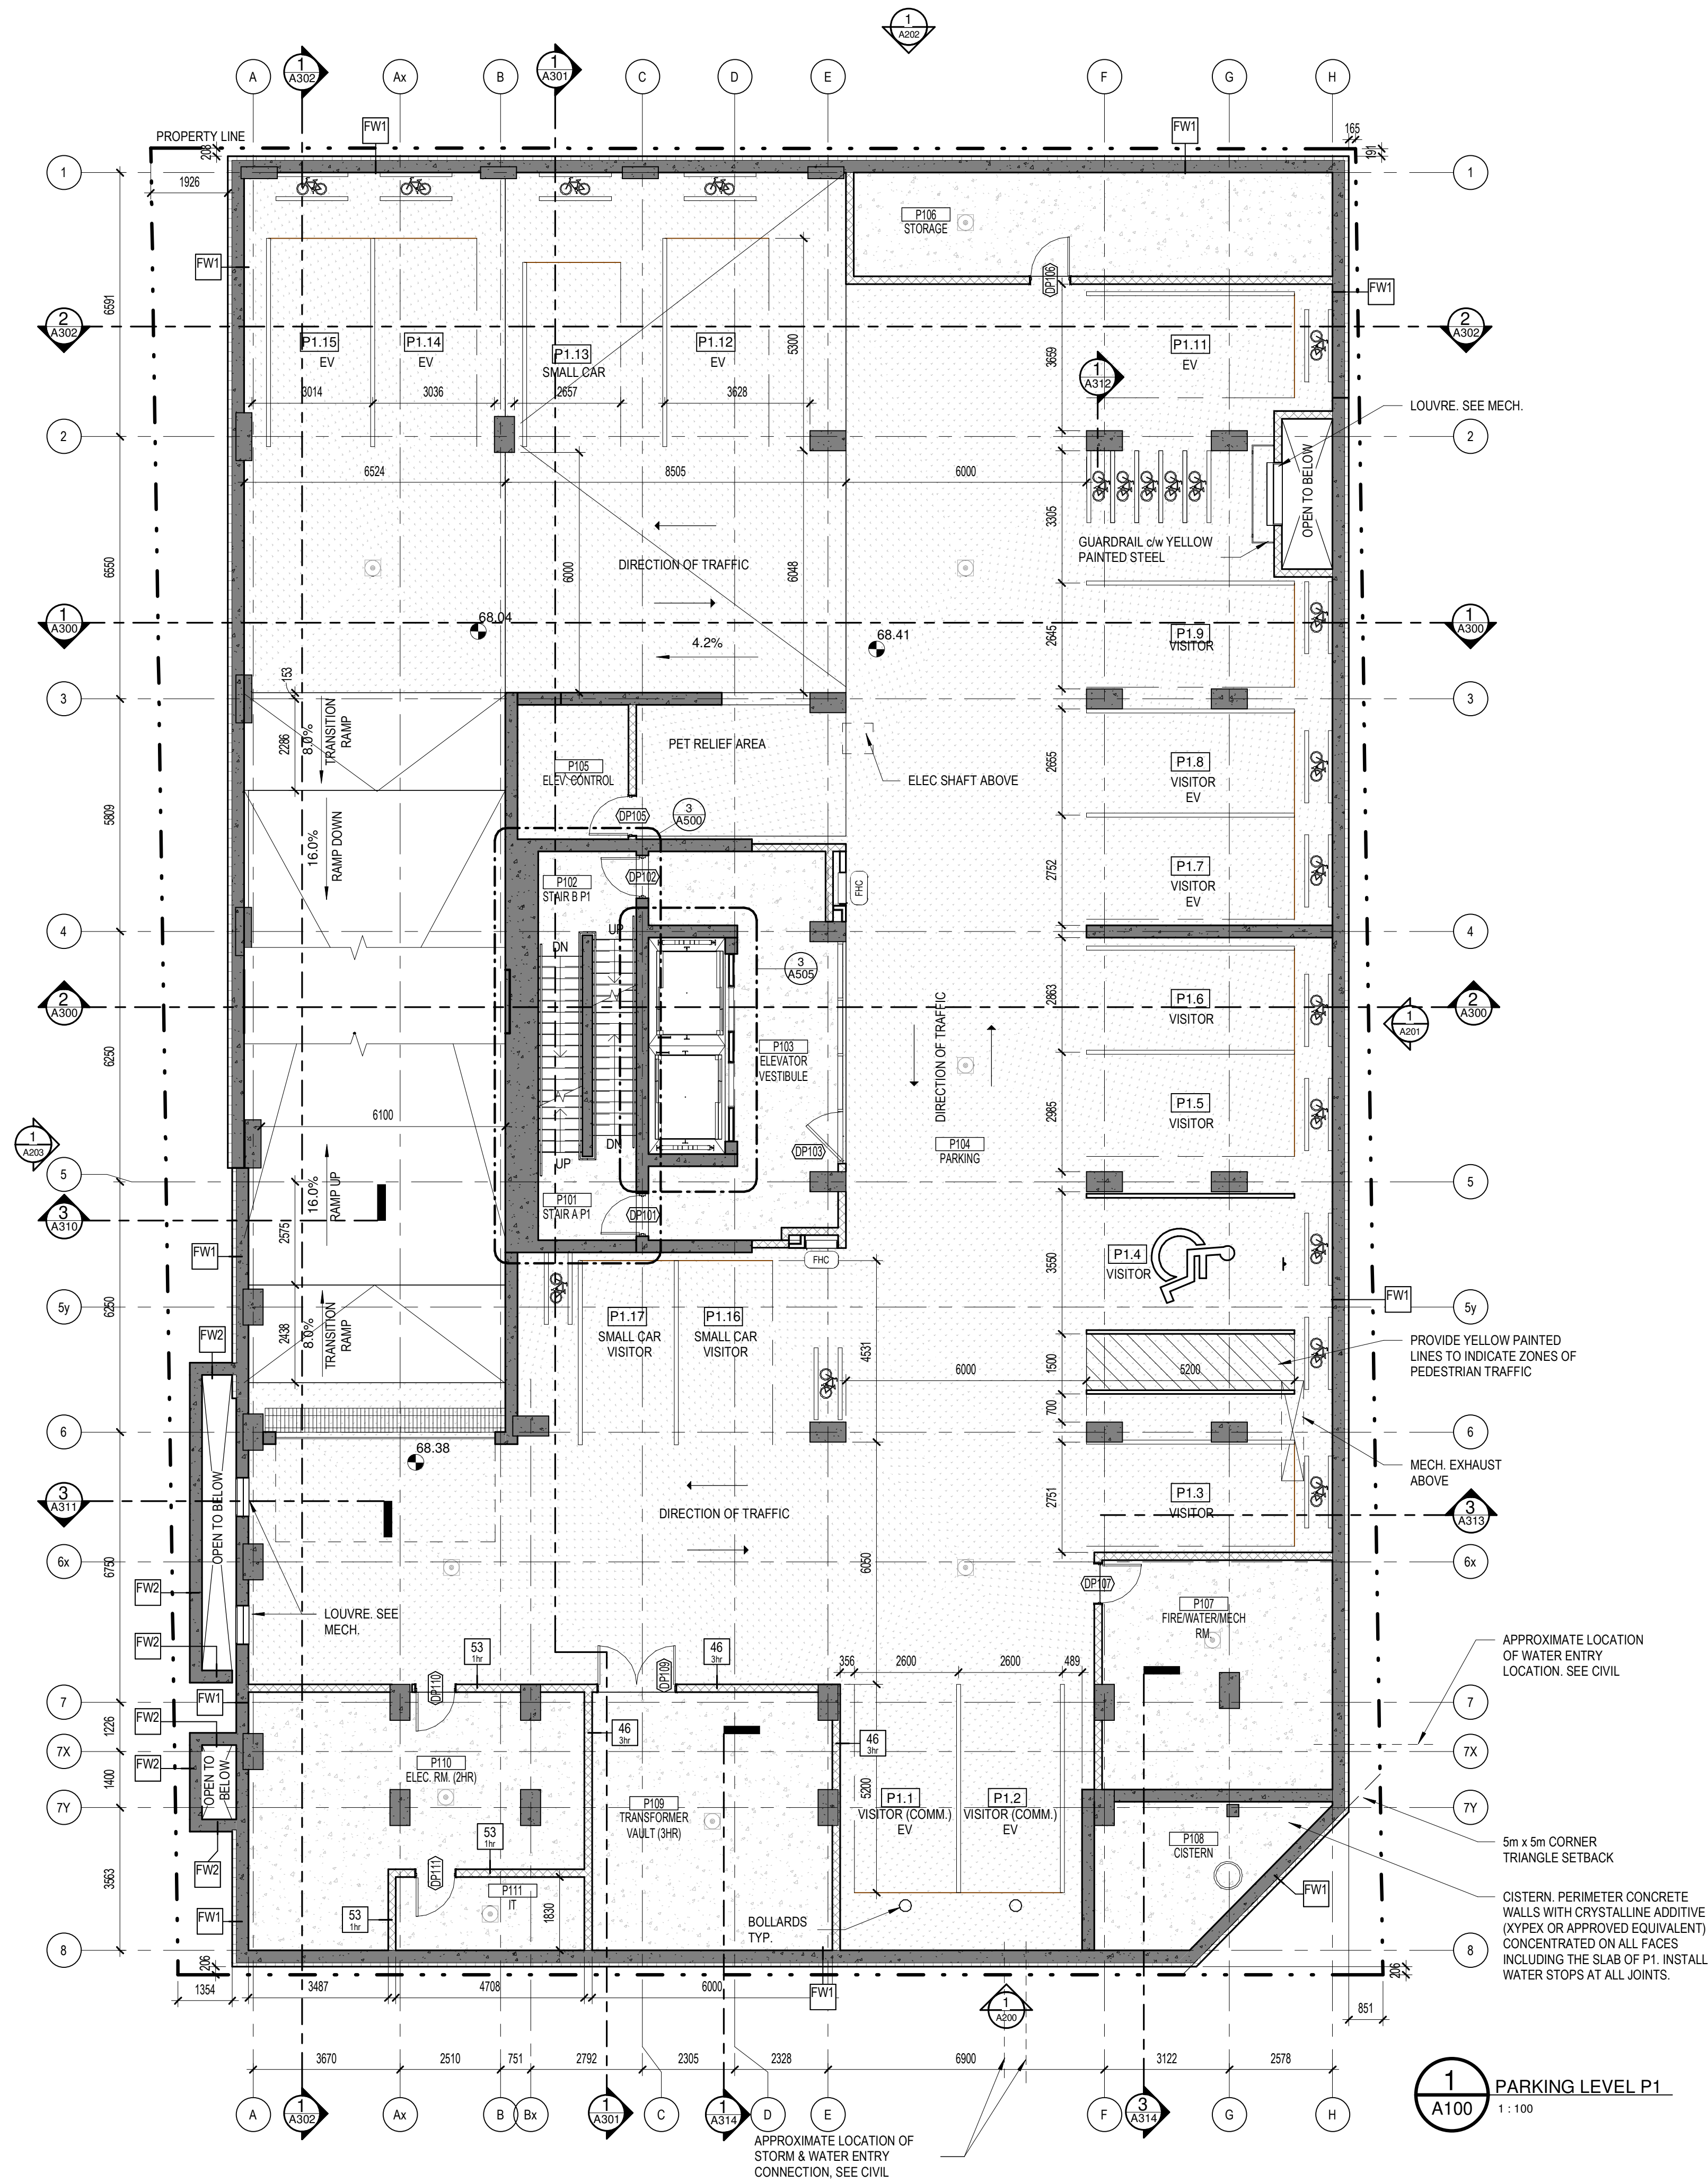
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EIGHTEEN STOREY MIXED-USE DEVELOPMENT

PARKING LEVEL P2 FLOOR PLAN

Dessiné par / Drawn by RD, LK	No. projet / Project number 1954
Vérifié par / Verified by MD, RC	No. dessin / Drawing number
Echelle / Scale As indicated	Revision / Revision
Date de création du dessin / Drawing creation date 10/15/20	26

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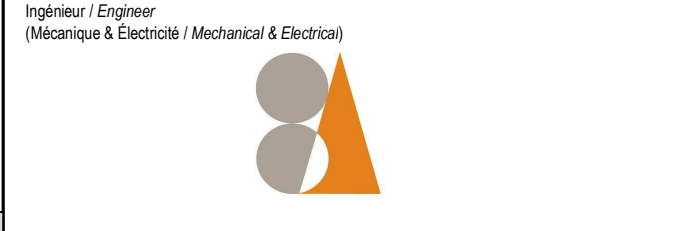
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Smith + Andersen
Ingénieur / Engineer
(Structure / Structural)



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Stade / Stadium

Note:
L'entrepreneur doit vérifier toutes les dimensions et informations sur le site et assurer complètement l'archivage de toutes erreurs ou omissions.

Contractor shall verify all information and dimensions on site and immediately report any errors or omissions to the architect.

Project / Projet

EIGHTEEN STOREY MIXED-USE DEVELOPMENT

PARKING LEVEL P1 FLOOR PLAN

Drawn by / Dessiné par
RD, LK

Project / Project number
1954

Verified by / Vérifié par
MD, RC

No. dessin / Drawing number
Revision / Revision

As indicated

Date de création du dessin / Drawing creation date
10/15/20

A100