



1 FRONT ELEVATION
A2.1 SCALE: 1/4"=1'-0"

Drawing name: C:\Users\Austan\Desktop\Work From Home March 16 21 11 Tweedsmuir A2.1.1.dwg; Date: 16/03/2022 11:11:11; User: AUSTAN; Plot Date: 16/03/2022 11:11:11

Consultants:

Consultants:

9		
8		
7	2022/12/01	SITE PLAN RE-SUBMISSION
6	2022/10/25	SITE PLAN RE-SUBMISSION
5	2022/10/04	ISSUED FOR COMMITTEE OF ADJUSTMENT
4	2022/05/16	ISSUED FOR SITE PLAN APPLICATION
3	2022/04/28	ISSUED FOR COORDINATION
2	2022/03/25	ISSUED FOR COORDINATION
1	2022/03/01	FOR CONSULTANT
No.	Y / M / D	REVISION

It is the responsibility of the appropriate contractor to check & verify all dimensions on site and report all errors &/or omissions to the architect. All contractors must comply with all pertinent codes & by-laws, & use proprietary products as directed by the manufacturer. Do not scale drawings. Copyright reserved.


Rosaline J. Hill Architect Inc.
414 Churchill Ave. N., Ottawa, ON, K1Z 5C6 • 613-853-2822
www.rjhill.ca • rosaline@rjhill.ca

SMALL APARTMENT BUILDING
368 Tweedsmuir Avenue, Ottawa, Ontario

FRONT ELEVATION

Drawn By: MP/RV	Date: MAY 2022	Sheet: A2.1
Project No: 2131	Scale: 1/4" = 1'-0"	

PLOTTEE Thu, 01 Dec 2022

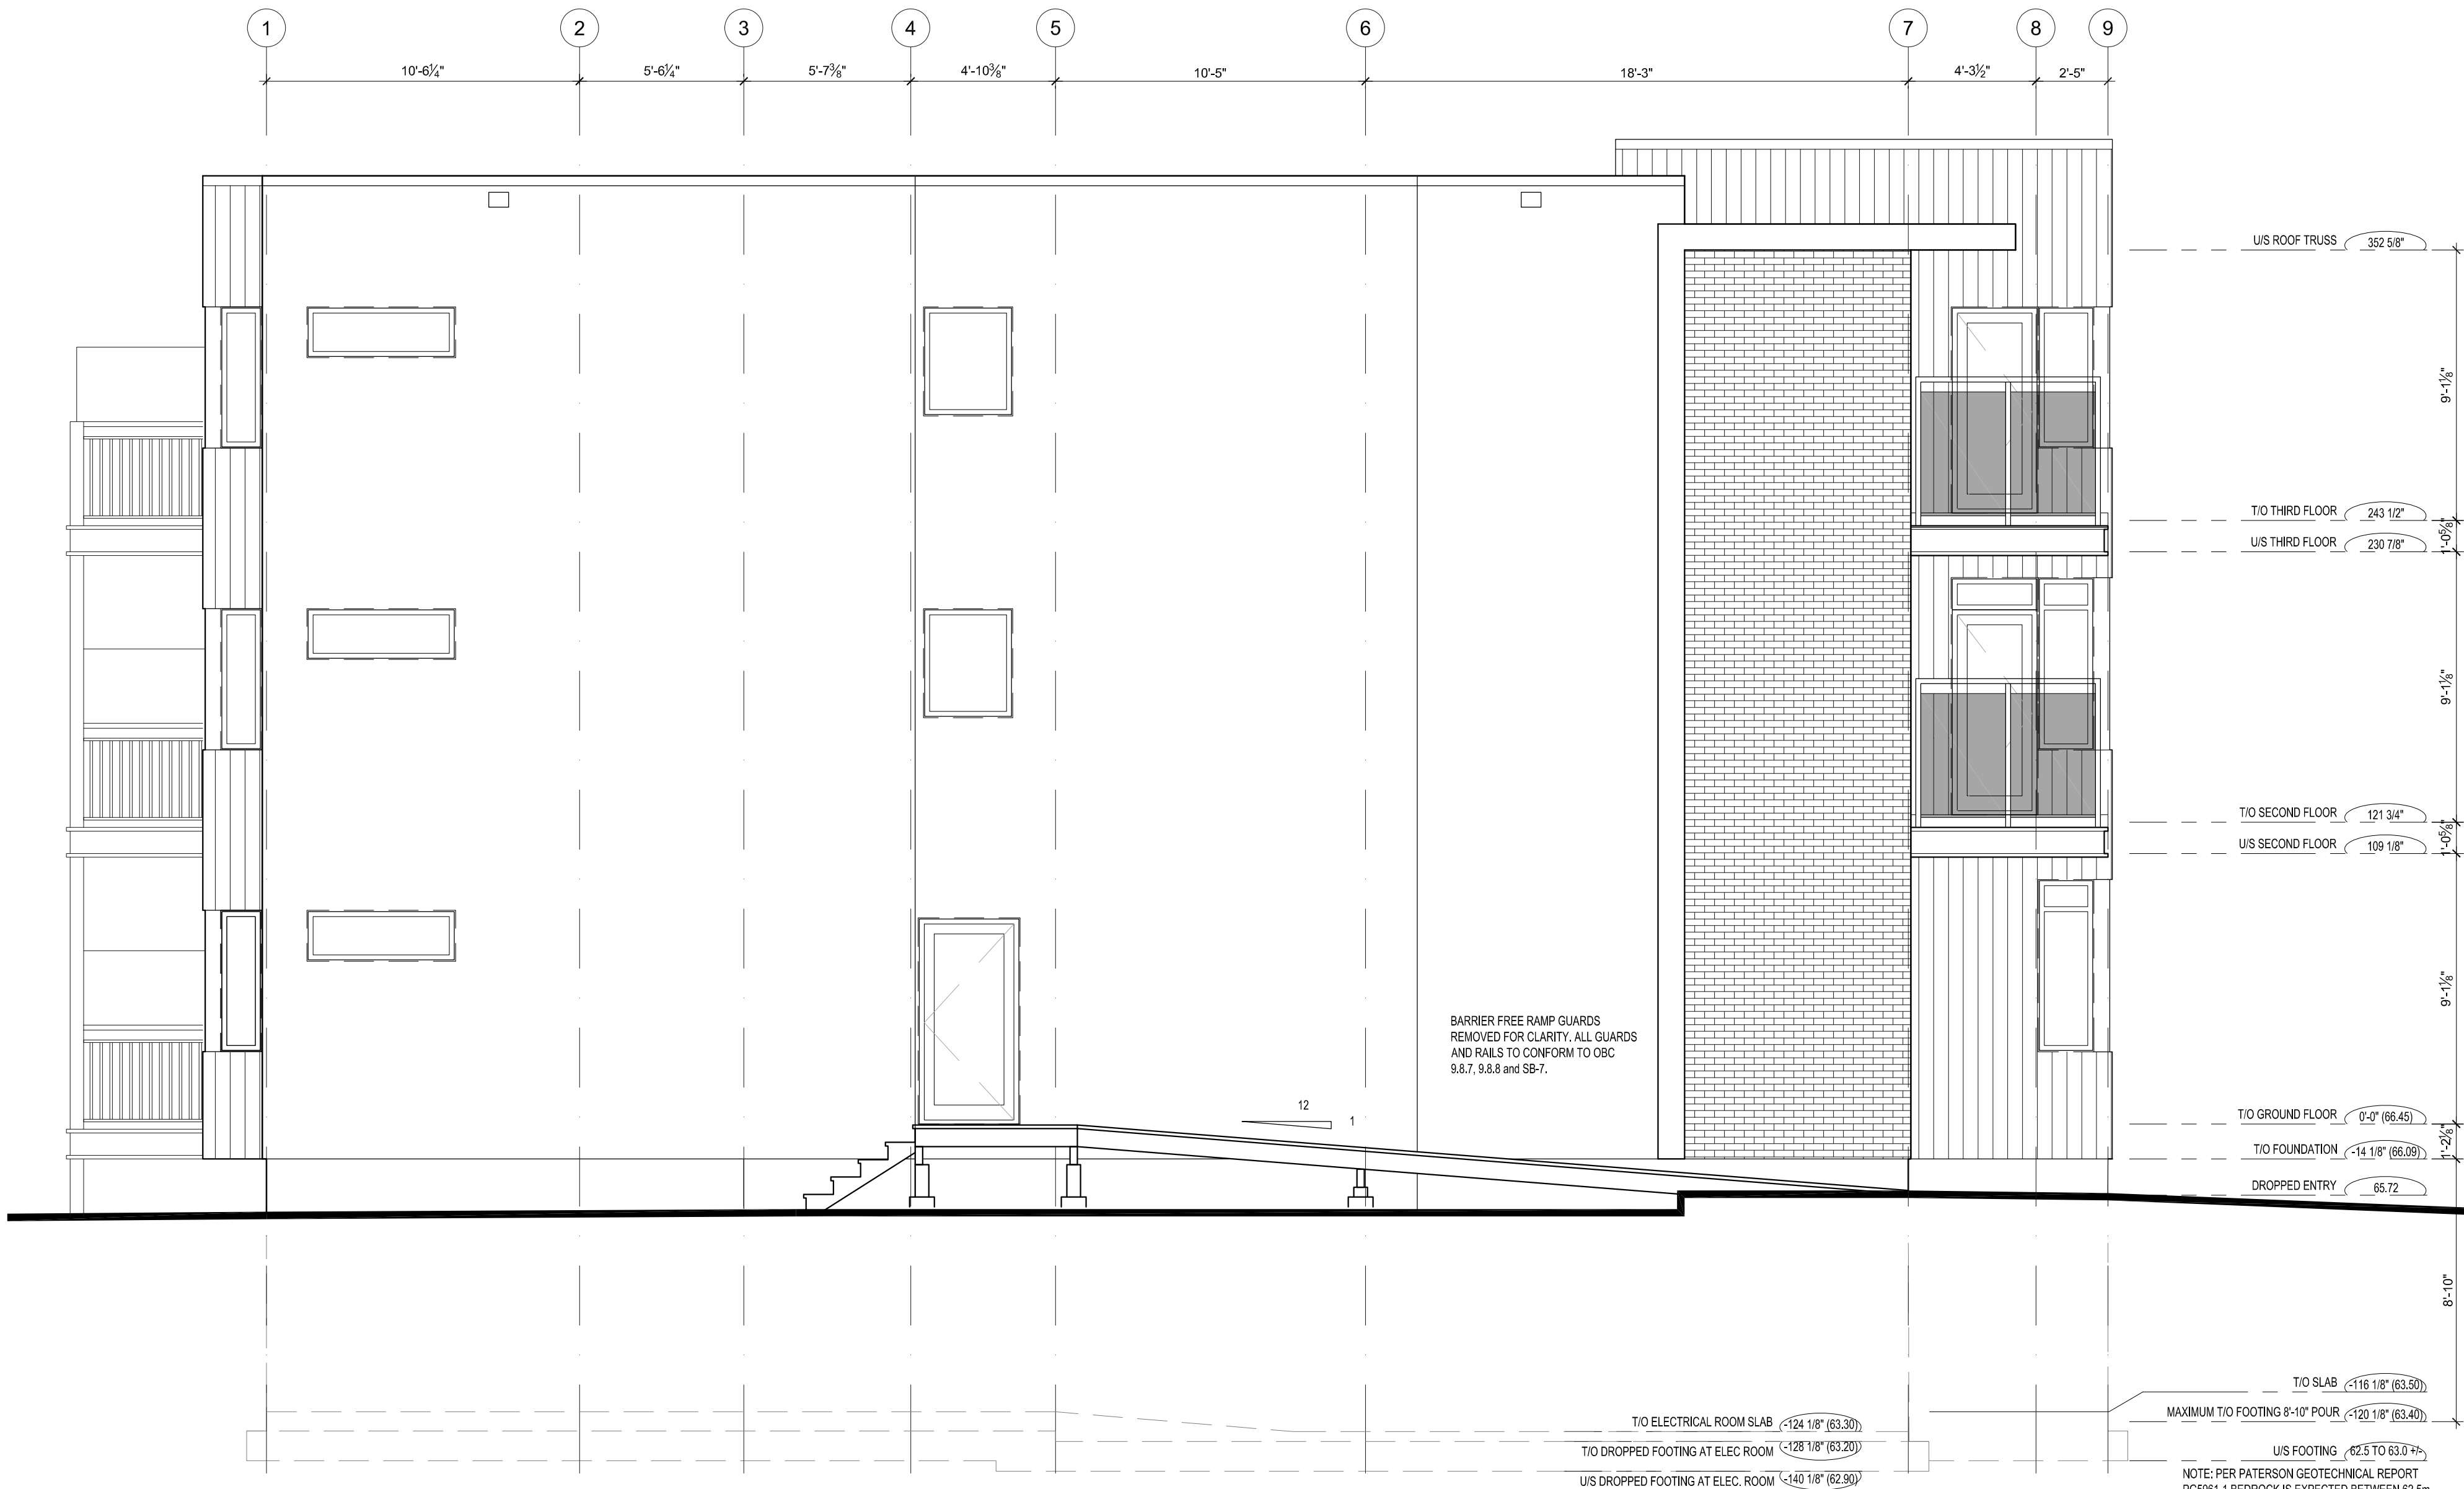

2 RIGHT ELEVATION
SCALE: 1/4"=1'-0"

Consultants:

Consultants:

No.	Y / M / D	REVISION
9		
8		
7	2022/12/01	SITE PLAN RE-SUBMISSION
6	2022/10/25	SITE PLAN RE-SUBMISSION
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2	2022/03/25	ISSUED FOR COORDINATION
1	2022/03/01	FOR CONSULTANT

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SMALL APARTMENT BUILDING
368 Tweedsmuir Avenue, Ottawa, Ontario
LEFT (SOUTH) SIDE ELEVATION

Drawn By: **MP/RV**
Date: **MAY 2022**
Project No: **2131**
Scale: **1/4" = 1'-0"**

Sheet: **A2.3**



1 LEFT ELEVATION
A2.2 SCALE: 1/4"=1'-0"

352 5/8" U/S ROOF TRUSS
 9'-1 1/2"
 1'-0 5/8"
 243 1/2" T/O THIRD FLOOR
 230 7/8" U/S THIRD FLOOR
 9'-1 1/8"
 1'-0 5/8"
 121 3/4" T/O SECOND FLOOR
 109 1/8" U/S SECOND FLOOR
 9'-1 1/8"
 1'-2 1/8"
 0'-0" (66.45) T/O GROUND FLOOR
 -14 1/8" (66.09) T/O FOUNDATION
 8'-10"
 -116 1/8" (63.50) T/O SLAB
 -120 1/8" (63.40) MAXIMUM T/O FOOTING 8'-10" POUR
 62.5 TO 63.0 +/- U/S FOOTING
 NOTE- PER PATERSON GEOTECHNICAL REPORT
 PG5961-1 BEDROCK IS EXPECTED BETWEEN 62.5m
 AND 63.0m +/-, ALL FOOTINGS TO BEAR DIRECTLY ON
 BEDROCK PER REPORT.

WINDOW WELL DRAINAGE
PER SITE SERVICING AND
GRADING DRAWINGS

Drawing name: C:\Users\Asha\OneDrive\Desktop\Work From Home_March_18\2131 Tweedsmuir A2.2\2131 A2.2 ELEVATION.dwg

Consultants:

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Consultants:

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9		
8		
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2	2022/03/25	ISSUED FOR COORDINATION
1	2022/03/01	FOR CONSULTANT
No.	Y / M / D	REVISION

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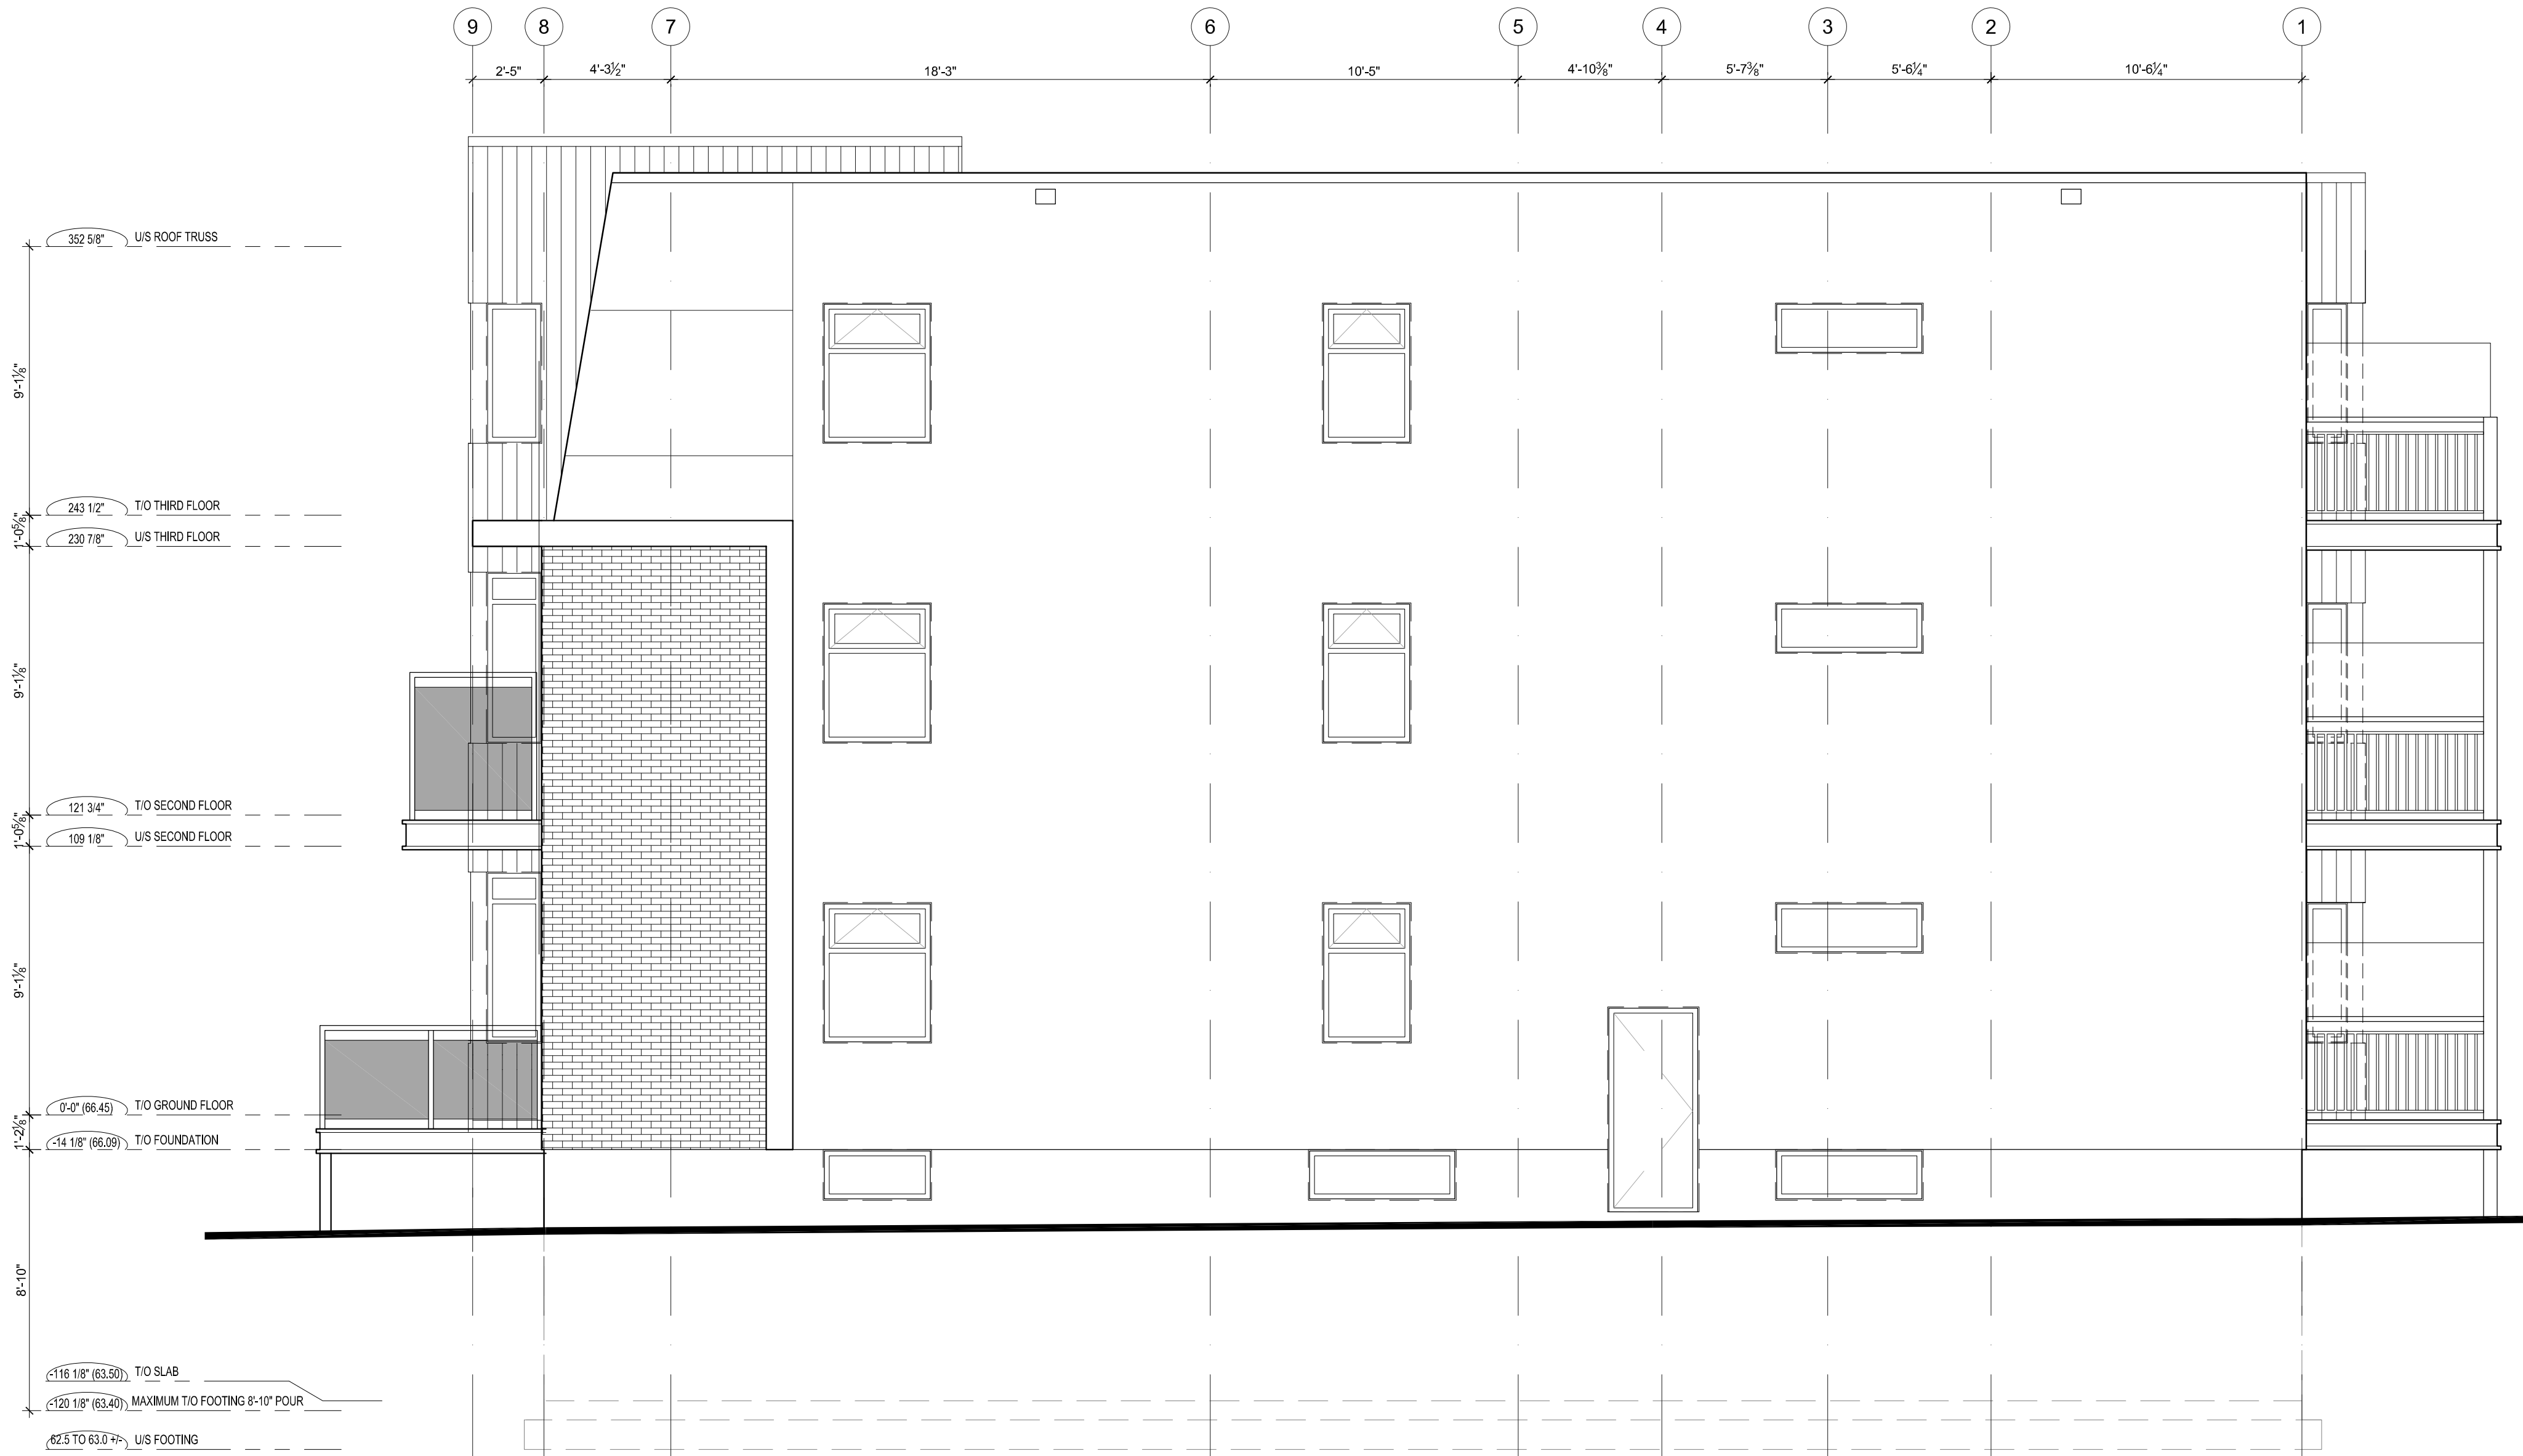
Rosaline J. Hill Architect Inc.

SMALL APARTMENT BUILDING
 368 Tweedsmuir Avenue, Ottawa, Ontario

REAR ELEVATION

Drawn By: MP/RV	Date: MAY 2022	Sheet: A2.2
Project No: 2131	Scale: 1/4" = 1'-0"	

PLOTTED Thu, 01 Dec 2022



352 5/8" U/S ROOF TRUSS

9'-1 1/2"

1'-0 5/8" 243 1/2" T/O THIRD FLOOR

230 7/8" U/S THIRD FLOOR

9'-1 1/2"

1'-0 5/8" 121 3/4" T/O SECOND FLOOR

109 1/8" U/S SECOND FLOOR

9'-1 1/2"

1'-2 1/8" 0'-0" (66.45) T/O GROUND FLOOR

-14 1/8" (66.09) T/O FOUNDATION

8'-10"

-116 1/8" (63.50) T/O SLAB

-120 1/8" (63.40) MAXIMUM T/O FOOTING 8'-10" POUR

62.5 TO 63.0 +/- U/S FOOTING

NOTE: PER PATERSON GEOTECHNICAL REPORT PG5961-1 BEDROCK IS EXPECTED BETWEEN 62.5m AND 63.0m +/-, ALL FOOTINGS TO BEAR DIRECTLY ON BEDROCK PER REPORT.

1 BUILDING SECTION
A3.1 SCALE: 1/4"=1'-0"

Consultants:

Consultants:

9		
8		
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SMALL APARTMENT BUILDING
368 Tweedsmuir Avenue, Ottawa, Ontario

RIGHT (NORTH) SIDE ELEVATION

Drawn By: **MP/RV** Date: **MAY 2022** Sheet: **A2.4**
Project No: **2131** Scale: **1/4" = 1'-0"**