

PRELIMINARY DESIGN

THESE DOCUMENTS ARE NOT COMPLETE

IN ALL DETAILS AND MAY BE SUBJECT TO CHANGE AS DESIGN DEVELOPMENT AND CODE REVIEW IS ADVANCED.

01 ISSUED TO CITY FOR REVIEW
FIRST ENGINEERING SUBMISSION

No. ISSUE / REVISION

DD/MM/YY

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VERIFY SHEET SIZE AND SCALES. BAR TO THE RIGHT IS 25mm IF THIS IS A FULL SIZE DRAWING.

SCALE: N.T.S



J.L.Richards

CONSULTANT:

PROFESSIONAL STAMP

ROFESSIONAL STAMP



PROJECT:

ARCADIA STAGE 6

450 HUNTMAR DRIVE

ELECTRICAL DETAILS

DESIGN: OS

DRAWN: OS

CHECKED: RH

JLR#: 26299-006

DRAWING#:

E02

File Location: V:\26000\26299-006 - Arcadia Stage 6\2-Design\5-Elect\AutoCAD For Visu

Statistics								Targets	
Description	Symbol	Avg	Min	Avg/Min	Туре	CLASSIFICATION	Avg	Avg/Min	
I - STREET 1 / STREET 2 NORTH	+	8.2 lux	2.5 lux	3.3:1	INTERSECTION	LOCAL	8.0 lux	6.0:1	
I - STREET 1 / STREET 2 SOUTH	+	10.0 lux	2.4 lux	4.2:1	INTERSECTION	LOCAL	8.0 lux	6.0:1	
I - STREET 1 / STREET 3	+	10.4 lux	4.6 lux	2.3:1	INTERSECTION	LOCAL	8.0 lux	6.0:1	
I - STREET 1 / STREET 4	+	8.6 lux	3.0 lux	2.9:1	INTERSECTION	LOCAL	8.0 lux	6.0:1	
I - STREET 1 / STREET 5	+	8.8 lux	4.1 lux	2.1:1	INTERSECTION	LOCAL	8.0 lux	6.0:1	
I - STREET 1 / STREET 6	+	8.9 lux	3.3 lux	2.7:1	INTERSECTION	LOCAL	8.0 lux	6.0:1	
I - STREET 2 / STREET 3	+	8.9 lux	3.6 lux	2.5:1	INTERSECTION	LOCAL	8.0 lux	6.0:1	
I - STREET 2 / STREET 4	+	8.5 lux	4.5 lux	1.9:1	INTERSECTION	LOCAL	8.0 lux	6.0:1	
STREET 1 - ENTRANCE	+	7.1 lux	1.9 lux	3.7:1	ROAD	LOCAL	4.0 lux	6.0:1	
STREET 3	+	8.0 lux	2.5 lux	3.2:1	ROAD	LOCAL	4.0 lux	6.0:1	
STREET 5	+	7.2 lux	2.2 lux	3.3:1	ROAD	LOCAL	4.0 lux	6.0:1	
STREET 6	+	8.9 lux	3.9 lux	2.31	ROAD	LOCAL	4.0 lux	6.0:1	


FIXTURE AND POLE SCHEDULE:

TYPE:	FIXTURE:	POLE:
Ж _А	L40U LED PENDANT LUMINAIRE 55W LED - ROADWAY LUMINAIRE - 3000K L40U-STM-55W48LED3K-G2-C-LE2	MADISON CONCRETE OCTAGONAL POLE 9.1m MANUFACTURED BY USI MA-300-B-2-BE-60-F-OTT WITH 1.4m BRACKET

NOTE:
ALL LUMINAIRES ARE TO BE COMPLETE WITH LUMEN IQ ADAPTIVE NODE A440 PHOTOCELL. CONTRACTOR TO INSTALL CONTROL NODE ADDITIONAL IDENTIFICATION STICKER ON DRAWINGS AT EACH STREET LIGHT POLE LOCATION. COORDINATE WITH CITY OF OTTAWA STREET LIGHT PROJECT COORDINATOR.

NOTES:

- 1. ALL FIXTURE POLES TO HAVE INTEGRAL FUSING AND PHOTO CELL.
- 2. UNLESS NOTED OTHERWISE ALL UNDERGROUND WIRING TO BE MINIMUM #8 TWU OR RWU TYPE, SIZED SO THAT MAXIMUM VOLTAGE DROP AT THE END OF THE CIRCUIT DOES NOT EXCEED 5% OF SUPPLY VOLTAGE. GROUNDING WIRING (LAST POLE AND EVERY FIFTH POLE) #8 AWG CU RWU CONDUCTOR SHOULD BE USED.
- 3. ALL ROADS CROSSING ARE TO BE CONCRETE ENCASED AS PER CITY OF OTTAWA SPECIFICATION, c/w SPARE DUCT.
- 4. ALL DIRECT BURIED CONDUIT TO BE INSTALLED AS PER CITY OF OTTAWA AND HYDRO OTTAWA SPECIFICATIONS.
- 5. ALL DIRECT BURIED CONDUIT TO BE MINIMUM 75mm PVC TYPE DB2 CONDUIT, REFER TO CITY OF OTTAWA SPECIFICATION LID0001A AND HYDRO
- 6. PROVIDE GROUND RODS AS SHOWN ON ELECTRICAL WIRING DRAWING.
- 7. ALL EMPTY CONDUIT TO BE c/w NYLON PULL STRING.

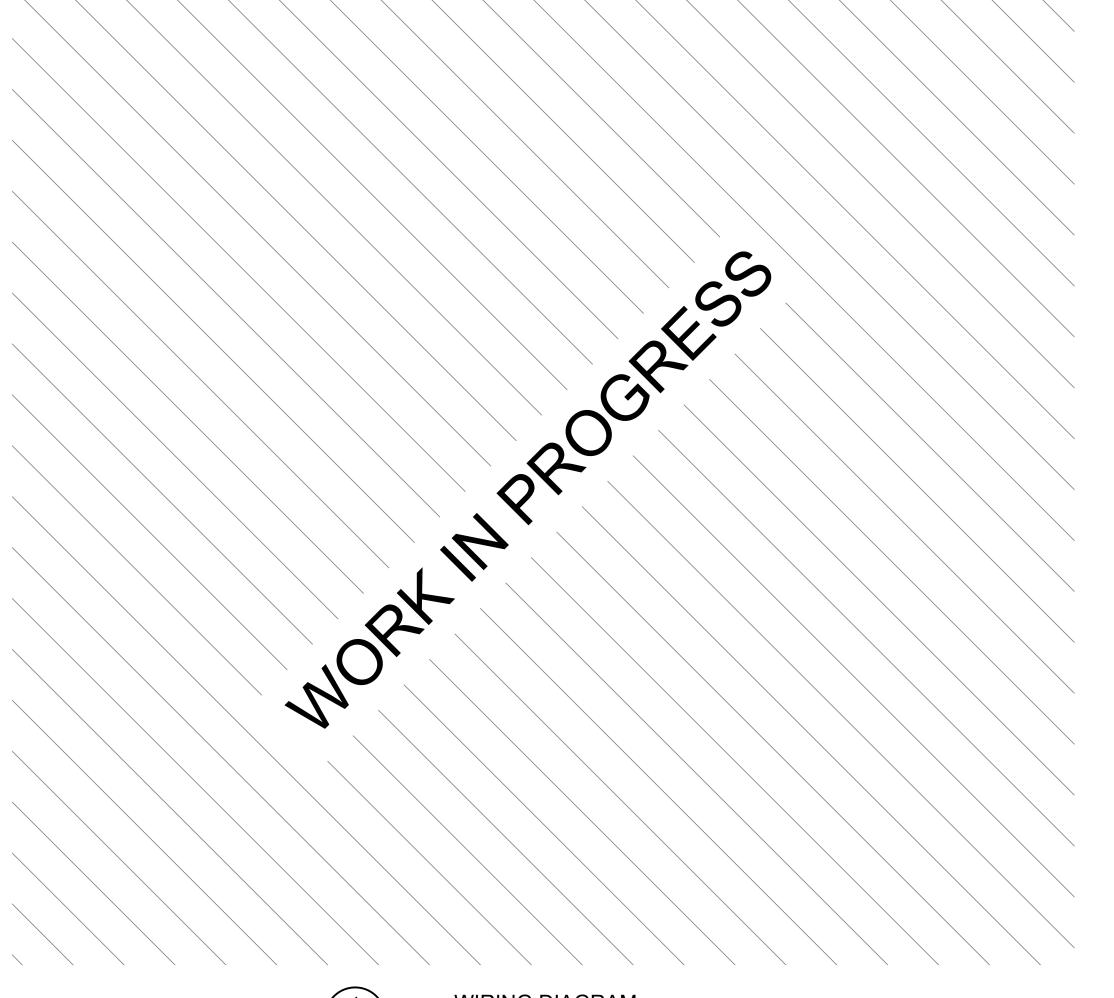



1. ALL STREETLIGHT MATERIALS AND INSTALLATIONS MUST COMPLY WITH CITY OF OTTAWA STANDARDS AND SPECIFICATIONS.

STREET LIGHT CABLES

2H,1B,1C,1SL DENOTES NUMBER OF DUCTS

GROUND ROD

CONCRETE ENCASED DUCT

55W LED STREET LIGHT

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ARCADIA STAGE 6


450 HUNTMAR DRIVE

LIGHTING STATISTICS


E03


CHECKED: RH

JLR #: 26299-006

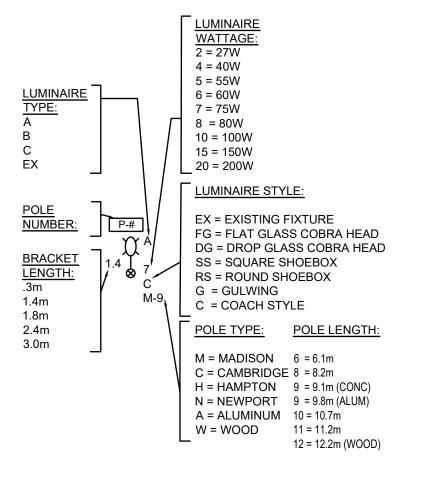



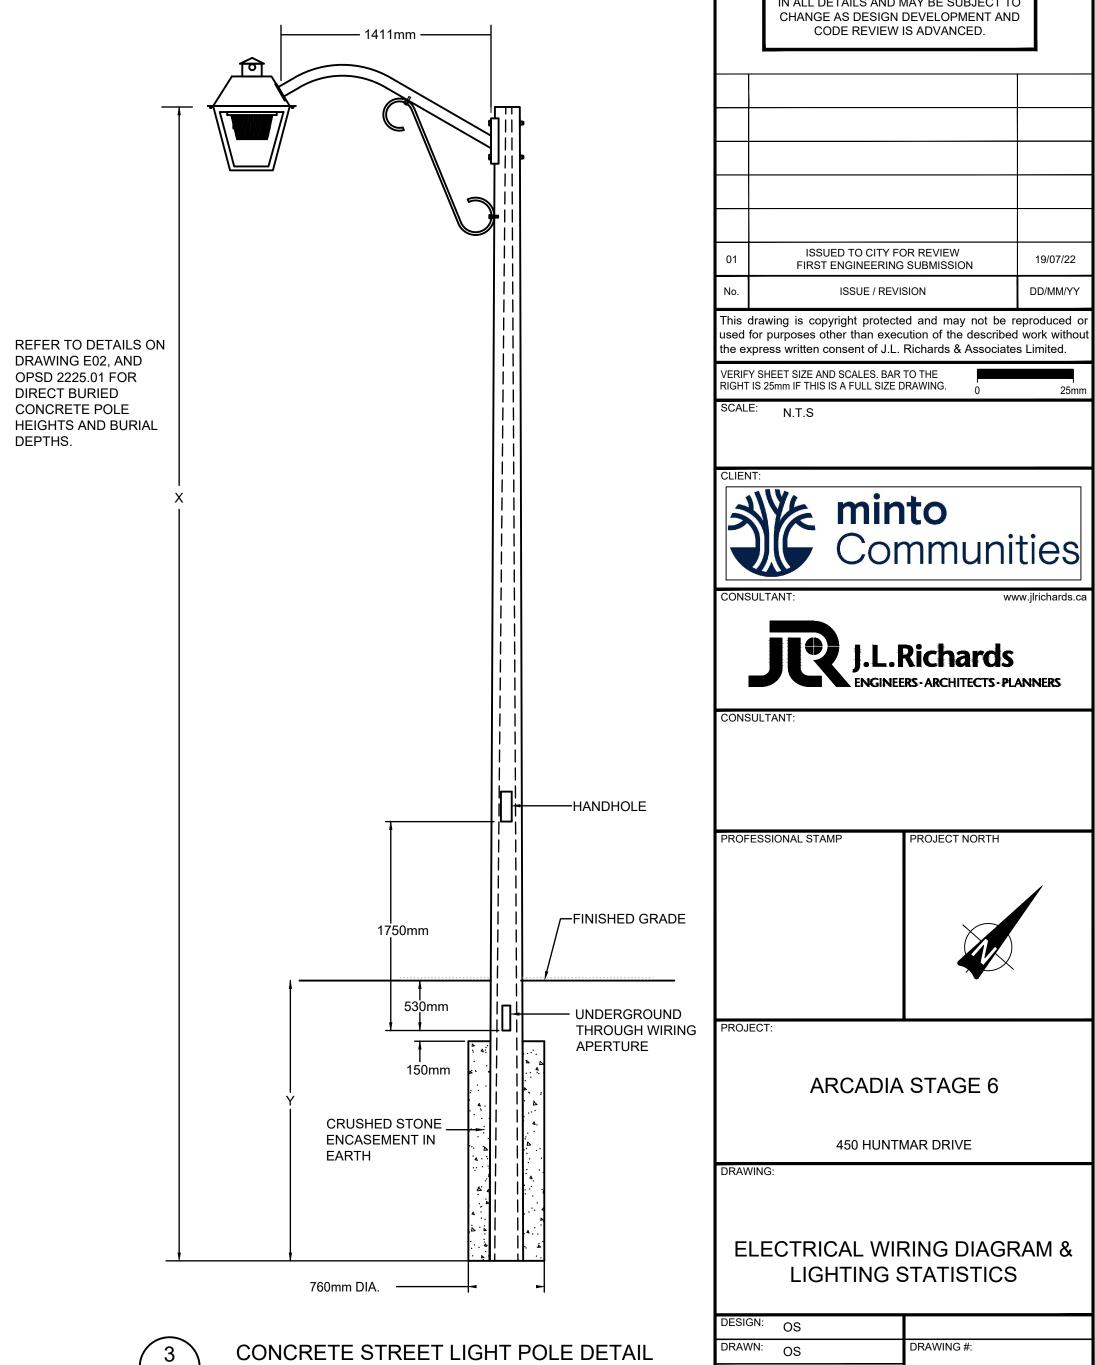

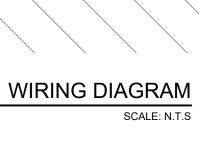





STREET 6

26299-006 ARCADIA STAGE 2022-07-18

Designer
OS
Date
2022-07-18
Scale
Not to Scale
Drawing No.
Summary

8.9 lux | 20.3 lux | 3.9 lux |

5.2:1

2.3:1