



1 CONCRETE PAVING Scale: 1:10

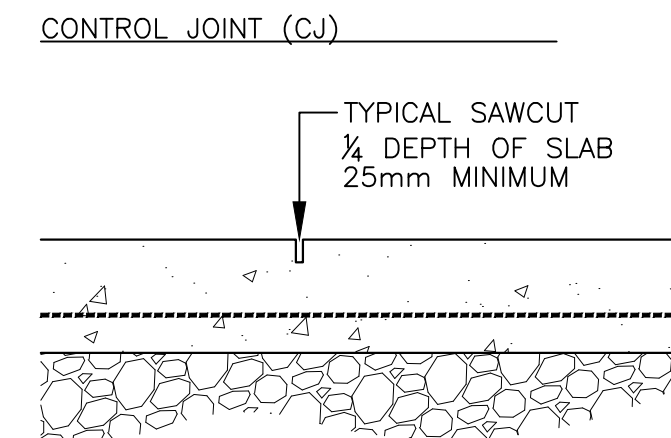

CONTROL JOINT (CJ)
 TYPICAL SAWCUT
 1/4 DEPTH OF SLAB
 25mm MINIMUM


- NOTES:
 1. REFER TO DRAWINGS FOR JOINT LAYOUT
 2. SAWCUT WITHIN 48 HOURS OF POUR
 3. NO TOOLED EDGES

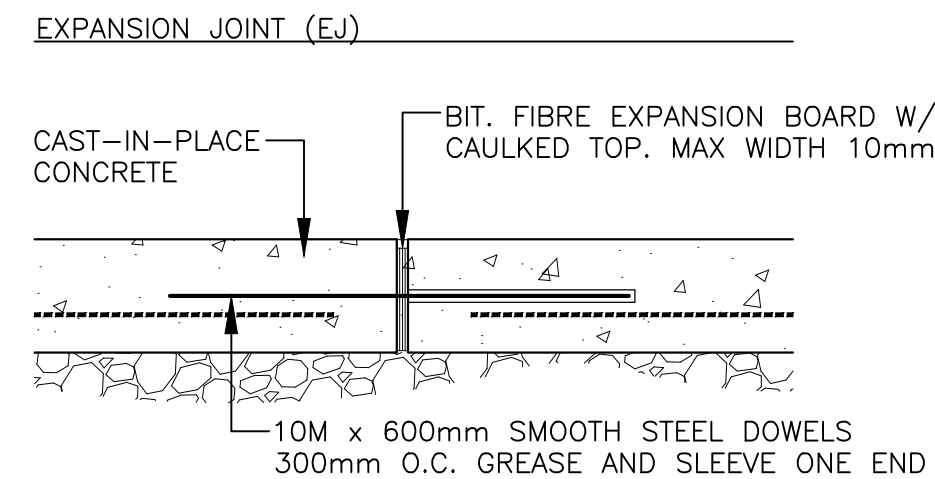


EXPANSION JOINT (EJ)
 BIT. FIBRE EXPANSION BOARD W/
 CAULKED TOP. MAX WIDTH 10mm
 10M x 600mm SMOOTH STEEL DOWELS
 300mm O.C. GREASE AND SLEEVE ONE END

- NOTES:
 1. REFER TO DRAWINGS FOR JOINT LAYOUT
 2. ALL STEEL DOWELS TO BE EPOXY - COATED
 3. NO TOOLED EDGES

2 CONCRETE JOINTS Scale: 1:10

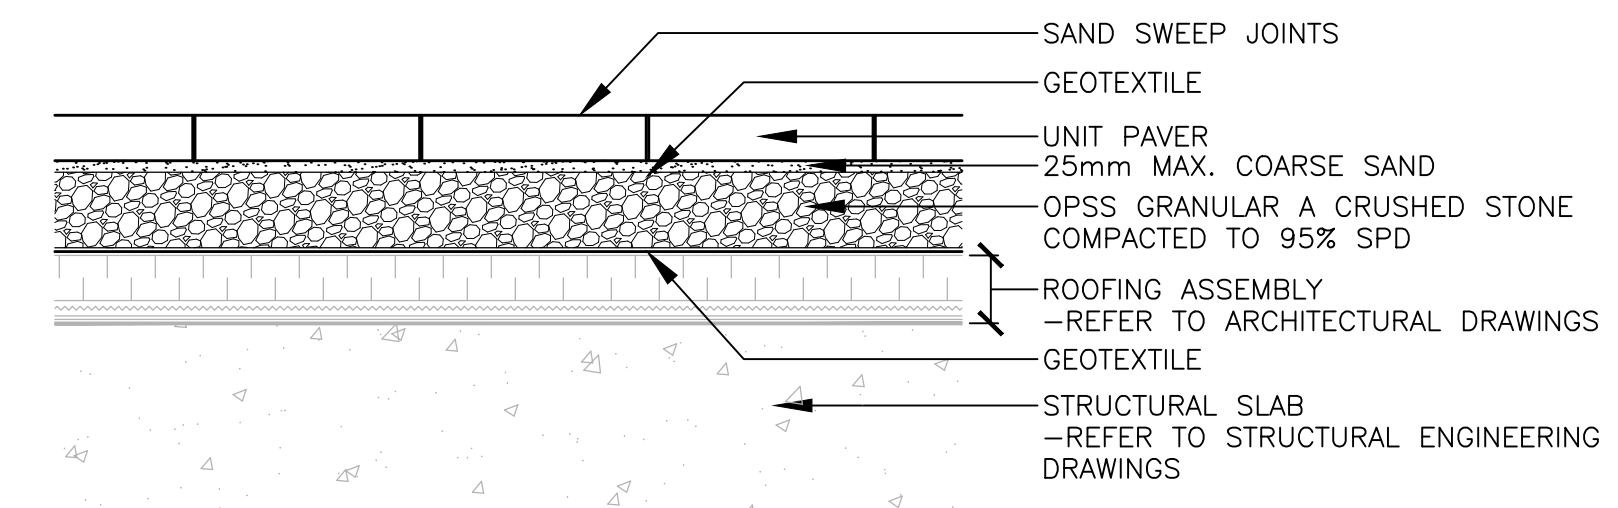


3 UNIT PAVING Scale: 1:10

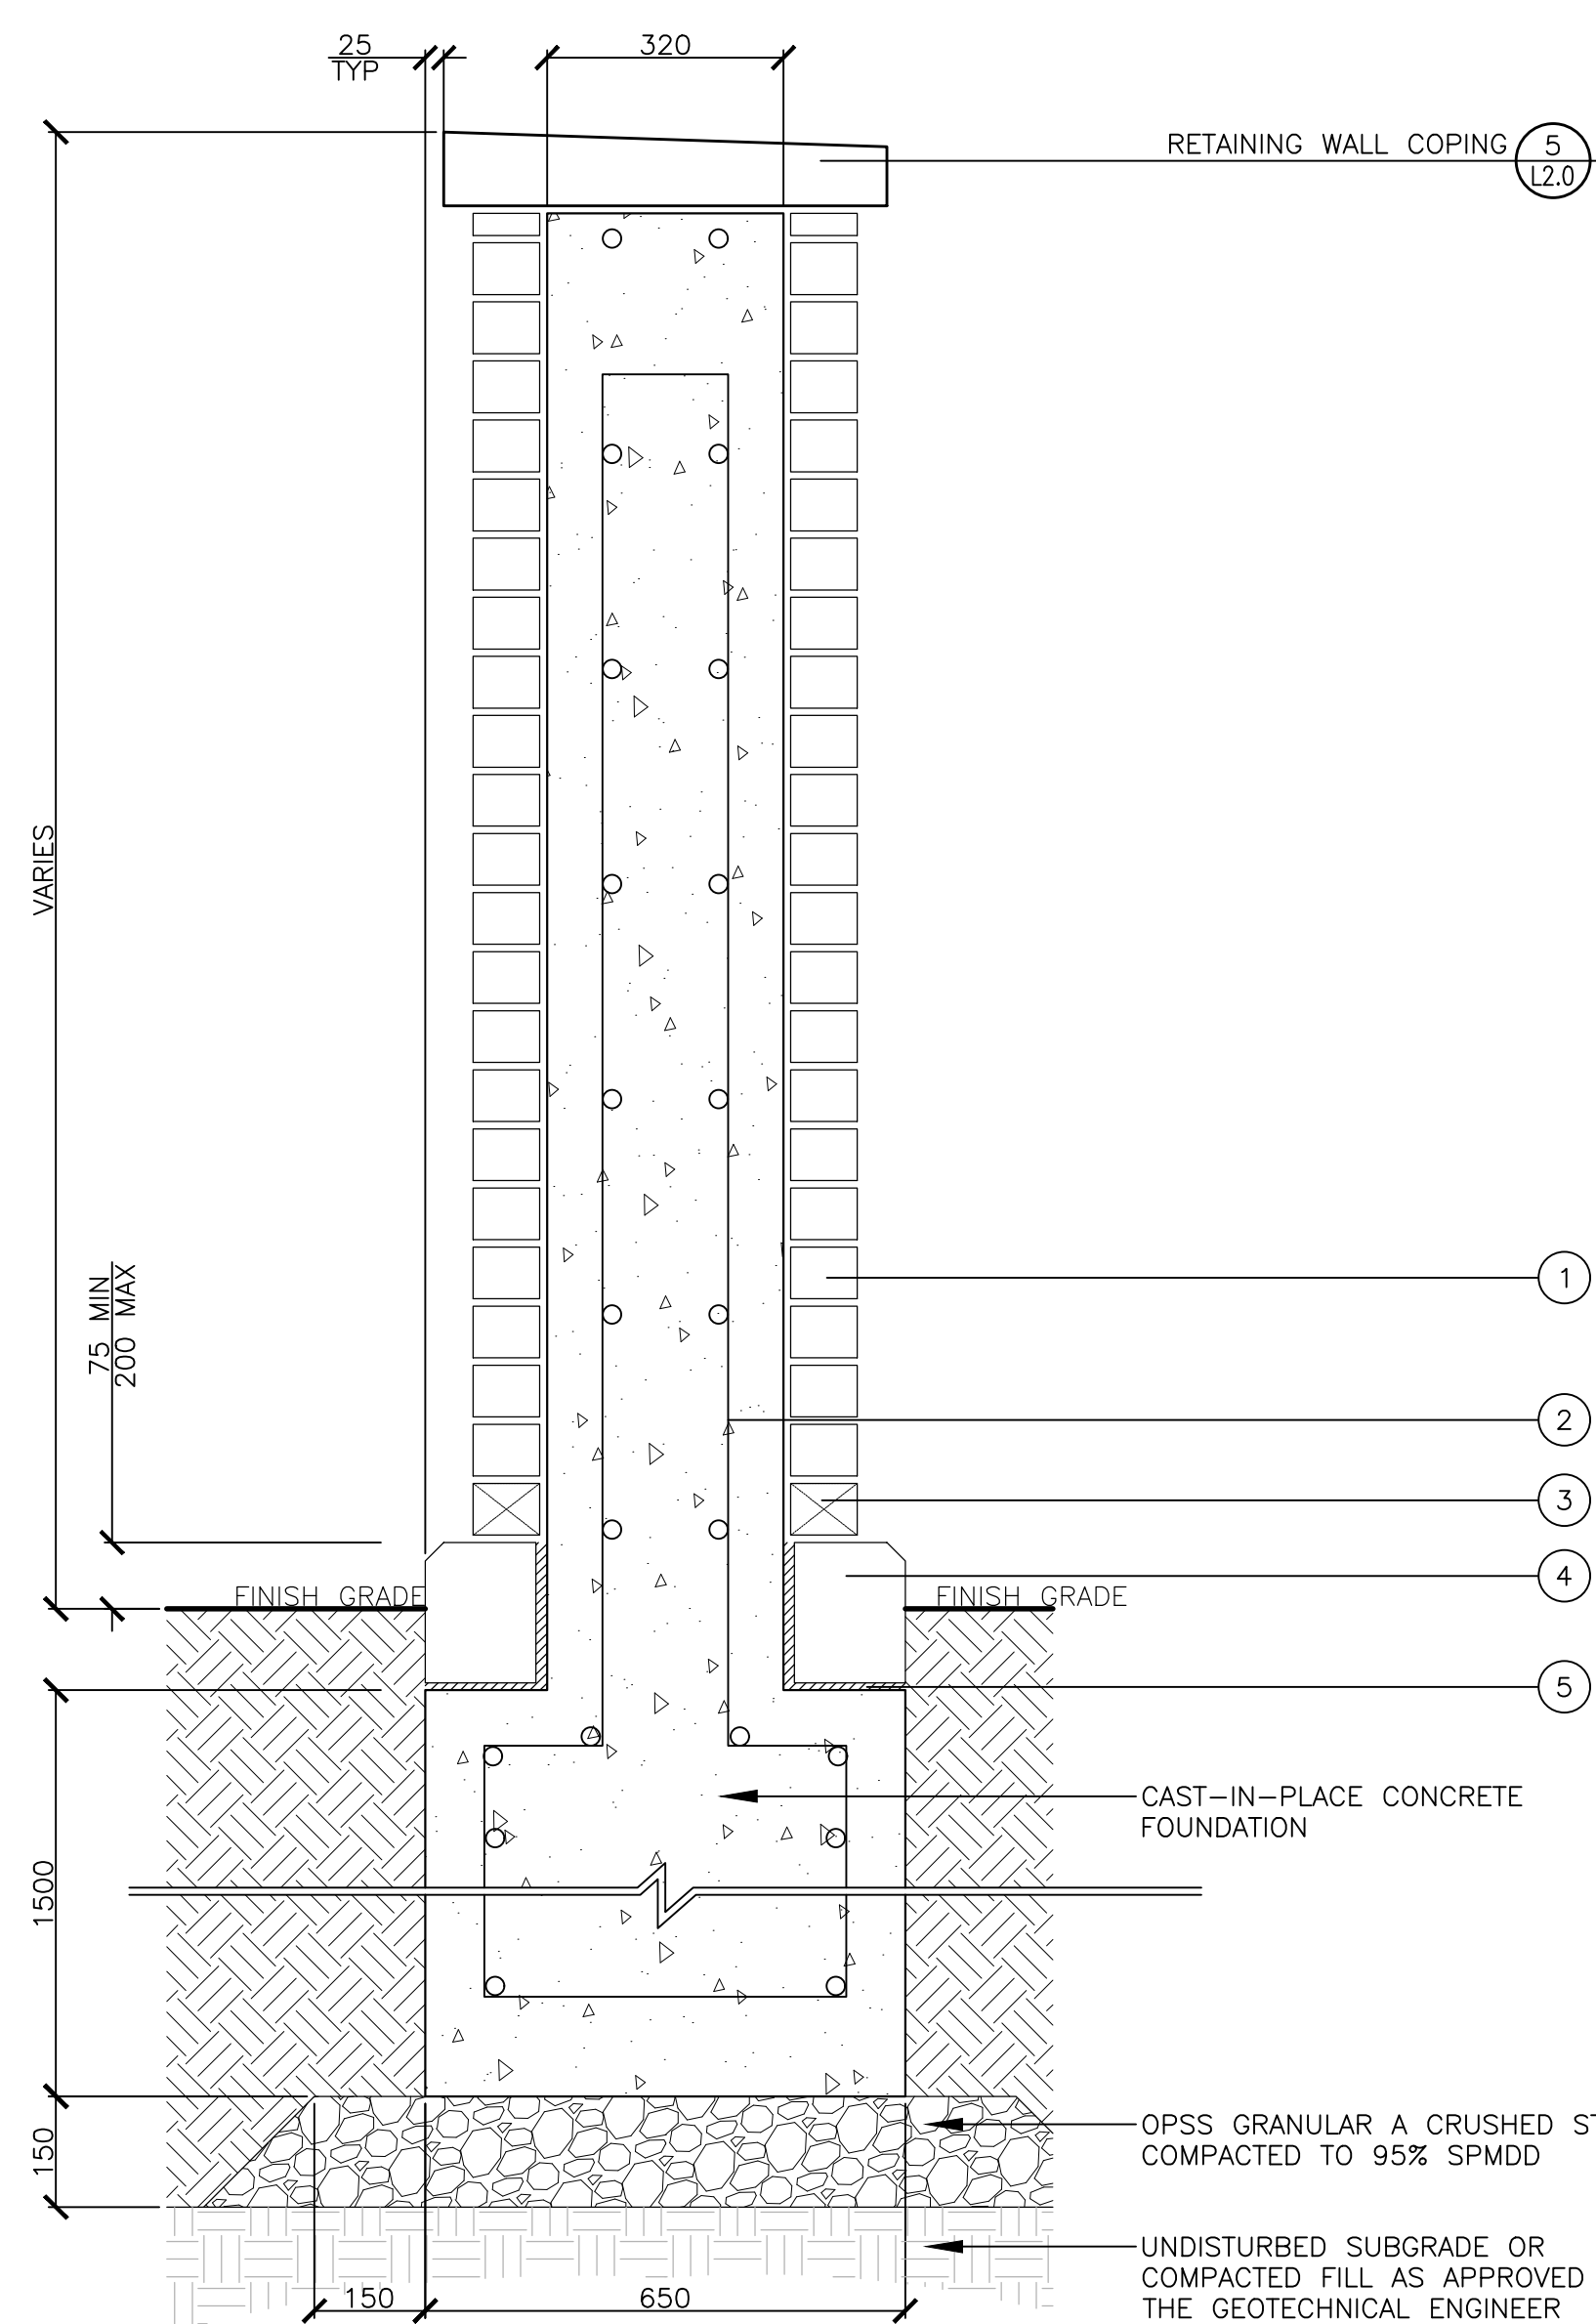


- NOTES:
 1. CLAY BRICK: -PATTERN: OFFSET RUNNING BOND
 2. REBAR: -15M HORIZONTAL CONTINUOUS
 -15M VERTICAL REBAR @ 450mm O.C.
 -ALL REBAR TO BE EPOXY COATED
 3. WEEP HOLE AT APPROX. 600mm SPACING. PROVIDE 10mm AIR SPACE BEHIND ALL MASONRY BRICK
 4. GRANITE FACING STONE: -25mm CHAMFER AT EXPOSED EDGE
 -NO AIR SPACE BEHIND GRANITE STONE
 5. WALL LEDGE TO STEP AS REQUIRED. STEPS TO BE EVENLY SPACED. HEIGHT OF STEPS SHALL BE EQUAL TO HEIGHT OF ONE BRICK COURSE
 6. INSTALL VERTICAL CONTROL JOINTS 4000 O.C. OR WHERE FOUNDATION STEPS

4 MASONRY PRIVACY WALL & MASONRY COLUMN Scale: 1:10

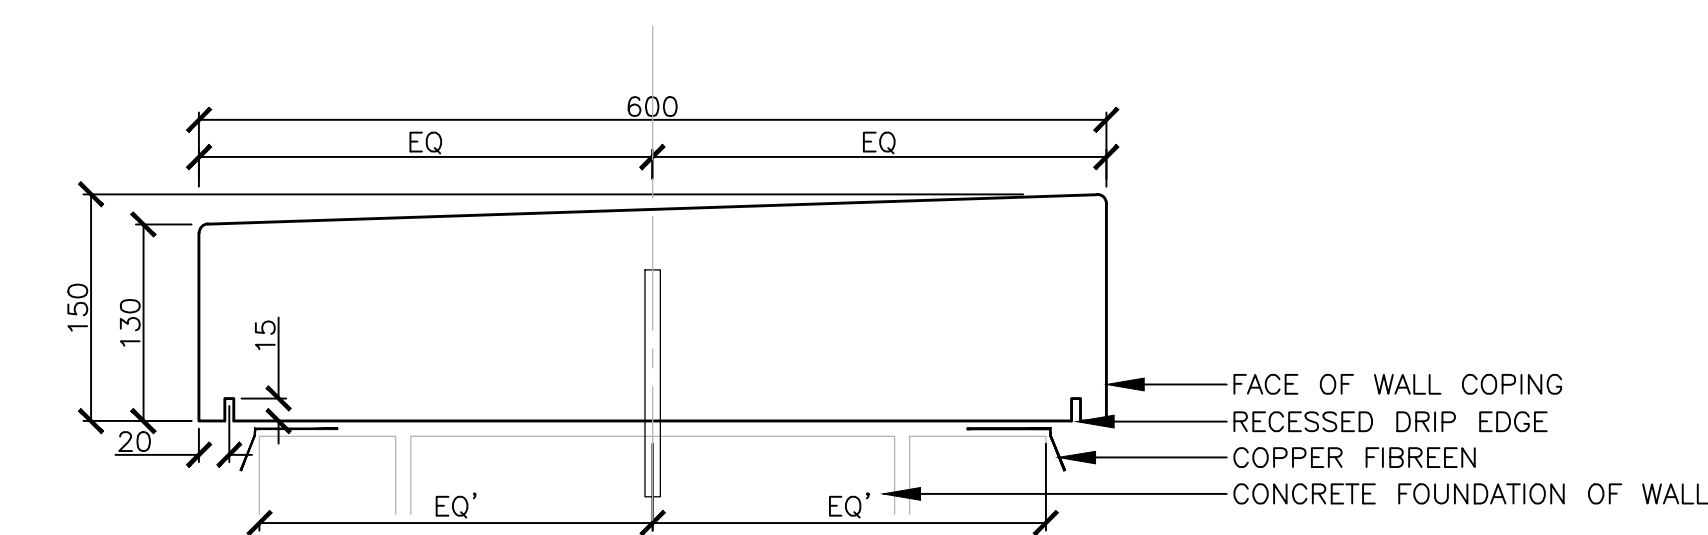


- NOTES:
 1. COPING TO BE PRECAST WITH MEDIUM SANDBLAST FINISH
 2. 6mm RADIUS AT TOP FRONT AND TOP BACK EDGES
 3. ALL COPING STONE TO BE SECURED TO WALL WITH TWO DOWELS. MORTAR ALL JOINTS
 4. FACE OF WALL COPING TO BE ADJACENT PLAZAS
 5. PROVIDE SAMPLES AND SHOP DRAWINGS FOR REVIEW PRIOR TO COMMENCEMENT OF WORK

5 PRIVACY WALL COPING Scale: 1:10

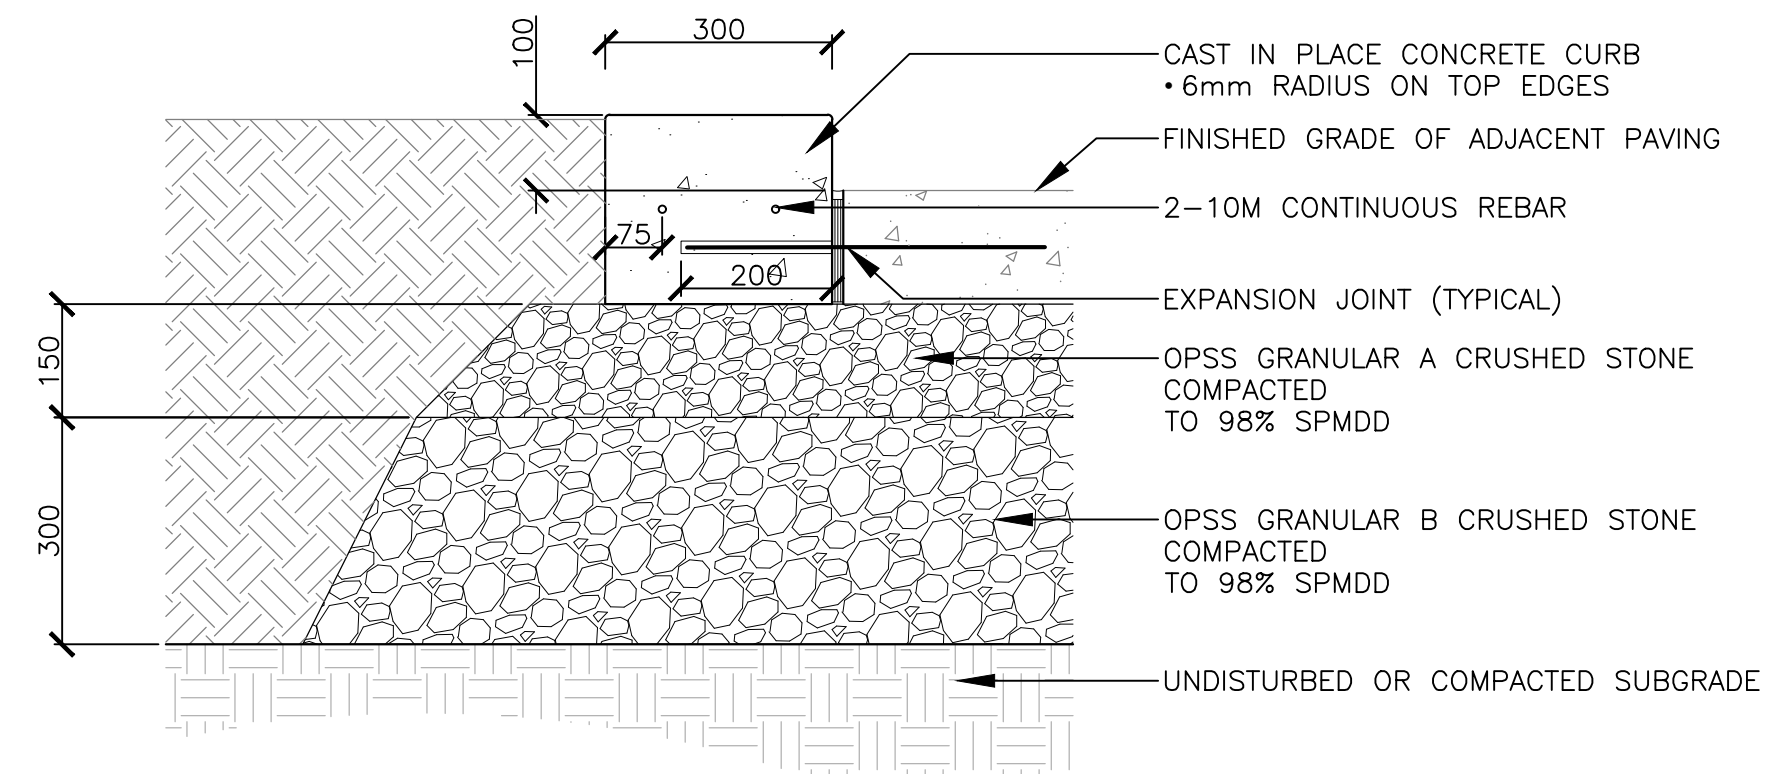


7 LANDSCAPE CURB Scale: 1:10

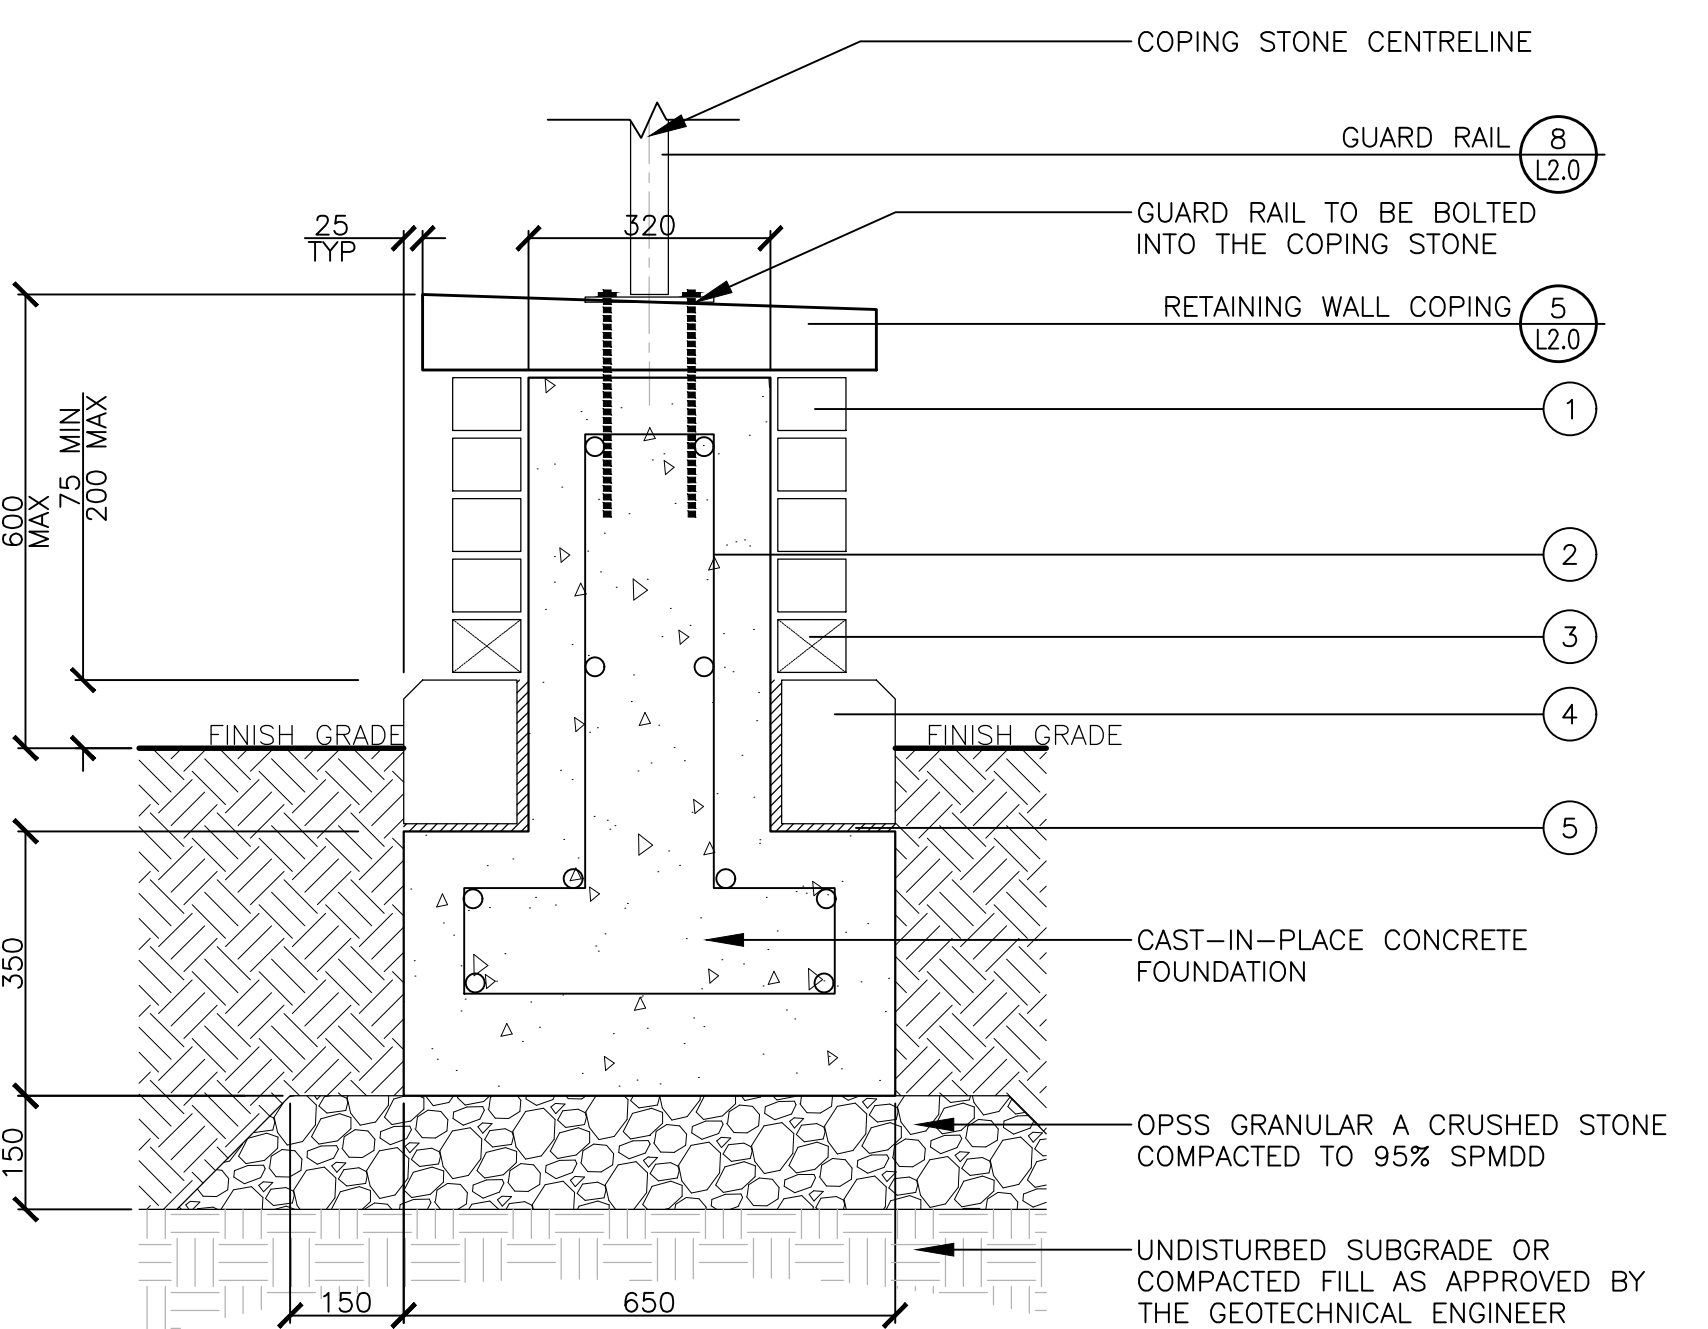

- NOTES:
 1. CLAY BRICK: -PATTERN: OFFSET RUNNING BOND
 2. REBAR: -15M HORIZONTAL CONTINUOUS
 -15M VERTICAL REBAR @ 450mm O.C.
 -ALL REBAR TO BE EPOXY COATED
 3. WEEP HOLE AT APPROX. 600mm SPACING. PROVIDE 10mm AIR SPACE BEHIND ALL MASONRY BRICK
 4. GRANITE FACING STONE: -25mm CHAMFER AT EXPOSED EDGE
 -NO AIR SPACE BEHIND GRANITE STONE
 5. WALL LEDGE TO STEP AS REQUIRED. STEPS TO BE EVENLY SPACED. HEIGHT OF STEPS SHALL BE EQUAL TO HEIGHT OF ONE BRICK COURSE
 6. INSTALL VERTICAL CONTROL JOINTS 4000 O.C. OR WHERE FOUNDATION STEPS

6 LOW MASONRY WALL Scale: 1:10

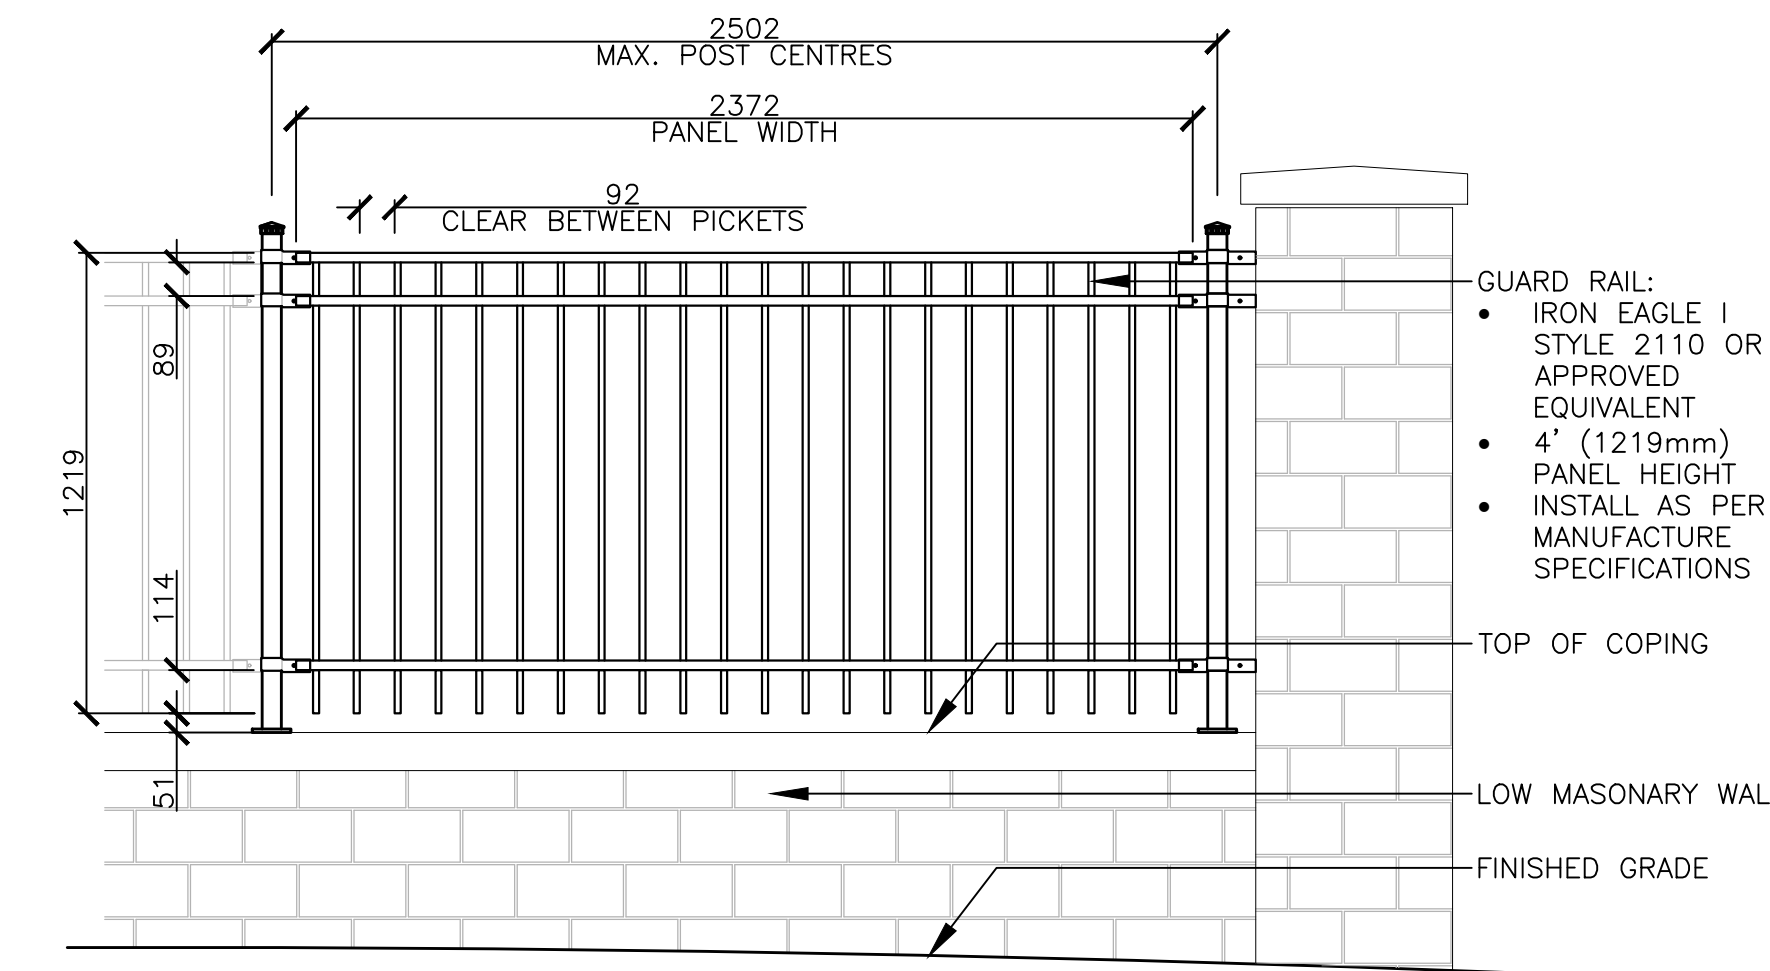

8 GUARD RAIL Scale: 1:20

No.	Revision	Date
5.	ISSUED FOR SPA	14 JUN, 2022
4.	REISSUED FOR RE-ZONING	07 DEC, 2021
3.	ISSUED FOR RE-ZONING	15 JUL, 2021
2.	ISSUED FOR REVIEW/COORDINATION	06 JUL, 2021
1.	ISSUED FOR REVIEW/COORDINATION	24 JUN, 2021

North:		Stamp:	

CSW Landscape Architecture
 Urban Design
 Site Planning
 Recreation and Park Planning
 Project Management

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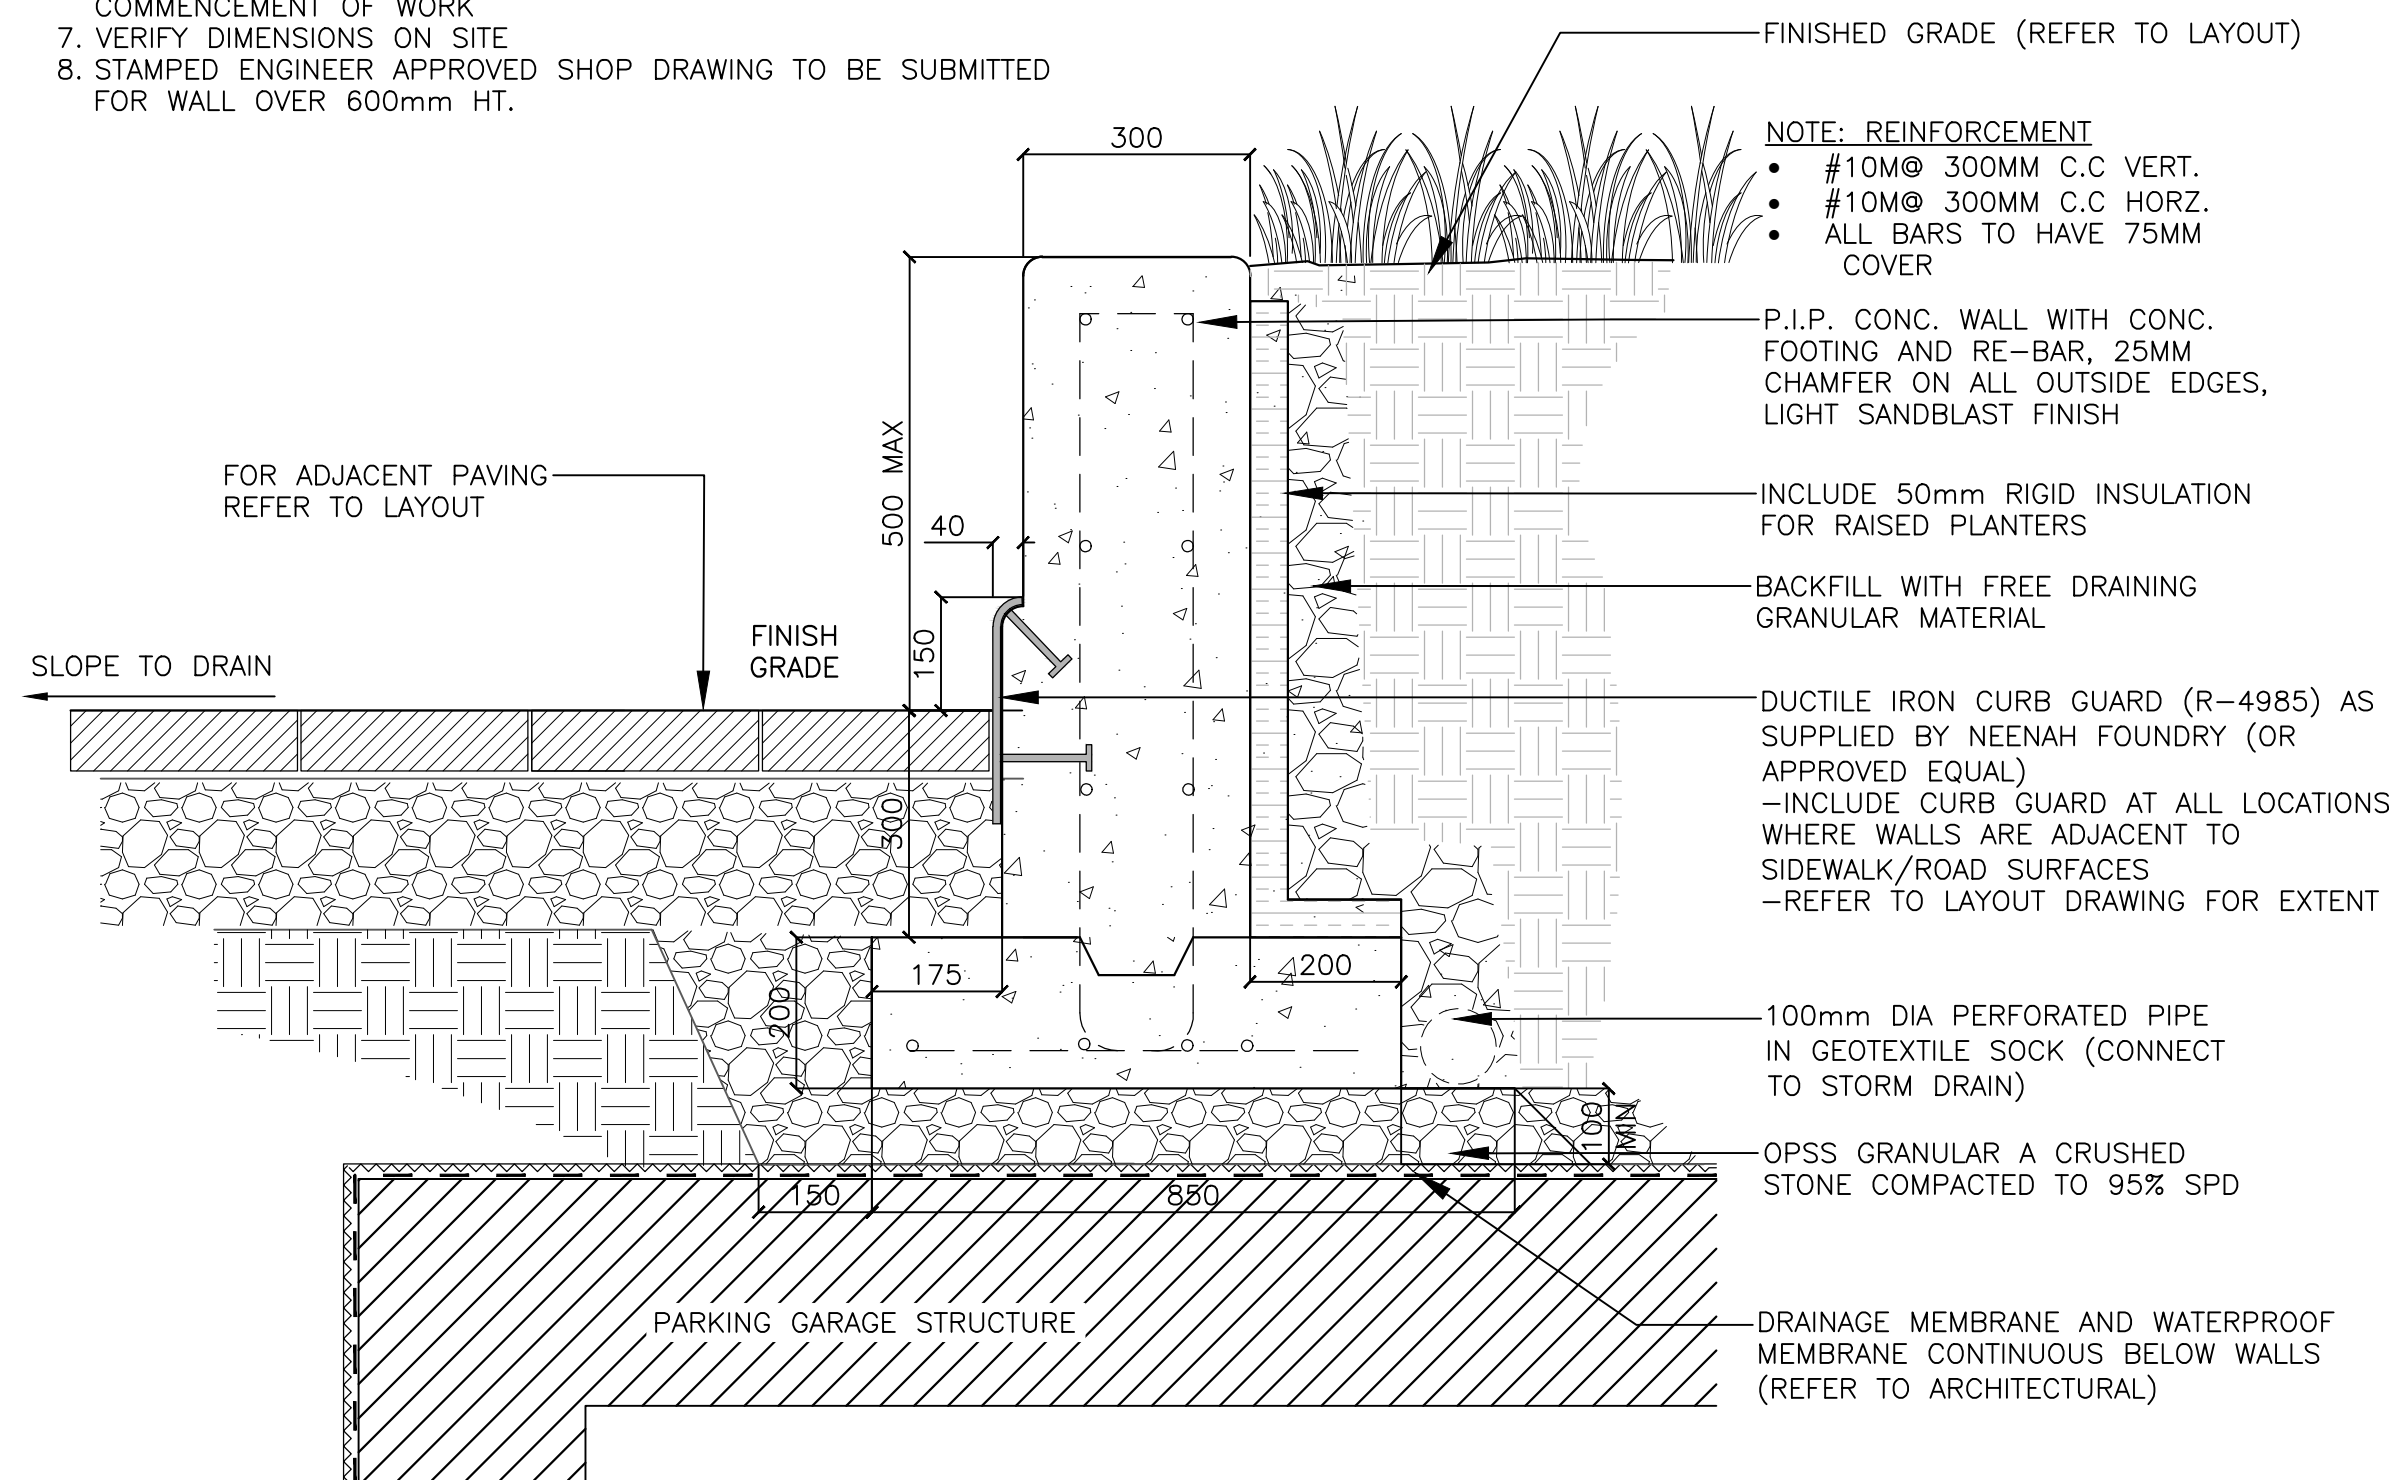
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 - check and verify all dimensions on site;
 - report all errors and/or omissions to the landscape architect;
 - comply with all pertinent codes and by-laws;
 - check and verify locations of all underground services with all local utilities prior to any digging.

Project:
50 THE DRIVEWAY
 50 THE DRIVEWAY
 OTTAWA, ONTARIO


Drawing:
LANDSCAPE PLAN

Scale:	AS NOTED	Date:	15 JUNE, 2021
Design By:	AC	Drawn By:	SMc
Project Number:	2096-01	Sheet Number:	L 2.0


- NOTES:
1. ALL WALLS TO HAVE ARCHITECTURAL GRADE FORM WORK
 2. ALL EXPOSED SURFACES TO HAVE LIGHT SANDBLAST FINISH
 3. 25mm RADIUS ON TOP EDGES
 4. ENSURE 75mm COVERAGE OVER ALL HORIZONTAL AND VERTICAL REINFORCING
 5. BIT. FIBRE EXPANSION JOINT EVERY 4M (10M X 600mm SMOOTH STEEL DOWELS, GREASE AND SLEEVE ONE END (6 AT EACH EXPANSION JOINT), ENSURE 100mm COVER
 6. SHOP DRAWINGS TO BE SUBMITTED FOR REVIEW PRIOR TO COMMENCEMENT OF WORK
 7. VERIFY DIMENSIONS ON SITE
 8. STAMPED ENGINEER APPROVED SHOP DRAWING TO BE SUBMITTED FOR WALL OVER 600mm HT.



1 CIP CONCRETE RETAINING WALL Scale: 1:10

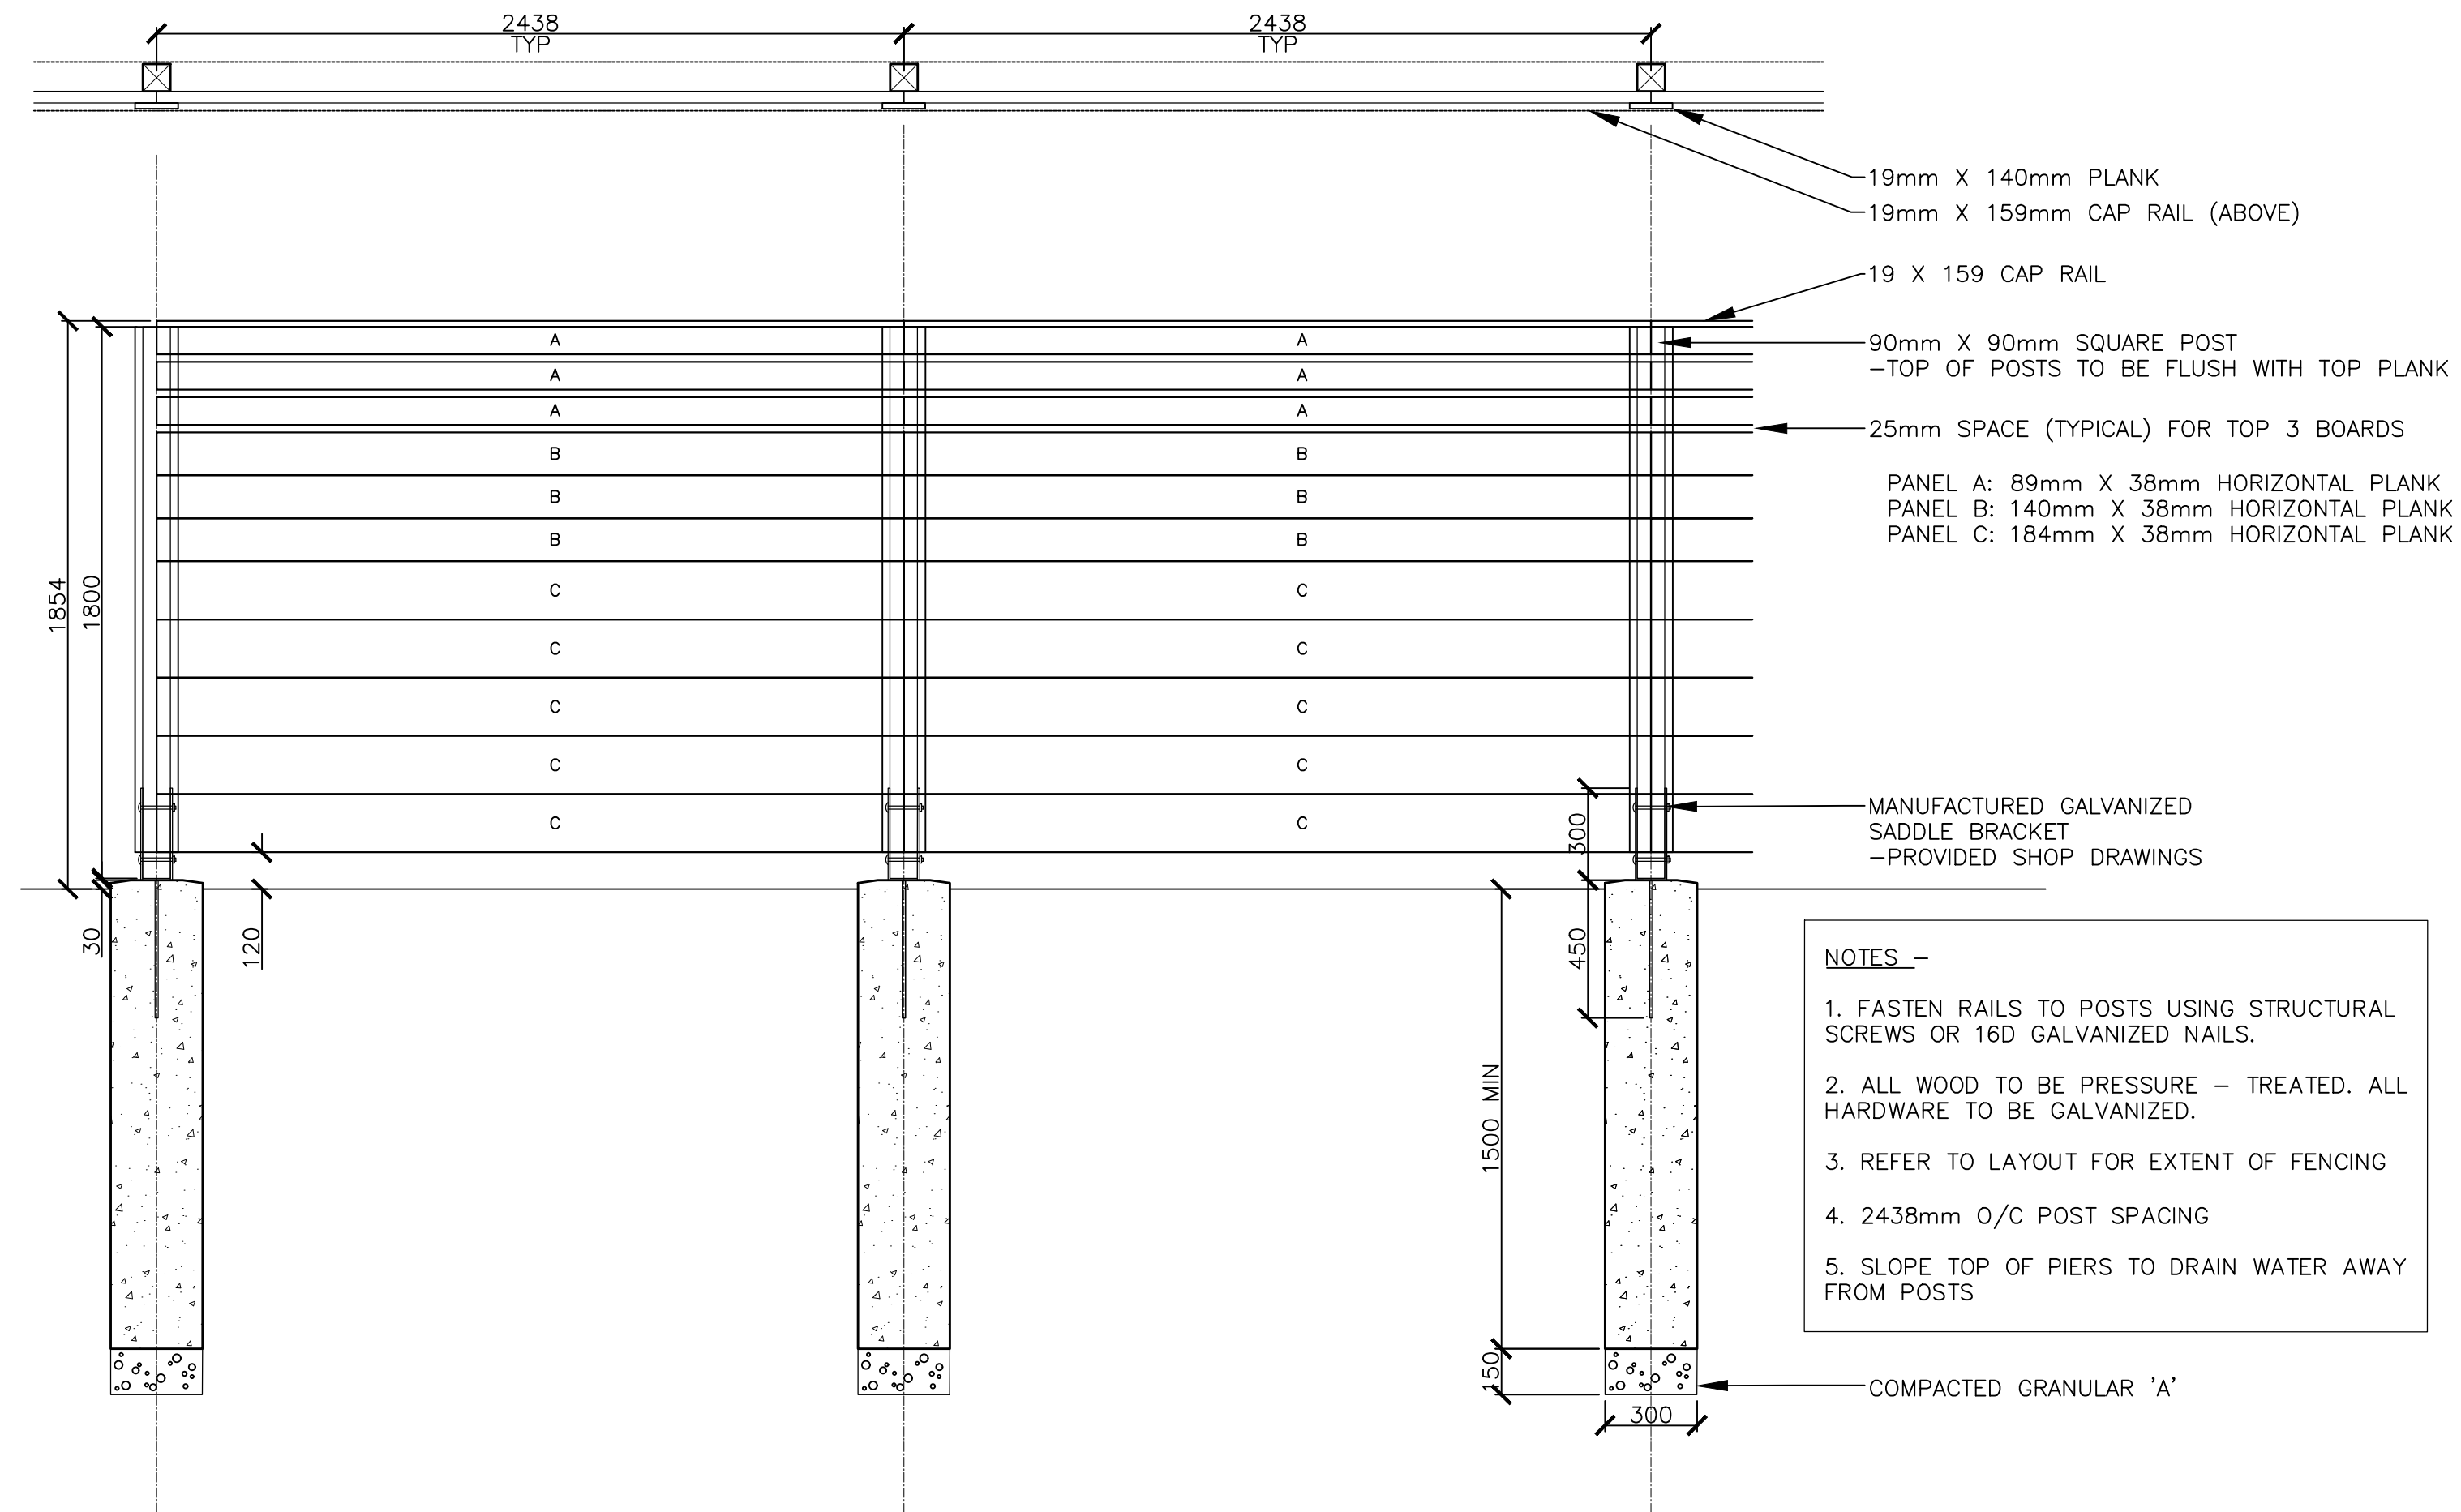


2 1.8M HEIGHT PRIVACY FENCE Scale: 1:20

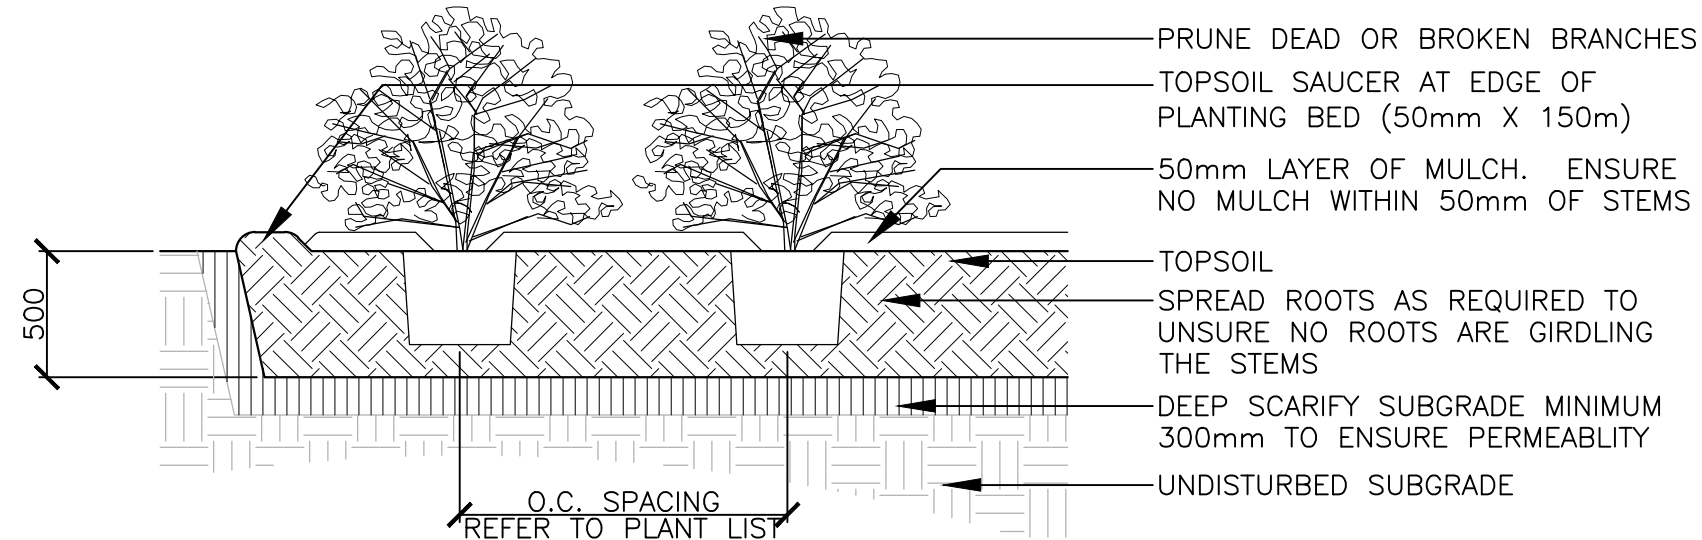


- NOTES:
- TOP OF ROOT BALL TO RETAIN SAME ELEVATION AS GROWING CONDITIONS

3 SHRUB PLANTING Scale: 1:30

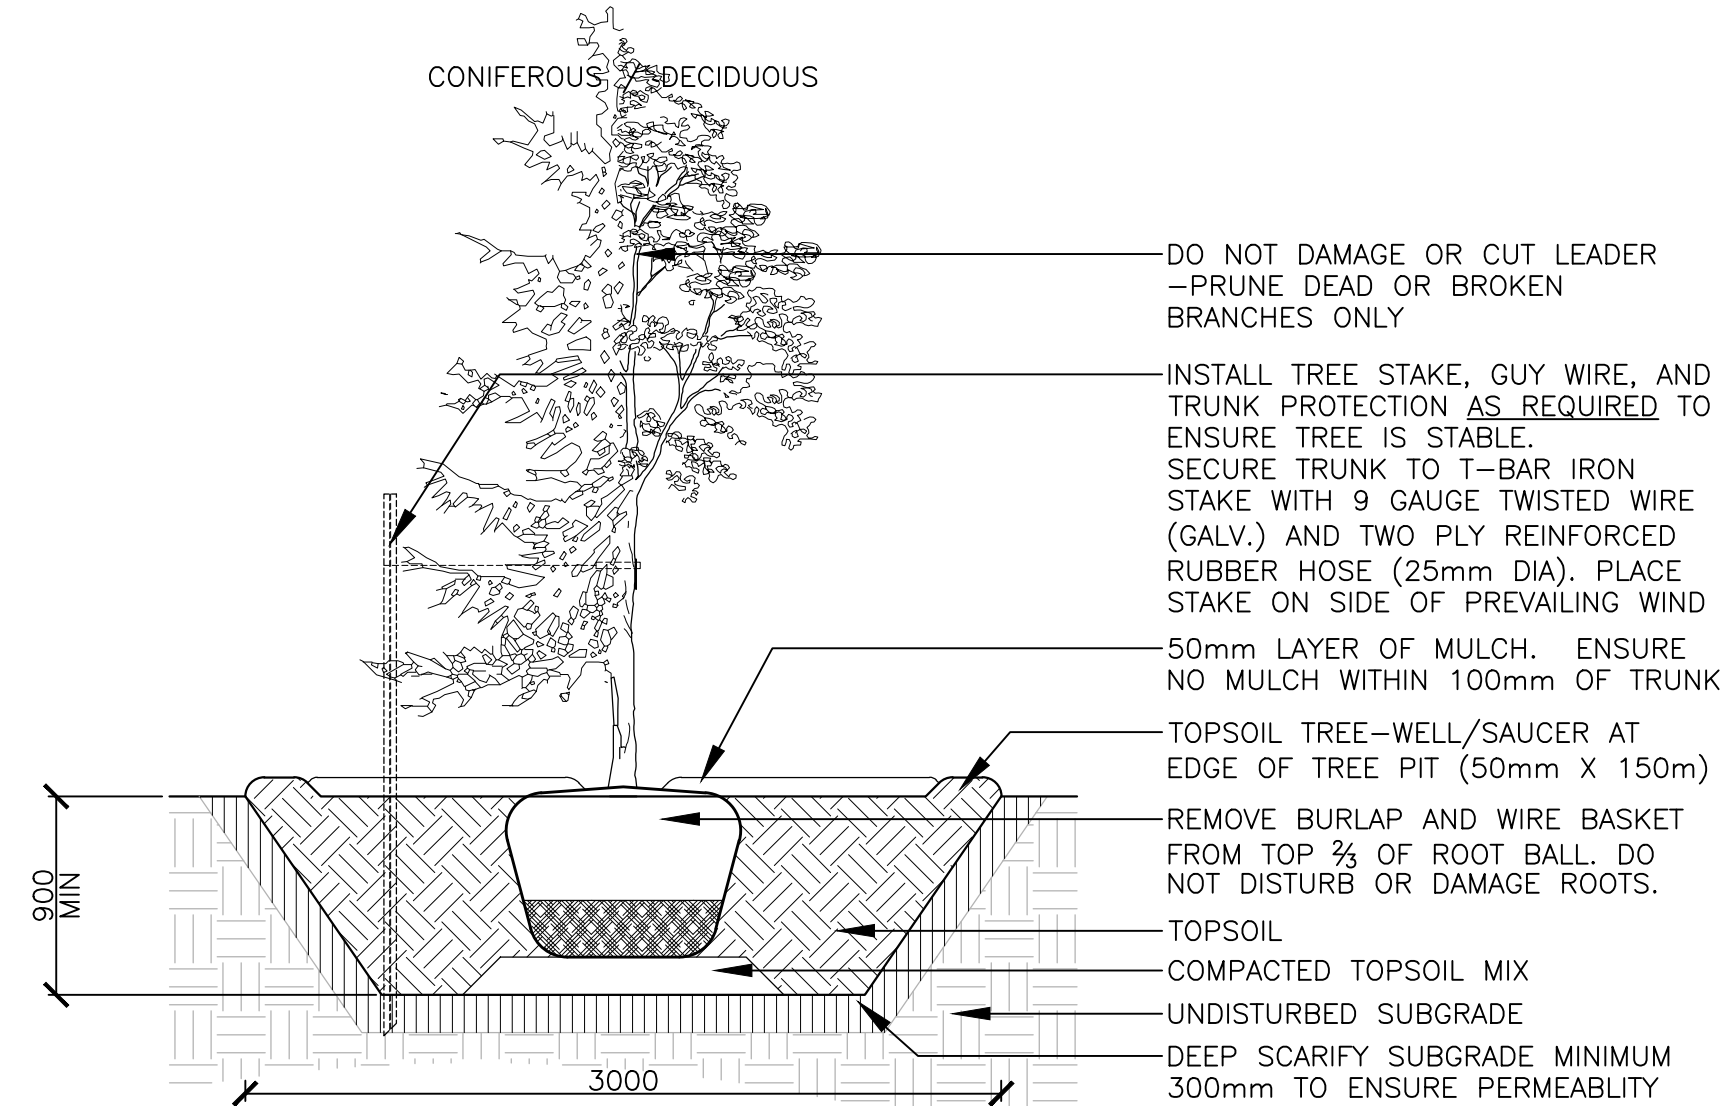

- NOTES:
- TREE STAKES ARE GENERALLY ARE TO BE USED FOR CONDITIONS WHERE THE INSTALLED TREE IS UNSTABLE AND/OR BECOMES UNSTABLE
 - ALLOW 10mm TO 25mm SLACK ON GUY WIRE SUPPORT FOR TREE
 - TOP OF ROOT BALL TO RETAIN SAME ELEVATION AS GROWING CONDITIONS
 - REMOVE STAKES ONE YEAR AFTER INSTALL
 - INSTALL STAKE BEYOND EDGE OF ROOT BALL

4 TREE PLANTING Scale: 1:30

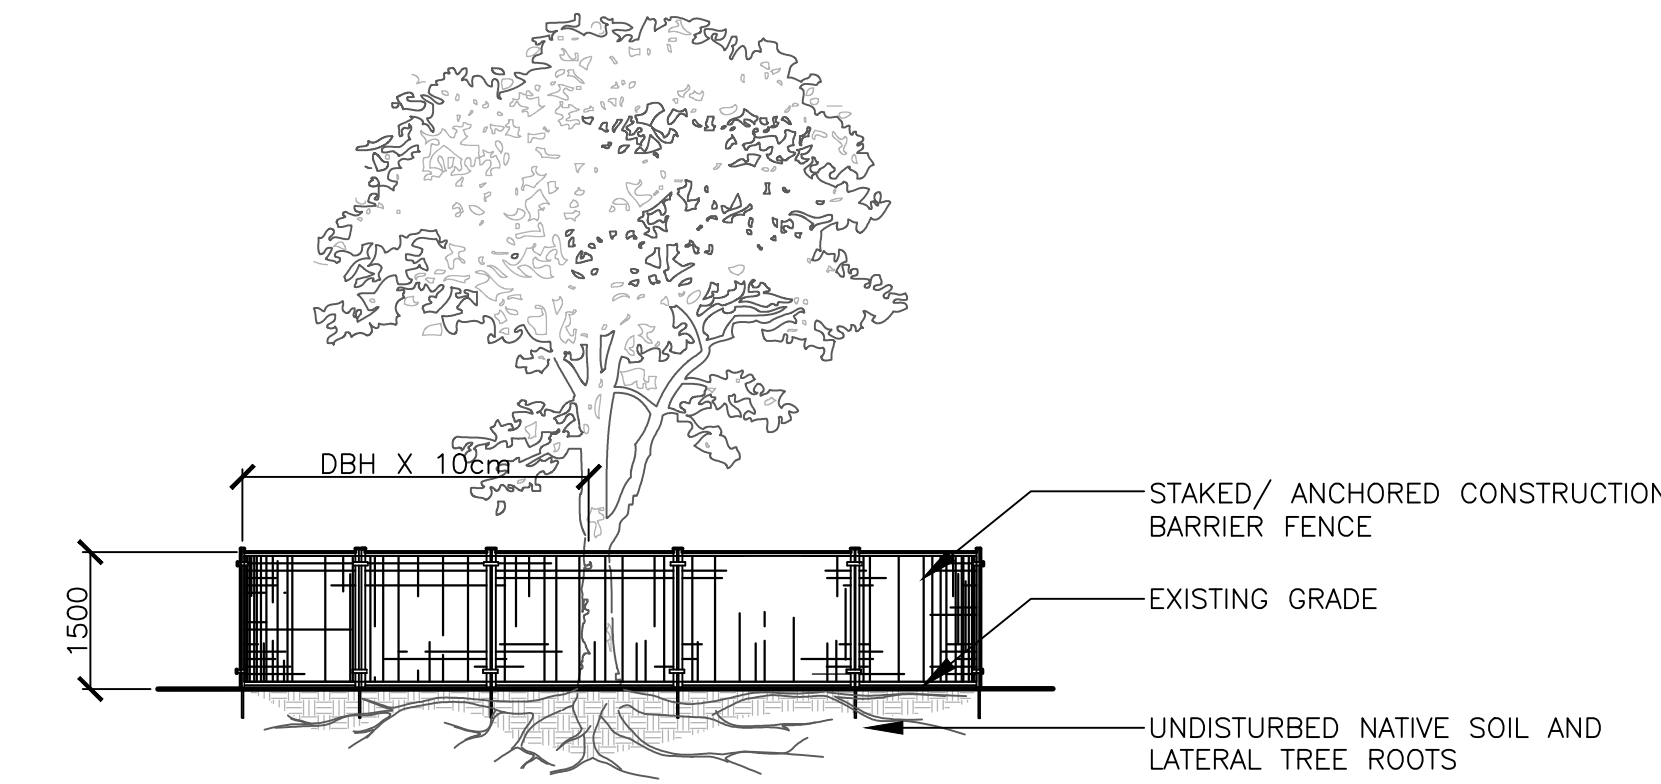

- NOTES:
- THE FOLLOWING PROTECTION MEASURES MUST BE IMPLEMENTED FOR RETAINED TREES, BOTH ON SITE AND ADJACENT SITES, PRIOR TO ANY TREE REMOVAL OR SITE WORKS AND MAINTAINED FOR THE DURATION OF CONSTRUCTION ON SITE.
1. UNDER THE GUIDANCE OF AN ARBORIST, ERECT A FENCE AT THE CRITICAL ROOT ZONE (CRZ) OF TREES WHERE THE CRZ IS ESTABLISHED AS BEING 10 CENTIMETERS FROM THE TRUNK FOR EVERY CENTIMETER OF TRUNK DIAMETER AT BREAST HEIGHT. THE CRZ IS CALCULATED AS DBH X 10cm.
 2. DO NOT PLACE ANY MATERIAL OR EQUIPMENT WITHIN THE CRZ OF THE TREE
 3. DO NOT ATTACH ANY SIGNS, NOTICES OR POSTERS TO ANY TREE
 4. DO NOT RAISE OR LOWER THE GRADE WITHIN THE CRZ WITHOUT APPROVAL
 5. TUNNEL OR BORE WHEN DIGGING WITHIN THE CRZ OF A TREE
 6. DO NOT DAMAGE THE ROOT SYSTEM, TRUNK, OR BRANCHES OR ANY TREE
 7. ENSURE THAT EXHAUST FUMES FROM ALL EQUIPMENT ARE NOT DIRECTED TOWARDS ANY TREE CANOPY

5 TREE PROTECTION FENCING Scale: 1:20

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