78 ROSEMOUNT AVE.

78 Rosemount Avenue, Ottawa, ON K1Y 1P6

ISSUED FOR BUILDING PERMIT: --/--/--

DRAWING LIST

ARCHITECTURAL

COVER PAGE AND LOCATION PLAN

GENERAL NOTES AND LEGEND

CODE MATRIX

ASSEMBLIES - FOUNDATION AND EXTERIOR

ASSEMBLIES - FLOOR AND ROOF

ASSEMBLIES - PARTITIONS

SITE PLAN

ACCESSORY BUILDING DETAILS

FOUNDATION PLAN

BASEMENT REFERENCE PLAN

FIRST FLOOR REFERENCE PLAN

SECOND FLOOR REFERENCE PLAN

THIRD FLOOR REFERENCE PLAN

ROOF PLAN

EXTERIOR ELEVATIONS

BUILDING SECTIONS

A410 WALL SECTIONS

EXIT STAIR 1 DETAILS

EXIT STAIR 2 DETAILS

STAIR DETAILS

BASEMENT REFLECTED CEILING PLAN

FIRST FLOOR REFLECTED CEILING PLAN

SECOND FLOOR REFLECTED CEILING PLAN

THIRD FLOOR REFLECTED CEILING PLAN

WASHROOM DETAILS

DOOR SCHEDULE - COMMON AREAS

A701 DOOR SCHEDULE - SUITES

A710 WINDOW SCHEDULE

<u>CIVIL</u>

C101 REMOVALS, SITE SERVICING, LOT GRADING, DRAINAGE, SEDIMENT AND EROSION CONTROL PLAN

STRUCTURAL

S00 COVER SHEET

S01 GENERAL NOTES

S02 TYPICAL DETAILS

S03 SCHEDULES

S04 SCHEDULES

S100 FOUNDATION PLAN

S101 BASEMENT PLAN

S102 FIRST FLOOR PLAN

S103 SECOND FLOOR PLAN S104 THIRD FLOOR PLAN

S105 ROOF PLAN

S300 SECTIONS

S301 SECTIONS

S302 SECTIONS

S303 SECTIONS

S304 SECTIONS

MECHANICAL

M101 MECHANICAL LEGEND, SCHEDULES, DETAILS AND ABBREVIATIONS

M201 BASEMENT FLOOR PLAN - DRAINAGE

M202 FIRST FLOOR PLAN - DRAINAGE M203 SECOND FLOOR PLAN - DRAINAGE

M204 THIRD FLOOR PLAN - DRAINAGE

M301 BASEMENT FLOOR PLAN - PLUMBING AND FIRE PROTECTION

M302 FIRST FLOOR PLAN - PLUMBING AND FIRE PROTECTION

M303 SECOND FLOOR PLAN - PLUMBING AND FIRE PROTECTION

M304 THIRD FLOOR PLAN - PLUMBING AND FIRE PROTECTION

M401 BASEMENT FLOOR PLAN - AIR DISTRIBUTION M402 FIRST FLOOR PLAN - AIR DISTRIBUTION

M403 SECOND FLOOR PLAN - AIR DISTRIBUTION

M404 THIRD FLOOR PLAN - AIR DISTRIBUTION

ELECTRICAL

E101 ELECTRICAL LEGEND, SCHEDULES, DETAILS AND ABBREVIATIONS

E201 BASEMENT FLOOR PLAN - ELECTRICAL

E202 FIRST FLOOR PLAN - ELECTRICAL

E203 SECOND FLOOR PLAN - ELECTRICAL





1 3D PERSPECTIVE



CSV ARCHITECTS

613.564.8118 Ottawa, Ontario,K2P 2R3 www.csv.ca

STRUCTURAL ENGINEER Cunliffe & Associates 200, 1550 Carling Ave 2nd Floor Ottawa, ON K1Z 8S8 613-729-7242 cunliffe@cunliffe.ca

MECHANICAL/ELECTRICAL ENGINEER Chorley + Bisset 250 City Centre Ave. Ottawa, ON K1R 1C7 613-241-0300 email@chorley.com

CIVIL ENGINEER McIntosh Perry 115 Walgreen Road, R.R. Carp, ON K0A 1L0 613-836-2184 www.mcintoshperry.com

STAMP

5 --/-- ISSUED FOR BUILDING PERMIT REV DATE ISSUE

1. OWNERSHIP OF THE COPYRIGHT OF THE DESIGN AND THE WORKS EXECUTED FROM THE DESIGN REMAINS WITH CSV ARCHITECTS, AND MAY NOT BE REPRODUCED IN ANY FORM WITHOUT THE WRITTEN CONSENT OF CSV ARCHITECTS.

2. THE DRAWINGS, PRESENTATIONS AND SPECIFICATIONS AS INSTRUMENTS OF SERVICE ARE AND SHALL REMAIN THE PROPERTY OF CSV ARCHITECTS. THEY ARE NOT TO BE USED BY THE CLIENT ON OTHER PROJECTS OR ON EXTENSIONS TO THIS PROJECT WITHOUT THE WRITTEN CONSENT OF CSV ARCHITECTS. 3. THIS DRAWING IS TO BE READ IN CONJUNCTION

WITH ALL OTHER PROJECT DRAWINGS AND SPECIFICATIONS. 4. DO NOT SCALE DRAWINGS. CONTRACTOR SHALL BE RESPONSIBLE TO VERIFY DIMENSIONS ON SITE. 5. ALL WORK SHALL BE IN ACCORDANCE WITH THE

ONTARIO BUILDING CODE AND ALL SUPPLEMENTS AND APPLICABLE MUNICIPAL REGULATIONS.

CLIENT

78 ROSEMOUNT AVE INC. OTTAWA

ONTARIO, CANADA

PROJECT

TITLE

REV

78 ROSEMOUNT AVE.

78 Rosemount Avenue, Ottawa, ON K1Y 1P6

COVER PAGE AND LOCATION PLAN

PROJECT NO: 2021-1320 DRAWN: APPROVED:

DATE PRINTED: 5/18/2022 11:08:33 AM

		T	
	ABBREVIATIONS:	GRAPHICS	LEGEND:
1 HR ACT ADDL ADJ AF AFF ALUM ALTB	ONE HOUR FIRE RATING ACOUSTIC CEILING TILE ADDITIONAL ADJUSTABLE ACCESS FLOORING ABOVE FINISHED FLOOR ALUMINUM ALUMINUM THERMALLY BROKEN	A.101	SHEET NUMBER — SHEET NO. SEQUENCE — SHEET TYPE — SHEET DISCIPLINE
ANO A/VB BL-AN BF BD BLDG BLKG BRK	ANODIZED AIR/VAPOUR BARRIER BLACK ANODIZED BARRIER FREE BOARD BUILDING BLOCKING BRICK		GRAPHIC SCALE M VIEW TITLE DRAWING NUMBER
BR CAB CG CLG CLR CL	BIKE RACK CABINET CORNER GUARD CEILING CLEAR CLEAR CLEAR STAIN	View Name A100 View Scale	—SHEET NUMBER
COL CONT CONTR CONSTR CPT CT	COLUMN CONTINUOUS CONTRACTOR CONSTRUCTION CARPET TILE CERAMIC TILE		NORTH ARROW
D DIA DIM DR	COMPLETE WITH DEPTH DIAMETER DIMENSION DOOR	AA Elevation	— GRID HEAD — GRID LINE
DWG ELEC EP EPF	DRAWING ELECTRICAL ELECTRICAL PANEL EPOXY FLOORING	Name	— REVISION TAG
EPTRZ EQPT EX FD FHC	EPOXY TERRAZZO EQUIPMENT EXISTING FLOOR DRAIN FIRE HOSE CABINET	00 A101	BUILDING SECTION TAG DRAWING NUMBER SHEET NUMBER
FIN FL GA GC	FINISH FLOOR GAUGE GENERAL CONTRACTOR	00 SIM A101	WALL SECTION TAG — DRAWING NUMBER — SHEET NUMBER
GL GWB HT HM HDW	GLASS GYPSUM BOARD HEIGHT HOLLOW METAL HARDWARE	00 SIM A101	DETAIL SECTION TAG DRAWING NUMBER SHEET NUMBER
IGU IMH INSTL ITF	HARDWOOD INSULATED GLAZING UNIT INSULATED HOLLOW METAL INSTALLATION INFORMATION TO FOLLOW	00 SIM A800	CALL OUT TAG — DRAWING NUMBER — SHEET NUMBER — CALL OUT AREA
LAV LVT MAX MDF	LAVATORY LUXURY VINYL TILE MAXIMUM MEDIUM DENSITY FIBERBOARD	0 A101 0◀	ELEVATION TAG —SHEET NUMBER —DRAWING NUMBER
MECH MEG MIN MISC	MECHANICAL MANUFACTURER MINIMUM MISCELLANEOUS	RISE 12	ROOF SLOPE
(N) N NIC NON COMB NR NTS	NEW NORTH NOT IN CONTRACT NON-COMBUSTIBLE NON-RATED NOT TO SCALE	2% 	SPOT SLOPE ROOM TAG ROOM NUMBER
OBC O/C OPNG ORG OS	ONTARIO BUILDING CODE ON CENTRE OPENING ORGANIC OCCUPANCY SENSOR	(W1000) 1000W x 1000H ◀ SILL:1000 ▼	WINDOW TAG WINDOW NUMBER WINDOW DIMENSIONS SILL HEIGHT AFF
PLAM PREFAB PSF PSTB PT	PLASTIC LAMINATE PREFABRICATION PRESSED STEEL FRAME PRESSED STEEL THERMALLY BROKEN PAINT	D1000 1000 x 1000 ₩2C.5	DOOR TAG DOOR NUMBER DOOR DIMENSIONS WALL TAG
QT QTY	QUARRY TILE QUANTITY	W100	CURTAIN WALL/ INTERIOR GLAZING TAG
(R) RB RD REC REF	RELOCATE RESILIENT/RUBBER BASE ROOF DRAIN RECESSED REFERENCE	#	KEY NOTE
REQD RO RS REV	REQUIRED ROUGH OPENING ROOF SCUPPER REVISION	#)	KEY NOTE
SIM SCWD SH SP SS	SIMILAR SOLID CORE WOOD SHEIF SPANDREL PANEL STAINLESS STEEL	<u>\$</u>	BUILDING ENTRANCE DATUM TARGET
SSURF STC STD STRUCT	SOLID SURFACE SOUND TRANSMISSION CLASSIFICATION STANDARD STRUCTURAL/STRUCTURE	1 / A101 ———————————————————————————————————	MATCHLINE REFERENCE 45MIN FRR
T TBD TBS THR T/O	THERMOSTAT TO BE DETERMINED TO BE SELECTED THRESHOLD TOP OF		60MIN FRR 90MIN FRR
UNO U/S	UNLESS NOTED OTHERWISE UNDERSIDE		
VB VCT VERT VIF VSF VWC	VAPOUR BARRIER VINYL COMPOSITION TILE VERTICAL VERIFY IN FIELD VINYL SHEET FLOORING VINYL WALL COVERING		
W	WIDTH	l	

WITHOUT

WOOD FLOORING WOOD VENEER

WOOD

WITH

W/O

WD

WF

GENERAL CONSTRUCTION NOTES:

- 1. THESE NOTES APPLY TO ENTIRE WORK.
- 2. DIMENSIONS ARE IN MILLIMETERS UNLESS OTHERWISE NOTED.
- 3. DIMENSIONS ON PLANS ARE TO CENTRE OF WALL STUDS, CONCRETE, CMU OR TO THE &OF STRUCTURAL GRIDS, UNLESS OTHERWISE NOTED.
- 4. ALL WOOD IN CONTACT WITH CONCRETE SHALL BE PRESSURE TREATED AND HAVE A SILL GASKET. THIS SHALL INCLUDE PLATES AND PLYWOOD SHEATHING. ALL WOOD BLOCKING USED AT OR BELOW GRADE IS TO BE PRESSURE TREATED.
- 5. PROVIDE GYPSUM BOARD CONTROL JOINTS AT MAX. 9100mm. COORDINATE EXACT LOCATION
- ON SITE WITH ARCHITECT PRIOR TO INSTALLATION.
- 6. ALL COLOURS (FLASHINGS, TRIMS, COMPOSITE MATERIALS) TO BE CHOSEN BY ARCHITECT FROM MANUFACTURER'S COMPLETE SELECTION.
- 7. PROVIDE BONDED WATERPROOFING MEMBRANE 150mm MINIMUM UP WALL AND FULL HEIGHT OF SHOWER WALLS. SHOWERS TO HAVE COLLAPSIBLE UPRIGHT LIP SPLASHGUARD AT THE ENTRANCE OF ALL SHOWERS.

GENERAL EXTERIOR WALL ASSEMBLY NOTES:

- 1. PROVIDE 16mm PLYWOOD BACKING BEHIND GYPSUM BOARD AT ALL BATHROOM FIXTURES, GRAB BARS,
- SHOWER, BATHTUBS, AND WALL MOUNTED DOOR STOPS. 2. LAP, TAPE AND SEAL ALL MEMBRANES TO PROVIDE CONTINUOUS AIR AND WEATHER TIGHT SEAL.
- 3. COORDINATE WALL ASSEMBLIES WITH STRUCTURAL SHEAR WALLS LOCATION. SHEAR WALL OSB TO BE LOCATED ON SUITE SIDE AND SPAN ENTIRE WALL LENGTH.

GENERAL ROOF ASSEMBLY NOTES:

- 1. ALL PARAPET FRAMING AND SHEATHING TO BE PRESSURE TREATED.
- 2. PROVIDE 16mm PRESSURE TREATED PLYWOOD BACKING AS REQUIRED TO SUIT
- EQUIPMENT REFER ALSO TO MECHANICAL AND ELECTRICAL DRAWINGS AND SCHEDULES. 3. COORDINATE MECHANICAL UNIT CURBS WITH SLOPED INSULATION.

GENERAL INTERIOR PARTITION WALL ASSEMBLY NOTES:

- 1. CONSTRUCT ALL ASSEMBLIES IN ACCORDANCE WITH THE REQUIREMENTS OF THE LABELING AGENCY, I.E. WH, UL,
- ULC ETC. WHEN IN DOUBT, SEEK DIRECTION FROM THE PROJECT ARCHITECT OR ACOUSTIC ENGINEER. 2. ALL E-BOXES (AND SIMILAR I.E. PHONE, CABLE, ETC.) LOCATED IN ACOUSTICALLY RATED ASSEMBLIES SHALL BE THE PLASTIC, THERMALLY RATED TYPE WITH FACE FLANGE AND GASKET. WHEN IN DOUBT, SEEK DIRECTION FROM THE PROJECT ARCHITECT OR ACOUSTIC ENGINEER.
- 3. RESILIENT CHANNELS ARE ONLY TO BE INSTALLED WHERE INDICATED ON THE DRAWINGS. THEY ARE NOT TO BE INSTALLED BEHIND GWB THAT BACKS UP HEAVY FIXTURES, OTHER FRAMING, OR OTHER FEATURE THAT WOULD
- PRECLUDE THEIR PROPER FUNCTION. CONSULT ARCHITECT IN CASE OF CONFLICT. 4. RESILIENT CHANNELS WHEN SPECIFIED FOR ONE SIDE OF A WALL ASSEMBLY SHALL BE INSTALLED ON THE SIDE WITH THE LEAST INTERRUPTIONS FOR SERVICES AND INTERIOR PARTITIONS. RESILIENT CHANNELS ON CEILINGS MUST ALL BE ORIENTATED THE SAME DIRECTION. ALL FASTENERS USED TO ATTACH THE GWB TO THE RESILIENT CHANNELS MUST BE SELECTED TO BE SHORT ENOUGH SO AS PRECLUDE PENETRATION INTO THE UNDERLYING FRAMING, OR ALTERNATELY OFFSET FROM FRAMING MEMBERS. UNDER NO CIRCUMSTANCES SHALL GWB FASTENERS BRIDGE THE GAP BETWEEN THE GWB AND THE FRAMING UNDERNEATH.
- 5. ALL GWB IN ACOUSTICALLY RATED CONSTRUCTION SHALL BE TYPE X OR TYPE C AS APPLICABLE. FULL SHEETS OF BOARD SHALL BE USED WHEREVER POSSIBLE, AND SMALLER PIECES SHALL BE AVOIDED EXCEPT WHERE NECESSARY DUE TO SPACE LIMITATIONS. ALL BOARDS SHALL BE CONTINUOUS PAST INTERIOR PARTITIONS (BOTH
- LAYERS WHERE APPLICABLE). 6. FILL VOIDS WITH GLASS FIBER INSULATION AROUND ALL PLUMBING PIPING WITHIN WALL CAVITIES. PROVIDE MINIMUM 25mm CLEARANCE ENSURE NO DIRECT CONTACT WITH FRAMING AND PLUMBING PIPING. PROVIDE 25mm
- GLASS FIBER INSULATION TO ALL HORIZONTAL AND VERTICAL SANITARY VENT PIPING. 7. PROVIDE CONTINUOUS FIRESTOPPING AND SMOKE SEALANT AT TOP AND BOTTOM OF ALL FIRE RATED WALLS /
- FLOORS WITH ULC LISTED SYSTEMS OR OBC APPROVED MATERIAL. 8. ALL FIRE RATED AND ACOUSTIC SEPARATIONS ARE TO EXTEND FROM THE TOP OF FLOOR TO THE UNDERSIDE OF THE FLOOR SHEATHING AND / OR ROOF SHEATHING ABOVE.
- 9. ALL OPENINGS THROUGH FIRE RATED ASSEMBLIES ARE TO BE FIRE STOPPED AND SEALED TO MAINTAIN THE INTEGRITY OF THE FIRE SEPARATION AND PROVIDE A SMOKE TIGHT BARRIER.
- 10. WHEN FASTENING MATERIALS TO STC RATED WALLS. ENSURE FASTENERS DO NOT PENETRATE THROUGH RESILIENT CHANNELS INTO UNDERLYING FRAMING.
- 11. OFFSET LIGHT SWITCHES AND OUTLETS AT LEAST 400mm HORIZONTALLY ON OPPOSITE SIDES OF DEMISING WALLS
- BETWEEN SUITES. 12. PLACE SOUND INSULATION BEHIND ELECTRICAL OUTLETS.
- 13. DO NOT PLACE ELECTRICAL PANELS, ON SUITE DEMISING SUITES OR CORRIDOR WALLS. 14. ALL NON LOAD-BEARING INTERIOR PARTITIONS TO TERMINATE AT UNDERSIDE OF FIRE RATED FLOOR ASSEMBLIES. COORDINATE WITH FIRE RATED CEILING ASSEMBLY DETAILS AND REQUIRED CLEARANCES FOR ACOUSTIC

ISOLATORS (+/- 41mm). PROVIDE BLOCKING WITHIN FLOOR ASSEMBLY TO SUIT WALL LOCATIONS AND FASTENING

- REQUIREMENTS. 15. FILL VOIDS WITH ACOUSTICAL INSULATION AROUND ALL PLUMBING PIPING WITHIN WALL CAVITIES.
- 16. REFER TO FLOOR PLANS FOR VERIFICATION OF REQUIRED FIRE RATED PARTITION LOCATIONS. 17. ALL FIRE RATED PARTITIONS TO TERMINATE AT UNDERSIDE OF FLOOR / ROOF SHEATHING ABOVE C/W FIRE RATED
- SEALANT
- 18. ADD 16mm PAINTED PLYWOOD UP TO 2440mm AFF IN MECHANICAL AND ELECTRICAL ROOMS. 19. PROVIDE NON-COMBUSTIBLE FIRE STOP AROUND ALL PIPES.
- 20. ALL WASHROOM, MECHANICAL AND LAUNDRY ROOM WALLS TO HAVE ACOUSTIC BATT INSULATION. 21. PROVIDE CONTINUOUS 16mm PLYWOOD BACKING BEHIND GYPSUM BOARD AT BATHTUBS AND WATER CLOSETS AT
- ALL WASHROOMS FOR FUTURE GRAB BARS. COORDINATE WITH FIXTURE LOCATIONS.
- 22. PROVIDE MINIMUM 25mm CLEARANCE TO ENSURE NO DIRECT CONTACT BETWEEN FRAMING AND PLUMBING. 23. USE MOISTURE RESISTANT GYPSUM BOARD AND MOISTURE & MILDEW RESISTANT PAINT IN ALL WASHROOMS, JANITOR ROOM, KITCHEN BACKSPLASH AND LAUNDRY ROOM UNLESS OTHERWISE INDICATED. WHERE FIRE RATED SEPARATION ARE REQUIRED, ADD 16mm MOISTURE RESISTANT GYPSUM BOARD OVER TOP OF FIRE RATED GYPSUM
- BOARD, COORDINATE WALL THICKNESS ACCORDINGLY. 24. USE WATER RESISTANT GYPSUM BOARD TILE BACKER BOARD AT ALL SHOWER WALLS. SEE SPECS
- 25. PROVIDE CONTINUOUS FIRE STOPPING AND FIRE BLOCKING AS REQUIRED TO PREVENT FIRE FROM TRAVELING. 26. PROVIDE 16mm PLYWOOD BACKING BEHIND GYPSUM BOARD AT ALL BATHROOM FIXTURES, GRAB BARS, SHOWER,
- BATHTUBS, AND WALL MOUNTED DOOR STOPS, COORDINATE WITH BARRIER-FREE DETAIL ON SHEET A004. 27. COORDINATE WALL ASSEMBLIES WITH STRUCTURAL SHEAR WALL LOCATIONS. SHEAR WALL OSB TO BE LOCATED ON SUITE SIDE. PROVIDE CONTINUOUS THICKNESS.
 - 28. REFER TO STRUCTURAL DRAWINGS FOR SHEAR WALL REQUIREMENTS INCLUDING BLOCKING, HARDWARE, NAILING PATTERNS, ETC.

GENERAL CEILING ASSEMBLY NOTES:

- 1. PROVIDE BACKING / FRAMING AS REQUIRED WITHIN FLOOR SYSTEM TO SUIT NON LOAD-BEARING WALLS
- DETAILS. 2. PROVIDE 16mm PLYWOOD BACKING AS REQUIRED TO SUIT CEILING MOUNTED EQUIPMENT - REFER ALSO TO
- MECHANICAL AND ELECTRICAL DRAWINGS AND SCHEDULES.
- 3. ALL PENETRATIONS IN FIRE RATED ASSEMBLIES TO BE C/W FIRE RATED / ULC APPROVED SEALANT 4. PROVIDE SEISMIC RESTRAINS AS REQUIRED FOR SUSPENDED CEILINGS.

ACCESS HATCHES - WALLS AND CEILINGS

- 1. PROVIDE SELF-CLOSING FIRE RATED INSULATED ACCESS HATCHES WITH CONCEALED HINGES IN FIRE RATED
- WALL / CEILING ASSEMBLIES. COORDINATE LOCATIONS WITH MECHANICAL DWGS. 2. PROVIDE 200 X 200mm FLUSH ACCESS HATCHES WITH CONCEALED HINGES AT ALL PLUMBING CLEANOUTS /
- SHUT OFF VALVES SEE MECHANICAL FOR CLEANOUT / SHUT OFF VALVE LOCATIONS.
- 3. REFER TO MANUFACTURER FOR FRAMING / BLOCKING REQUIREMENTS.

CSV ARCHITECTS

sustainable design · conception écologique

613.564.8118 190 O'Connor Street, Suite 100 Ottawa, Ontario, K2P 2R3 www.csv.ca

STRUCTURAL ENGINEER Cunliffe & Associates 200, 1550 Carling Ave 2nd Floor Ottawa, ON K1Z 8S8 613-729-7242 cunliffe@cunliffe.ca

MECHANICAL/ELECTRICAL ENGINEER Chorley + Bisset 250 City Centre Ave. Ottawa, ON K1R 1C7 613-241-0300 email@chorley.com

CIVIL ENGINEER McIntosh Perry 115 Walgreen Road, R.R. 3 Carp, ON K0A 1L0 613-836-2184 www.mcintoshperry.com

STAMP

5 --/--/-- ISSUED FOR BUILDING PERMIT REV DATE

NOTES

1. OWNERSHIP OF THE COPYRIGHT OF THE DESIGN AND THE WORKS EXECUTED FROM THE DESIGN REMAINS WITH CSV ARCHITECTS, AND MAY NOT BE REPRODUCED IN ANY FORM WITHOUT THE WRITTEN CONSENT OF CSV ARCHITECTS. 2. THE DRAWINGS, PRESENTATIONS AND SPECIFICATIONS AS INSTRUMENTS OF SERVICE ARE AND SHALL REMAIN THE PROPERTY OF CSV ARCHITECTS. THEY ARE NOT TO BE USED BY THE CLIENT ON OTHER PROJECTS OR ON EXTENSIONS TO THIS PROJECT WITHOUT THE WRITTEN CONSENT OF CSV ARCHITECTS. 3. THIS DRAWING IS TO BE READ IN CONJUNCTION

WITH ALL OTHER PROJECT DRAWINGS AND SPECIFICATIONS. 4. DO NOT SCALE DRAWINGS. CONTRACTOR SHALL BE RESPONSIBLE TO VERIFY DIMENSIONS ON SITE. 5. ALL WORK SHALL BE IN ACCORDANCE WITH THE ONTARIO BUILDING CODE AND ALL SUPPLEMENTS

AND APPLICABLE MUNICIPAL REGULATIONS. CLIENT

78 ROSEMOUNT AVE

INC. **OTTAWA** ONTARIO, CANADA

PROJECT

78 ROSEMOUNT AVE.

78 Rosemount Avenue, Ottawa, ON K1Y 1P6

TITLE **GENERAL NOTES AND LEGEND**

PROJECT NO: 2021-1320 DRAWN: JW APPROVED: JS 1:100

DATE PRINTED: 5/18/2022 11:08:34 AM REV DRAWING NO.

_		Ontario Building Code Data Matrix Part 9 Housing and Small Buildings	Building Code Reference
9.00	Building Code Version	O. Reg. 332/12 Last Amendment O. Reg. 191/14	
9.01	Project Type	New	[A] 1.1.2.
9.02	Major Occupancy	Description: Occupancy Use	9.10.2.
9.02	Classification	Group C Residential - Low Rise Apartment Building	9.10.2.
		Tresidential - Low Hise Apartment Building	
9.03	Superimposed Major Occupancies	No Yes N/A Description:	9.10.2.3.
9.04	Building Area (m²)	Description: Existing: New: Total: Main Building 0 m² 263 m² 263 m² 0 m² 0 m² 0 m²	[A] 1.4.1.2.
9.05	Gross Area (m²)	Total: 0 m ² 263 m ² 263 m ² Description: Existing: New: Total:	[A] 1.4.1.2.
		First Floor 0 m² 263 m² 263 m² Second Floor 0 m² 263 m² 263 m²	
		Third Floor 0 m² 263 m² 263 m²	
		$\begin{array}{cccccccccccccccccccccccccccccccccccc$	
9.06	Mezzanine Area	Description: Existing: New: Total:	9.10.4.1.
	(m²)	$\begin{array}{c ccccccccccccccccccccccccccccccccccc$	
		Total: 0 m ² 0 m ² 0 m ²	
9.07	Building Height	3 Storeys Above Grade11 (m) Above Grade1 Storeys Below Grade	[A] 1.4.1.2. & 9.10.4.
9.08	Number of Streets/ Firefighter Access	Street(s)	9.10.20.
9.09	Sprinkler System	Required Not Required	9.10.8.2.
		Proposed: Entire Building Selected Compartments Basement In Lieu of Roof Rating None	
9.10	Fire Alarm System	X Required Not Required Proposed: X Single Stage Not Applicable Two Stage	9.10.18.
9.11	Water Service/ Supply is Adequate	□ No ☒ Yes	
9.12	Construction Type	Restriction: X Combustible Permitted Non-combustible Required Actual: X Combustible Non-combustible Combination Heavy Timber Construction: X No Yes	9.10.6.
9.13	Post-Disaster Building	X No Yes	[A] 1.1.2.2.(2)
9.14	Occupant Load	Floor Level/Area Occupancy Based On Occupant Load Type (Persons)	3.1.17.
		Basement Residential Occupancy 10	
		First Floor Residential Occupancy 10 Second Floor Residential Occupancy 12 Third Floor Residential Occupancy 12	
9.15	Barrier-Free Design:	Yes Explanation 1-12 Suites, 1 Barrier Free Unit Provided No	9.5.2.
9.16	Hazardous Substances:	Yes Explanation	9.10.1.3.
9.17	Required Fire Resistance Ratings	Horizontal Assembly Rating (H) Supporting Noncombustible Assembly (H) in lieu of rating?	9.10.8.
		Floors over Basement 0.75 0.75 X No Yes N/A	
		Floors	
		Roof N/A N/A N/A N/A N/A	
9.18	Spatial Separation	Wall EBF Area L.D. Required Construction Type Cladding Type (m²) (m) FRR (H) Required Required	9.10.14., 9.10.15.
		North 190* 1.5 1 X Non-combustible X Non-combustible	
		East 165 8 0.75 Non-combustible Non-combustible South 190* 1.5 1 X Non-combustible X Non-combustible	
		West 165 8.78 0.75 Non-combustible Non-combustible * LARGEST INDIVIDUAL FIRE COMPARTMENT EBF = 19.6 m ²	
6	D	insert additional walls as required	0.01 - 1
9.19	Plumbing Fixture Requirements	Ratio: N/A Floor Level/Area Occupant OBC Reference Fixtures Fixtures Load Provided	9.31. & 3.7.4.
		Basement 10 9.31.4.1. 3 3 First Floor 10 9.31.4.1. 3 3	
		Second Floor 12 9.31.4.1. 3 3	
		<u>Third Floor</u> 12 9.31.4.1. 3 3	

9.20	Energy Efficiency	Category:				
		Non-Residential Compliance Option:	SB-10 Prescriptive (Div.4) SB-10 Performance (Div.2) SB-10 Prescriptive (Div.2)	2)		
		Residential Compliance Option:	X SB-12 Prescriptive Compl SB-12 Performance Comp SB-12 Other: Energy Star EnerGuide for New House	oliance for New Homes		
		Climatic Zone:	Project Design Conditi	ons:		
		Fenestration	Gross Above Grade Wall or <u>Roof Area</u> (m²)	Gross Fenestration <u>Area (m²)</u>	Fenestration <u>Ratio</u>	
		Vertical (W+D)	706	128	18%	
		Skylights	N/A	N/A		
		Space Heating Fuel		Oil Solid Fuel	X ElectricityEarth Energy	
		Heating Equipment Efficiency	≥90% AFUE	≥78%	% - <u>≥</u> 90% AFUE	
		Other Conditions	ICF Basement Walk-out Basement Log/Post & Beam	Slab	Above Grade -on-Ground rn-in Insulation re Grade Wall	
			Spar Applied Foam Insulat Above Grade Wall	tion Draii Unit	n Water Heat Recovery Provided	
		Compliance Package	C1			
9.21	Notes					

CSV ARCHITECTS

sustainable design · conception écologique

190 O'Connor Street, Suite 100 613.564.8118 www.csv.ca Ottawa, Ontario,K2P 2R3

STRUCTURAL ENGINEER Cunliffe & Associates 200, 1550 Carling Ave 2nd Floor Ottawa, ON K1Z 8S8 613-729-7242 cunliffe@cunliffe.ca

MECHANICAL/ELECTRICAL ENGINEER Chorley + Bisset 250 City Centre Ave. Ottawa, ON K1R 1C7 613-241-0300 email@chorley.com

CIVIL ENGINEER McIntosh Perry 115 Walgreen Road, R.R. 3 Carp, ON K0A 1L0 613-836-2184 www.mcintoshperry.com

STAMP

5 --/-- ISSUED FOR BUILDING PERMIT

NOTES

REV DATE ISSUE

1. OWNERSHIP OF THE COPYRIGHT OF THE DESIGN AND THE WORKS EXECUTED FROM THE DESIGN REMAINS WITH CSV ARCHITECTS, AND MAY NOT BE REPRODUCED IN ANY FORM WITHOUT THE WRITTEN CONSENT OF CSV ARCHITECTS.

2. THE DRAWINGS, PRESENTATIONS AND SPECIFICATIONS AS INSTRUMENTS OF SERVICE ARE AND SHALL REMAIN THE PROPERTY OF CSV ARCHITECTS. THEY ARE NOT TO BE USED BY THE CLIENT ON OTHER PROJECTS OR ON EXTENSIONS TO THIS PROJECT WITHOUT THE WRITTEN CONSENT OF CSV ARCHITECTS.

3. THIS DRAWING IS TO BE READ IN CONJUNCTION WITH ALL OTHER PROJECT DRAWINGS AND SPECIFICATIONS.

4. DO NOT SCALE DRAWINGS. CONTRACTOR SHALL BE RESPONSIBLE TO VERIFY DIMENSIONS ON SITE.

5. ALL WORK SHALL BE IN ACCORDANCE WITH THE ONTARIO BUILDING CODE AND ALL SUPPLEMENTS AND APPLICABLE MUNICIPAL REGULATIONS.

CLIENT

78 ROSEMOUNT AVE INC.

OTTAWA ONTARIO, CANADA

PROJECT

TITLE


78 ROSEMOUNT AVE.

78 Rosemount Avenue, Ottawa, ON K1Y 1P6

CODE MATRIX

PROJECT NO: 2021-1320 DRAWN: JW APPROVED: JS

DATE PRINTED: 5/18/2022 11:08:36 AM REV DRAWING NO.

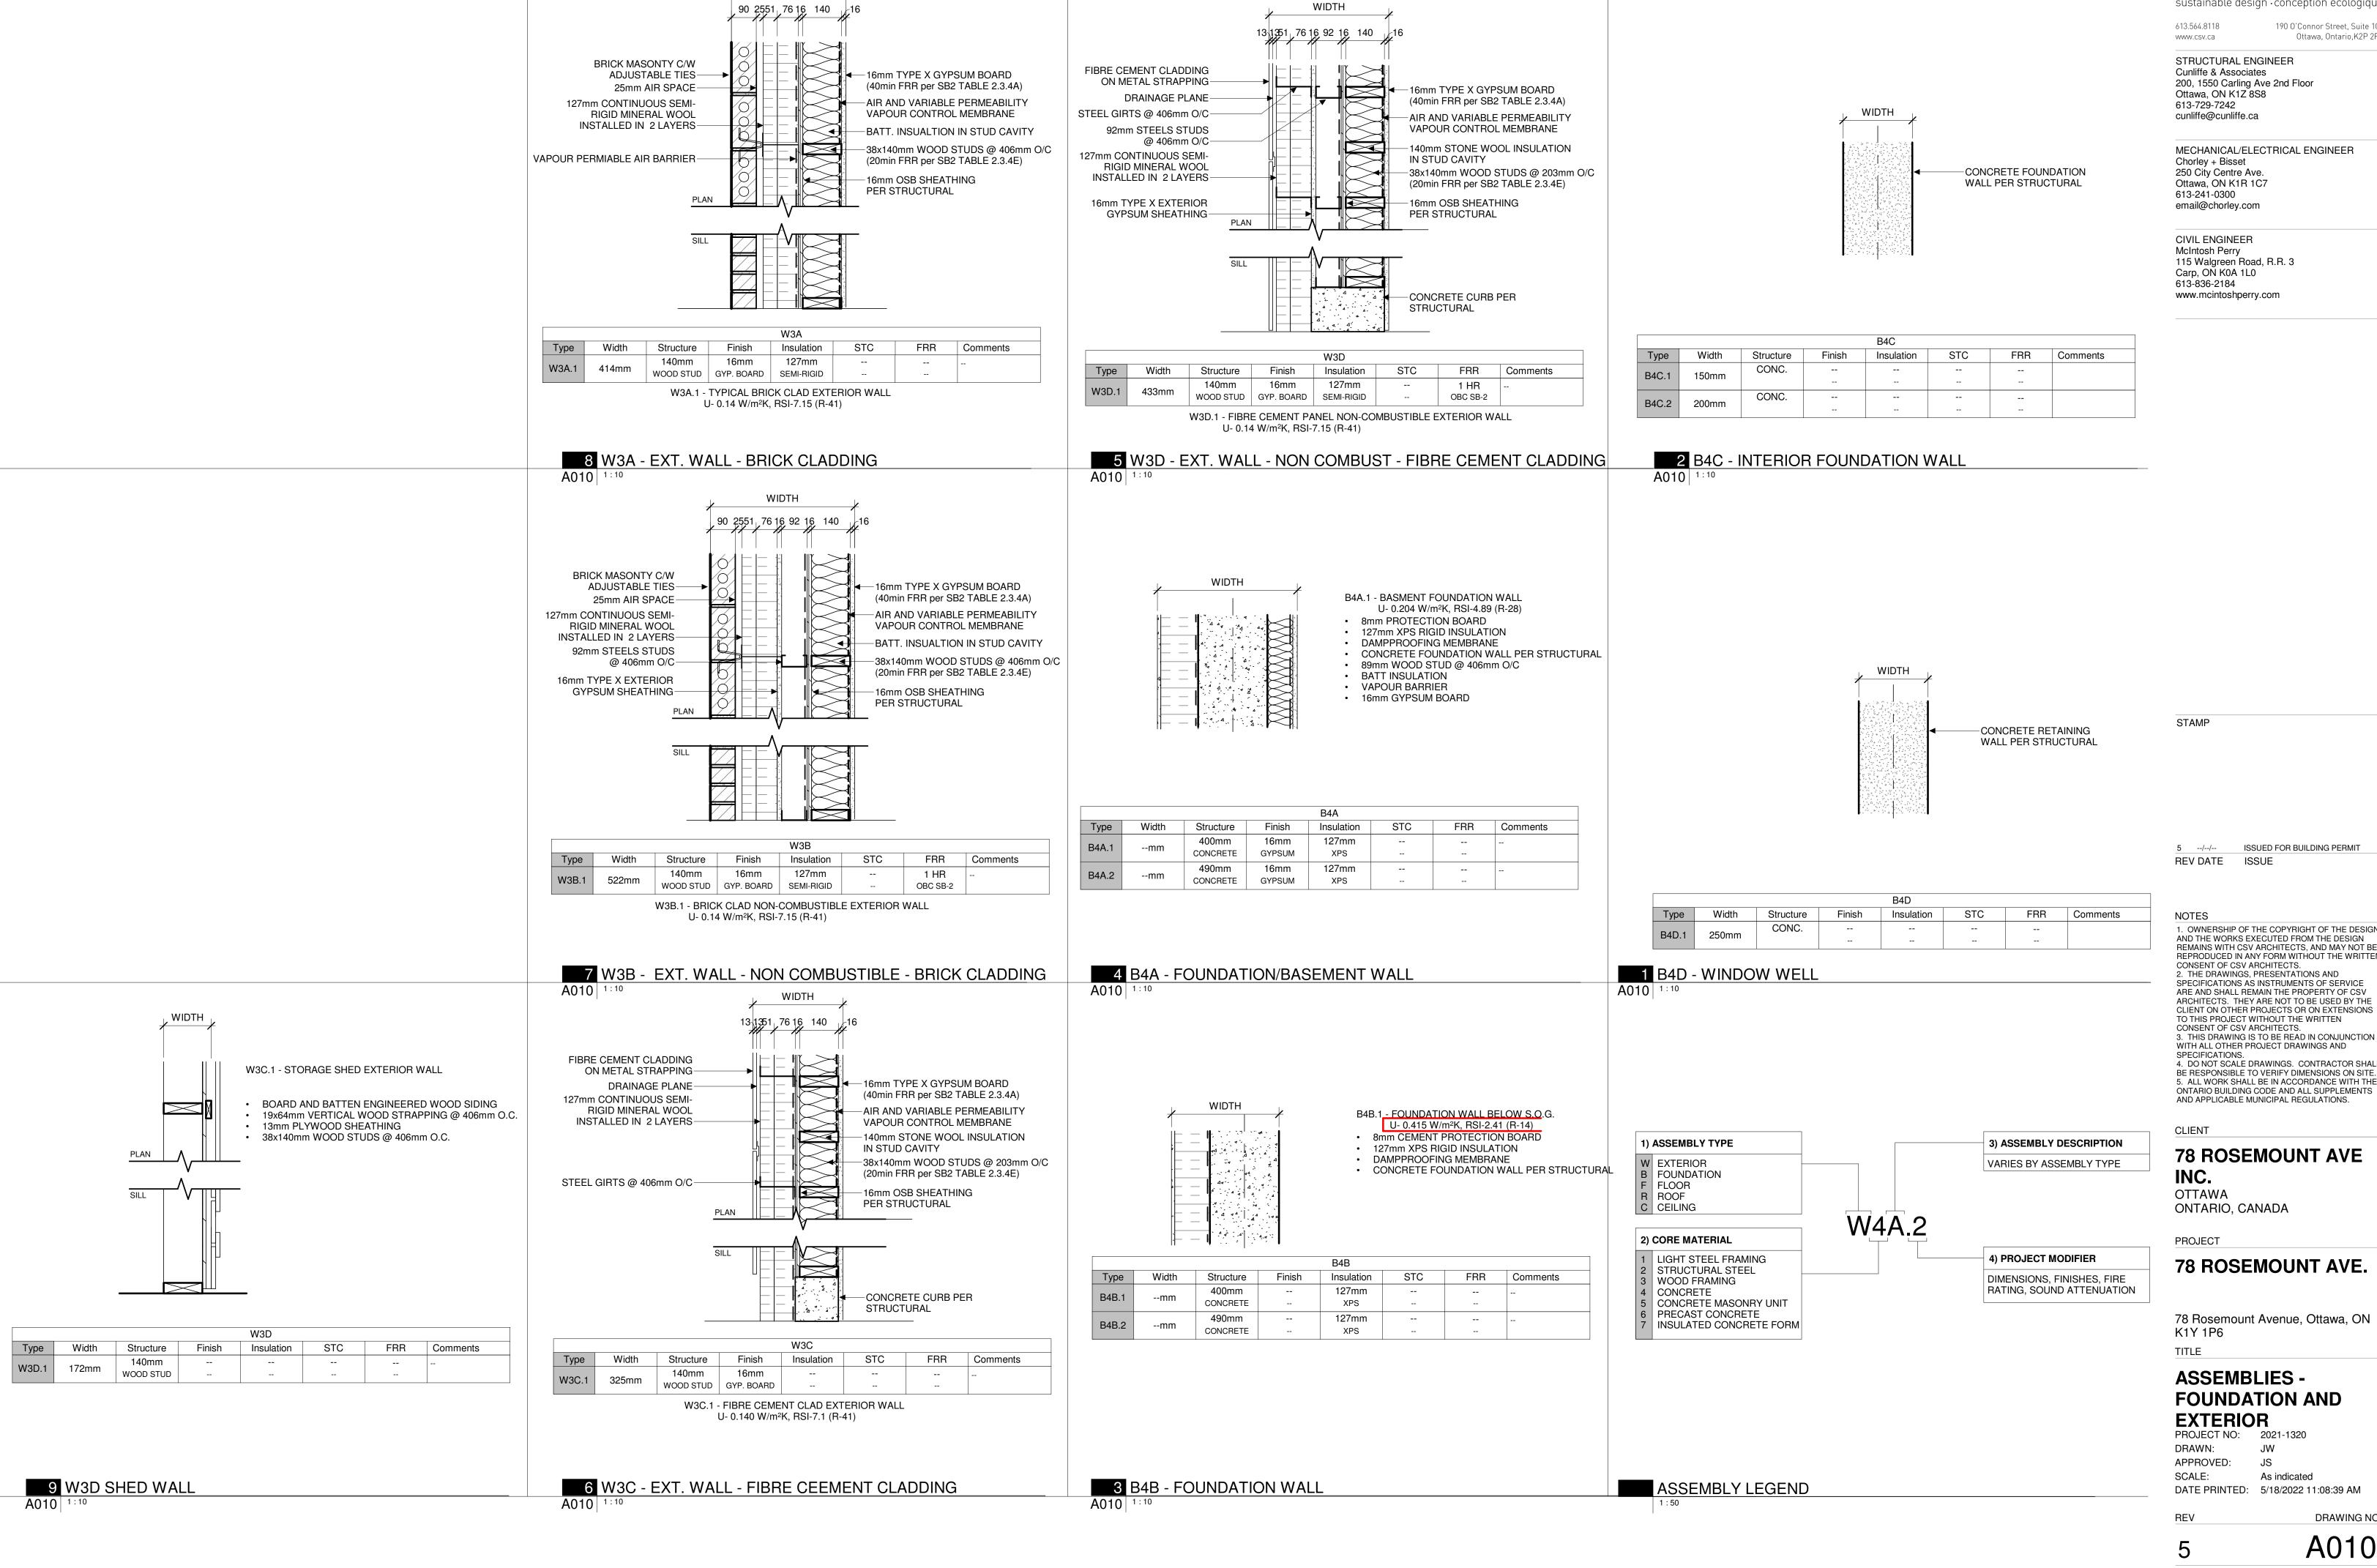

WIDTH

CSV ARCHITECTS

sustainable design · conception écologique

613.564.8118 190 O'Connor Street, Suite 100 Ottawa, Ontario,K2P 2R3 www.csv.ca

STRUCTURAL ENGINEER Cunliffe & Associates 200, 1550 Carling Ave 2nd Floor Ottawa, ON K1Z 8S8 613-729-7242 cunliffe@cunliffe.ca

MECHANICAL/ELECTRICAL ENGINEER Chorley + Bisset 250 City Centre Ave. Ottawa, ON K1R 1C7 613-241-0300

CIVIL ENGINEER McIntosh Perry 115 Walgreen Road, R.R. 3 Carp, ON K0A 1L0 613-836-2184

--/-- ISSUED FOR BUILDING PERMIT ISSUE

1. OWNERSHIP OF THE COPYRIGHT OF THE DESIGN AND THE WORKS EXECUTED FROM THE DESIGN REMAINS WITH CSV ARCHITECTS, AND MAY NOT BE REPRODUCED IN ANY FORM WITHOUT THE WRITTEN CONSENT OF CSV ARCHITECTS. 2. THE DRAWINGS, PRESENTATIONS AND SPECIFICATIONS AS INSTRUMENTS OF SERVICE ARE AND SHALL REMAIN THE PROPERTY OF CSV ARCHITECTS. THEY ARE NOT TO BE USED BY THE CLIENT ON OTHER PROJECTS OR ON EXTENSIONS TO THIS PROJECT WITHOUT THE WRITTEN CONSENT OF CSV ARCHITECTS. 3. THIS DRAWING IS TO BE READ IN CONJUNCTION WITH ALL OTHER PROJECT DRAWINGS AND SPECIFICATIONS. 4. DO NOT SCALE DRAWINGS. CONTRACTOR SHALL BE RESPONSIBLE TO VERIFY DIMENSIONS ON SITE. 5. ALL WORK SHALL BE IN ACCORDANCE WITH THE

78 ROSEMOUNT AVE

OTTAWA ONTARIO, CANADA

PROJECT

78 ROSEMOUNT AVE.


78 Rosemount Avenue, Ottawa, ON


ASSEMBLIES -FOUNDATION AND EXTERIOR

PROJECT NO: 2021-1320 DRAWN: JW APPROVED: JS As indicated

A010

DRAWING NO.

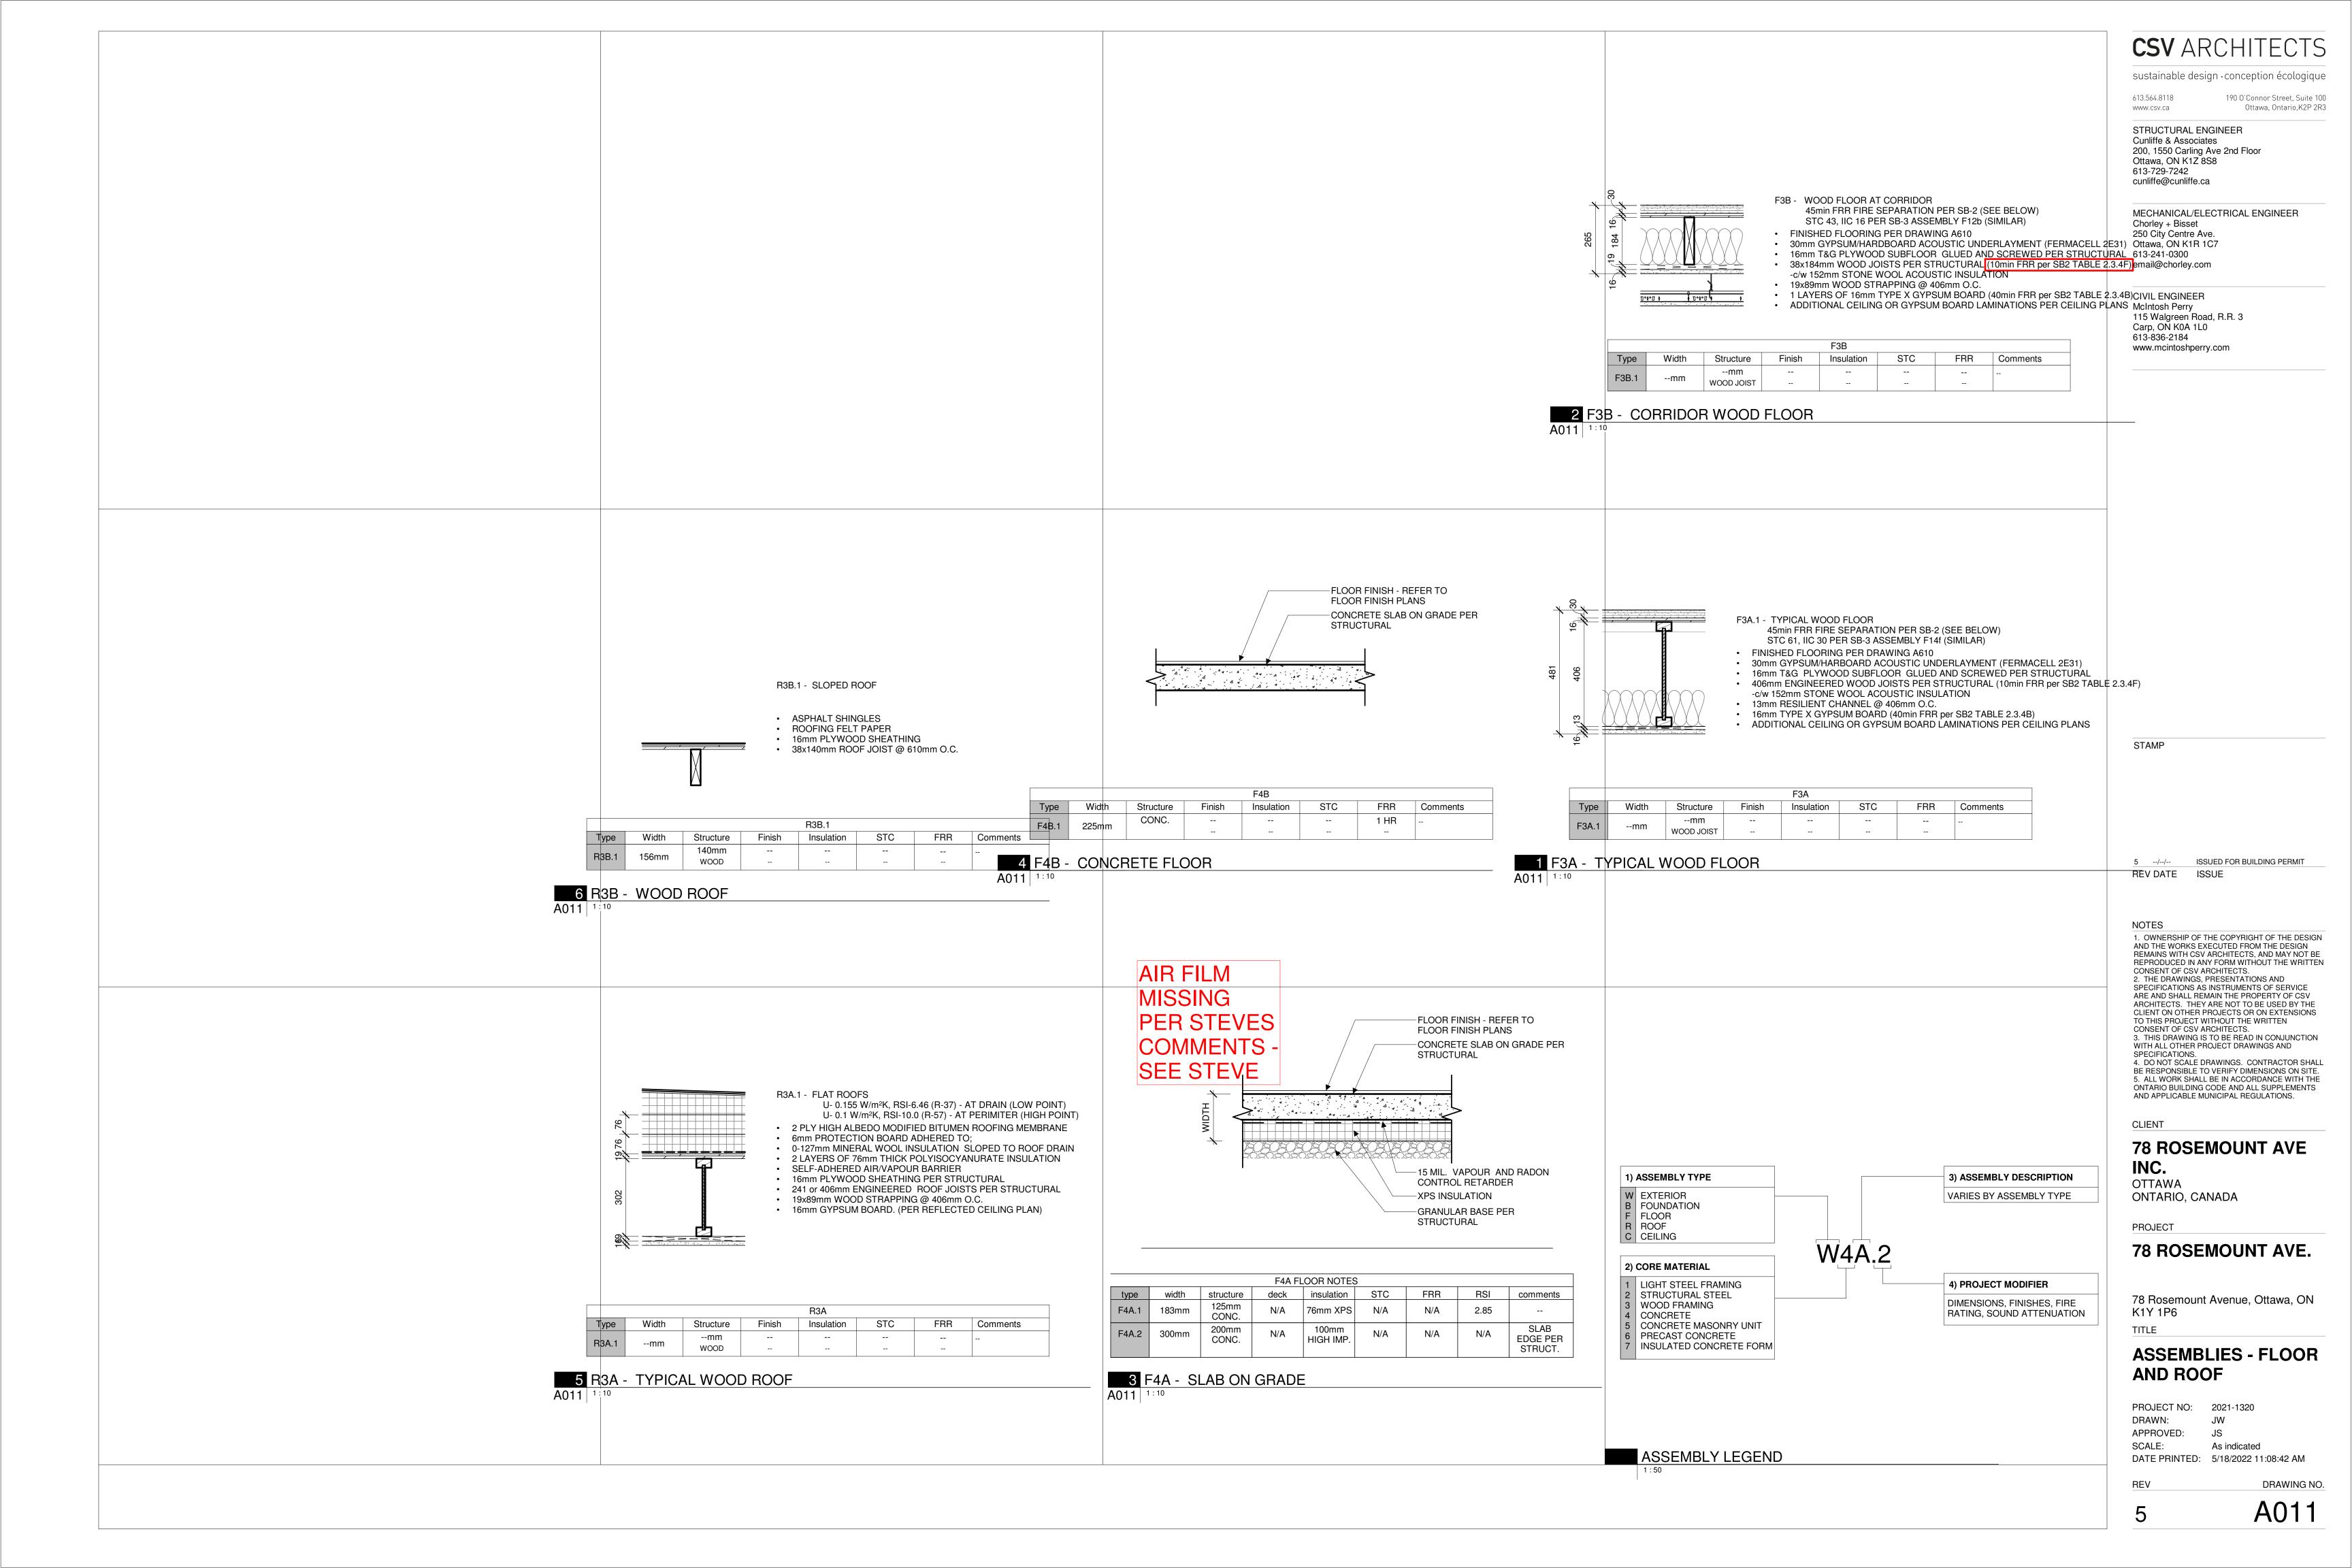

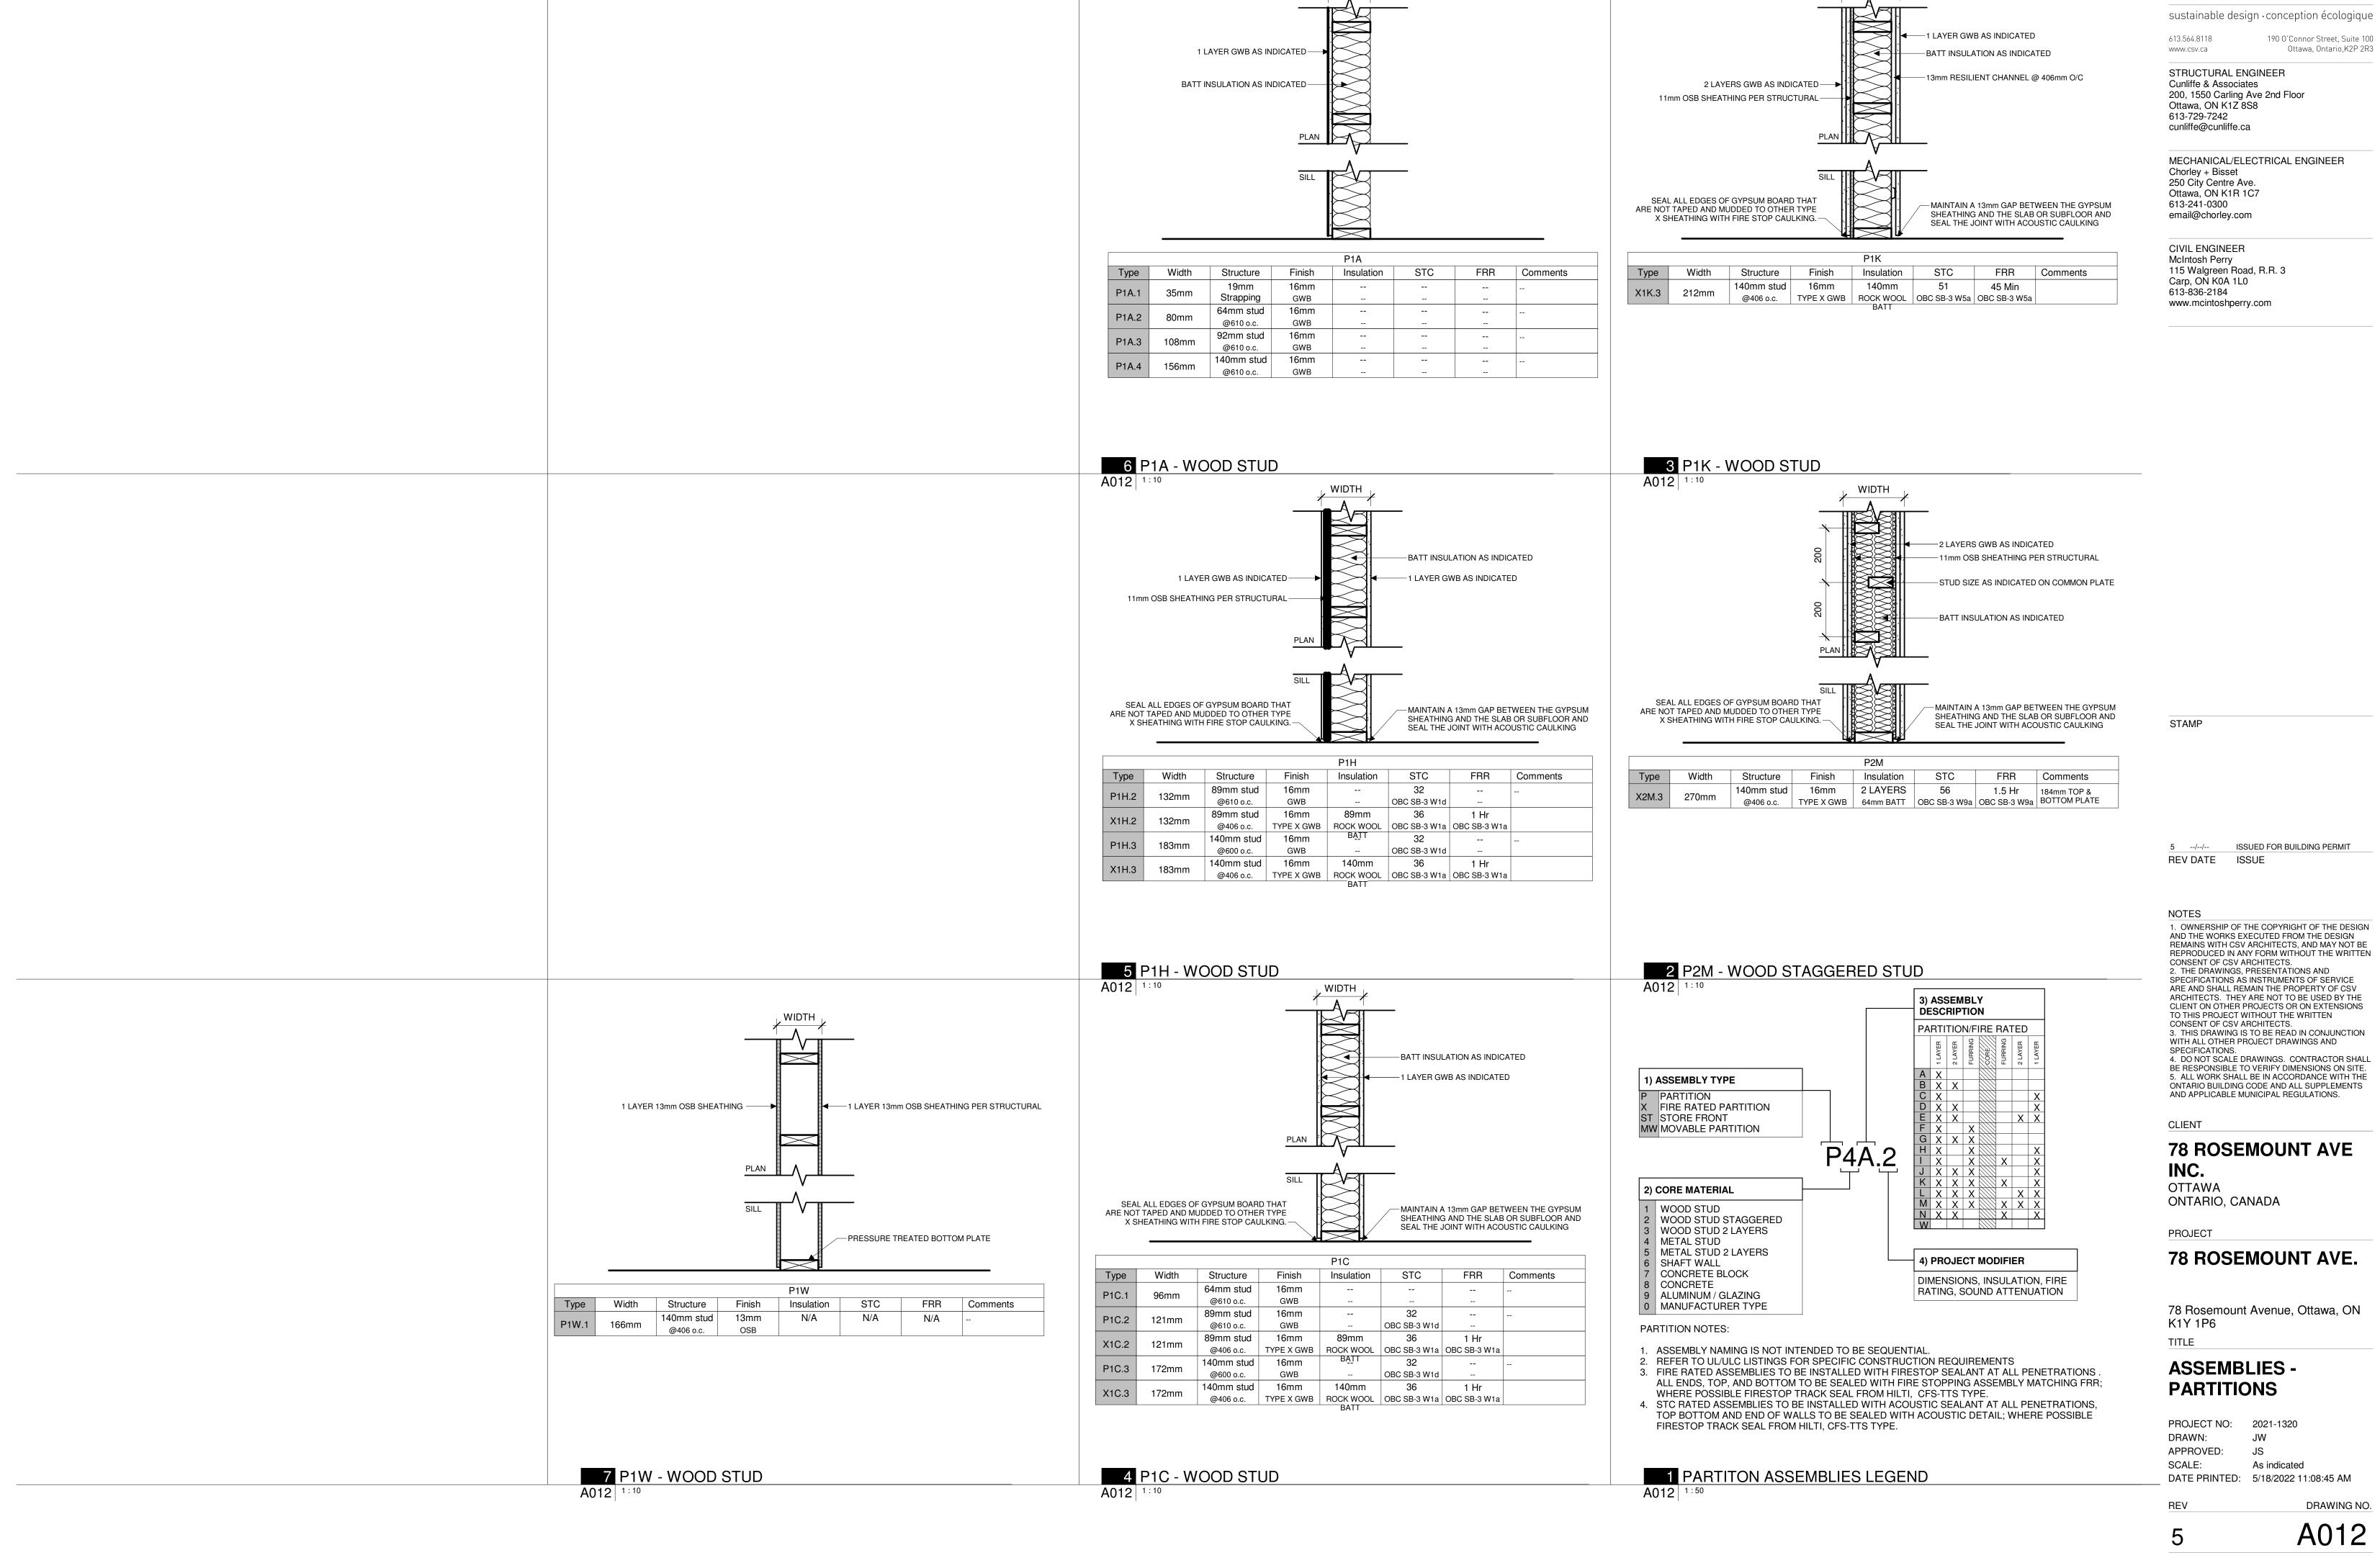


CSV ARCHITECTS

190 O'Connor Street, Suite 100

1. OWNERSHIP OF THE COPYRIGHT OF THE DESIGN AND THE WORKS EXECUTED FROM THE DESIGN REMAINS WITH CSV ARCHITECTS, AND MAY NOT BE REPRODUCED IN ANY FORM WITHOUT THE WRITTEN SPECIFICATIONS AS INSTRUMENTS OF SERVICE ARE AND SHALL REMAIN THE PROPERTY OF CSV ARCHITECTS. THEY ARE NOT TO BE USED BY THE CLIENT ON OTHER PROJECTS OR ON EXTENSIONS 3. THIS DRAWING IS TO BE READ IN CONJUNCTION

78 ROSEMOUNT AVE

78 Rosemount Avenue, Ottawa, ON

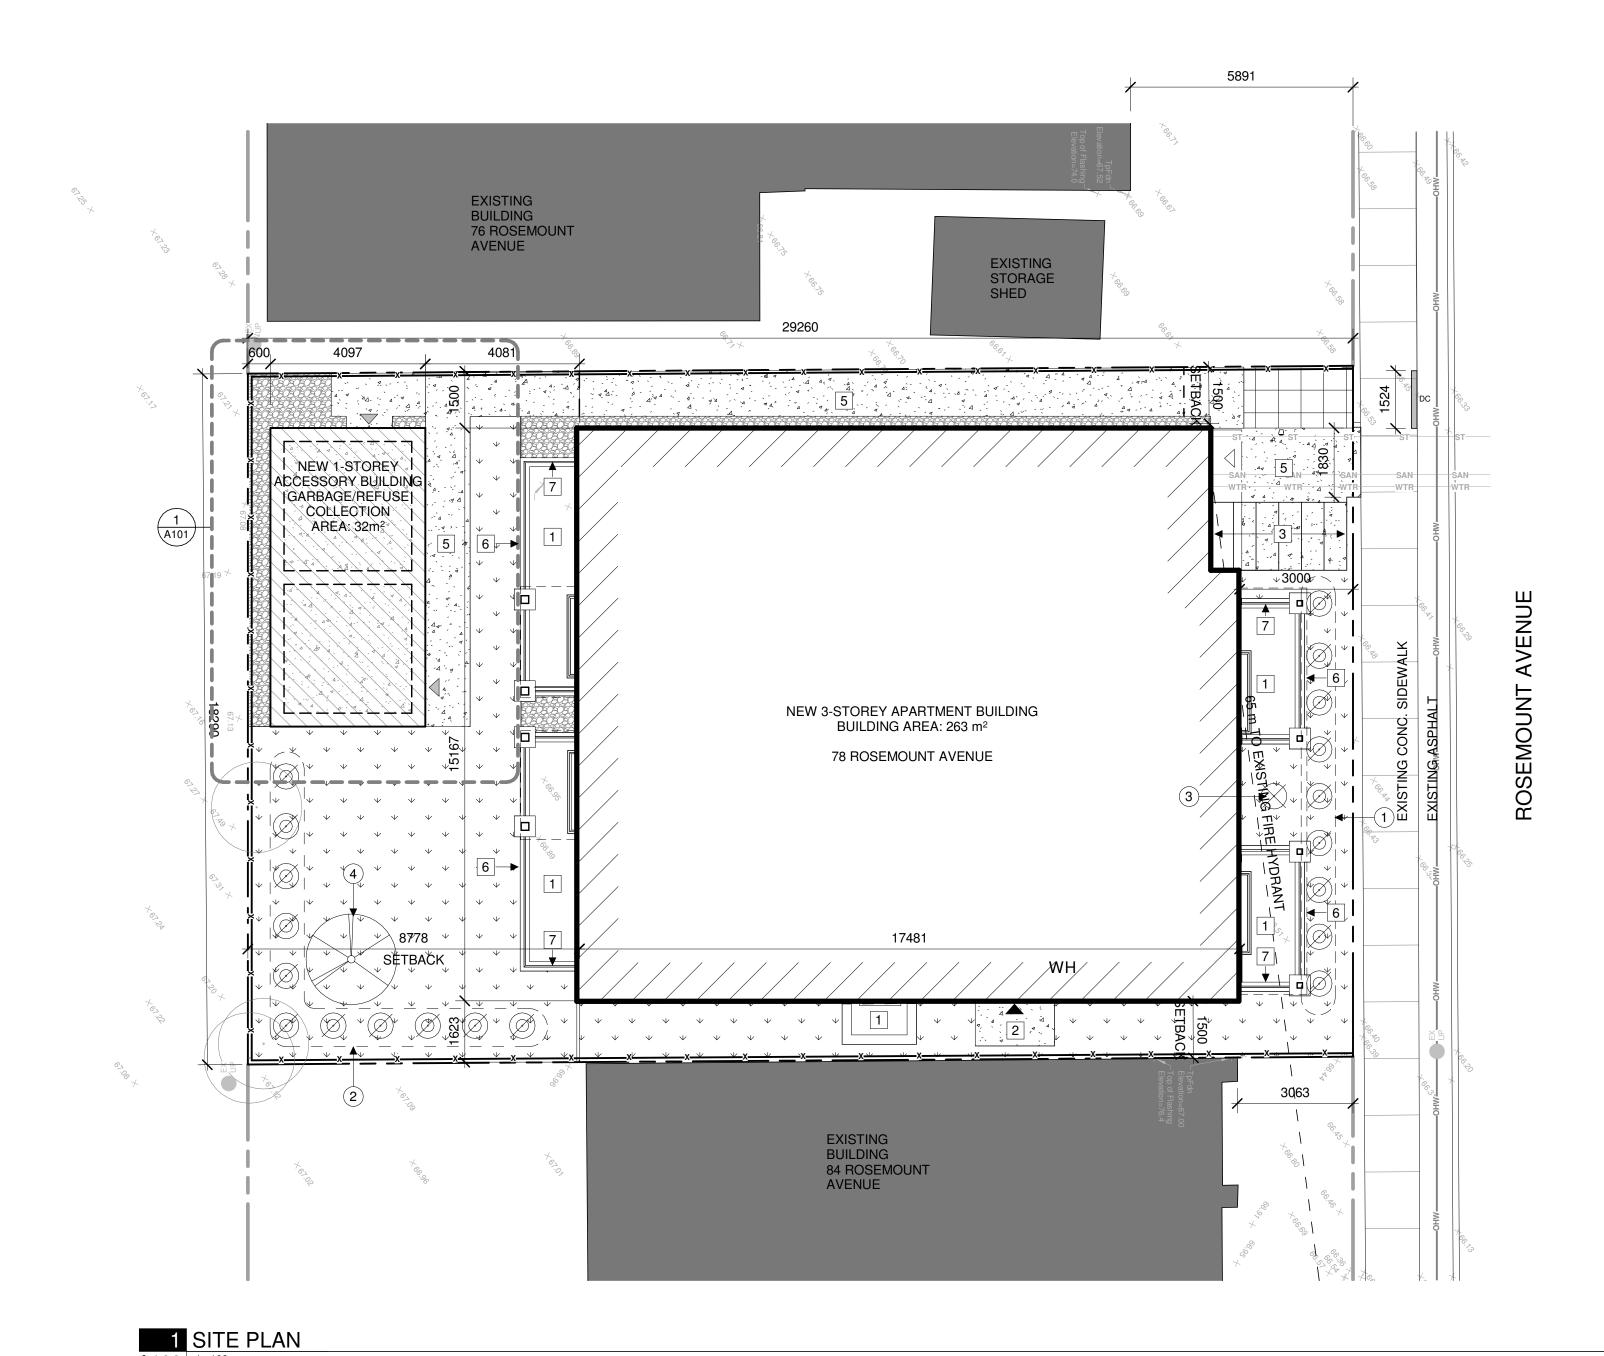

PLANT LIST KEYNOTES:

- 1) PENNISETUM ALOPEWROIDES 'HAMLEN' (DWARF FOUNTAIN GRASS)
- CALAMAGRSTIS ACUTIFLORA 'KARL FOERSTER' (FEATHER REED GRASS)
- PHYSOCARPUS OPULIFOLIUS (COMMON NINE BARK)
- QUERCUS RUBRA (RED OAK)

LEGAL DESCRIPTION: PART OF LOT 20	SITE AREA
REGISTERED PLAN 94 CITY OF OTTAWA	BUILDING AREA
CITY OF OTTAWA	GROSS FLOOR AREA
REFERENCE SURVEY: V-19040	BUILDING HEIGHT
MUNICIPAL ADDRESS: 78 ROSEMOUNT AVENUE	ZONE: R4UB
OTTAWA, ON K1Y 1P6	SCHEDULE 1: AREA

SCHEDULE 342: AREA A

535.14 m ²	<u>ZONI</u>
263 m ²	MIN.
784 m ²	MIN.
11 m 3 STOREYS	MIN.
3 31 UNE 13	MIN.
	MIN.
	MAX.
	LAND
	SOFT
	I

NING PROVISION	REQUIRED	PROVIDE
I. LOT WIDTH	15 m	18.29 m
I. LOT AREA	450 m²	535.14 m²
I. FRONT YARD SETBACK	4.477 m	3 m
I. REAR YARD SETBACK	8.778 m	8.778 m
I. INTERIOR YARD SETBACK	1.5 m	1.5 m
X. HEIGHT	11 m	11 m
NDSCAPED AREA	160.5 m² MIN. 30%	234 m²
FT SCAPED AREA:	WIIIN. 30 /6	
FRONT YARD - 40%	22 m ²	39 m²

80 m²

110 m²

REAR YARD - 50%

IDED	PARKING QUEING + LOADING	REQUIRED
m	RESIDENTIAL SPACES	None
4 m²	VISITOR SPACES	None
	ACCESSIBLE PARKING	None
m	BICYCLE PARKING	6
	REFUSE COLLECTION	

None None None 3 x 360L Blue Bin (7SQFT clrnce/bin) 3 x 360L Black Bin

PROVIDED

(7SQFT clrnce/bin) 2 x 240L Green Bin (5.4SQFT clrnce/bin) EXISTING TREE

SITE PLAN GENERAL NOTES:

2. DO NOT SCALE THIS DRAWING

CONSULTANT

CONSULTANT

EXCAVATION

EXCAVATION

TO DIGGING

SITE PLAN KEYNOTES:

CONCRETE PAD

5 CONCRETE PATHWAY

TO ELECTRICAL

SITE PLAN LEGEND:

СВ

∘⊖_{LS}

⊕ EX LS

--FH

 \bigotimes_{MH}

7 GATE

6 LINE OF BALCONY ABOVE

BICYCLE PARKING

REFUSE/RECYCLE BIN

FROM EXISTING PLANS AND SURVEYS

UNKNOWN SUBSURFACE CONDITIONS

1. ALL GENERAL SITE INFORMATION AND CONDITIONS COMPILED

3. REPORT ANY DISCREPANCIES PRIOR TO COMMENCING WORK.

SITE AND REPORT ANY ERRORS AND/OR OMISSIONS TO THE

5. REINSTATE ALL AREAS AND ITEMS DAMAGED AS A RESULT OF

6. CONTRACTOR TO LAYOUT PLANTING BEDS, PATHWAYS ETC.

TO APPROVAL OF CONSULTANT PRIOR TO ANY JOB

7. THE ACCURACY OF THE POSITION OF UTILITIES IS NOT

GUARANTEED - CONTRACTOR TO VERIFY PRIOR TO

9. ALL DISTURBED AREAS TO BE RESTORED TO ORIGINAL CONDITION OR BETTER UNLESS OTHERWISE NOTED

8. INDIVIDUAL UTILITY COMPANY MUST BE CONTACTED FOR

CONFIRMATION OF UTILITY EXISTENCE AND LOCATION PRIOR

1 CONCRETE WINDOW WELL C/W AREA DRAIN. FILL W/ LOOSE

DOOR OPERATOR PUSH BUTTON ON PEDESTAL - REFER

EXISTING BUILDING

CONCRETE PAD/PATH

NEW GRASS

PAVER TYPE 1

EMERGENCY EXIT

SERVICE DOORS

PROPERTY LINE

NEW SANITARY

(BELOW GRADE)

CATCH BASIN

CATCH BASIN

LIGHT STANDARD

FIRE HYDRANT

MANHOLE

UTILITY POLE

NEW STORM

GAS

BUILDING MAIN ENTRANCE

NEW DOMESTIC WATER

NEW ELECTRICAL SERVICE

EXISTING OVER HEAD WIRES

LIGHT STANDARD EXISTING

FIRE HYDRANT EXISTING

MANHOLE EXISTING

UTILITY POLE EXISTING

SIAMESE CONNECTION

DROPPED CURB

1800mm HIGH WOOD PRIVACY FENCE

EXISTING CONCRETE SIDEWALK

GRAVEL/RIVERSTONE/MAINTENANCE STRIP

CONSTRUCTION ACTIVITIES TO THE SATISFACTION OF THE

NO RESPONSIBILITY IS BORN BY THE CONSULTANT FOR

4. CONTRACTOR TO CHECK AND VERIFY ALL DIMENSIONS ON

DC

PROPOSED TREE

PROPOSED SHRUB

PROJECT NO: 2021-1320 DRAWN: JW APPROVED: JS SCALE: As indicated DATE PRINTED: 5/18/2022 11:08:49 AM

REV

PROPOSED FOUNTAIN GRASS

CSV ARCHITECTS

sustainable design · conception écologique 190 O'Connor Street, Suite 100 613.564.8118 Ottawa, Ontario,K2P 2R3

STRUCTURAL ENGINEER Cunliffe & Associates 200, 1550 Carling Ave 2nd Floor Ottawa, ON K1Z 8S8 613-729-7242 cunliffe@cunliffe.ca

www.csv.ca

MECHANICAL/ELECTRICAL ENGINEER Chorley + Bisset 250 City Centre Ave. Ottawa, ON K1R 1C7 613-241-0300

CIVIL ENGINEER McIntosh Perry 115 Walgreen Road, R.R. 3 Carp, ON K0A 1L0 613-836-2184 www.mcintoshperry.com

email@chorley.com

4 05/13/2022 ISSUED FOR SITE PLAN CONTROL 3 03/11/2022 ISSUED FOR COORDINATION 2 03/08/2022 ISSUED FOR COORDINATION 1 01/28/2022 ISSUED FOR COORDINATION

REV DATE ISSUE

1. OWNERSHIP OF THE COPYRIGHT OF THE DESIGN

STAMP

AND THE WORKS EXECUTED FROM THE DESIGN
AND THE WORKS EXECUTED FROM THE DESIGN
REMAINS WITH CSV ARCHITECTS, AND MAY NOT BE
REPRODUCED IN ANY FORM WITHOUT THE WRITTEN
CONSENT OF CSV ARCHITECTS.
2. THE DRAWINGS, PRESENTATIONS AND SPECIFICATIONS AS INSTRUMENTS OF SERVICE ARE AND SHALL REMAIN THE PROPERTY OF CSV ARCHITECTS. THEY ARE NOT TO BE USED BY THE CLIENT ON OTHER PROJECTS OR ON EXTENSIONS TO THIS PROJECT WITHOUT THE WRITTEN

CONSENT OF CSV ARCHITECTS. 3. THIS DRAWING IS TO BE READ IN CONJUNCTION WITH ALL OTHER PROJECT DRAWINGS AND SPECIFICATIONS. 4. DO NOT SCALE DRAWINGS. CONTRACTOR SHALL BE RESPONSIBLE TO VERIFY DIMENSIONS ON SITE. 5. ALL WORK SHALL BE IN ACCORDANCE WITH THE ONTARIO BUILDING CODE AND ALL SUPPLEMENTS
AND APPLICABLE MUNICIPAL REGULATIONS.

CLIENT

78 ROSEMOUNT AVE INC.

OTTAWA ONTARIO, CANADA

PROJECT

78 ROSEMOUNT AVE.


78 Rosemount Avenue, Ottawa, ON

TITLE

SITE PLAN

K1Y 1P6

DRAWING NO. A100

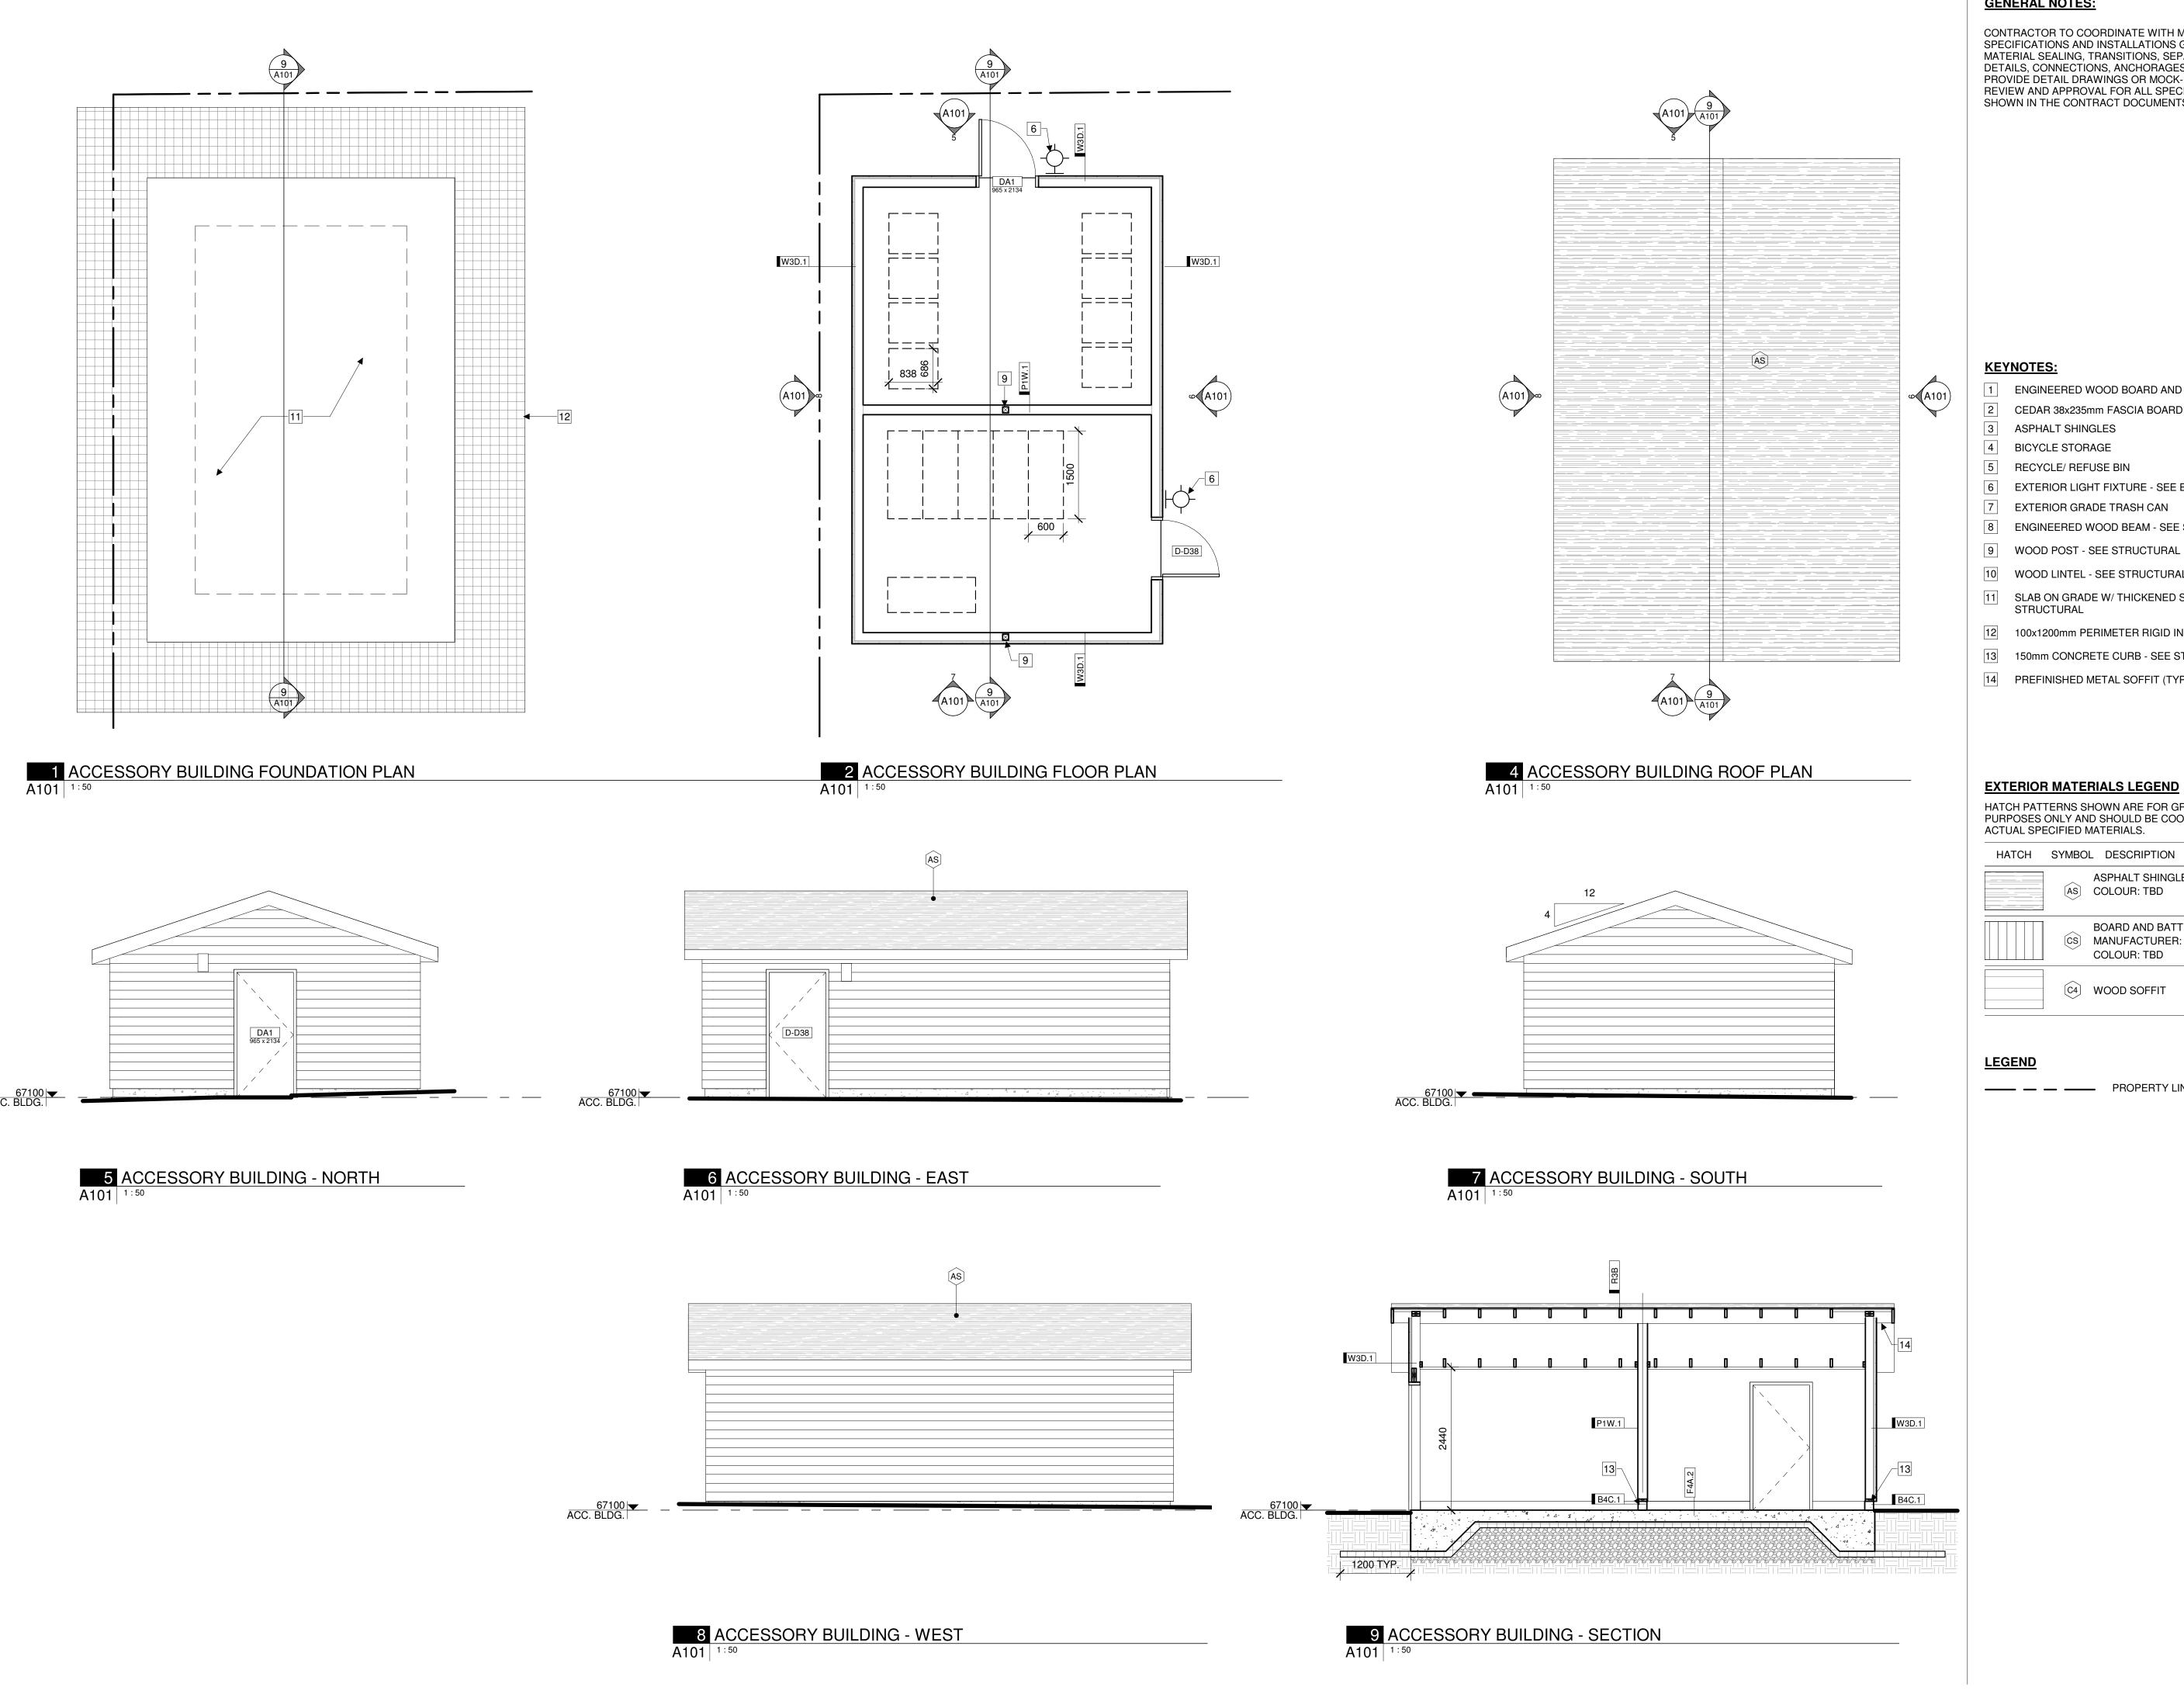

GENERAL NOTES:

CONTRACTOR TO COORDINATE WITH MANUFACTURER'S SPECIFICATIONS AND INSTALLATIONS GUIDELINES FOR ALL MATERIAL SEALING, TRANSITIONS, SEPARATIONS, FLASHING DETAILS, CONNECTIONS, ANCHORAGES, ETC. CONTRACTOR TO PROVIDE DETAIL DRAWINGS OR MOCK-UP FOR ARCHITECT'S REVIEW AND APPROVAL FOR ALL SPECIAL CONDITIONS NOT SHOWN IN THE CONTRACT DOCUMENTS.

CSV ARCHITECTS

sustainable design · conception écologique

613.564.8118 190 O'Connor Street, Suite 100 Ottawa, Ontario,K2P 2R3 www.csv.ca

STRUCTURAL ENGINEER Cunliffe & Associates 200, 1550 Carling Ave 2nd Floor Ottawa, ON K1Z 8S8 613-729-7242 cunliffe@cunliffe.ca

MECHANICAL/ELECTRICAL ENGINEER Chorley + Bisset 250 City Centre Ave. Ottawa, ON K1R 1C7 613-241-0300 email@chorley.com

CIVIL ENGINEER McIntosh Perry 115 Walgreen Road, R.R. 3 Carp, ON K0A 1L0 613-836-2184 www.mcintoshperry.com

- 1 ENGINEERED WOOD BOARD AND BATTEN VERTICAL SIDING
- 2 CEDAR 38x235mm FASCIA BOARD
- 3 ASPHALT SHINGLES
- 4 BICYCLE STORAGE
- 5 RECYCLE/ REFUSE BIN
- 6 EXTERIOR LIGHT FIXTURE SEE ELECTRICAL
- 7 EXTERIOR GRADE TRASH CAN
- 8 ENGINEERED WOOD BEAM SEE STRUCTURAL
- 10 WOOD LINTEL SEE STRUCTURAL
- 11 SLAB ON GRADE W/ THICKENED SLAB EDGE SEE STRUCTURAL
- 12 100x1200mm PERIMETER RIGID INSULATION SKIRT
- 13 150mm CONCRETE CURB SEE STRUCTURAL
- 14 PREFINISHED METAL SOFFIT (TYP.)

EXTERIOR MATERIALS LEGEND

HATCH PATTERNS SHOWN ARE FOR GRAPHIC PURPOSES ONLY AND SHOULD BE COORDINATED WITH ACTUAL SPECIFIED MATERIALS.

HATCH SYMBOL DESCRIPTION ASPHALT SHINGLES AS COLOUR: TBD BOARD AND BATTEN CEDAR SIDING ©S MANUFACTURER: TBD COLOUR: TBD C4 WOOD SOFFIT

PROPERTY LINE

STAMP

5 --/-- ISSUED FOR BUILDING PERMIT REV DATE ISSUE

NOTES

1. OWNERSHIP OF THE COPYRIGHT OF THE DESIGN

1. OWNERSHIP OF THE COPYRIGHT OF THE DESIGN AND THE WORKS EXECUTED FROM THE DESIGN REMAINS WITH CSV ARCHITECTS, AND MAY NOT BE REPRODUCED IN ANY FORM WITHOUT THE WRITTEN CONSENT OF CSV ARCHITECTS.

2. THE DRAWINGS, PRESENTATIONS AND SPECIFICATIONS AS INSTRUMENTS OF SERVICE ARE AND SHALL REMAIN THE PROPERTY OF CSV ARCHITECTS. THEY ARE NOT TO BE USED BY THE CLIENT ON OTHER PROJECTS OR ON EXTENSIONS. CLIENT ON OTHER PROJECTS OR ON EXTENSIONS TO THIS PROJECT WITHOUT THE WRITTEN CONSENT OF CSV ARCHITECTS.

3. THIS DRAWING IS TO BE READ IN CONJUNCTION WITH ALL OTHER PROJECT DRAWINGS AND SPECIFICATIONS. 4. DO NOT SCALE DRAWINGS. CONTRACTOR SHALL BE RESPONSIBLE TO VERIFY DIMENSIONS ON SITE.
5. ALL WORK SHALL BE IN ACCORDANCE WITH THE ONTARIO BUILDING CODE AND ALL SUPPLEMENTS AND APPLICABLE MUNICIPAL REGULATIONS.

CLIENT

78 ROSEMOUNT AVE INC.

OTTAWA ONTARIO, CANADA

PROJECT

K1Y 1P6

TITLE


78 ROSEMOUNT AVE.

78 Rosemount Avenue, Ottawa, ON

ACCESSORY BUILDING DETAILS

PROJECT NO: 2021-1320 DRAWN: JW APPROVED: JS 1:50

DATE PRINTED: 5/18/2022 11:08:52 AM DRAWING NO.

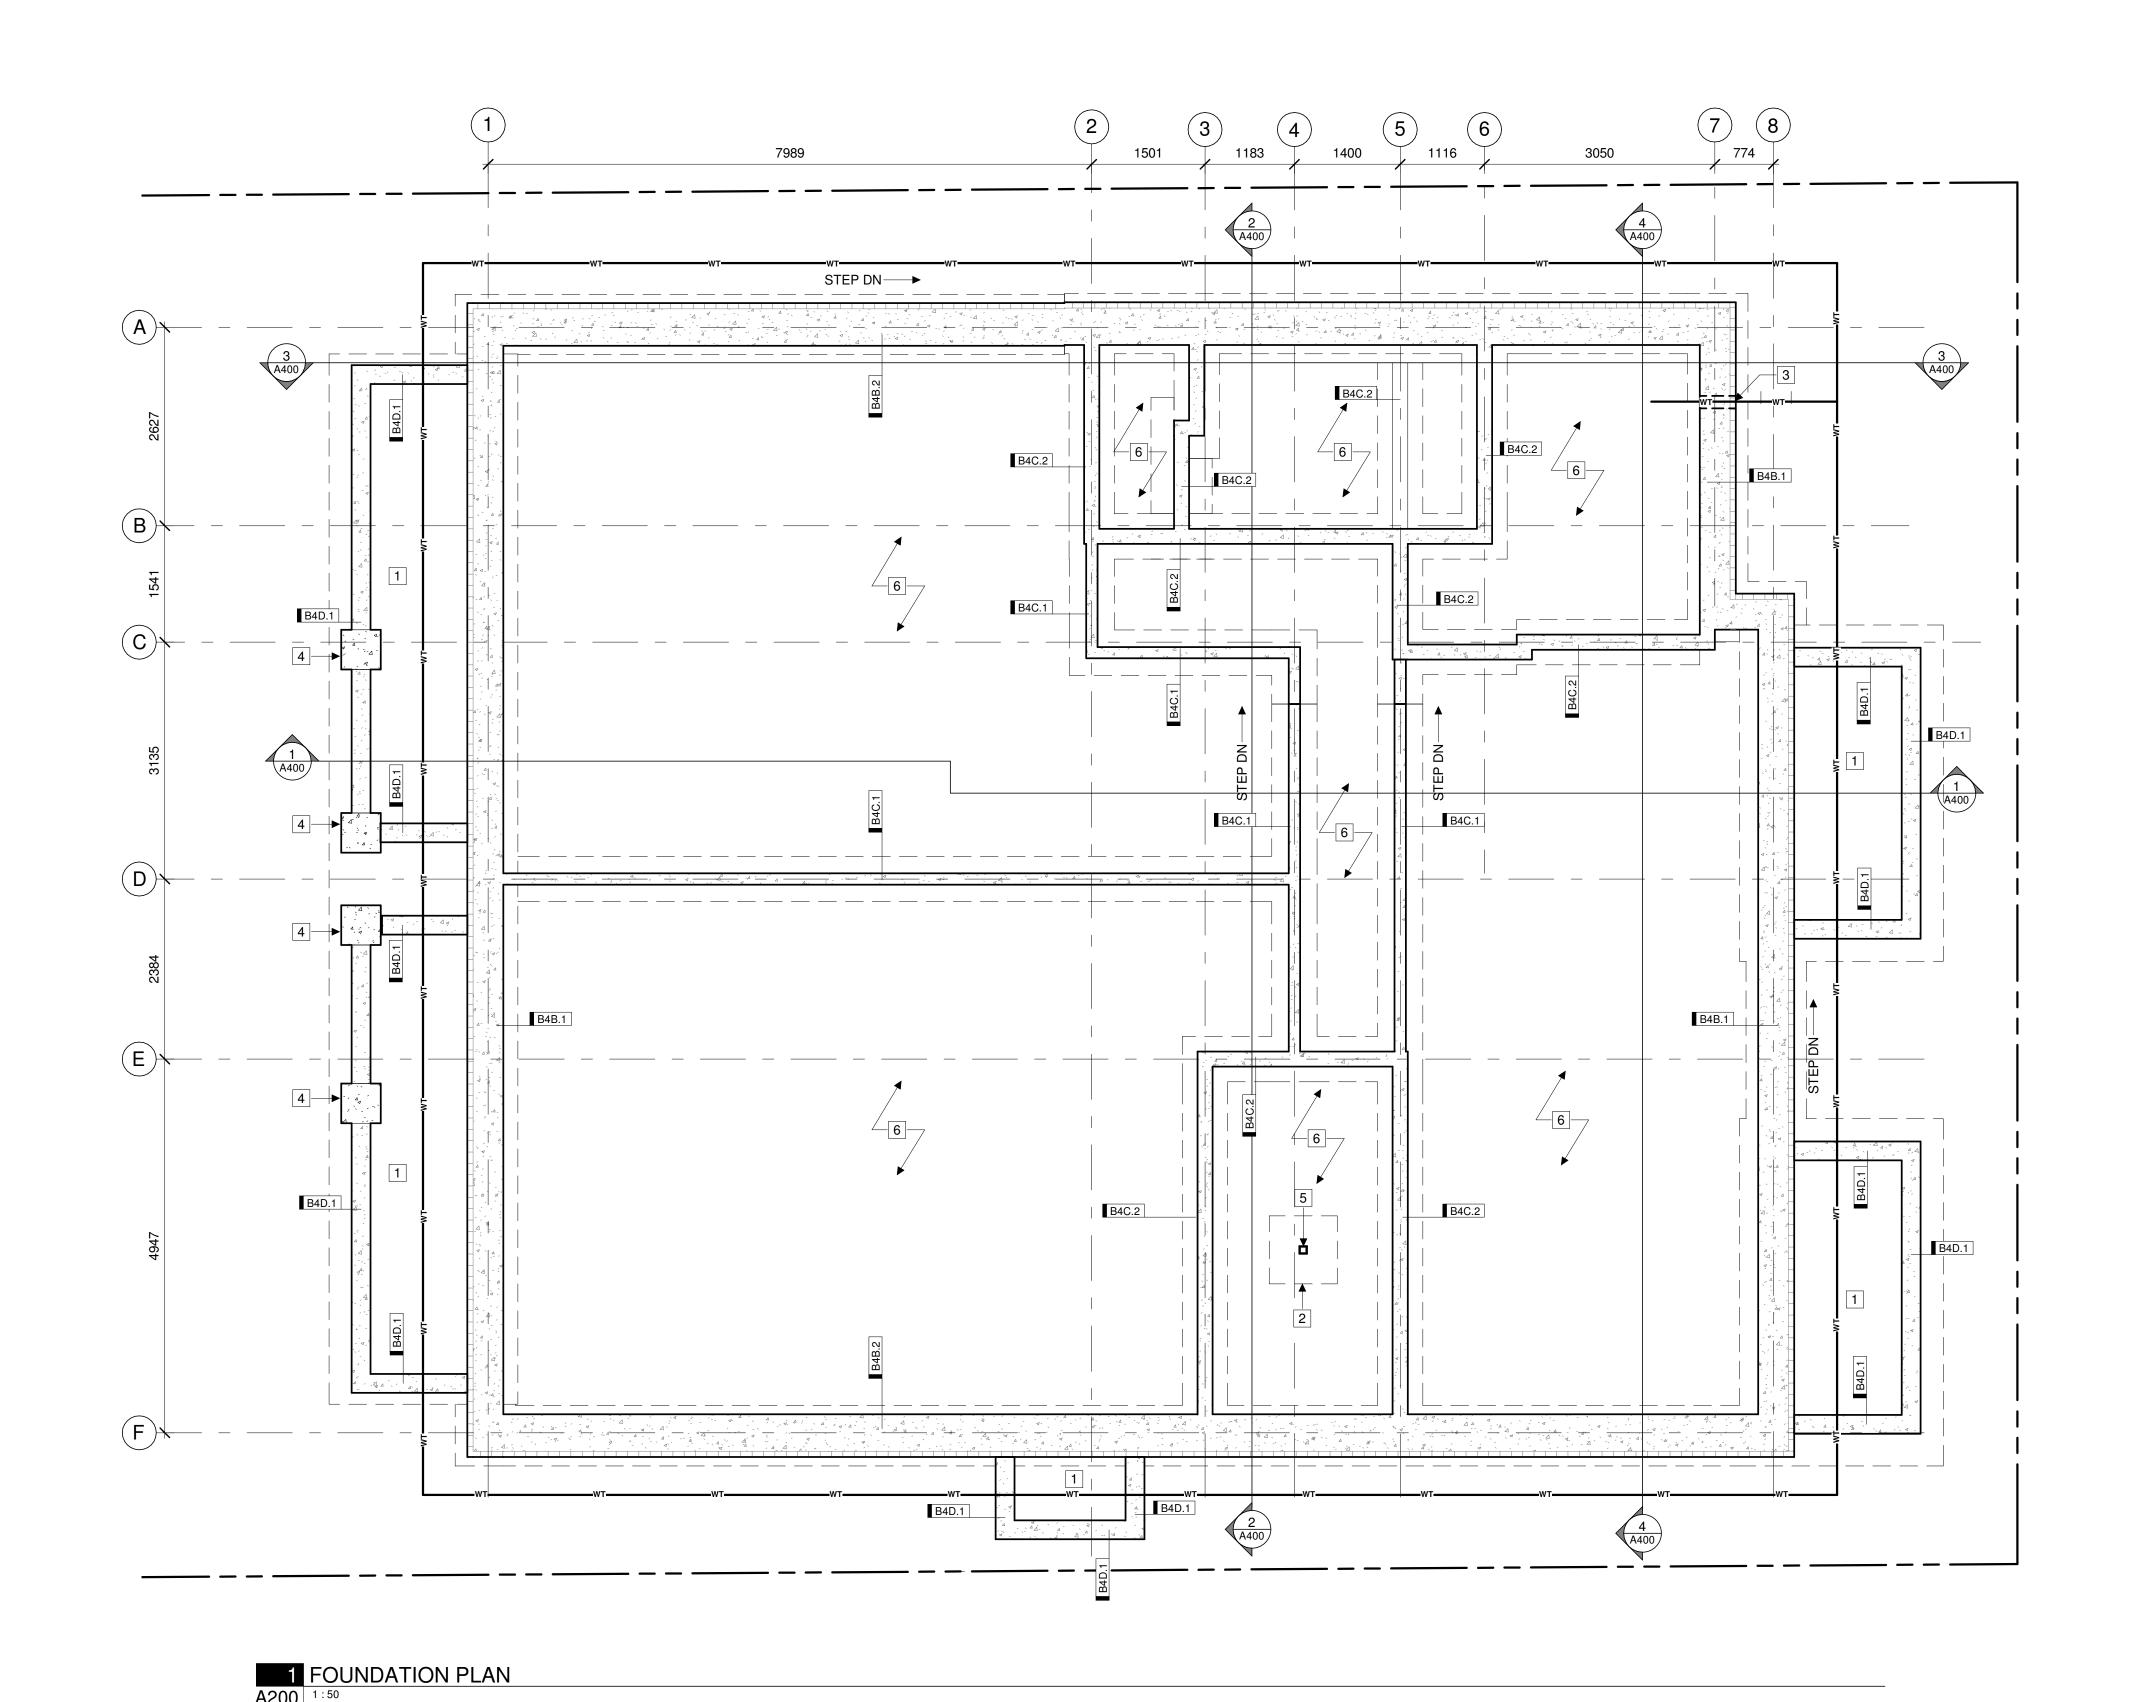


GENERAL FOUNDATION PLAN NOTES:

- 1. DIMENSIONS ARE FOR LOCATION ONLY. REFER TO STRUCTURAL DRAWINGS FOR FOOTINGS, COLUMNS AND FOUNDATION WALL SIZES.
- 2. REFER TO MECHANICAL + ELECTRICAL DRAWINGS FOR DETAILS OF UNDERGROUND SERVICES.
- 3. ALL EXTERIOR FOUNDATION WALLS ARE DIMENSIONED TO
- EXTERIOR FACE OF ASSEMBLY UNLESS OTHERWISE NOTED. 4. ALL INTERIOR FOUNDATION WALLS + FOOTINGS ARE DIMENSIONED FROM GRIDLINE TO FACE UNLESS OTHERWISE NOTED.

FOUNDATION PLAN KEYNOTES:

- 1 CONCRETE WINDOW WELL SEE STRUCTURAL
- 2 FOOTING PER STRUCTURAL
- 3 SLEEVE CONCRETE FOUNDATION FOR WEEPING TILE
- 4 CONCRETE PIER SEE STRUCTURAL
- 5 STEEL POST SEE STRUCTURAL
- 6 COCNRETE SLAB SEE STRUCTURAL

FOUNDATION PLAN LEGEND:

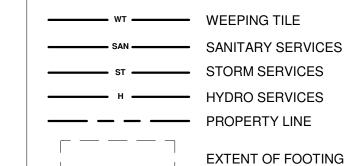

CSV ARCHITECTS

sustainable design · conception écologique

613.564.8118 190 O'Connor Street, Suite 100 Ottawa, Ontario,K2P 2R3 www.csv.ca

STRUCTURAL ENGINEER Cunliffe & Associates 200, 1550 Carling Ave 2nd Floor Ottawa, ON K1Z 8S8 613-729-7242 cunliffe@cunliffe.ca

MECHANICAL/ELECTRICAL ENGINEER Chorley + Bisset 250 City Centre Ave. Ottawa, ON K1R 1C7 613-241-0300

CIVIL ENGINEER McIntosh Perry 115 Walgreen Road, R.R. 3 Carp, ON K0A 1L0 613-836-2184 www.mcintoshperry.com

email@chorley.com

STAMP

5 --/-- ISSUED FOR BUILDING PERMIT 3 03/11/2022 ISSUED FOR COORDINATION REV DATE ISSUE

1. OWNERSHIP OF THE COPYRIGHT OF THE DESIGN AND THE WORKS EXECUTED FROM THE DESIGN REMAINS WITH CSV ARCHITECTS, AND MAY NOT BE REPRODUCED IN ANY FORM WITHOUT THE WRITTEN CONSENT OF CSV ARCHITECTS.

2. THE DRAWINGS, PRESENTATIONS AND SPECIFICATIONS AS INSTRUMENTS OF SERVICE SPECIFICATIONS AS INSTRUMENTS OF SERVICE ARE AND SHALL REMAIN THE PROPERTY OF CSV ARCHITECTS. THEY ARE NOT TO BE USED BY THE CLIENT ON OTHER PROJECTS OR ON EXTENSIONS TO THIS PROJECT WITHOUT THE WRITTEN CONSENT OF CSV ARCHITECTS. 3. THIS DRAWING IS TO BE READ IN CONJUNCTION WITH ALL OTHER PROJECT DRAWINGS AND WITH ALL OTHER PROJECT DRAWINGS AND SPECIFICATIONS.

4. DO NOT SCALE DRAWINGS. CONTRACTOR SHALL BE RESPONSIBLE TO VERIFY DIMENSIONS ON SITE.

5. ALL WORK SHALL BE IN ACCORDANCE WITH THE ONTARIO BUILDING CODE AND ALL SUPPLEMENTS AND APPLICABLE MUNICIPAL REGULATIONS.

CLIENT

78 ROSEMOUNT AVE INC.

OTTAWA ONTARIO, CANADA

PROJECT


78 ROSEMOUNT AVE.

78 Rosemount Avenue, Ottawa, ON K1Y 1P6

TITLE **FOUNDATION PLAN**

PROJECT NO: 2021-1320 DRAWN: APPROVED: JS 1:50 DATE PRINTED: 5/18/2022 11:08:54 AM

DRAWING NO.

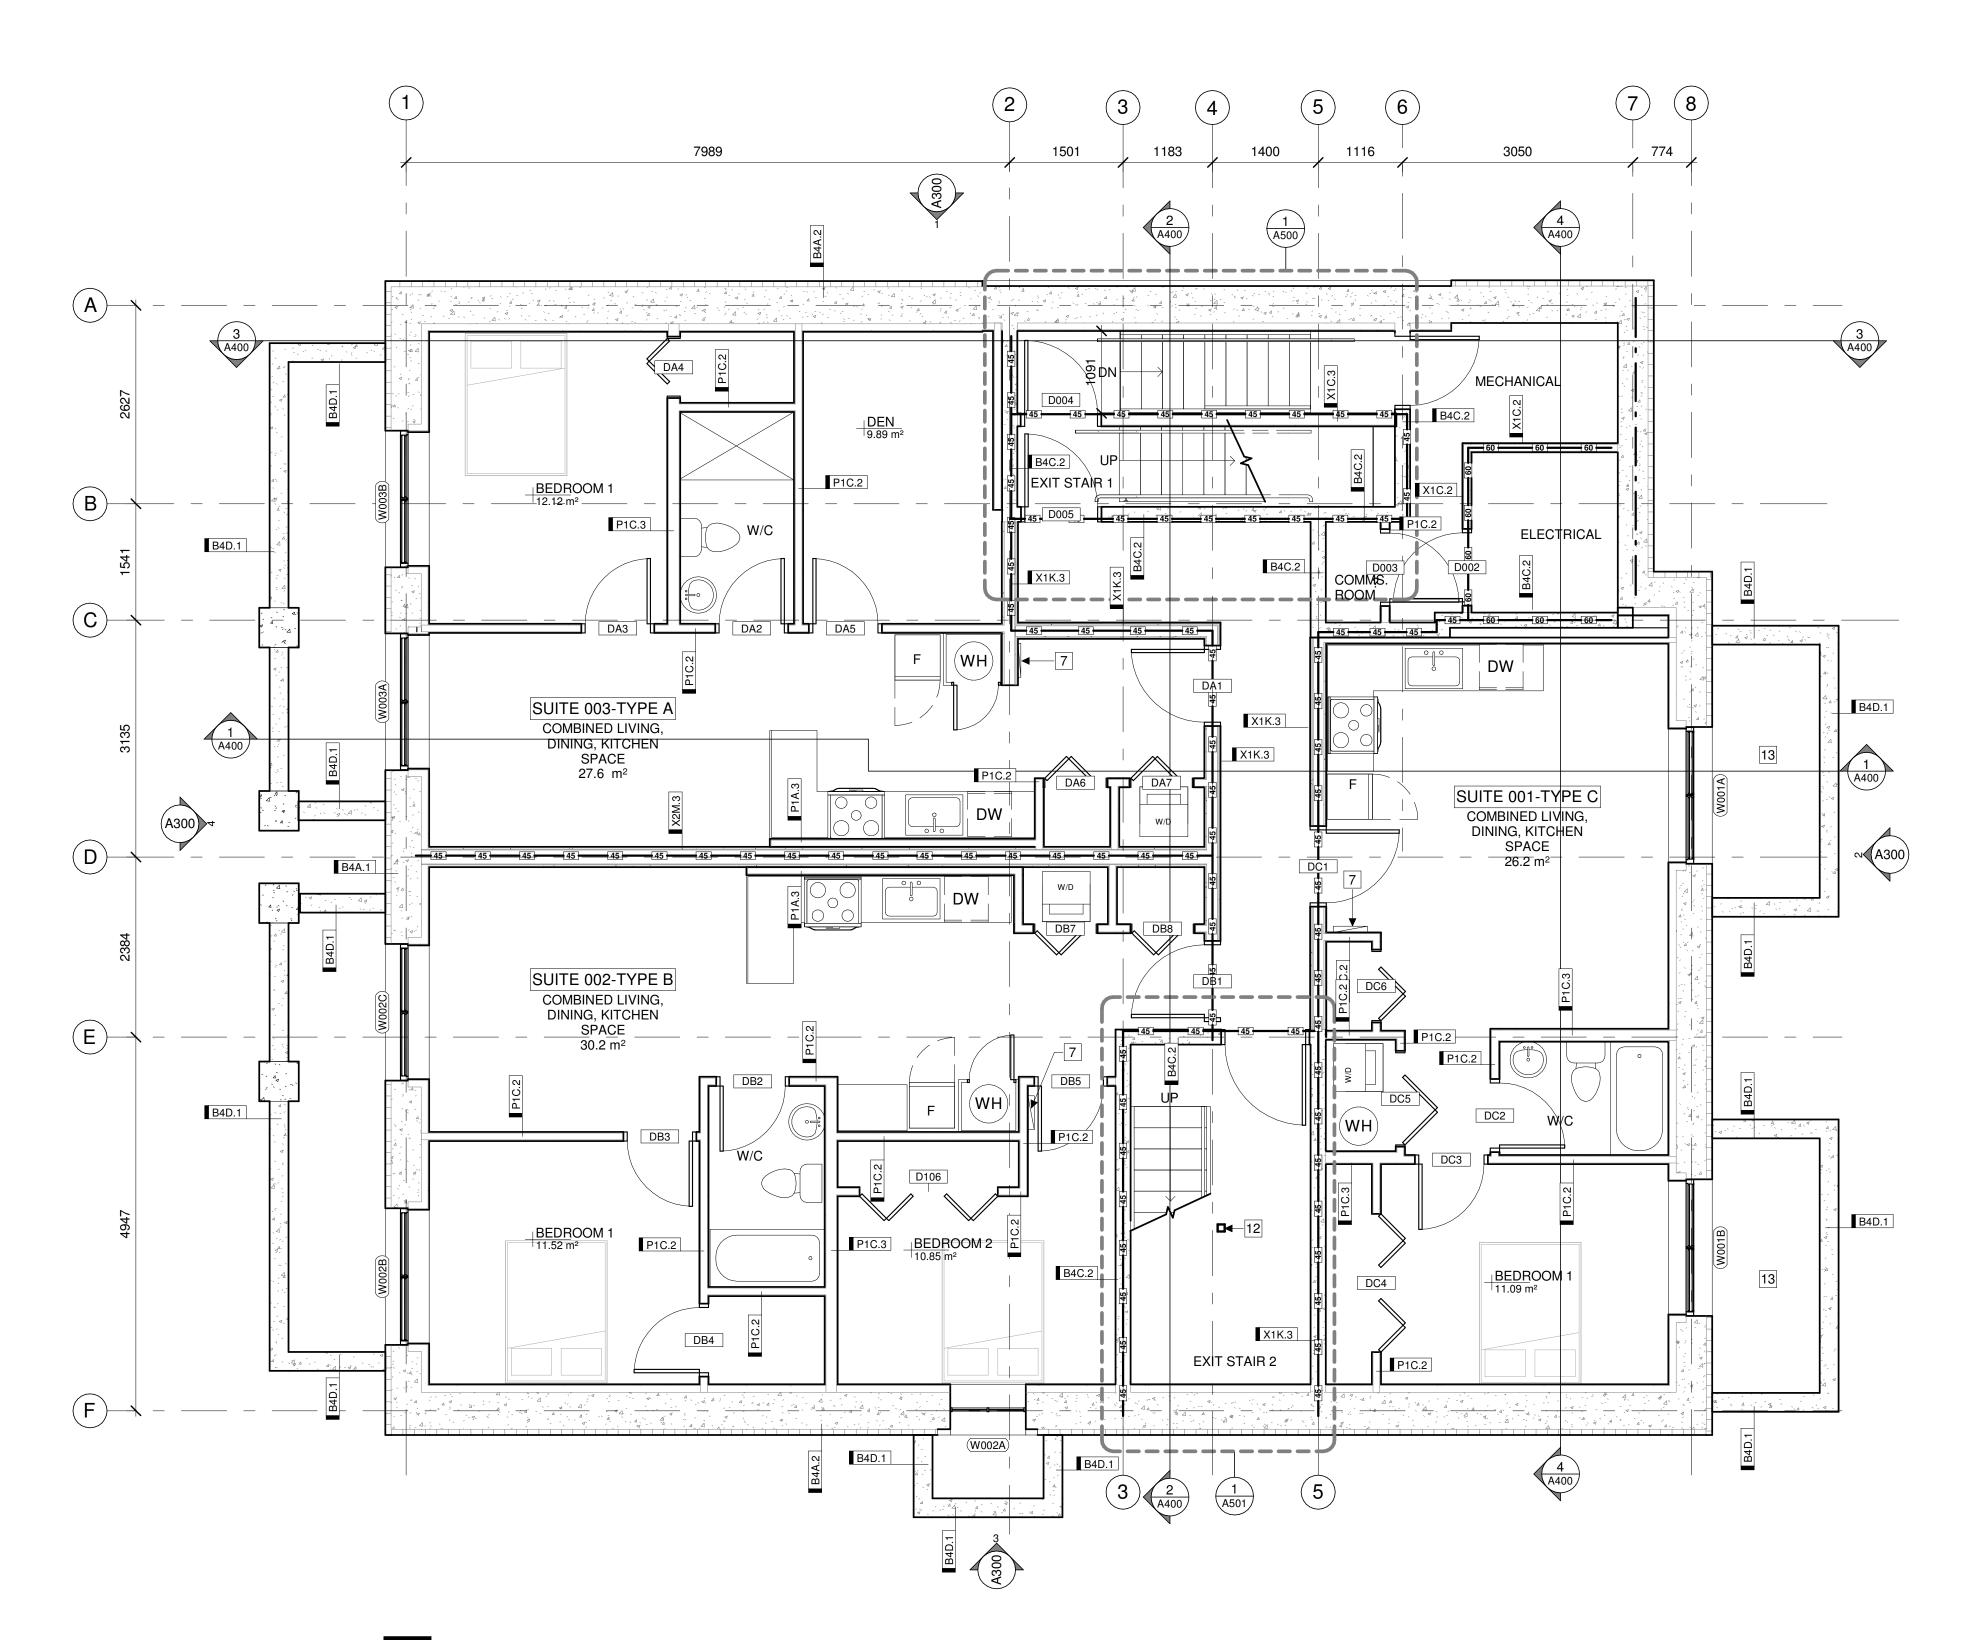

BASEMENT REFERENCE PLAN A201 1:50

GENERAL REFERENCE PLAN NOTES:

NOTE FOR USER: DRAWINGS OF A SIMILAR FUNCTION ie. FLOOR PLAN, ELEVATION, SECTION, INTERIOR ELEVATION ARE TO HAVE COMMON NOTES AND LEGENDS. INDIVIDUAL LEGENDS SHOULD NOT BE CREATED FOR EACH SHEET.

CSV ARCHITECTS

sustainable design · conception écologique

613.564.8118 190 O'Connor Street, Suite 100 Ottawa, Ontario,K2P 2R3 www.csv.ca

STRUCTURAL ENGINEER Cunliffe & Associates 200, 1550 Carling Ave 2nd Floor Ottawa, ON K1Z 8S8 613-729-7242 cunliffe@cunliffe.ca

MECHANICAL/ELECTRICAL ENGINEER Chorley + Bisset 250 City Centre Ave. Ottawa, ON K1R 1C7 613-241-0300 email@chorley.com

CIVIL ENGINEER McIntosh Perry 115 Walgreen Road, R.R. 3 Carp, ON K0A 1L0 613-836-2184 www.mcintoshperry.com

REFERENCE PLAN KEYNOTES:

- 1 VERTICAL PLATFORM LIFT
- 2 FIRE ALARM CONTROL PANEL
- 3 MAILBOXES
- 4 BALCONY
- 5 WINDOW WELL
- 6 JULIETTE BALCONY
- 7 ELECTRICAL PANEL SEE ELECTRICAL
- 8 COMMUNICATIONS EQUIPMENT WALL BOX SEE ELECTRICAL
- 9 HOSE BIB
- 10 ROOF ACCESS LADDER
- DOOR OPERATOR PUSH BUTTON ON PEDESTAL REFER TO **ELECTRICAL**
- 12 STEEL POST PER STRUCTURAL
- 13 CONCRETE WINDOW WELL SEE STRUCTURAL

STAMP

LEGEND:

FLOOR DRAIN PER MECHANICAL 45 MIN. FIRE RESISTANCE RATING

60 MIN. FIRE RESISTANCE RATING

60MIN FIRE RESISTANCE RATING

90MIN FIRE RESISTANCE RATING

BEAM ABOVE

5 --/-- ISSUED FOR BUILDING PERMIT 3 03/11/2022 ISSUED FOR COORDINATION REV DATE ISSUE



1. OWNERSHIP OF THE COPYRIGHT OF THE DESIGN 1. OWNERSHIP OF THE COPYRIGHT OF THE DESIGN AND THE WORKS EXECUTED FROM THE DESIGN REMAINS WITH CSV ARCHITECTS, AND MAY NOT BE REPRODUCED IN ANY FORM WITHOUT THE WRITTEN CONSENT OF CSV ARCHITECTS.

2. THE DRAWINGS, PRESENTATIONS AND SPECIFICATIONS AS INSTRUMENTS OF SERVICE ARE AND SHALL REMAIN THE PROPERTY OF CSV ARCHITECTS. THEY ARE NOT TO BE USED BY THE CLIENT ON OTHER PROJECTS OR ON EXTENSIONS TO THIS PROJECT WITHOUT THE WRITTEN. TO THIS PROJECT WITHOUT THE WRITTEN CONSENT OF CSV ARCHITECTS.

3. THIS DRAWING IS TO BE READ IN CONJUNCTION WITH ALL OTHER PROJECT DRAWINGS AND SPECIFICATIONS.
4. DO NOT SCALE DRAWINGS. CONTRACTOR SHALL BE RESPONSIBLE TO VERIFY DIMENSIONS ON SITE.

5. ALL WORK SHALL BE IN ACCORDANCE WITH THE ONTARIO BUILDING CODE AND ALL SUPPLEMENTS AND APPLICABLE MUNICIPAL REGULATIONS.

CLIENT

78 ROSEMOUNT AVE INC.

OTTAWA ONTARIO, CANADA

PROJECT

K1Y 1P6

78 ROSEMOUNT AVE.


FIRE RATING LEGEND: 78 Rosemount Avenue, Ottawa, ON 45MIN FIRE RESISTANCE RATING

TITLE

BASEMENT REFERENCE PLAN

PROJECT NO: 2021-1320 DRAWN: JW APPROVED: JS 1:50 DATE PRINTED: 5/18/2022 11:08:58 AM

DRAWING NO.

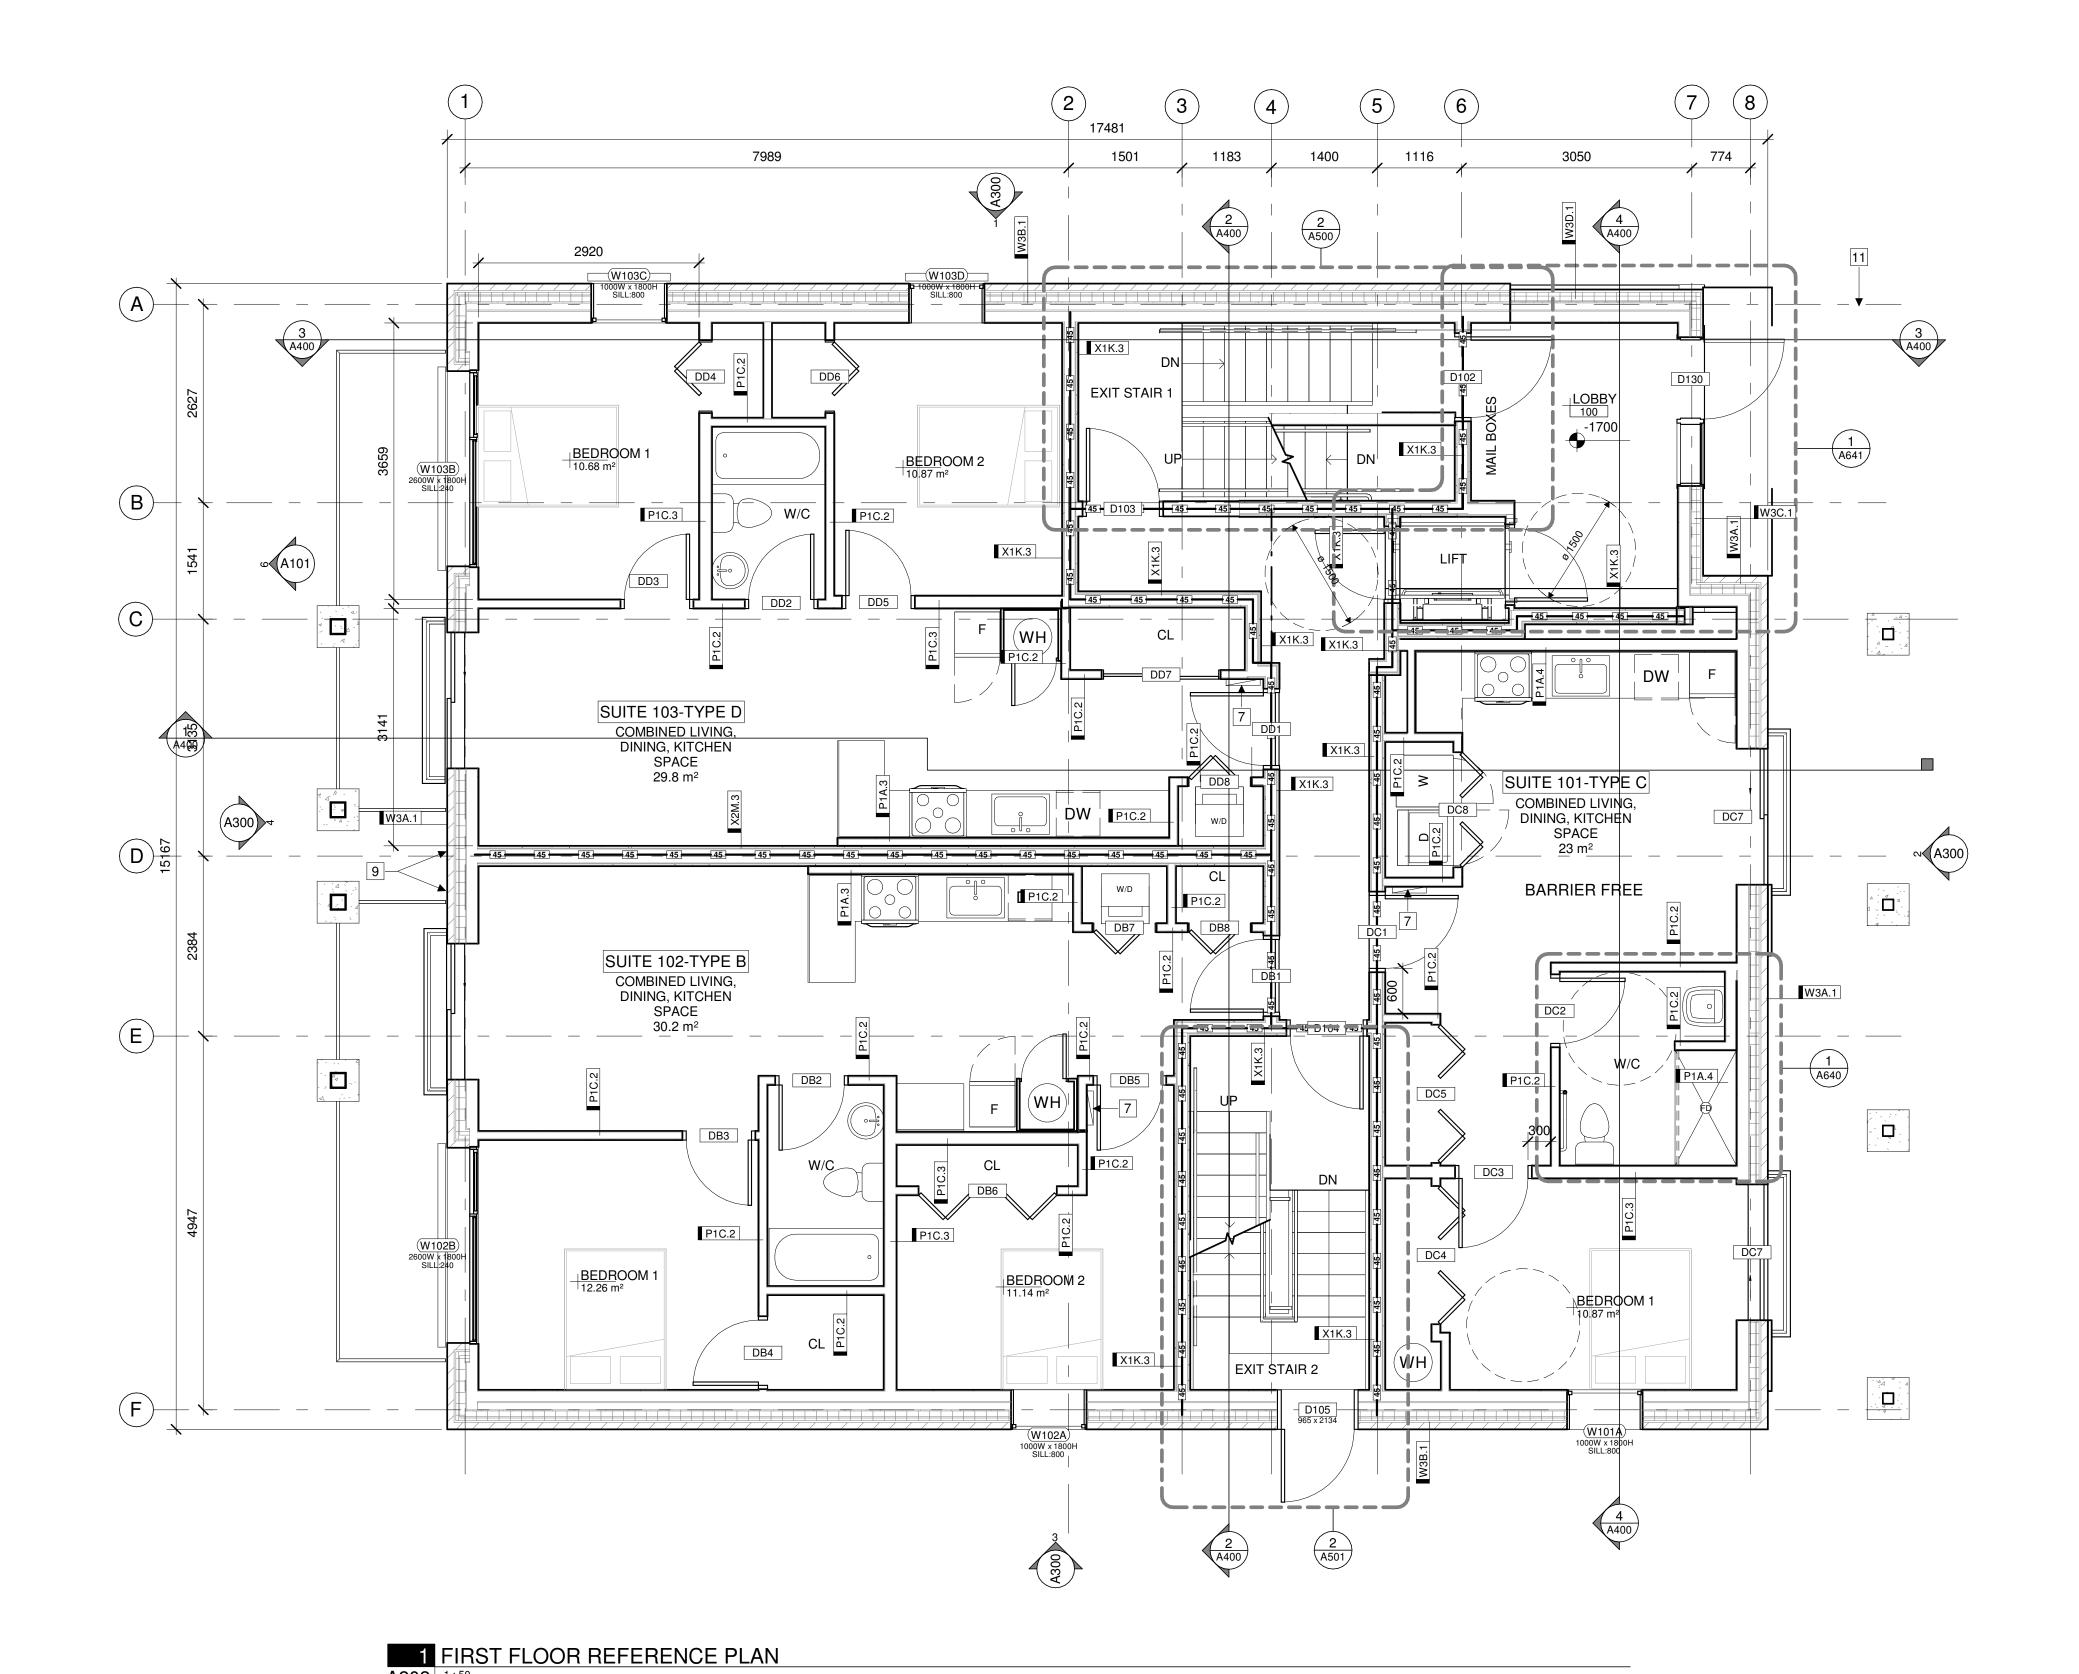

GENERAL REFERENCE PLAN NOTES:

NOTE FOR USER: DRAWINGS OF A SIMILAR FUNCTION ie. FLOOR PLAN, ELEVATION, SECTION, INTERIOR ELEVATION ARE TO HAVE COMMON NOTES AND LEGENDS. INDIVIDUAL LEGENDS SHOULD NOT BE CREATED FOR EACH SHEET.

CSV ARCHITECTS

sustainable design · conception écologique
613.564.8118 190 O'Connor Street, Suite 100

www.csv.ca Ottawa, Ontario,K2P 2R3

STRUCTURAL ENGINEER

STRUCTURAL ENGINEER
Cunliffe & Associates
200, 1550 Carling Ave 2nd Floor
Ottawa, ON K1Z 8S8
613-729-7242
cunliffe@cunliffe.ca

MECHANICAL/ELECTRICAL ENGINEER Chorley + Bisset 250 City Centre Ave. Ottawa, ON K1R 1C7 613-241-0300 email@chorley.com

CIVIL ENGINEER
McIntosh Perry
115 Walgreen Road, R.R. 3
Carp, ON K0A 1L0
613-836-2184
www.mcintoshperry.com

REFERENCE PLAN KEYNOTES:

- 1 VERTICAL PLATFORM LIFT
- 2 FIRE ALARM CONTROL PANEL
- 3 MAILBOXES
- 4 BALCONY
- 5 WINDOW WELL
- 6 JULIETTE BALCONY
- 7 ELECTRICAL PANEL SEE ELECTRICAL
- 8 COMMUNICATIONS EQUIPMENT WALL BOX SEE ELECTRICAL
- 9 HOSE BIB
- 10 ROOF ACCESS LADDER
- DOOR OPERATOR PUSH BUTTON ON PEDESTAL REFER TO ELECTRICAL
- 12 STEEL POST PER STRUCTURAL
- 13 CONCRETE WINDOW WELL SEE STRUCTURAL

STAMP

LEGEND:

FLOOR DRAIN PER MECHANICAL

45 MIN. FIRE RESISTANCE RATING

60 MIN. FIRE RESISTANCE RATING

BEAM ABOVE

FIRE RATING LEGEND:

45MIN FIRE RESISTANCE RATING

60MIN FIRE RESISTANCE RATING

90MIN FIRE RESISTANCE RATING

5 --/--/-- ISSUED FOR BUILDING PERMIT
3 03/11/2022 ISSUED FOR COORDINATION
REV DATE ISSUE

REV DATE ISSUE

OTES

1. OWNERSHIP OF THE COPYRIGHT OF THE DESIGN AND THE WORKS EXECUTED FROM THE DESIGN REMAINS WITH CSV ARCHITECTS, AND MAY NOT BE REPRODUCED IN ANY FORM WITHOUT THE WRITTEN CONSENT OF CSV ARCHITECTS.

2. THE DRAWINGS, PRESENTATIONS AND SPECIFICATIONS AS INSTRUMENTS OF SERVICE ARE AND SHALL REMAIN THE PROPERTY OF CSV ARCHITECTS. THEY ARE NOT TO BE USED BY THE CLIENT ON OTHER PROJECTS OR ON EXTENSIONS TO THIS PROJECT WITHOUT THE WRITTEN CONSENT OF CSV ARCHITECTS.

3. THIS DRAWING IS TO BE READ IN CONJUNCTION WITH ALL OTHER PROJECT DRAWINGS AND SPECIFICATIONS.

4. DO NOT SCALE DRAWINGS. CONTRACTOR SHALL BE RESPONSIBLE TO VERIFY DIMENSIONS ON SITE.

5. ALL WORK SHALL BE IN ACCORDANCE WITH THE ONTARIO BUILDING CODE AND ALL SUPPLEMENTS AND APPLICABLE MUNICIPAL REGULATIONS.

CLIENT

78 ROSEMOUNT AVE INC.

OTTAWA ONTARIO, CANADA

PROJECT

78 ROSEMOUNT AVE.

K1Y 1P6

TITLE

FIRST FLOOR

78 Rosemount Avenue, Ottawa, ON


FIRST FLOOR REFERENCE PLAN

PROJECT NO: 2021-1320
DRAWN: JW
APPROVED: JS
SCALE: 1:50
DATE PRINTED: 5/18/2022 11:09:02 AM

REV DRAWING NO.

A202

.

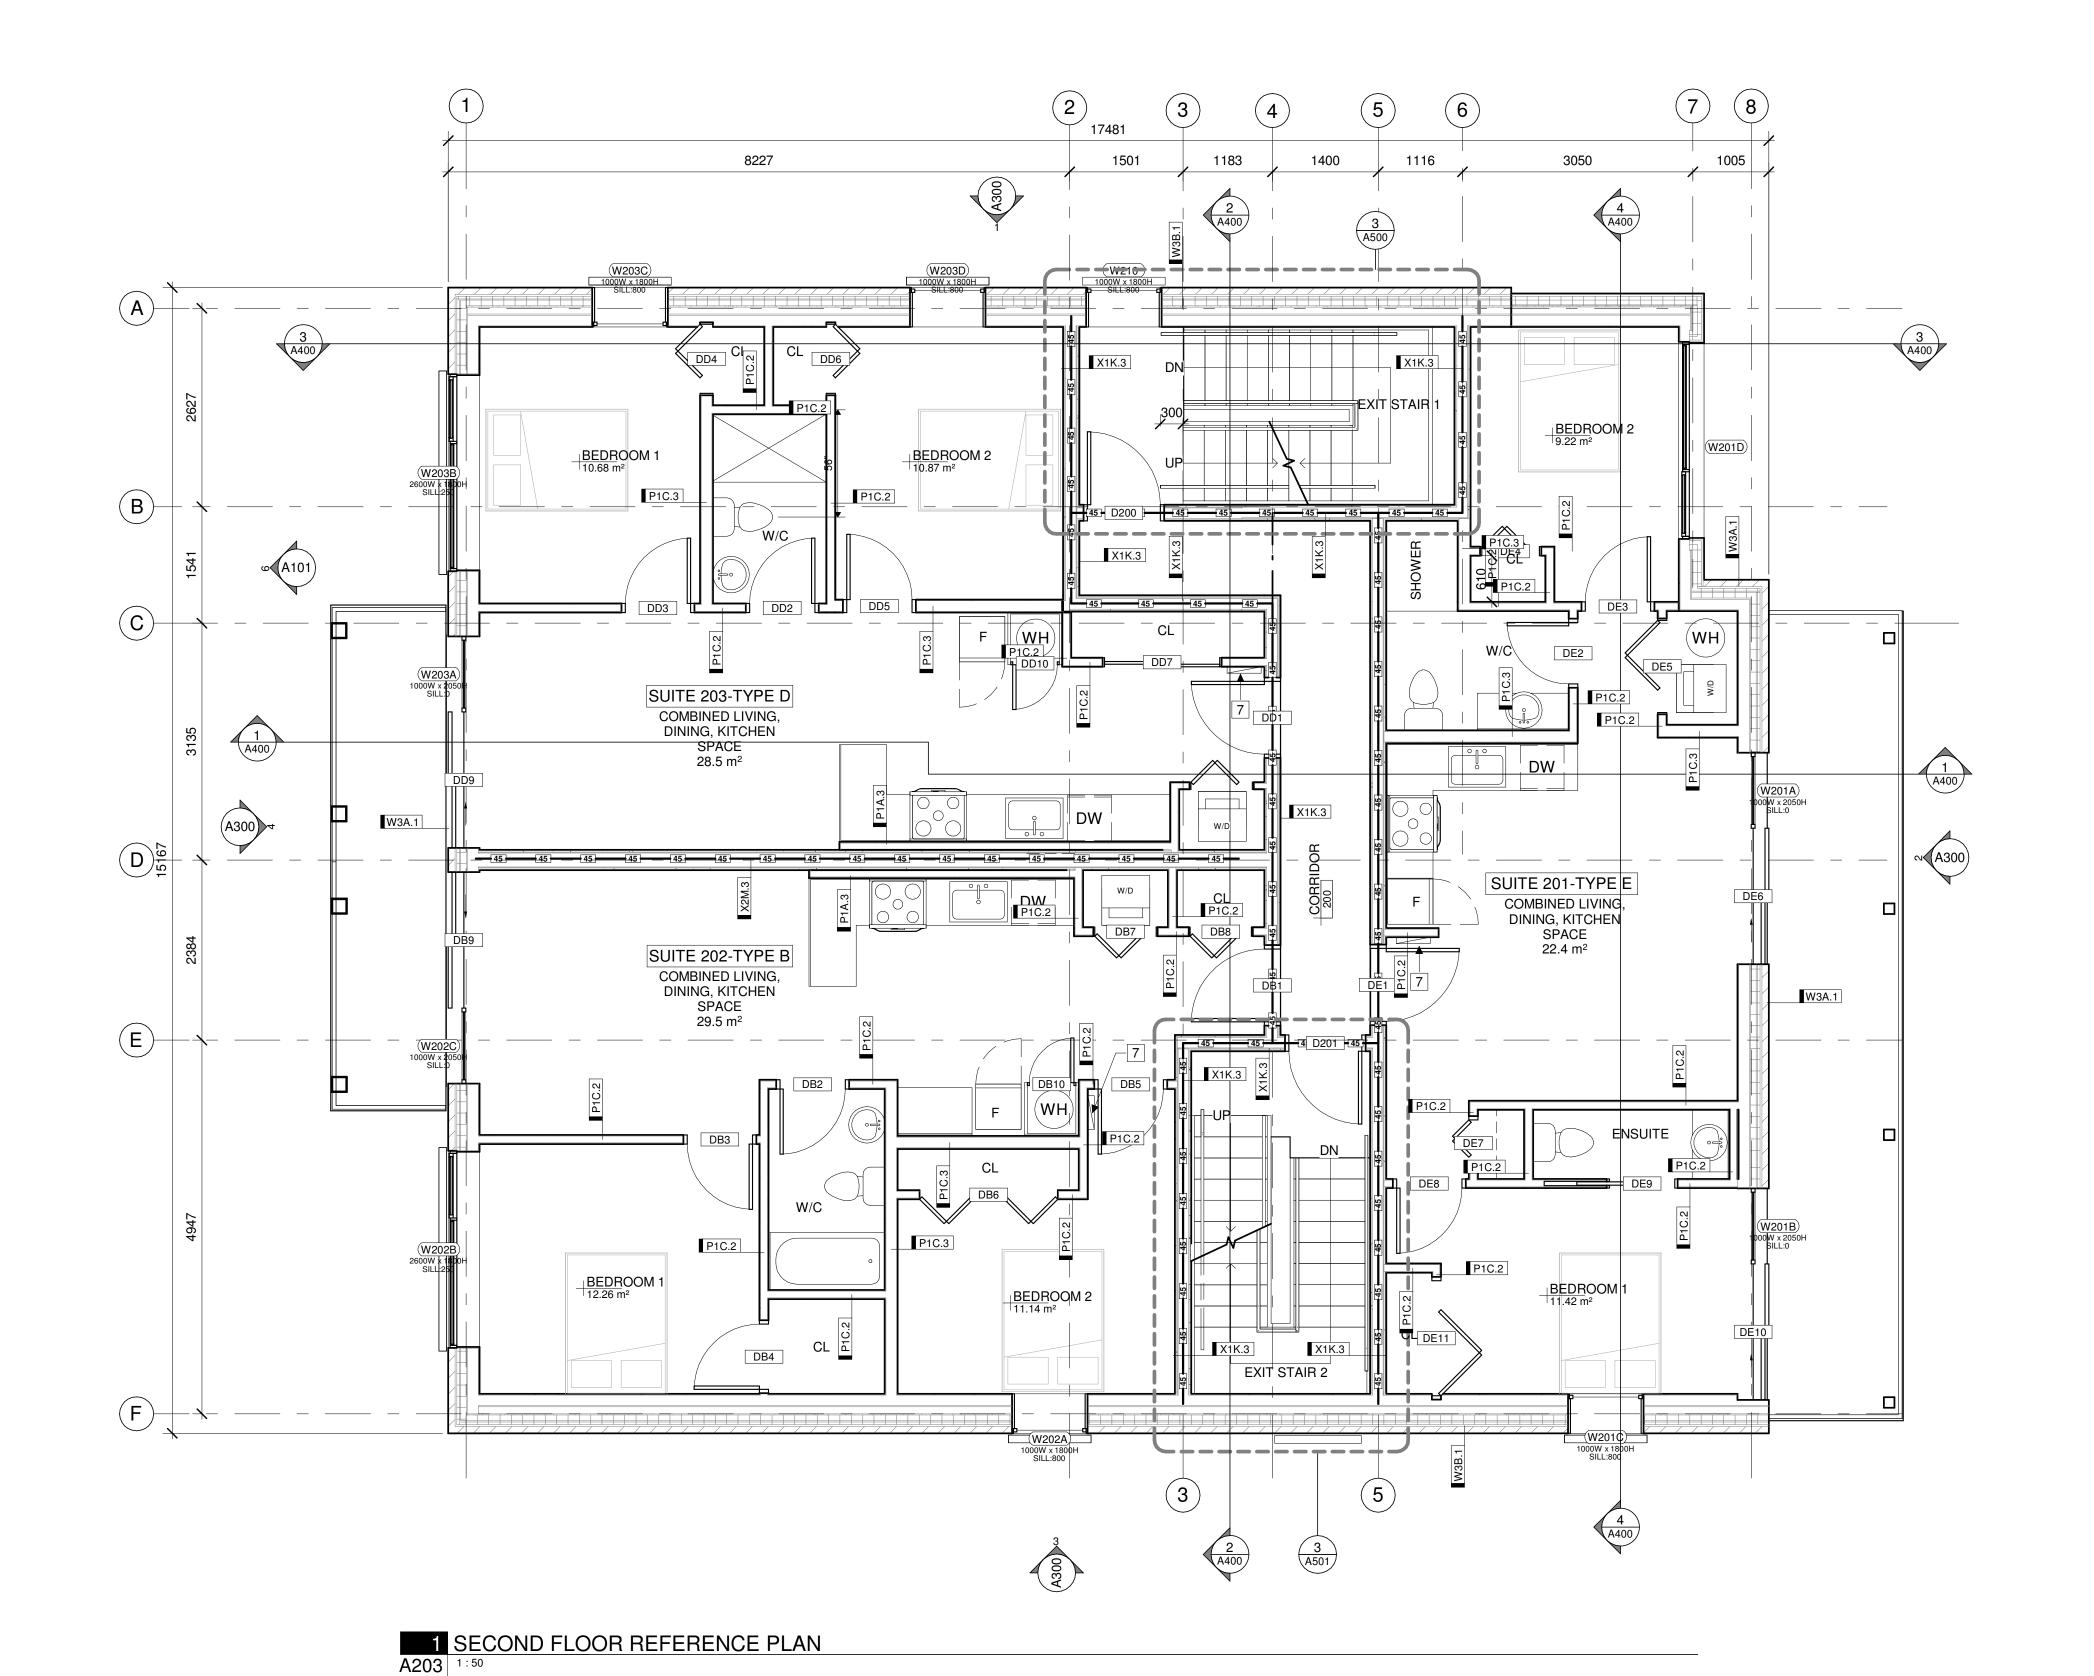

GENERAL REFERENCE PLAN NOTES:

NOTE FOR USER: DRAWINGS OF A SIMILAR FUNCTION ie. FLOOR PLAN, ELEVATION, SECTION, INTERIOR ELEVATION ARE TO HAVE COMMON NOTES AND LEGENDS. INDIVIDUAL LEGENDS SHOULD NOT BE CREATED FOR EACH SHEET.

CSV ARCHITECTS

sustainable design · conception écologique

613.564.8118 190 O'Connor Street, Suite 100 Ottawa, Ontario,K2P 2R3 www.csv.ca

STRUCTURAL ENGINEER Cunliffe & Associates 200, 1550 Carling Ave 2nd Floor Ottawa, ON K1Z 8S8 613-729-7242 cunliffe@cunliffe.ca

MECHANICAL/ELECTRICAL ENGINEER Chorley + Bisset 250 City Centre Ave. Ottawa, ON K1R 1C7 613-241-0300 email@chorley.com

CIVIL ENGINEER McIntosh Perry 115 Walgreen Road, R.R. 3 Carp, ON K0A 1L0 613-836-2184 www.mcintoshperry.com

REFERENCE PLAN KEYNOTES:

- 1 VERTICAL PLATFORM LIFT
- 2 FIRE ALARM CONTROL PANEL
- 3 MAILBOXES
- 4 BALCONY
- 5 WINDOW WELL
- 6 JULIETTE BALCONY
- 7 ELECTRICAL PANEL SEE ELECTRICAL
- 8 COMMUNICATIONS EQUIPMENT WALL BOX SEE ELECTRICAL
- 9 HOSE BIB
- 10 ROOF ACCESS LADDER
- DOOR OPERATOR PUSH BUTTON ON PEDESTAL REFER TO **ELECTRICAL**
- 12 STEEL POST PER STRUCTURAL
- 13 CONCRETE WINDOW WELL SEE STRUCTURAL

STAMP

LEGEND:

FLOOR DRAIN PER MECHANICAL

45 MIN. FIRE RESISTANCE RATING 60 MIN. FIRE RESISTANCE RATING

BEAM ABOVE

5 --/-- ISSUED FOR BUILDING PERMIT 3 03/11/2022 ISSUED FOR COORDINATION REV DATE ISSUE

1. OWNERSHIP OF THE COPYRIGHT OF THE DESIGN AND THE WORKS EXECUTED FROM THE DESIGN
AND THE WORKS EXECUTED FROM THE DESIGN
REMAINS WITH CSV ARCHITECTS, AND MAY NOT BE
REPRODUCED IN ANY FORM WITHOUT THE WRITTEN
CONSENT OF CSV ARCHITECTS.
2. THE DRAWINGS, PRESENTATIONS AND SPECIFICATIONS AS INSTRUMENTS OF SERVICE ARE AND SHALL REMAIN THE PROPERTY OF CSV ARCHITECTS. THEY ARE NOT TO BE USED BY THE CLIENT ON OTHER PROJECTS OR ON EXTENSIONS TO THIS PROJECT WITHOUT THE WRITTEN CONSENT OF CSV ARCHITECTS. 3. THIS DRAWING IS TO BE READ IN CONJUNCTION WITH ALL OTHER PROJECT DRAWINGS AND SPECIFICATIONS.
4. DO NOT SCALE DRAWINGS. CONTRACTOR SHALL BE RESPONSIBLE TO VERIFY DIMENSIONS ON SITE.

5. ALL WORK SHALL BE IN ACCORDANCE WITH THE ONTARIO BUILDING CODE AND ALL SUPPLEMENTS AND APPLICABLE MUNICIPAL REGULATIONS.

CLIENT

78 ROSEMOUNT AVE INC.

OTTAWA ONTARIO, CANADA

PROJECT

K1Y 1P6

78 ROSEMOUNT AVE.

FIRE RATING LEGEND: 78 Rosemount Avenue, Ottawa, ON 45MIN FIRE RESISTANCE RATING

60MIN FIRE RESISTANCE RATING


90MIN FIRE RESISTANCE RATING

TITLE SECOND FLOOR

REFERENCE PLAN PROJECT NO: 2021-1320

DRAWN: JW APPROVED: JS 1:50 DATE PRINTED: 5/18/2022 11:09:05 AM

DRAWING NO.

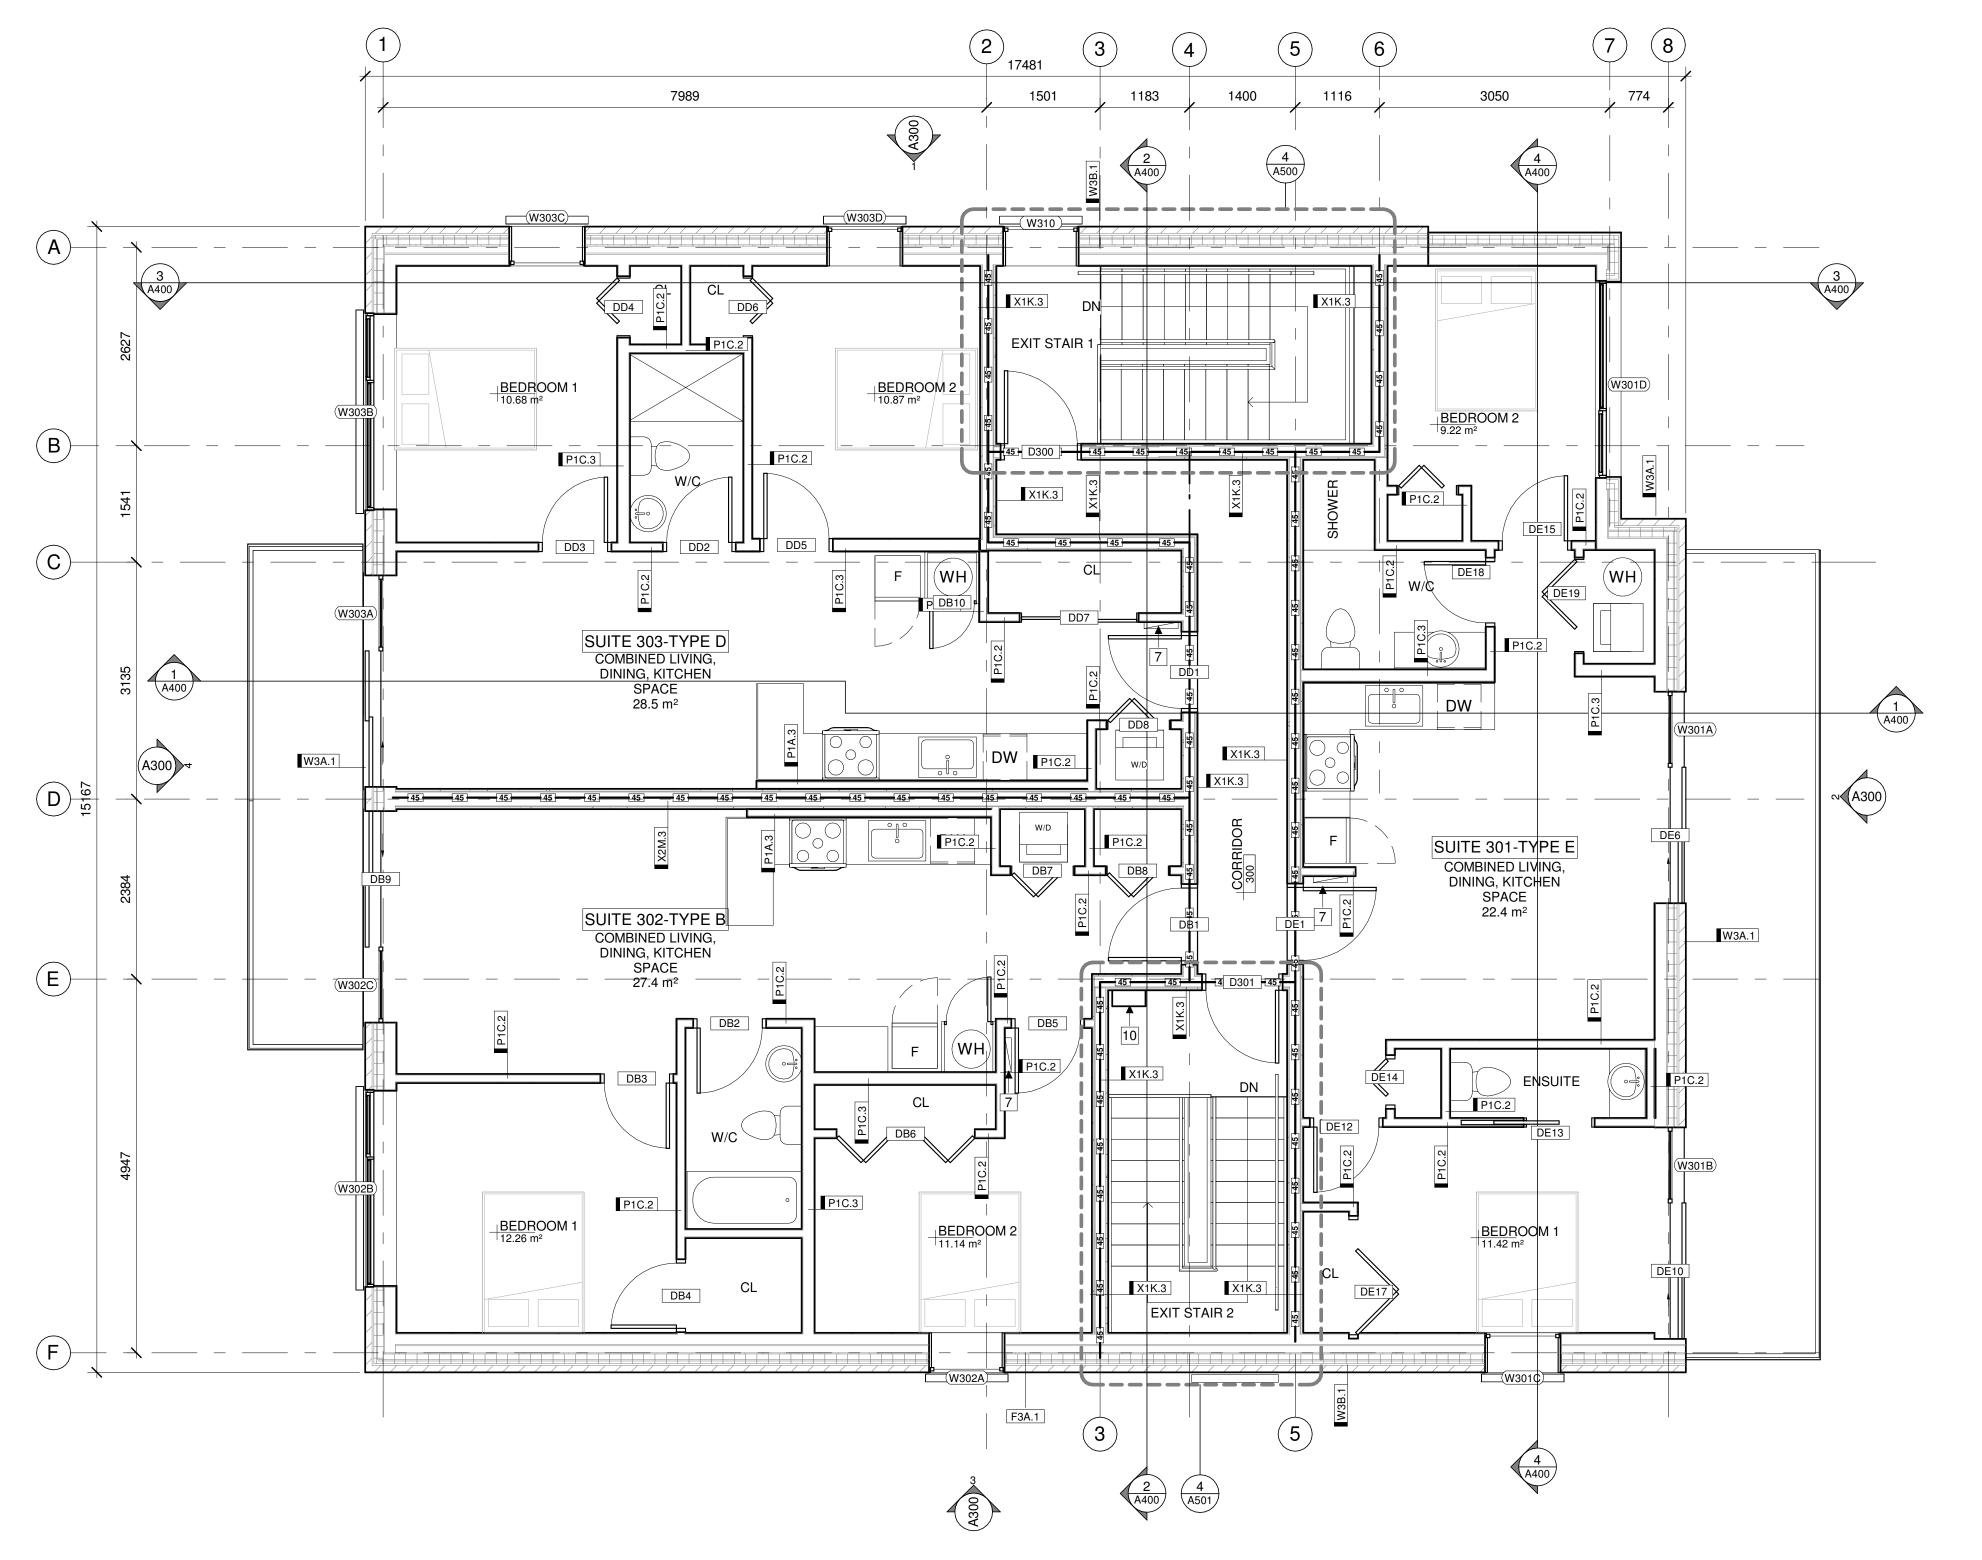

1 THIRD FLOOR REFERENCE PLAN

A204 1:50

GENERAL REFERENCE PLAN NOTES:

NOTE FOR USER: DRAWINGS OF A SIMILAR FUNCTION ie. FLOOR PLAN, ELEVATION, SECTION, INTERIOR ELEVATION ARE TO HAVE COMMON NOTES AND LEGENDS. INDIVIDUAL LEGENDS SHOULD NOT BE CREATED FOR EACH SHEET.

CSV ARCHITECTS

sustainable design · conception écologique

190 O'Connor Street, Suite 100 613.564.8118 Ottawa, Ontario,K2P 2R3 www.csv.ca

STRUCTURAL ENGINEER Cunliffe & Associates 200, 1550 Carling Ave 2nd Floor Ottawa, ON K1Z 8S8 613-729-7242 cunliffe@cunliffe.ca

MECHANICAL/ELECTRICAL ENGINEER Chorley + Bisset 250 City Centre Ave. Ottawa, ON K1R 1C7 613-241-0300 email@chorley.com

CIVIL ENGINEER McIntosh Perry 115 Walgreen Road, R.R. 3 Carp, ON K0A 1L0 613-836-2184 www.mcintoshperry.com

REFERENCE PLAN KEYNOTES:

- 1 VERTICAL PLATFORM LIFT
- 2 FIRE ALARM CONTROL PANEL
- 3 MAILBOXES
- 4 BALCONY
- 5 WINDOW WELL
- 6 JULIETTE BALCONY
- 7 ELECTRICAL PANEL SEE ELECTRICAL
- 8 COMMUNICATIONS EQUIPMENT WALL BOX SEE ELECTRICAL
- 9 HOSE BIB
- 10 ROOF ACCESS LADDER
- DOOR OPERATOR PUSH BUTTON ON PEDESTAL REFER TO **ELECTRICAL**
- 12 STEEL POST PER STRUCTURAL
- 13 CONCRETE WINDOW WELL SEE STRUCTURAL

STAMP

LEGEND:

FLOOR DRAIN PER MECHANICAL

45 MIN. FIRE RESISTANCE RATING 60 MIN. FIRE RESISTANCE RATING

BEAM ABOVE

FIRE RATING LEGEND:

45MIN FIRE RESISTANCE RATING

60MIN FIRE RESISTANCE RATING

90MIN FIRE RESISTANCE RATING

5 --/-- ISSUED FOR BUILDING PERMIT 3 03/11/2022 ISSUED FOR COORDINATION REV DATE ISSUE



1. OWNERSHIP OF THE COPYRIGHT OF THE DESIGN AND THE WORKS EXECUTED FROM THE DESIGN
AND THE WORKS EXECUTED FROM THE DESIGN
REMAINS WITH CSV ARCHITECTS, AND MAY NOT BE
REPRODUCED IN ANY FORM WITHOUT THE WRITTEN
CONSENT OF CSV ARCHITECTS.
2. THE DRAWINGS, PRESENTATIONS AND
RECOGNICATIONS AS INSTRUMENTS OF SERVICE SPECIFICATIONS AS INSTRUMENTS OF SERVICE ARE AND SHALL REMAIN THE PROPERTY OF CSV ARCHITECTS. THEY ARE NOT TO BE USED BY THE CLIENT ON OTHER PROJECTS OR ON EXTENSIONS TO THIS PROJECT WITHOUT THE WRITTEN CONSENT OF CSV ARCHITECTS. 3. THIS DRAWING IS TO BE READ IN CONJUNCTION WITH ALL OTHER PROJECT DRAWINGS AND SPECIFICATIONS. 4. DO NOT SCALE DRAWINGS. CONTRACTOR SHALL BE RESPONSIBLE TO VERIFY DIMENSIONS ON SITE.

5. ALL WORK SHALL BE IN ACCORDANCE WITH THE ONTARIO BUILDING CODE AND ALL SUPPLEMENTS AND APPLICABLE MUNICIPAL REGULATIONS.

CLIENT

78 ROSEMOUNT AVE INC.

OTTAWA ONTARIO, CANADA

PROJECT

K1Y 1P6

78 ROSEMOUNT AVE.


78 Rosemount Avenue, Ottawa, ON

TITLE THIRD FLOOR

REFERENCE PLAN

PROJECT NO: 2021-1320 DRAWN: JW APPROVED: JS 1:50 DATE PRINTED: 5/18/2022 11:09:08 AM

REV DRAWING NO.

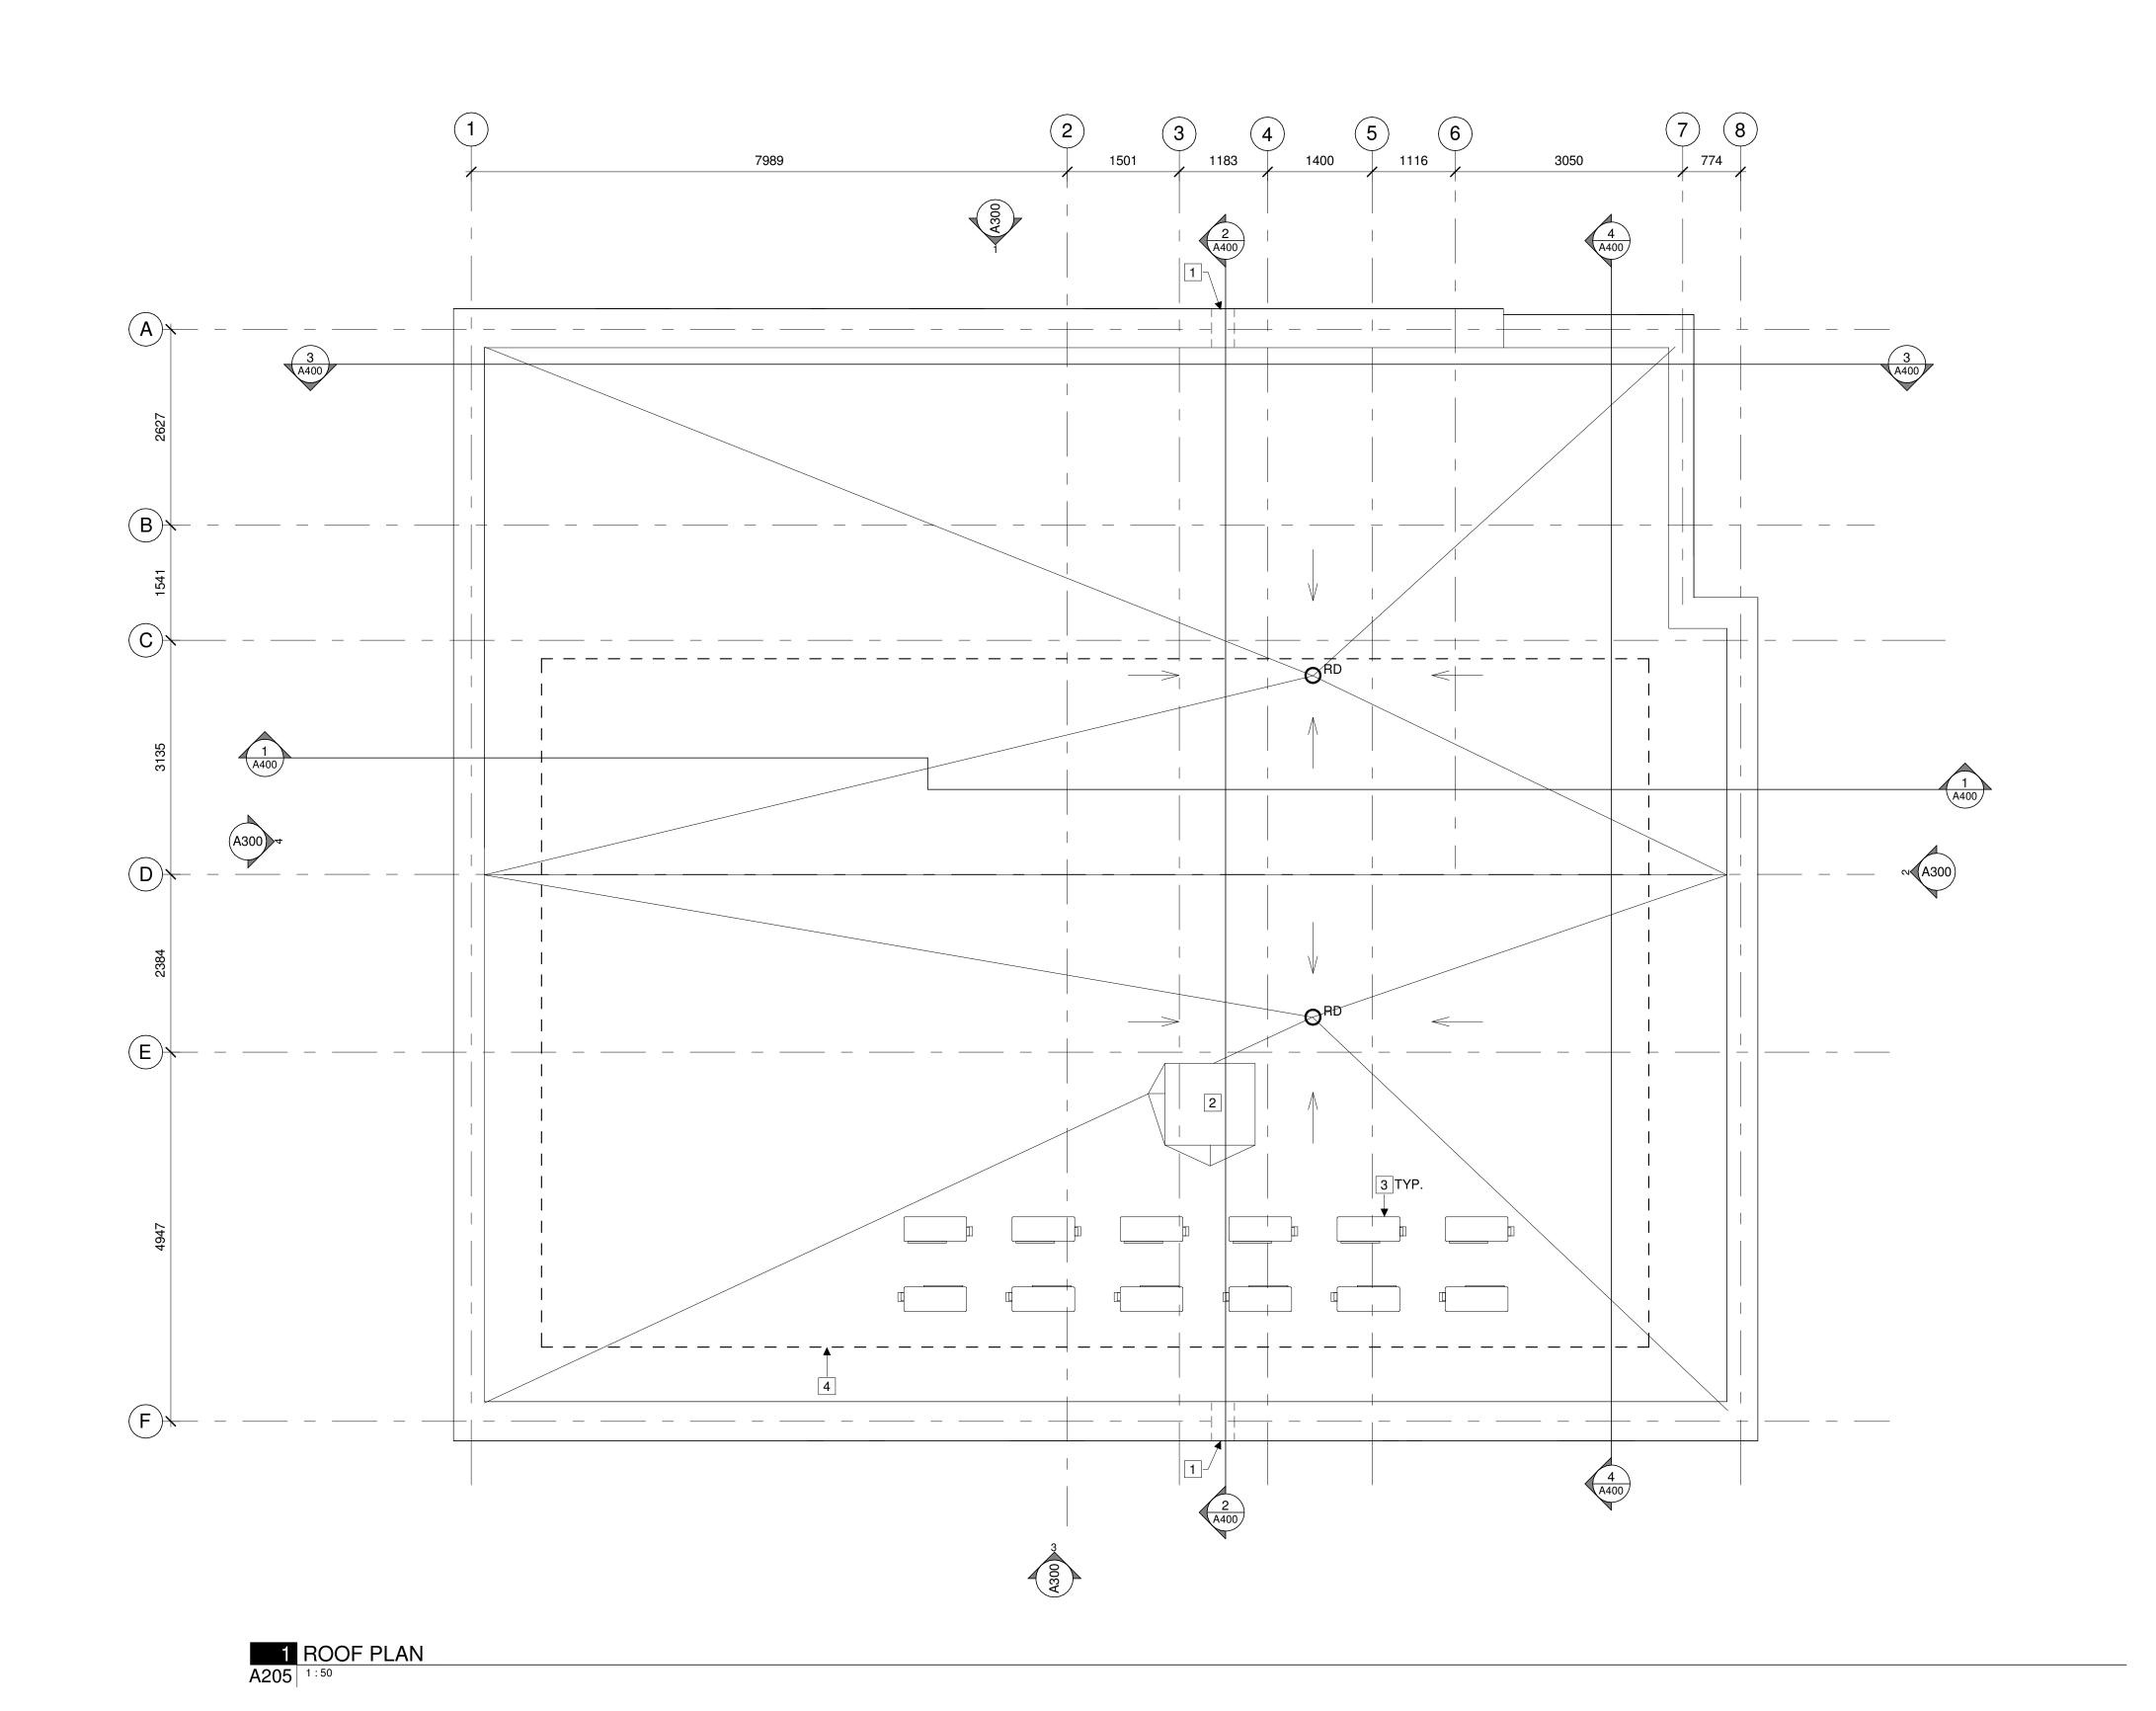

ROOF PLAN NOTES:

NOTES

ROOF PLAN KEYNOTES:

- 1 300mm WIDE PREFINISHED OVERFLOW SCUPPER
- 2 ROOF ACCESS HATCH
- 3 HEAT PUMP CONDENSOR UNIT PER MECHANICAL
- 4 AREA FOR FUTURE SOLAR ARRAY

CIVIL ENGINEER

613.564.8118 www.csv.ca

McIntosh Perry 115 Walgreen Road, R.R. 3 Carp, ON K0A 1L0 613-836-2184 www.mcintoshperry.com

STRUCTURAL ENGINEER
Cunliffe & Associates
200, 1550 Carling Ave 2nd Floor
Ottawa, ON K1Z 8S8
613-729-7242

MECHANICAL/ELECTRICAL ENGINEER
Chorley + Bisset
250 City Centre Ave.
Ottawa, ON K1R 1C7

cunliffe@cunliffe.ca

613-241-0300

email@chorley.com

CSV ARCHITECTS

sustainable design · conception écologique

190 O'Connor Street, Suite 100 Ottawa, Ontario,K2P 2R3

ROOF PLAN LEGEND:

ORD ROOF DRAIN PER MECHANICAL

→ SLOPE ARROW

STAMP

5 --/-- ISSUED FOR BUILDING PERMIT REV DATE ISSUE

1. OWNERSHIP OF THE COPYRIGHT OF THE DESIGN AND THE WORKS EXECUTED FROM THE DESIGN REMAINS WITH CSV ARCHITECTS, AND MAY NOT BE REPRODUCED IN ANY FORM WITHOUT THE WRITTEN CONSENT OF CSV ARCHITECTS.

2. THE DRAWINGS, PRESENTATIONS AND SPECIFICATIONS AS INSTRUMENTS OF SERVICE ARE AND SHALL REMAIN THE PROPERTY OF CSV ARCHITECTS. THEY ARE NOT TO BE USED BY THE CLIENT ON OTHER PROJECTS OR ON EXTENSIONS TO THIS PROJECT WITHOUT THE WRITTEN TO THIS PROJECT WITHOUT THE WRITTEN CONSENT OF CSV ARCHITECTS.

3. THIS DRAWING IS TO BE READ IN CONJUNCTION WITH ALL OTHER PROJECT DRAWINGS AND WITH ALL OTHER PROJECT DRAWINGS AND SPECIFICATIONS.

4. DO NOT SCALE DRAWINGS. CONTRACTOR SHALL BE RESPONSIBLE TO VERIFY DIMENSIONS ON SITE.

5. ALL WORK SHALL BE IN ACCORDANCE WITH THE ONTARIO BUILDING CODE AND ALL SUPPLEMENTS AND APPLICABLE MUNICIPAL REGULATIONS.

CLIENT

78 ROSEMOUNT AVE INC.

OTTAWA ONTARIO, CANADA

PROJECT

TITLE

78 ROSEMOUNT AVE.

78 Rosemount Avenue, Ottawa, ON K1Y 1P6

ROOF PLAN

PROJECT NO: 2021-1320 DRAWN: JW APPROVED: JS 1:50

DRAWING NO.

DATE PRINTED: 5/18/2022 11:09:09 AM



ELEVATION NOTES:

- 1. CONTRACTOR TO COORDINATE WITH MANUFACTURER'S SPECIFICATIONS AND INSTALLATIONS GUIDELINES FOR ALL MATERIAL SEALING, TRANSITIONS, SEPARATIONS, FLASHING DETAILS, CONNECTIONS, ANCHORAGES, ETC. CONTRACTOR TO PROVIDE DETAIL DRAWINGS OR MOCK-UP FOR ARCHITECT'S REVIEW AND APPROVAL FOR ALL SPECIAL CONDITIONS NOT SHOWN IN THE CONTRACT DOCUMENTS.
- 2. ALL CAP FLASHING TO BE _ COLOUR. ALL OTHER FLASHING TO BE TO MATCH METAL CLADDING. 3. PANEL LAYOUT APPROXIMATE. TO BE FINALIZED BY CONSULTANT ONCE MANUFACTURE HAD BEEN SELECTED.

- 1 BALCONY
- 2 1070mm HEIGHT GUARD
- 3 NON-FREEZE HOSE BIB SEE MECHANICAL
- DOOR OPERATOR PUSH BUTTON ON PEDESTAL REFER TO ELECTRICAL
- # CHARCOAL COLOUR FIBRE CEMENT PANEL SOFFIT
- # MECHANICAL LOUVER SEE MECHANICAL
- # POWER DOOR ACTUATOR BUTTON- SEE ELECTRICAL
- # DOOR C/W SIDELIGHT AND TRANSOM
- # SLOPED PATHWAY SEE CIVIL
- LOCATION OF BUILDING SIGNAGE PROVIDE 16mm PLYWOOD BACKING AS REQUIRED
- # EXHAUST VENT SEE MECHANICAL
- # OVERFLOW SCUPPER AT 150mm ABOVE ROOF DRAIN LEVEL
- # WALL MOUNTED EXTERIOR LIGHT FIXTURE SEE ELECTRICAL
- # ALUMINUM TRIPLE GLAZED STOREFRONT
- BRICK SOLDIER COURSE
- # PREFINISHED METAL THRU-WALL FLASHING C/W DRIP EDGE
- # 150mm PREFINISHED METAL CAP FLASHING C/W DRIP EDGE
- # LOCKABLE FROST PROOF HOSE BIB
- 1070mm HIGH GALVANIZED METAL GUARD RAIL SECURED TO PARAPET. SEE STRUCTURAL FOR DETAIL.
- # MECHANICAL EQUIPMENT SEE MECHANICAL
- # PREFINISHED METAL REVEAL
- # 12.7mm BRICK CORBEL SEE 4/A300 FOR PATTERN
- 200mm FOUNDATION UPSTAND / CEMENT FACED INSULATION ABOVE GRADE
- # PRECAST CONCRETE WINDOW SILL
- # FIRE DEPARTMENT CONNECTION SEE MECHANICAL
- # INTAKE VENT SEE MECHANICAL
- # EXPANSION JOINTS W/ BACKER ROD AND SEALANT
- # STEEL ANGLE LINTEL SEE STRUCTURAL
- # LINTEL OUTRIGGER SEE STRUCTURAL
- # APPROX. GRADE SEE CIVIL
- # CURTAIN WALL FRAME MOUNTED DOOR OPERATOR BUTTON. WIRES TO BE RUN INSIDE FRAME - SEE ELECTRICAL
- # FROSTED FILM SEE WINDOW SCHEDULE
- # GAS METER SEE MECHANICAL
- # WOOD FRAMED CANOPY W/ TENSION CABLE- SEE STRUCTURAL
- # MUNICIPAL NUMBERING AT 2-4M ABOVE GRADE, MOUNTED TO FACE OF BRICK W/ FASTNERS W/ COLORED-HEADS TO MATCH SIGN COLOR

ELEVATION LEGEND:

HATCH PATTERNS SHOWN ARE FOR GRAPHIC PURPOSES ONLY AND SHOULD BE COORDINATED WITH ACTUAL SPECIFIED MATERIALS.

SYMBOL DESCRIPTION BRICK VENEER MANUFACTURER: COLOUR:



FIBRE CEMENT PANEL MANUFACTURER:

COLOUR:

78 ROSEMOUNT AVE.

4 05/13/2022 ISSUED FOR SITE PLAN CONTROL

1. OWNERSHIP OF THE COPYRIGHT OF THE DESIGN

AND THE WORKS EXECUTED FROM THE DESIGN REMAINS WITH CSV ARCHITECTS, AND MAY NOT BE REPRODUCED IN ANY FORM WITHOUT THE WRITTEN CONSENT OF CSV ARCHITECTS.

2. THE DRAWINGS, PRESENTATIONS AND

SPECIFICATIONS AS INSTRUMENTS OF SERVICE

ARE AND SHALL REMAIN THE PROPERTY OF CSV

ARCHITECTS. THEY ARE NOT TO BE USED BY THE

CLIENT ON OTHER PROJECTS OR ON EXTENSIONS

3. THIS DRAWING IS TO BE READ IN CONJUNCTION

4. DO NOT SCALE DRAWINGS. CONTRACTOR SHALL

BE RESPONSIBLE TO VERIFY DIMENSIONS ON SITE.

5. ALL WORK SHALL BE IN ACCORDANCE WITH THE

ONTARIO BUILDING CODE AND ALL SUPPLEMENTS
AND APPLICABLE MUNICIPAL REGULATIONS.

78 ROSEMOUNT AVE

TO THIS PROJECT WITHOUT THE WRITTEN

WITH ALL OTHER PROJECT DRAWINGS AND

CONSENT OF CSV ARCHITECTS.

SPECIFICATIONS.

CLIENT

INC.

OTTAWA

PROJECT

TITLE

ONTARIO, CANADA

REV DATE ISSUE

CSV ARCHITECTS

sustainable design · conception écologique

190 O'Connor Street, Suite 100

Ottawa, Ontario,K2P 2R3

613.564.8118

www.csv.ca

STRUCTURAL ENGINEER

200, 1550 Carling Ave 2nd Floor

MECHANICAL/ELECTRICAL ENGINEER

Cunliffe & Associates

Ottawa, ON K1Z 8S8

cunliffe@cunliffe.ca

Chorley + Bisset 250 City Centre Ave.

613-241-0300 email@chorley.com

CIVIL ENGINEER

Carp, ON K0A 1L0 613-836-2184

www.mcintoshperry.com

115 Walgreen Road, R.R. 3

McIntosh Perry

STAMP

Ottawa, ON K1R 1C7

613-729-7242

78 Rosemount Avenue, Ottawa, ON K1Y 1P6


EXTERIOR ELEVATIONS


PROJECT NO: 2021-1320 DRAWN: JW APPROVED: JS As indicated


DATE PRINTED: 5/18/2022 11:09:14 AM


REV


DRAWING NO.

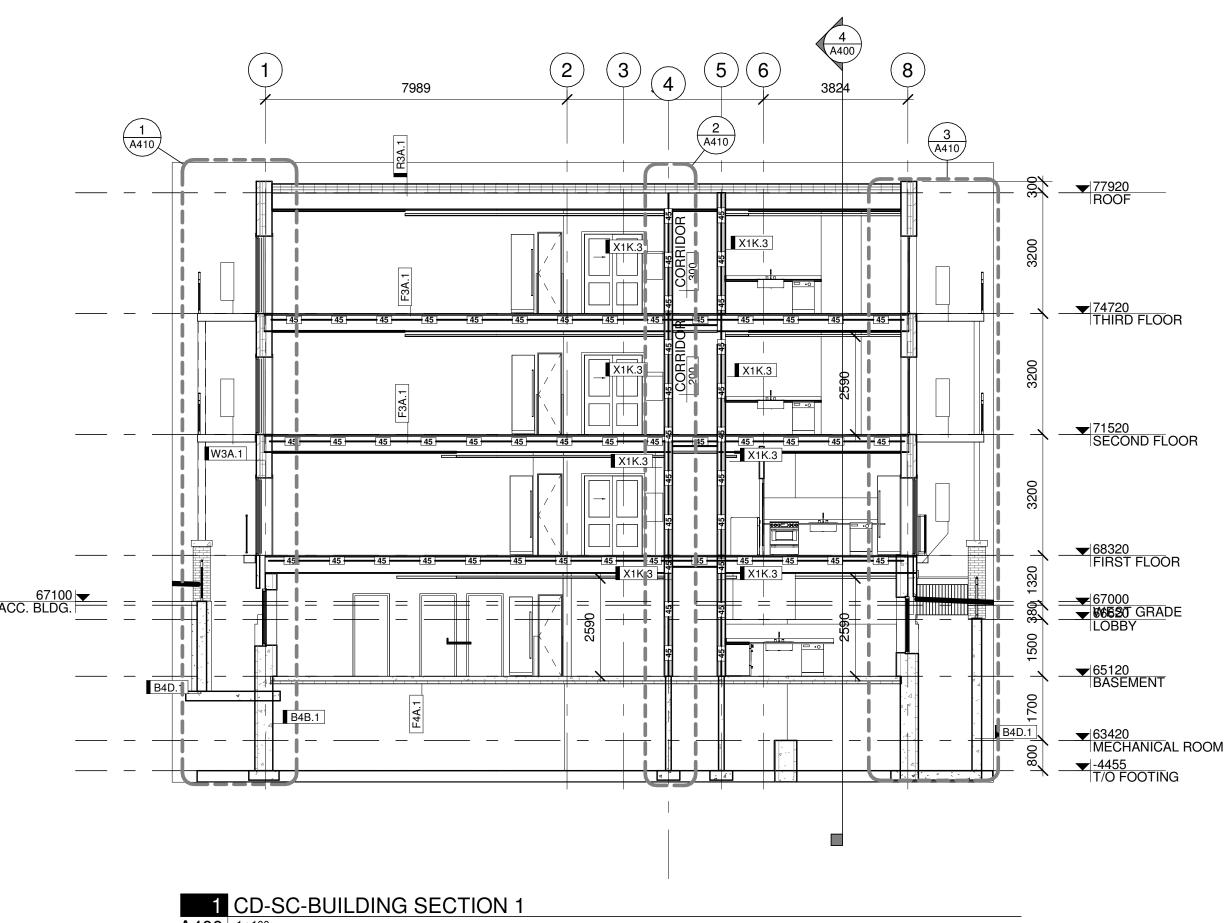

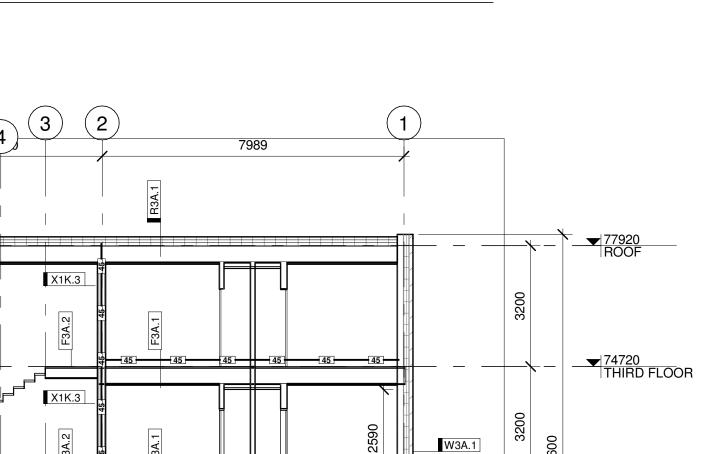

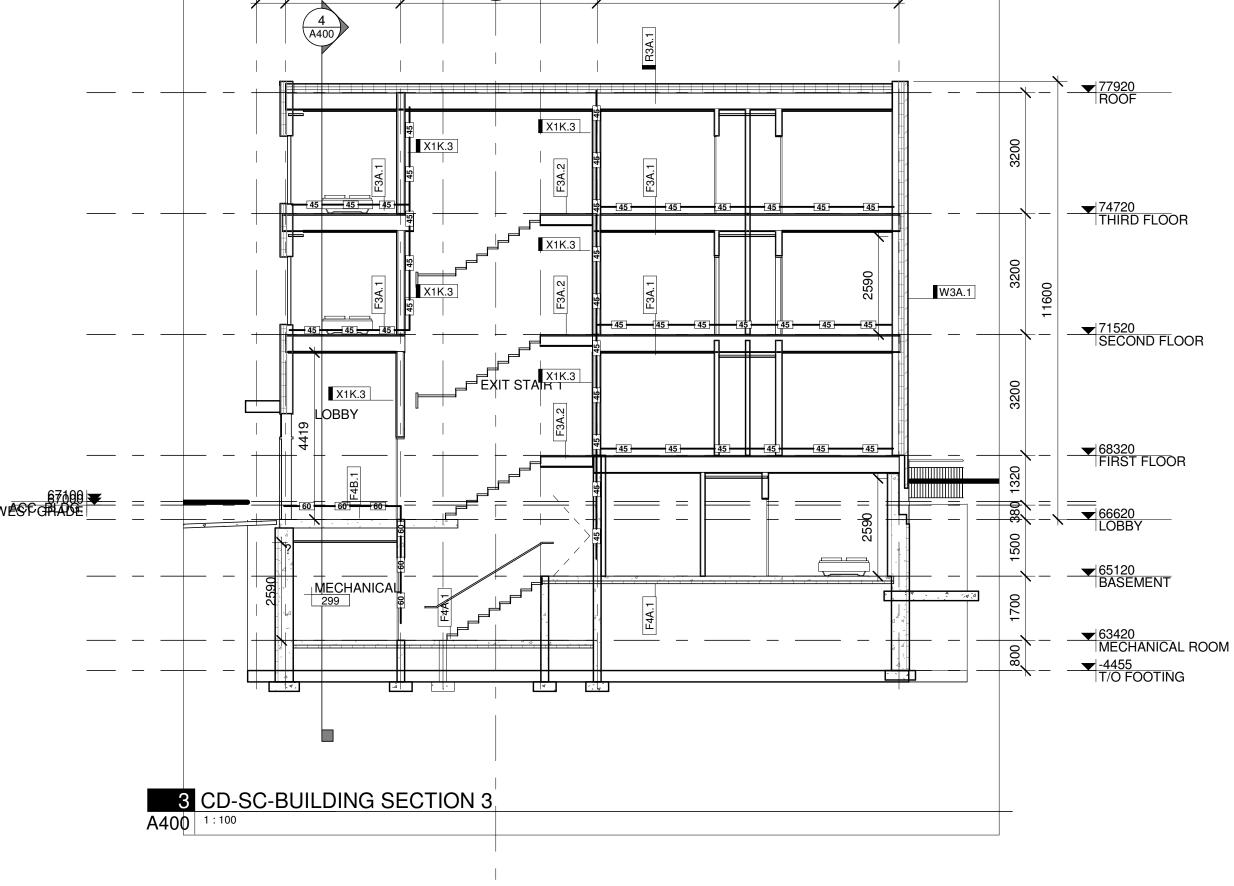

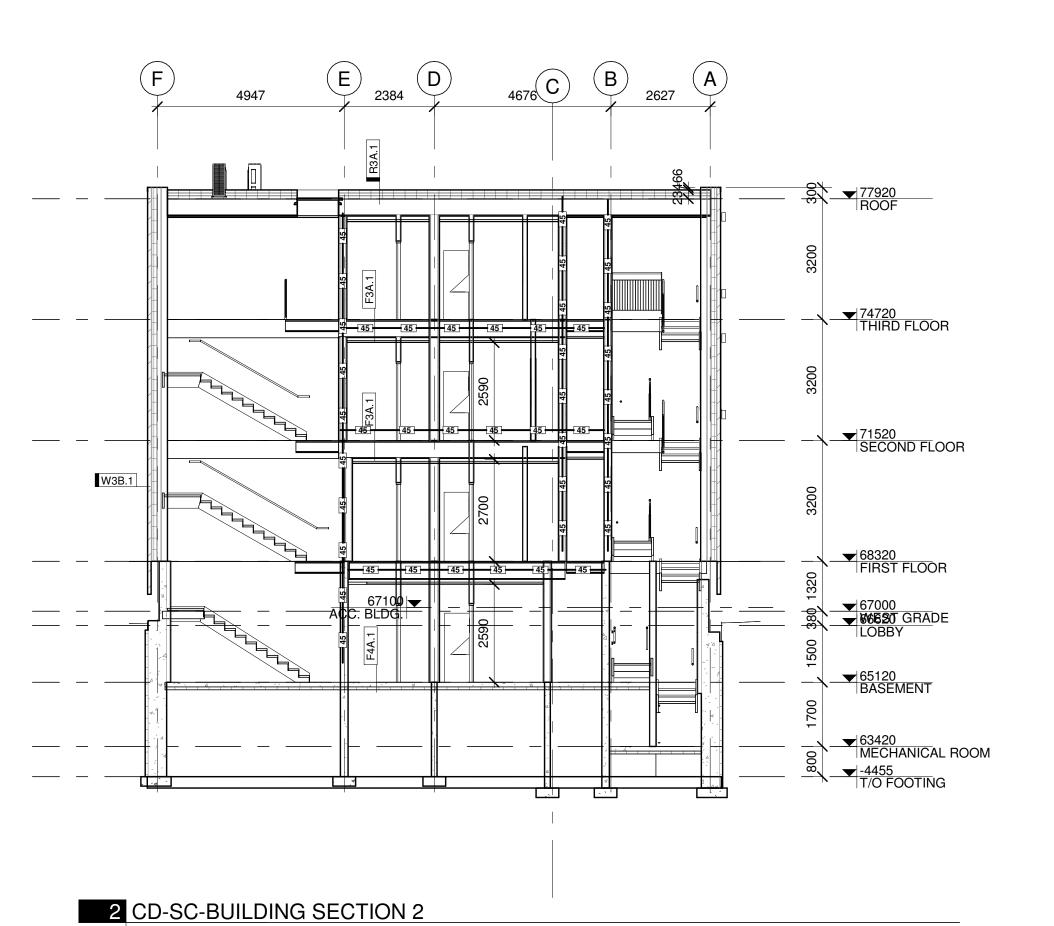

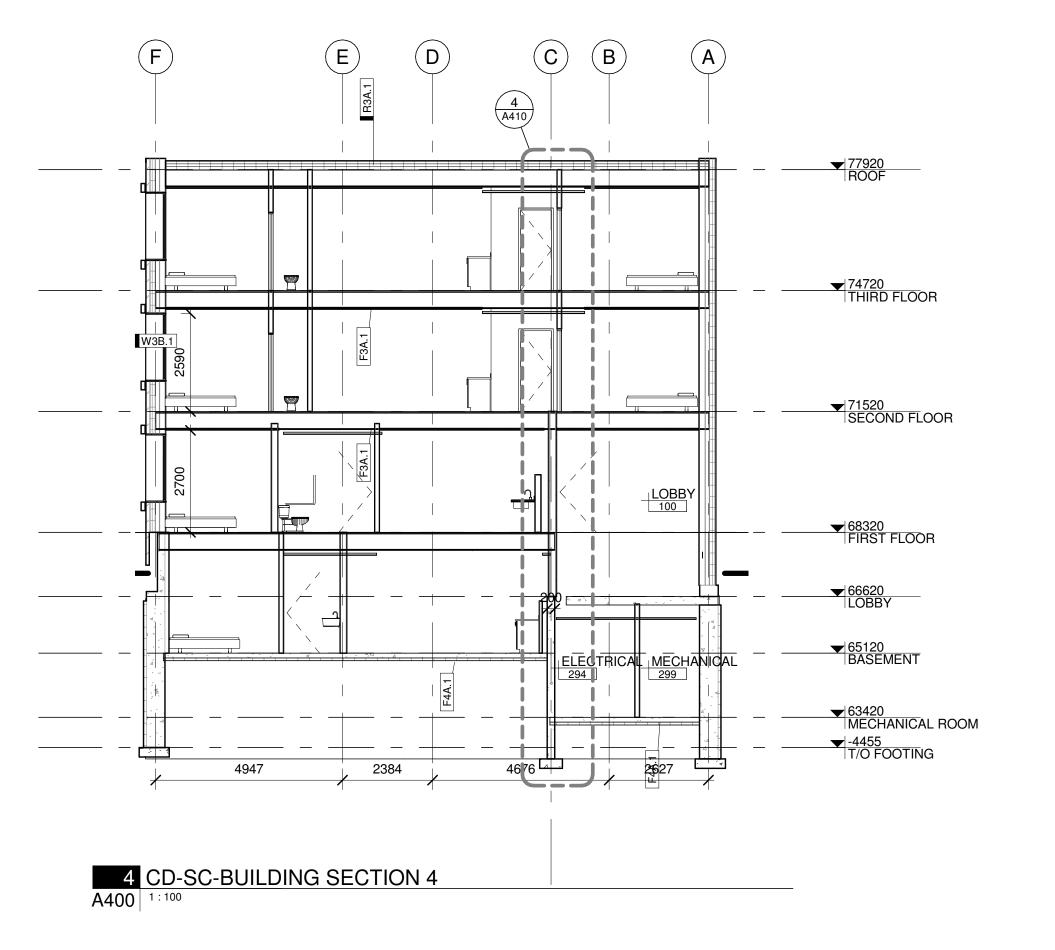

GENERAL BUILDING SECTION NOTES:

NOTE FOR USER: DRAWINGS OF A SIMILAR FUNCTION ie. FLOOR PLAN, ELEVATION, SECTION, INTERIOR ELEVATION ARE TO HAVE COMMON NOTES AND LEGENDS. INDIVIDUAL LEGENDS SHOULD NOT BE CREATED FOR EACH SHEET.

CSV ARCHITECTS

sustainable design · conception écologique

613.564.8118 190 O'Connor Street, Suite 100 Ottawa, Ontario,K2P 2R3 www.csv.ca

STRUCTURAL ENGINEER Cunliffe & Associates 200, 1550 Carling Ave 2nd Floor Ottawa, ON K1Z 8S8 613-729-7242 cunliffe@cunliffe.ca

MECHANICAL/ELECTRICAL ENGINEER Chorley + Bisset 250 City Centre Ave. Ottawa, ON K1R 1C7 613-241-0300 email@chorley.com

CIVIL ENGINEER McIntosh Perry 115 Walgreen Road, R.R. 3 Carp, ON K0A 1L0 613-836-2184 www.mcintoshperry.com

BUILDING SECTION KEYNOTES:

- # MECHANICAL SHAFT
- # VERTICAL PLATFORM LIFT
- # FIRE ALARM CONTROL PANEL
- # MAILBOXES
- # BALCONY
- # WINDOW WELL
- # JULIETTE BALCONY

LEGEND:

FIRE RATING LEGEND:

45MIN FIRE RESISTANCE RATING 60MIN FIRE RESISTANCE RATING 90MIN FIRE RESISTANCE RATING

REV DATE ISSUE

STAMP

NOTES 1. OWNERSHIP OF THE COPYRIGHT OF THE DESIGN AND THE WORKS EXECUTED FROM THE DESIGN
AND THE WORKS EXECUTED FROM THE DESIGN
REMAINS WITH CSV ARCHITECTS, AND MAY NOT BE
REPRODUCED IN ANY FORM WITHOUT THE WRITTEN
CONSENT OF CSV ARCHITECTS.
2. THE DRAWINGS, PRESENTATIONS AND SPECIFICATIONS AS INSTRUMENTS OF SERVICE ARE AND SHALL REMAIN THE PROPERTY OF CSV ARCHITECTS. THEY ARE NOT TO BE USED BY THE CLIENT ON OTHER PROJECTS OR ON EXTENSIONS TO THIS PROJECT WITHOUT THE WRITTEN CONSENT OF CSV ARCHITECTS. 3. THIS DRAWING IS TO BE READ IN CONJUNCTION WITH ALL OTHER PROJECT DRAWINGS AND SPECIFICATIONS. 4. DO NOT SCALE DRAWINGS. CONTRACTOR SHALL

BE RESPONSIBLE TO VERIFY DIMENSIONS ON SITE.

5 --/-- ISSUED FOR BUILDING PERMIT 3 03/11/2022 ISSUED FOR COORDINATION

5. ALL WORK SHALL BE IN ACCORDANCE WITH THE ONTARIO BUILDING CODE AND ALL SUPPLEMENTS AND APPLICABLE MUNICIPAL REGULATIONS.

CLIENT

78 ROSEMOUNT AVE INC.

OTTAWA ONTARIO, CANADA

PROJECT

TITLE


78 ROSEMOUNT AVE.

78 Rosemount Avenue, Ottawa, ON K1Y 1P6

BUILDING SECTIONS

PROJECT NO: 2021-1320 DRAWN: JW APPROVED: JS As indicated DATE PRINTED: 5/18/2022 11:09:18 AM

DRAWING NO.

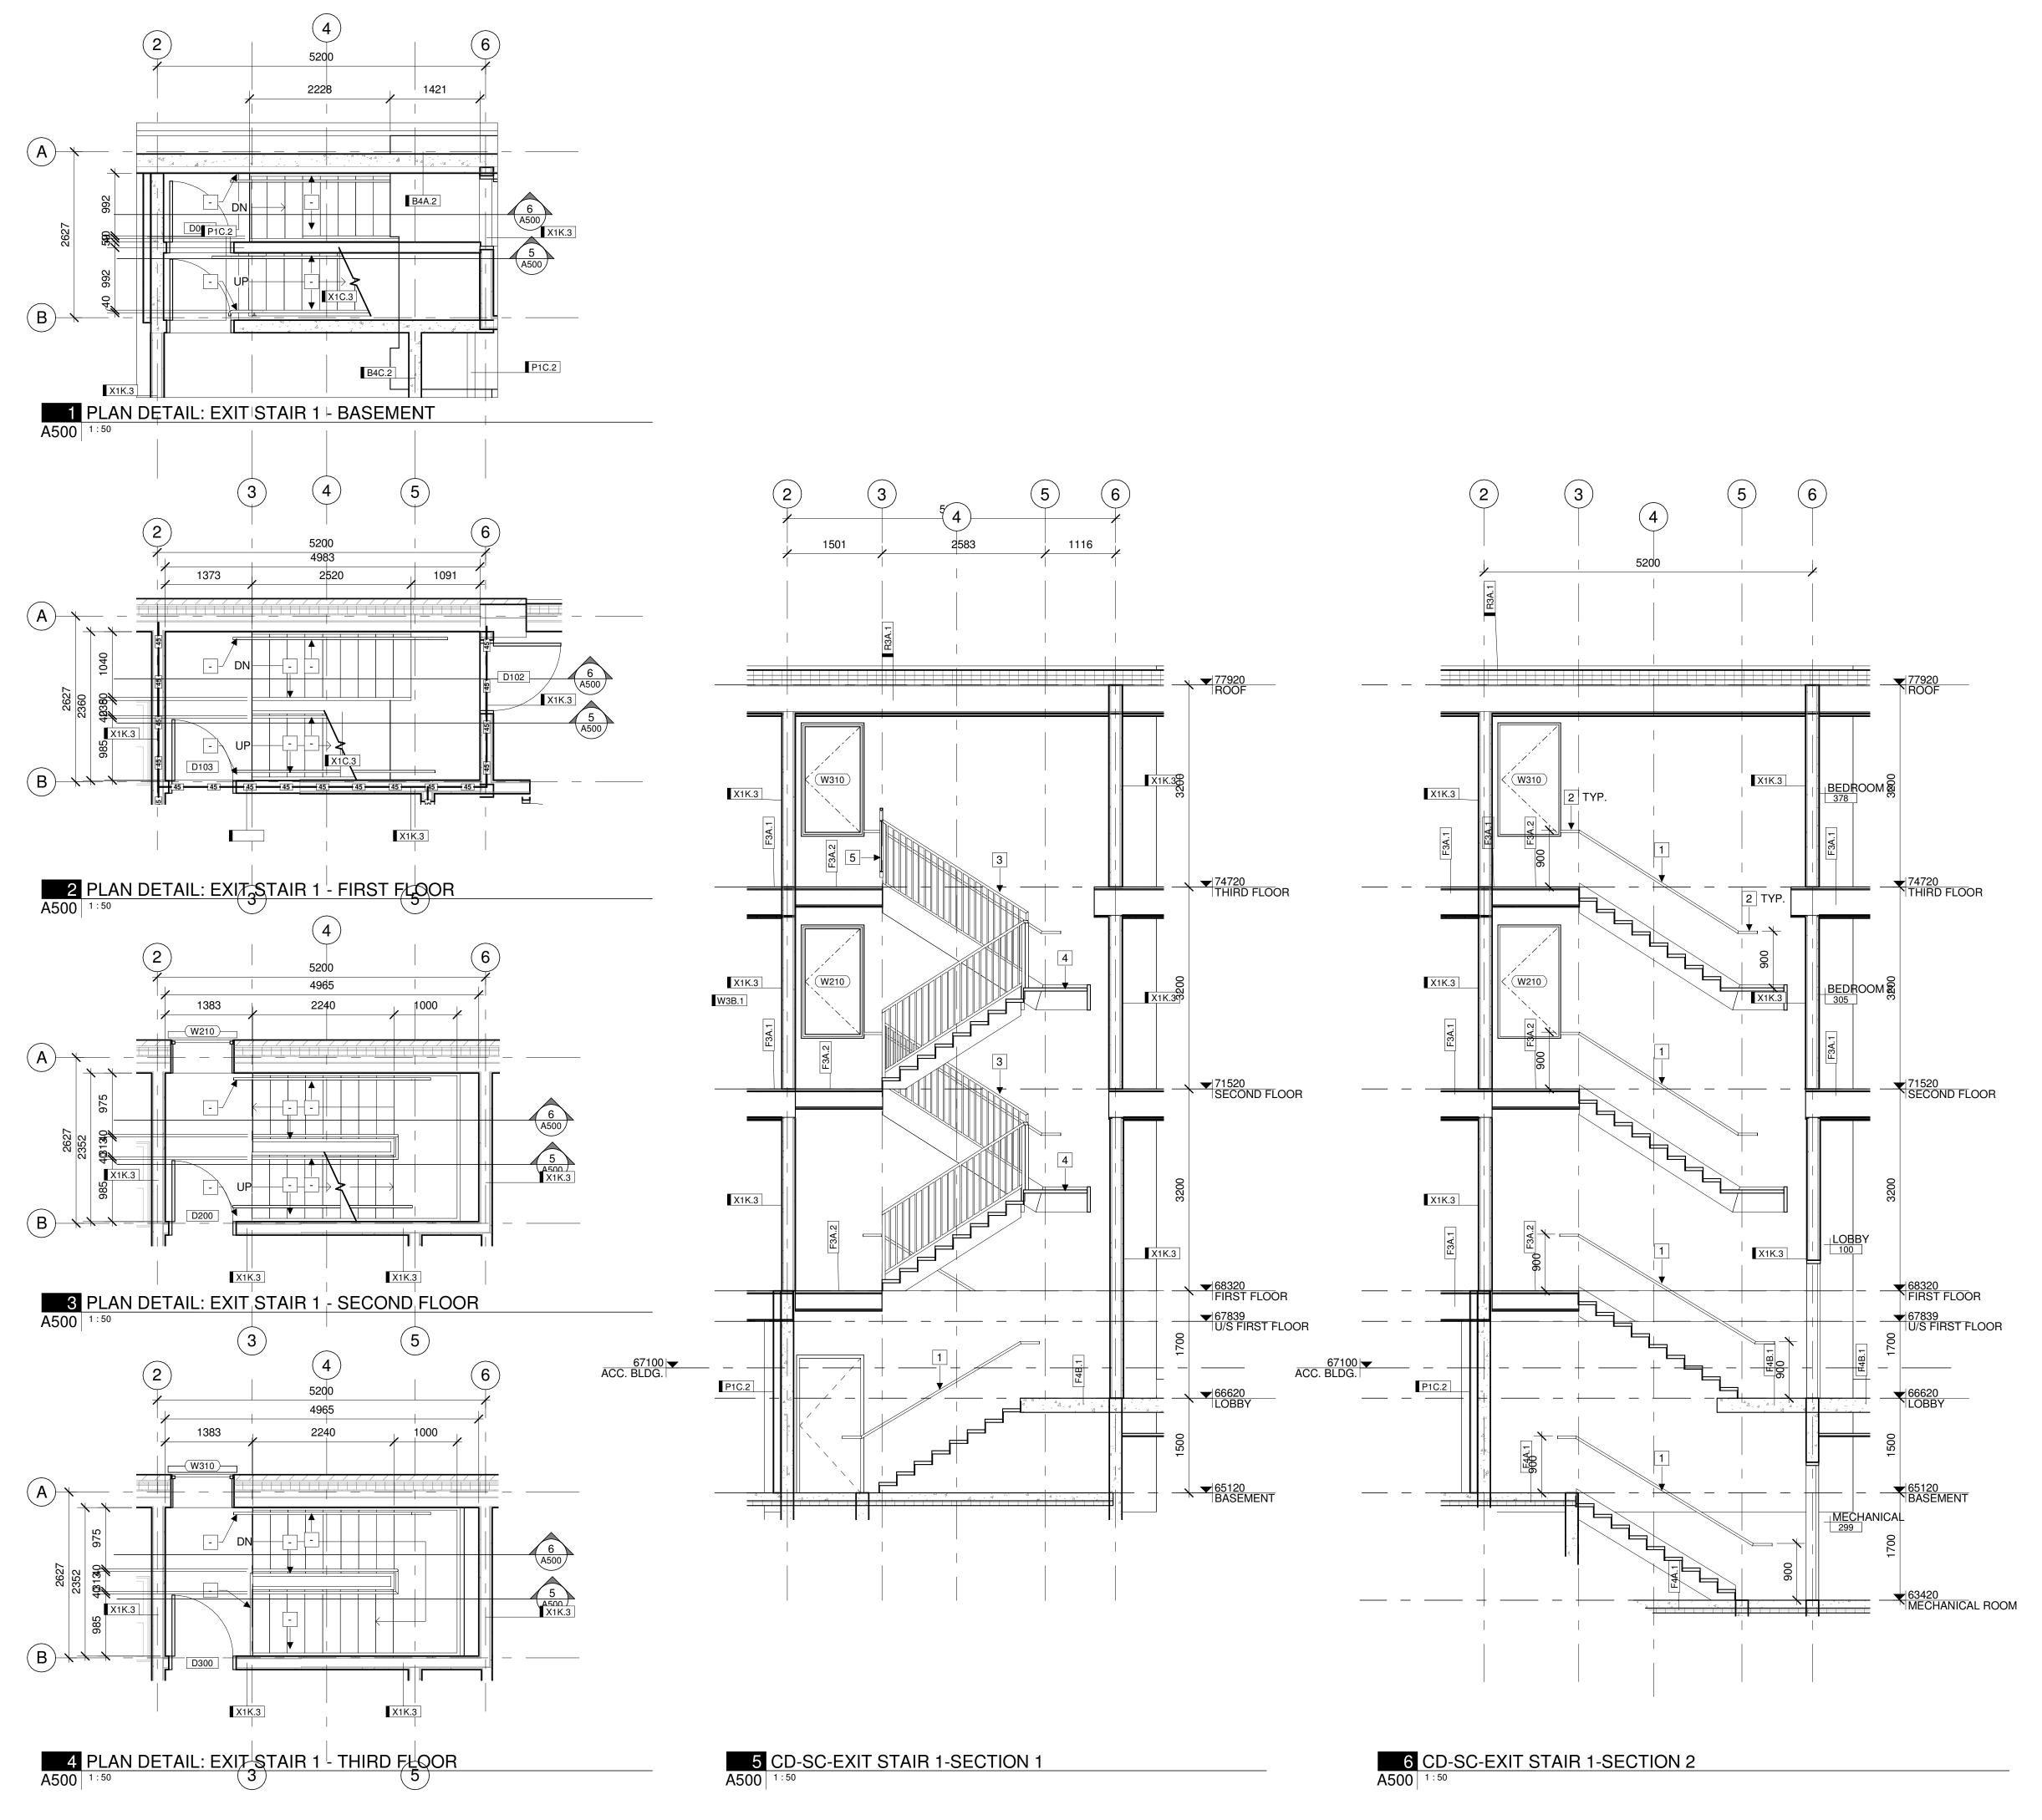

GENERAL NOTES:

- DEMARCATE LEADING EDGE OF TREADS AND LEADING EDGE
 OF LANDING WITH COLOUR CONTRAST/DISTINCTIVE VISUAL
 DATTERN

 OF LEADING

 OF LEADING EDGE OF TREADS AND LEADING EDGE
 OF LANDING WITH COLOUR CONTRAST/DISTINCTIVE VISUAL
 DATTERN

 OF LEADING EDGE OF TREADS AND LEADING EDGE
 OF LANDING WITH COLOUR CONTRAST/DISTINCTIVE VISUAL
 DATTERN

 OF LANDING WITH COLOUR CONTRAST/D
- 2. CONTRACTOR TO PROVIDE ENGINEERED STAMPED SHOP DRAWINGS OF STAIRS, HANDRAILS AND GUARDS SEALED AND SIGNED BY A PROFESSIONAL STRUCTURAL ENGINEER LICENSED IN THE PROVINCE OF ONTARIO.
- LICENSED IN THE PROVINCE OF ONTARIO.

 3. WOOD FRAMED STAIR TREAD AND RISERS. STAIR FINISH PER FLOOR FINISH PLAN
- 4. PROVIDE 50mm MIN. CLEARANCE BETWEEN HANDRAIL AND ANY ADJACENT SURFACE
- 5. ALL METAL COMPONENTS FOR GUARDS AND HANDRAILS TO BE PRIMED AND PAINTED. COLOUR PER FINISH PLANS

STAIR KEYNOTES:

- 38mm Ø STEEL PIPE WALL MOUNTED HANDRAIL. PROVIDE 50mm CLEARANCE BETWEEN HANDRAIL AND ADJACENT SURFACE
- 2 300mm HANDRAIL EXTENSION (TYP.)
- 1070mm HIGH STEEL GUARD C/W 16mm Ø BALUSTERS @ 100mm O.C. CONNECTED TO STRINGERS WITH MOUNTING PLATE
- 4 INTERMEDIATE LANDING SEE STRUCTURAL
- 5 1070mm HIGH STEEL GUARD C/W 16mm Ø BALUSTERS @ 100mm O.C.
- 6 TACTILE INDICATOR
- DEMARCATE LEADING EDGE OF TREADS AND LEADING EDGE OR LANDING WITH COLOUR CONTRAST / DISTINCTIVE VISUAL PATTERN (TYP)
- PROVIDE MAX. 6mm CLEARANCE BETWEEN FIRE RATED WALL SURFACE AND STAIR FRAMING. PROVIDE FIRE RATED SEALANT AT ALL STRUCTURAL AND WALL PENETRATIONS, TYP.

CSV ARCHITECTS

sustainable design · conception écologique
613.564.8118 190 O'Connor Street, Suite 100

www.csv.ca Ottawa, Ontario,K2P 2R3

STRUCTURAL ENGINEER
Cunliffe & Associates

200, 1550 Carling Ave 2nd Floor Ottawa, ON K1Z 8S8 613-729-7242 cunliffe@cunliffe.ca

MECHANICAL/ELECTRICAL ENGINEER Chorley + Bisset 250 City Centre Ave. Ottawa, ON K1R 1C7 613-241-0300 email@chorley.com

CIVIL ENGINEER
McIntosh Perry
115 Walgreen Road, R.R. 3
Carp, ON K0A 1L0
613-836-2184
www.mcintoshperry.com

STAMP

REV DATE ISSUE



.....

1. OWNERSHIP OF THE COPYRIGHT OF THE DESIGN AND THE WORKS EXECUTED FROM THE DESIGN REMAINS WITH CSV ARCHITECTS, AND MAY NOT BE REPRODUCED IN ANY FORM WITHOUT THE WRITTEN CONSENT OF CSV ARCHITECTS.

2. THE DRAWINGS, PRESENTATIONS AND SPECIFICATIONS AS INSTRUMENTS OF SERVICE ARE AND SHALL REMAIN THE PROPERTY OF CSV ARCHITECTS. THEY ARE NOT TO BE USED BY THE CLIENT ON OTHER PROJECTS OR ON EXTENSIONS TO THIS PROJECT WITHOUT THE WRITTEN CONSENT OF CSV ARCHITECTS.

3. THIS DRAWING IS TO BE READ IN CONJUNCTION WITH ALL OTHER PROJECT DRAWINGS AND SPECIFICATIONS.

4. DO NOT SCALE DRAWINGS. CONTRACTOR SHALL BE RESPONSIBLE TO VERIFY DIMENSIONS ON SITE.

5. ALL WORK SHALL BE IN ACCORDANCE WITH THE ONTARIO BUILDING CODE AND ALL SUPPLEMENTS AND APPLICABLE MUNICIPAL REGULATIONS.

CLIENT

78 ROSEMOUNT AVE INC.

OTTAWA ONTARIO, CANADA

PROJECT

TITLE

78 ROSEMOUNT AVE.


78 Rosemount Avenue, Ottawa, ON K1Y 1P6

EXIT STAIR 1 DETAILS

DATE PRINTED: 5/18/2022 11:09:24 AM

PROJECT NO: 2021-1320
DRAWN: JW
APPROVED: JS
SCALE: As indicated

REV

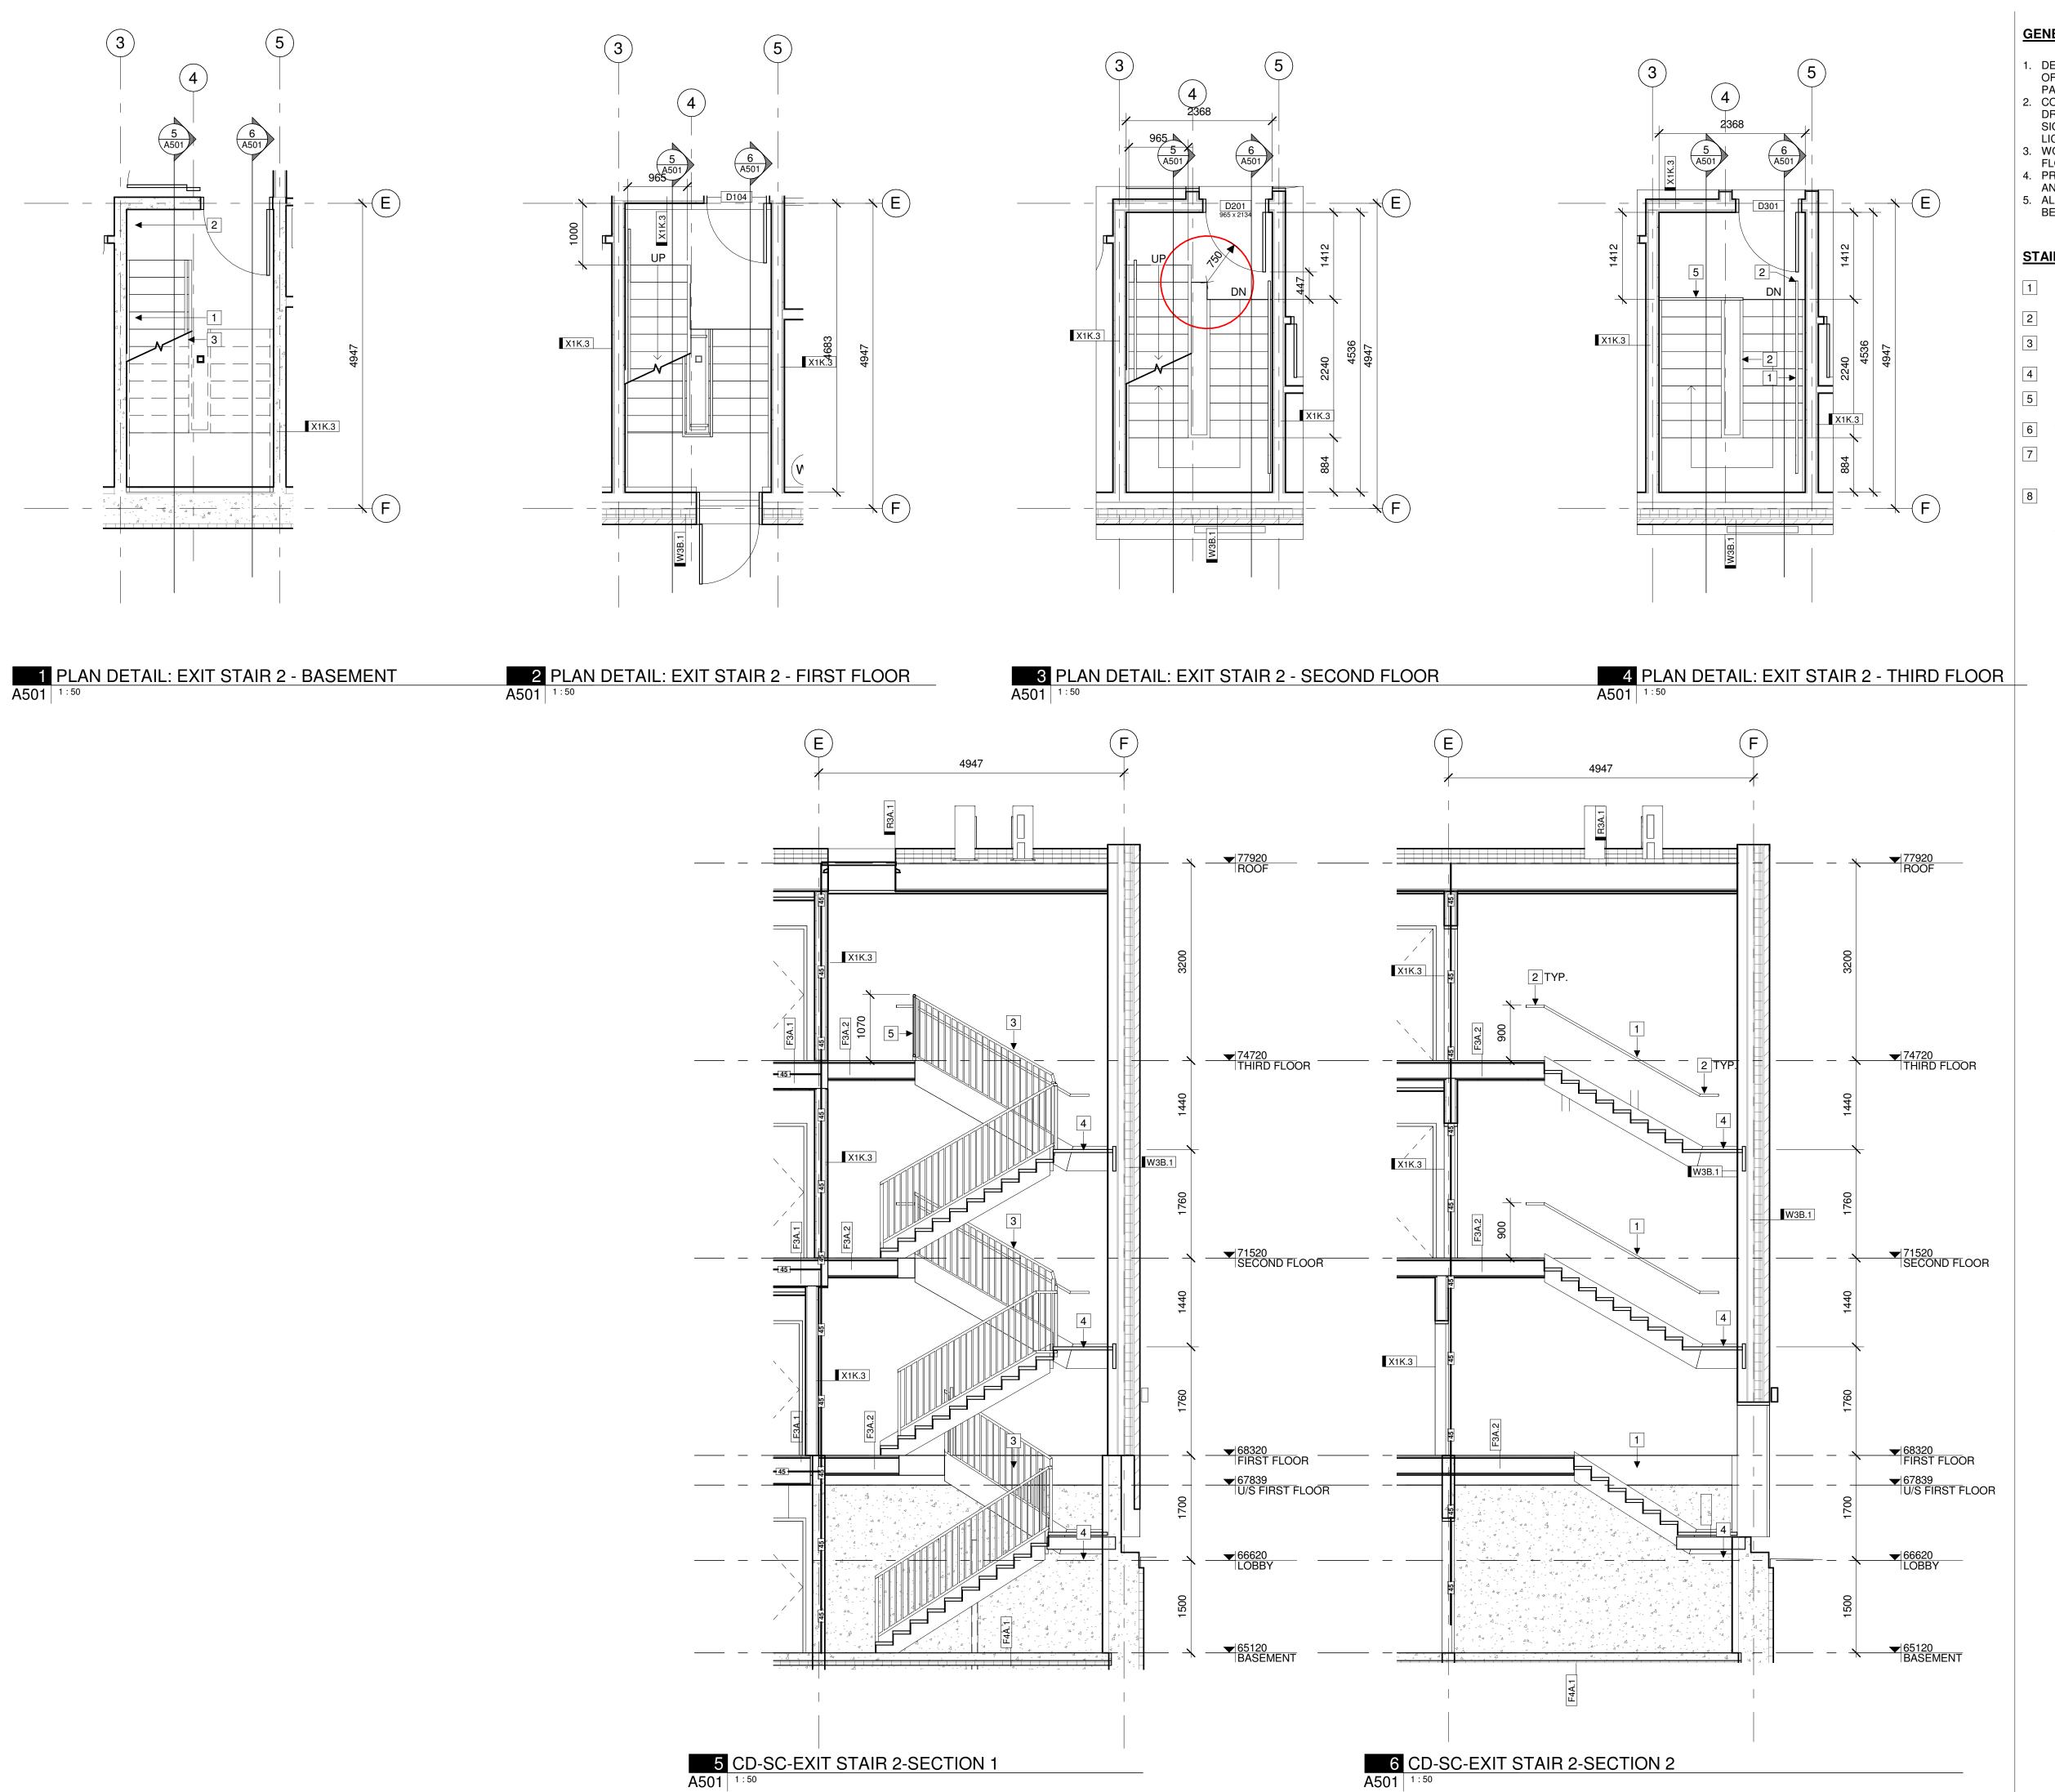

6 CD-SC-EXIT STAIR 2-SECTION 2

GENERAL NOTES:

1. DEMARCATE LEADING EDGE OF TREADS AND LEADING EDGE OF LANDING WITH COLOUR CONTRAST/DISTINCTIVE VISUAL

2. CONTRACTOR TO PROVIDE ENGINEERED STAMPED SHOP DRAWINGS OF STAIRS, HANDRAILS AND GUARDS SEALED AND SIGNED BY A PROFESSIONAL STRUCTURAL ENGINEER LICENSED IN THE PROVINCE OF ONTARIO.

3. WOOD FRAMED STAIR TREAD AND RISERS. STAIR FINISH PER FLOOR FINISH PLAN

4. PROVIDE 50mm MIN. CLEARANCE BETWEEN HANDRAIL AND ANY ADJACENT SURFACE

5. ALL METAL COMPONENTS FOR GUARDS AND HANDRAILS TO BE PRIMED AND PAINTED. COLOUR PER FINISH PLANS

STAIR KEYNOTES:

38mm Ø STEEL PIPE WALL MOUNTED HANDRAIL. PROVIDE 50mm CLEARANCE BETWEEN HANDRAIL AND ADJACENT SURFACE

2 300mm HANDRAIL EXTENSION (TYP.)

3 1070mm HIGH STEEL GUARD C/W 16mm Ø BALUSTERS @ 100mm O.C. CONNECTED TO STRINGERS WITH MOUNTING PLATE

4 INTERMEDIATE LANDING - SEE STRUCTURAL

5 1070mm HIGH STEEL GUARD C/W 16mm Ø BALUSTERS @ 100mm O.C.

6 TACTILE INDICATOR

DEMARCATE LEADING EDGE OF TREADS AND LEADING EDGE OR LANDING WITH COLOUR CONTRAST / DISTINCTIVE VISUAL PATTERN (TYP)

PROVIDE MAX. 6mm CLEARANCE BETWEEN FIRE RATED WALL SURFACE AND STAIR FRAMING. PROVIDE FIRE RATED SEALANT AT ALL STRUCTURAL AND WALL PENETRATIONS,

CSV ARCHITECTS

sustainable design · conception écologique

613.564.8118 190 O'Connor Street, Suite 100 Ottawa, Ontario,K2P 2R3 www.csv.ca

STRUCTURAL ENGINEER Cunliffe & Associates 200, 1550 Carling Ave 2nd Floor Ottawa, ON K1Z 8S8 613-729-7242 cunliffe@cunliffe.ca

MECHANICAL/ELECTRICAL ENGINEER Chorley + Bisset 250 City Centre Ave. Ottawa, ON K1R 1C7 613-241-0300 email@chorley.com

CIVIL ENGINEER McIntosh Perry 115 Walgreen Road, R.R. 3 Carp, ON K0A 1L0 613-836-2184 www.mcintoshperry.com

STAMP

REV DATE ISSUE



1. OWNERSHIP OF THE COPYRIGHT OF THE DESIGN AND THE WORKS EXECUTED FROM THE DESIGN REMAINS WITH CSV ARCHITECTS, AND MAY NOT BE REPRODUCED IN ANY FORM WITHOUT THE WRITTEN CONSENT OF CSV ARCHITECTS.

2. THE DRAWINGS, PRESENTATIONS AND SPECIFICATIONS AS INSTRUMENTS OF SERVICE ARE AND SHALL REMAIN THE PROPERTY OF CSV ARCHITECTS. THEY ARE NOT TO BE USED BY THE CLIENT ON OTHER PROJECTS OR ON EXTENSIONS CLIENT ON OTHER PROJECTS OR ON EXTENSIONS TO THIS PROJECT WITHOUT THE WRITTEN CONSENT OF CSV ARCHITECTS.

3. THIS DRAWING IS TO BE READ IN CONJUNCTION WITH ALL OTHER PROJECT DRAWINGS AND SPECIFICATIONS.

4. DO NOT SCALE DRAWINGS. CONTRACTOR SHALL BE RESPONSIBLE TO VERIFY DIMENSIONS ON SITE.

5. ALL WORK SHALL BE IN ACCORDANCE WITH THE ONTARIO BUILDING CODE AND ALL SUPPLEMENTS AND APPLICABLE MUNICIPAL REGULATIONS.

CLIENT

78 ROSEMOUNT AVE INC.

OTTAWA ONTARIO, CANADA

PROJECT

78 ROSEMOUNT AVE.


78 Rosemount Avenue, Ottawa, ON K1Y 1P6 TITLE


EXIT STAIR 2 DETAILS

PROJECT NO: 2021-1320 DRAWN: APPROVED: JS As indicated DATE PRINTED: 5/18/2022 11:09:27 AM

A501

DRAWING NO.

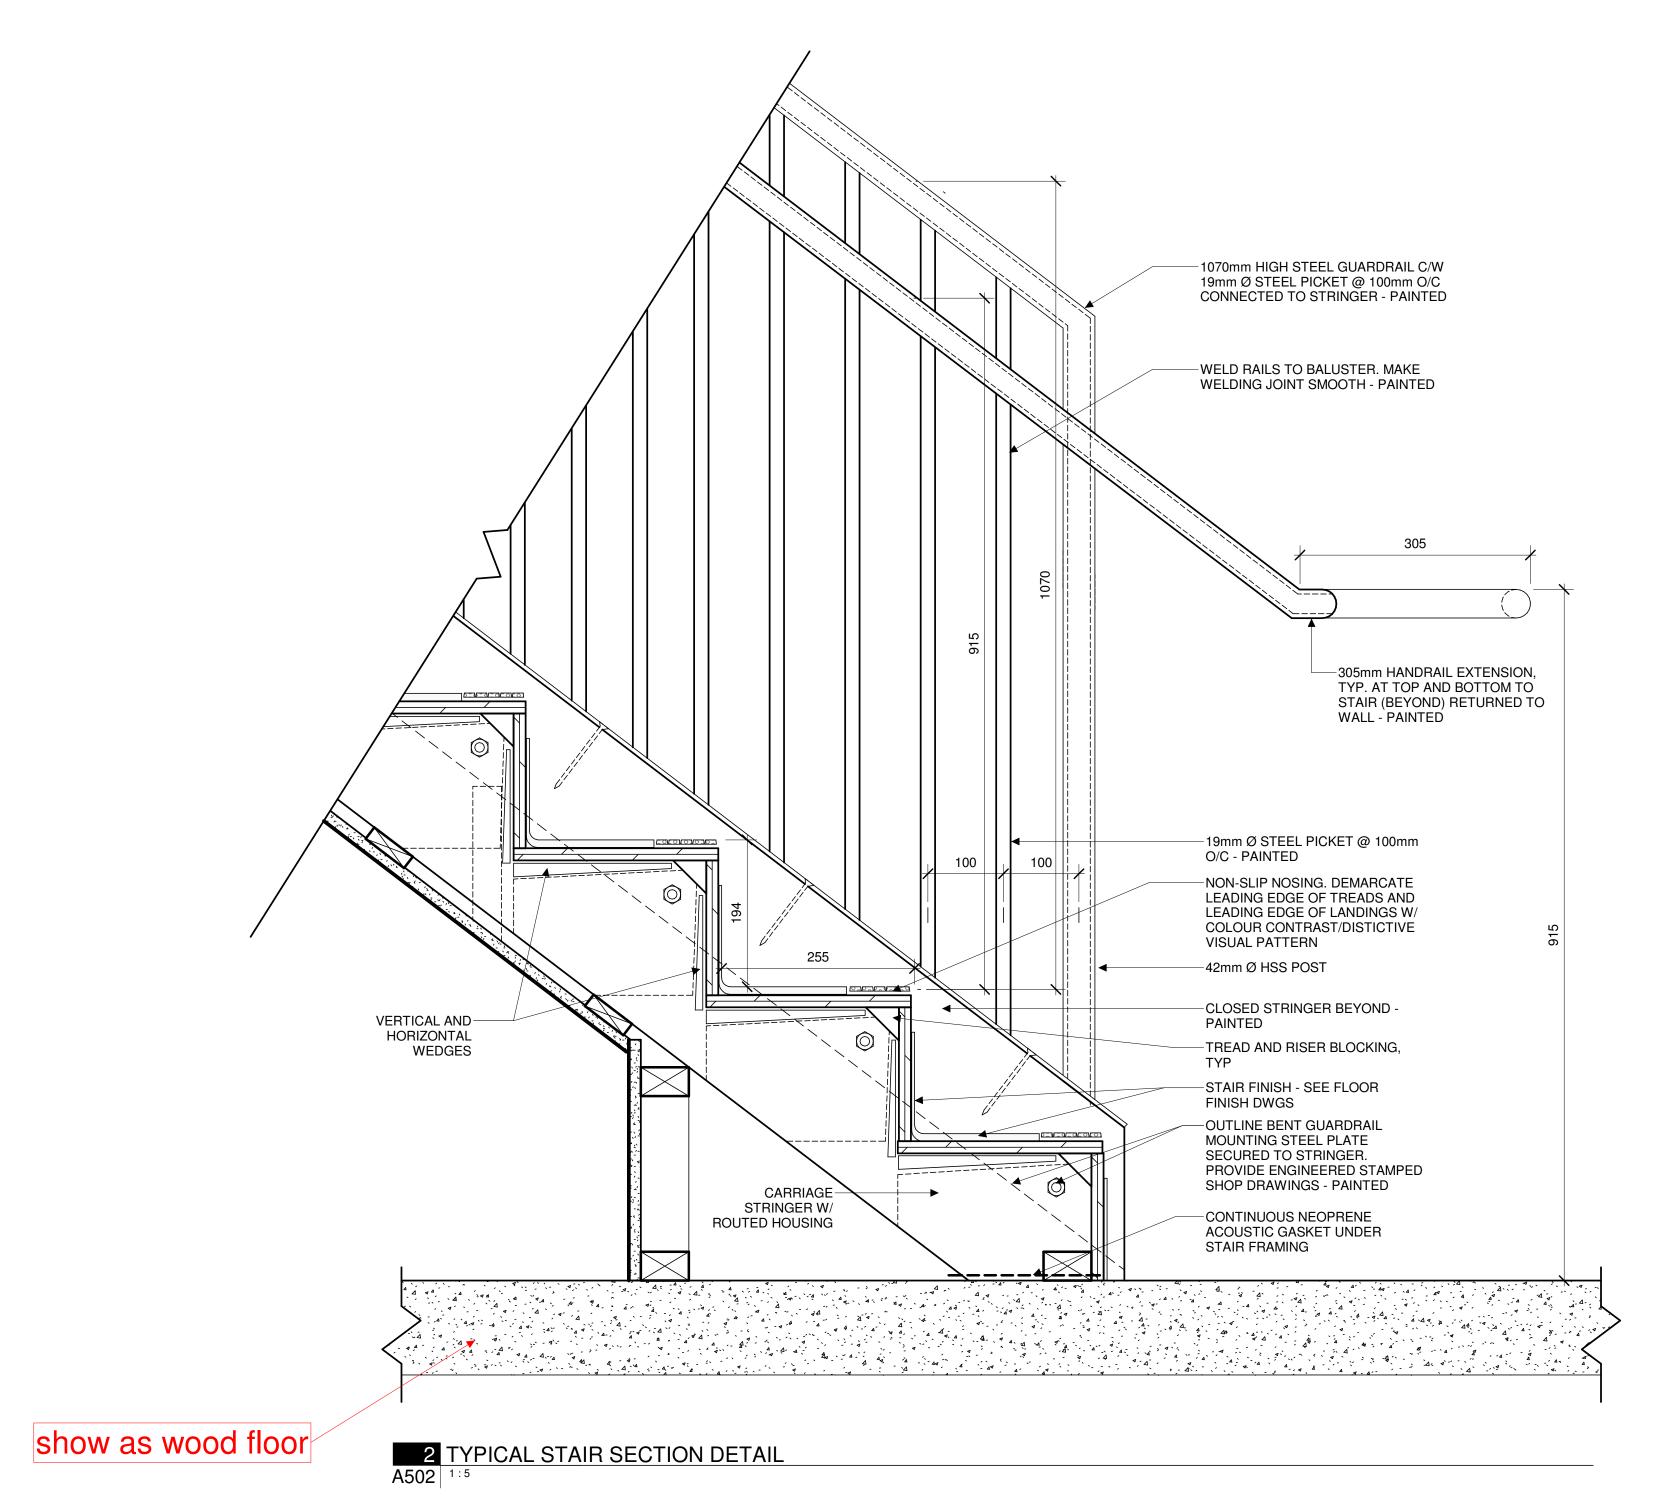

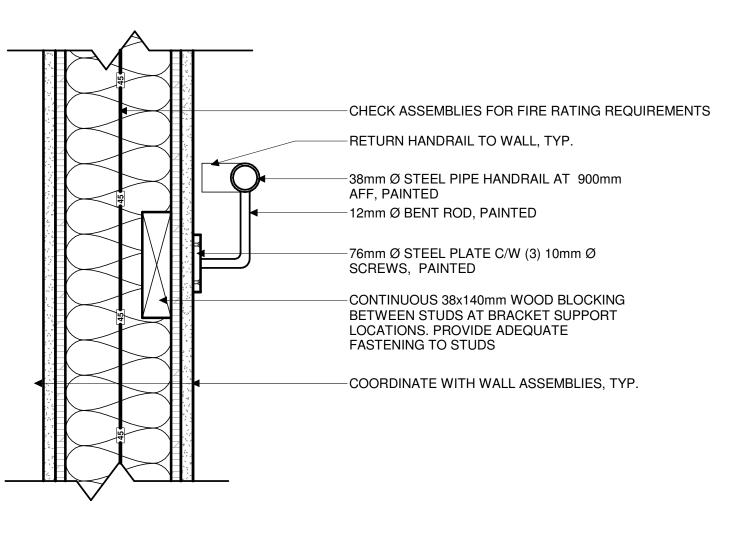

1 TYPICAL HANDRAIL SECTION DETAIL
A502 1:5

CSV ARCHITECTS

sustainable design · conception écologique

613.564.8118 190 O'Connor Street, Suite 100 Ottawa, Ontario,K2P 2R3 www.csv.ca

STRUCTURAL ENGINEER Cunliffe & Associates 200, 1550 Carling Ave 2nd Floor Ottawa, ON K1Z 8S8 613-729-7242 cunliffe@cunliffe.ca

MECHANICAL/ELECTRICAL ENGINEER Chorley + Bisset 250 City Centre Ave. Ottawa, ON K1R 1C7 613-241-0300 email@chorley.com

CIVIL ENGINEER McIntosh Perry 115 Walgreen Road, R.R. 3 Carp, ON K0A 1L0 613-836-2184 www.mcintoshperry.com

STAMP

REV DATE ISSUE

NOTES 1. OWNERSHIP OF THE COPYRIGHT OF THE DESIGN 1. OWNERSHIP OF THE COPYRIGHT OF THE DESIGN AND THE WORKS EXECUTED FROM THE DESIGN REMAINS WITH CSV ARCHITECTS, AND MAY NOT BE REPRODUCED IN ANY FORM WITHOUT THE WRITTEN CONSENT OF CSV ARCHITECTS.

2. THE DRAWINGS, PRESENTATIONS AND SPECIFICATIONS AS INSTRUMENTS OF SERVICE ARE AND SHALL REMAIN THE PROPERTY OF CSV ARCHITECTS. THEY ARE NOT TO BE USED BY THE CLIENT ON OTHER PROJECTS OR ON EXTENSIONS.

CLIENT ON OTHER PROJECTS OR ON EXTENSIONS TO THIS PROJECT WITHOUT THE WRITTEN CONSENT OF CSV ARCHITECTS. 3. THIS DRAWING IS TO BE READ IN CONJUNCTION WITH ALL OTHER PROJECT DRAWINGS AND

SPECIFICATIONS. 4. DO NOT SCALE DRAWINGS. CONTRACTOR SHALL BE RESPONSIBLE TO VERIFY DIMENSIONS ON SITE. 5. ALL WORK SHALL BE IN ACCORDANCE WITH THE ONTARIO BUILDING CODE AND ALL SUPPLEMENTS AND APPLICABLE MUNICIPAL REGULATIONS.

CLIENT

78 ROSEMOUNT AVE INC.

OTTAWA ONTARIO, CANADA

PROJECT

TITLE

REV

78 ROSEMOUNT AVE.


78 Rosemount Avenue, Ottawa, ON K1Y 1P6

STAIR DETAILS

PROJECT NO: 2021-1320 DRAWN: JW APPROVED: JS 1:5

DATE PRINTED: 5/18/2022 11:09:28 AM

DRAWING NO.

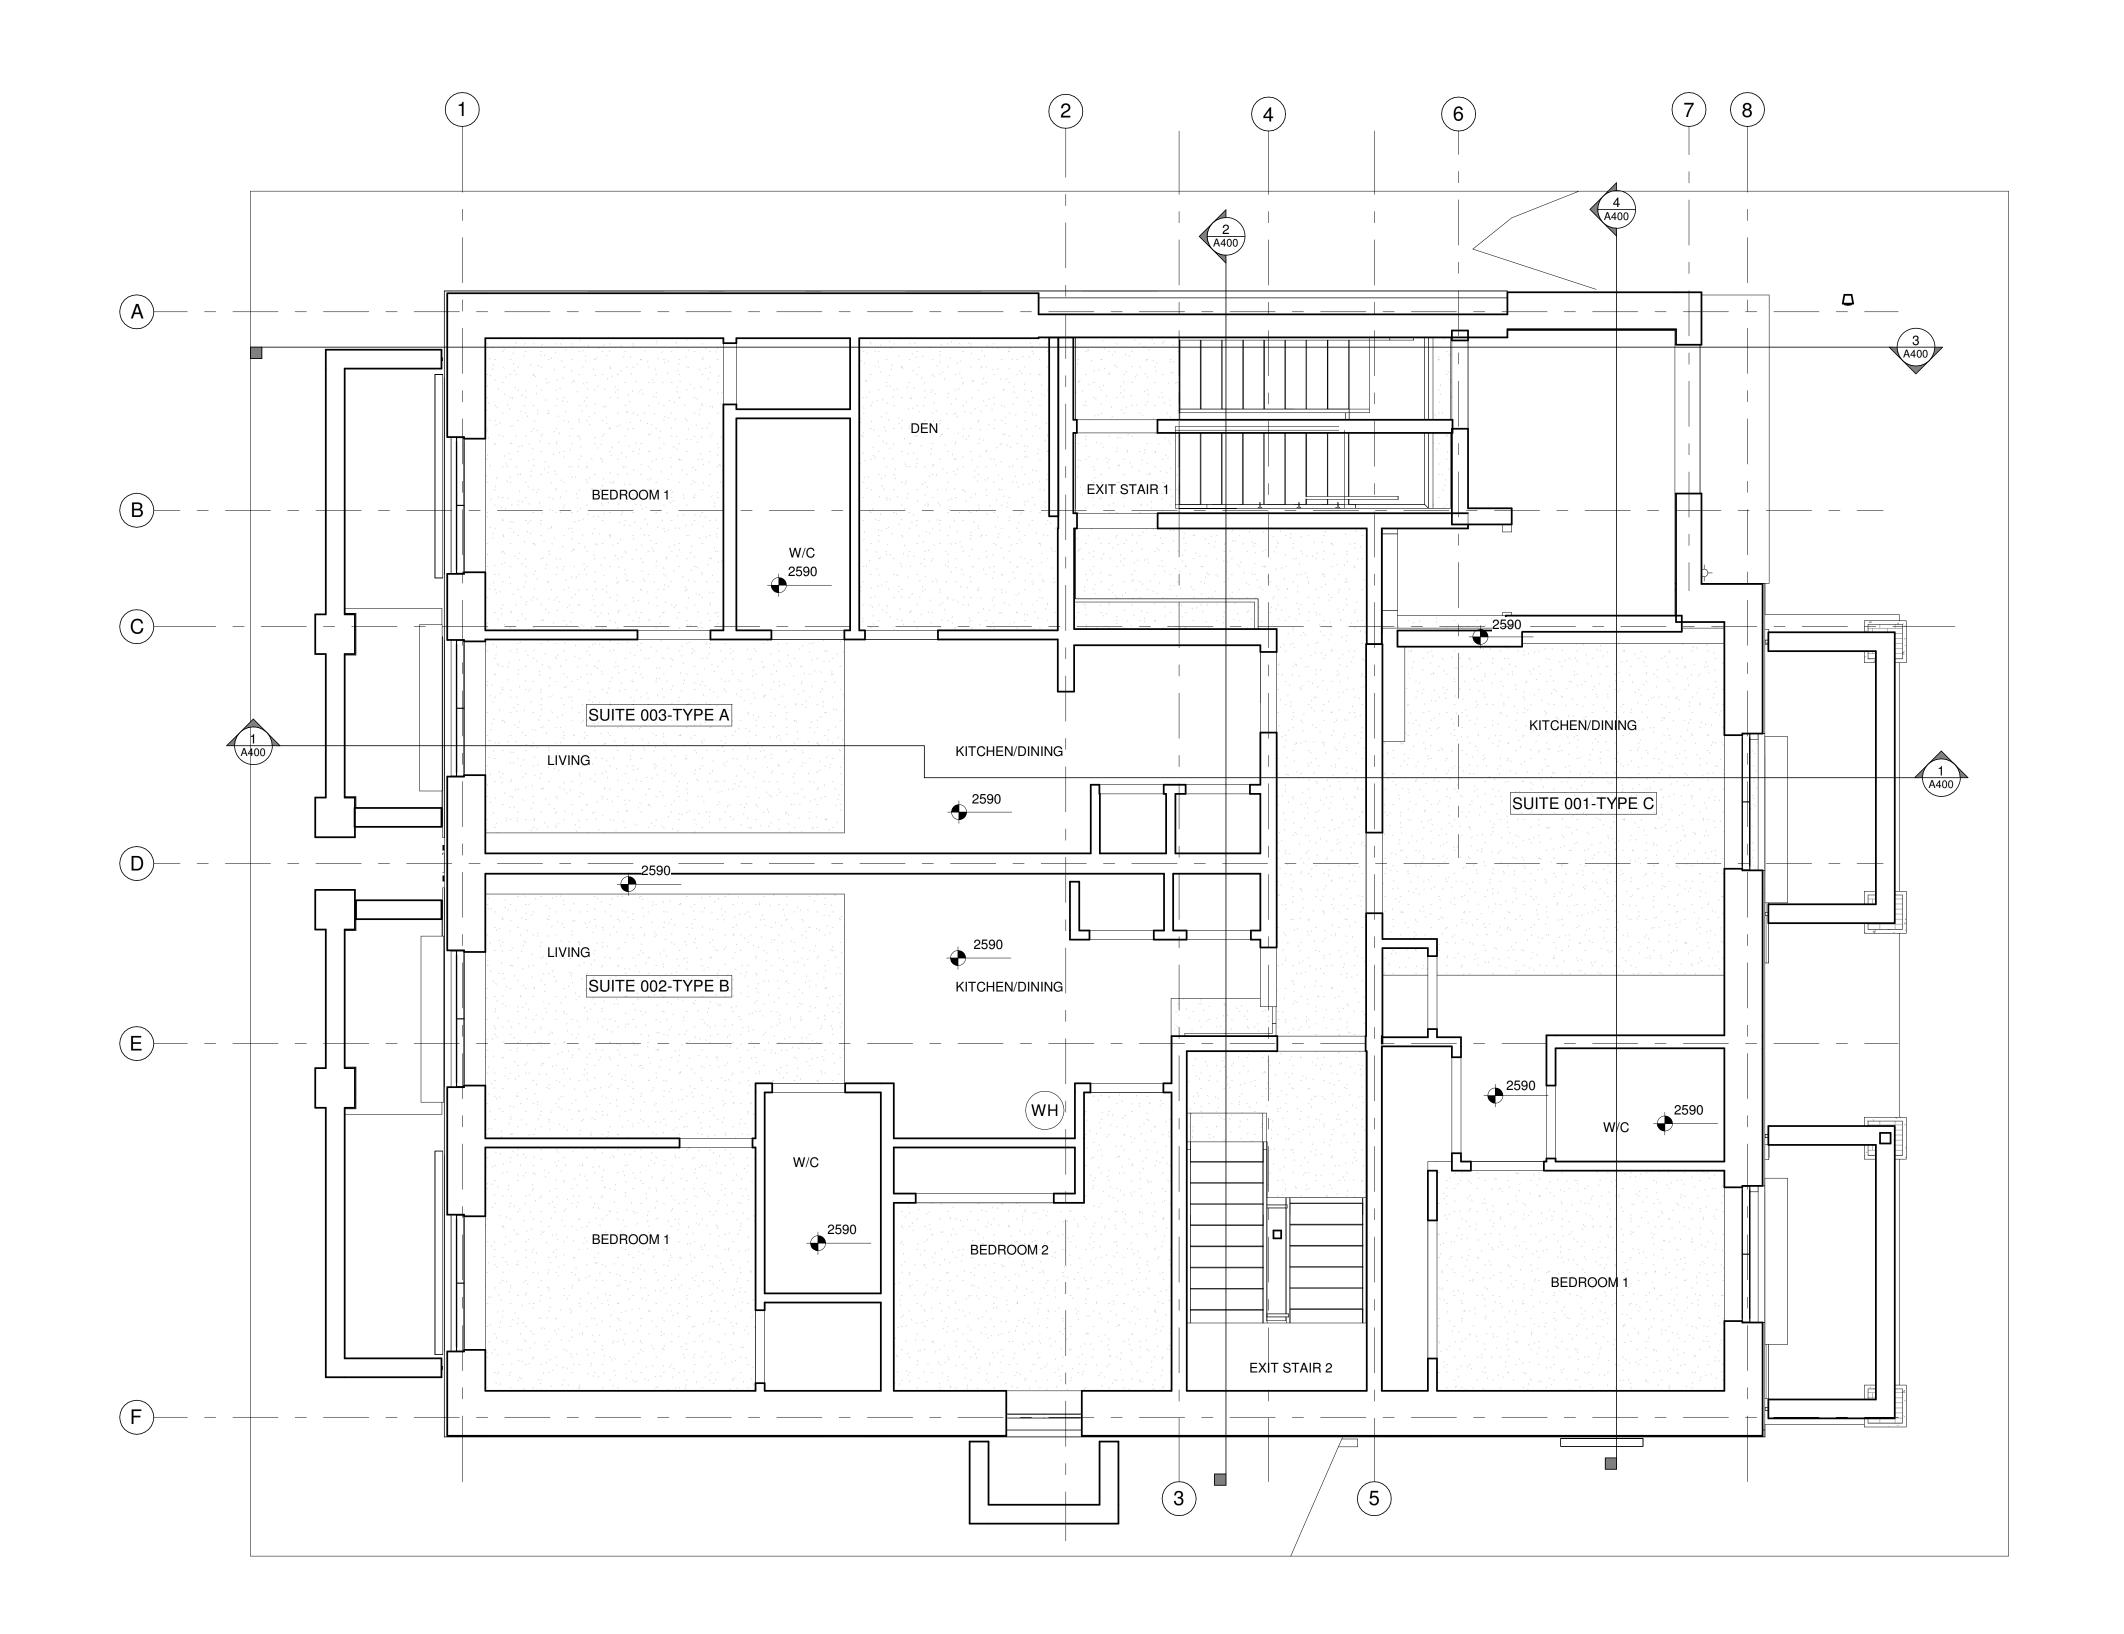

REFLECTED CEILING PLAN NOTES:

 NOTES 2. NOTES

REFLECTED CEILING PLAN KEYNOTES:

- # SAMPLE TEXT
- # SAMPLE TEXT

- # SAMPLE TEXT
- # SAMPLE TEXT
- # SAMPLE TEXT MULTI LINE

CSV ARCHITECTS

sustainable design · conception écologique 613.564.8118 190 O'Connor Street, Suite 100

Ottawa, Ontario,K2P 2R3 www.csv.ca STRUCTURAL ENGINEER

Cunliffe & Associates 200, 1550 Carling Ave 2nd Floor Ottawa, ON K1Z 8S8 613-729-7242 cunliffe@cunliffe.ca

MECHANICAL/ELECTRICAL ENGINEER Chorley + Bisset 250 City Centre Ave. Ottawa, ON K1R 1C7 613-241-0300 email@chorley.com

CIVIL ENGINEER McIntosh Perry 115 Walgreen Road, R.R. 3 Carp, ON K0A 1L0 613-836-2184 www.mcintoshperry.com

REFLECTED CEILING PLAN LEGEND:

<u>LIGHTING</u>

RECTANGULAR FIXTURE

RECTANGULAR FIXTURE SUSPENDED

LINEAR FIXTURE

LINEAR FIXTURE SUSPENDED

LINEAR FIXTURE WALL MOUNTED

POT LIGHT

PENDANT LIGHT

SURFACE MOUNTED LIGHT <u></u> WALL MOUNTED LIGHT

EMERGENCY REMOTE HEAD

WALL MOUNTED EMERGENCY BATTERY

EXIT SIGN WALL MOUNTED

CEILING MOUNTED OCCUPANCY SENSOR

CEILING MOUNTED PHOTOCELL

MECHANICAL

LINEAR DIFFUSER

RETURN GRILLE

SUPPORT DIFFUSER

FIRE PROTECTION

SPRINKLER PENDANT

SPRINKLER CONCEALED

SPRINKLER UPRIGHT

SPRINKLER SIDEWALL

F FIRE ALARM SPEAKER

SMOKE/HEAT DETECTOR

STROBE LIGHT

STAMP



1. OWNERSHIP OF THE COPYRIGHT OF THE DESIGN AND THE WORKS EXECUTED FROM THE DESIGN REMAINS WITH CSV ARCHITECTS, AND MAY NOT BE REPRODUCED IN ANY FORM WITHOUT THE WRITTEN CONSENT OF CSV ARCHITECTS.

2. THE DRAWINGS, PRESENTATIONS AND SPECIFICATIONS AS INSTRUMENTS OF SERVICE ARE AND SHALL REMAIN THE PROPERTY OF CSV ARCHITECTS. THEY ARE NOT TO BE USED BY THE CLIENT ON OTHER PROJECTS OR ON EXTENSIONS TO THIS PROJECT WITHOUT THE WRITTEN TO THIS PROJECT WITHOUT THE WRITTEN CONSENT OF CSV ARCHITECTS.

3. THIS DRAWING IS TO BE READ IN CONJUNCTION WITH ALL OTHER PROJECT DRAWINGS AND WITH ALL OTHER PROJECT DRAWINGS AND SPECIFICATIONS.

4. DO NOT SCALE DRAWINGS. CONTRACTOR SHALL BE RESPONSIBLE TO VERIFY DIMENSIONS ON SITE.

5. ALL WORK SHALL BE IN ACCORDANCE WITH THE ONTARIO BUILDING CODE AND ALL SUPPLEMENTS AND APPLICABLE MUNICIPAL REGULATIONS.

CLIENT

78 ROSEMOUNT AVE INC.

OTTAWA ONTARIO, CANADA

PROJECT

TITLE

REV


78 ROSEMOUNT AVE.

78 Rosemount Avenue, Ottawa, ON K1Y 1P6

BASEMENT REFLECTED CEILING

PLAN
PROJECT NO: 2021-1320 DRAWN: JW APPROVED: JS As indicated DATE PRINTED: 5/18/2022 11:09:31 AM

DRAWING NO.

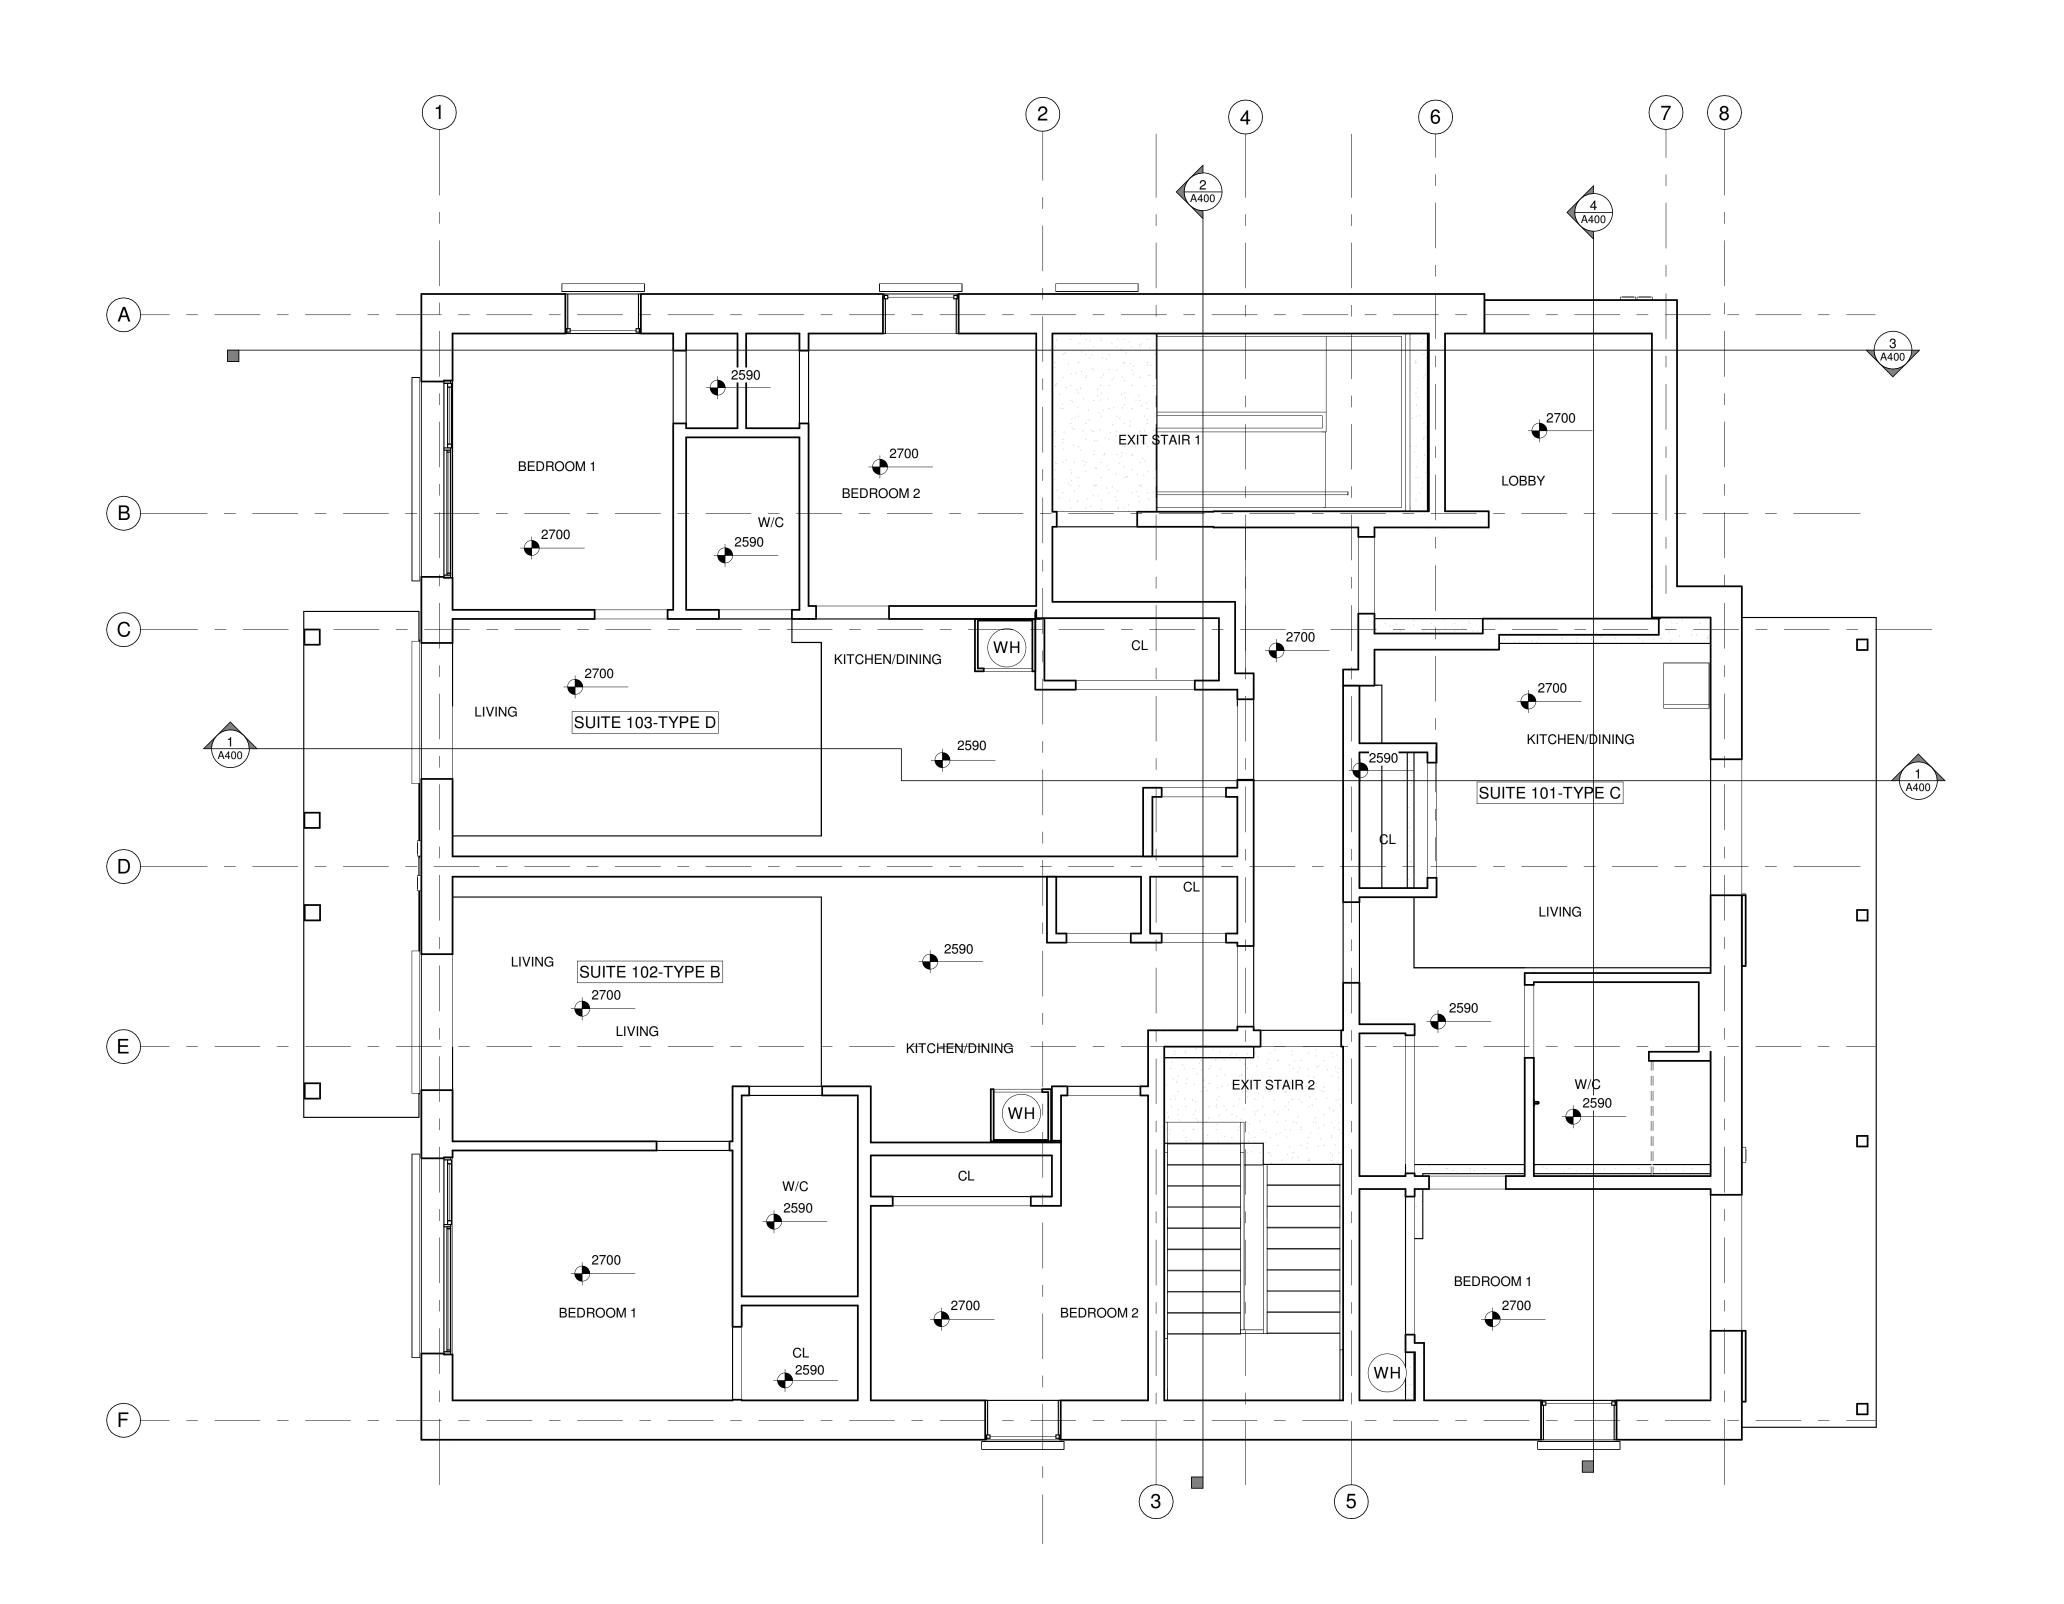

1 FIRST FLOOR REFLECTED CEILING PLAN

REFLECTED CEILING PLAN NOTES:

 NOTES 2. NOTES

REFLECTED CEILING PLAN KEYNOTES:

- # SAMPLE TEXT

- # SAMPLE TEXT
- # SAMPLE TEXT
- # SAMPLE TEXT
- # SAMPLE TEXT MULTI LINE

REFLECTED CEILING PLAN LEGEND:

<u>LIGHTING</u>

RECTANGULAR FIXTURE



POT LIGHT

PENDANT LIGHT

 $rac{1}{2}$ WALL MOUNTED LIGHT

WALL MOUNTED EMERGENCY BATTERY

EXIT SIGN WALL MOUNTED

CEILING MOUNTED OCCUPANCY SENSOR

MECHANICAL

RETURN GRILLE

FIRE PROTECTION

SPRINKLER PENDANT

SPRINKLER CONCEALED

SPRINKLER UPRIGHT

SPRINKLER SIDEWALL

613.564.8118 190 O'Connor Street, Suite 100 Ottawa, Ontario,K2P 2R3 www.csv.ca

CSV ARCHITECTS

sustainable design · conception écologique

STRUCTURAL ENGINEER Cunliffe & Associates 200, 1550 Carling Ave 2nd Floor Ottawa, ON K1Z 8S8

613-729-7242 cunliffe@cunliffe.ca

MECHANICAL/ELECTRICAL ENGINEER Chorley + Bisset 250 City Centre Ave. Ottawa, ON K1R 1C7 613-241-0300 email@chorley.com

CIVIL ENGINEER McIntosh Perry 115 Walgreen Road, R.R. 3 Carp, ON K0A 1L0 613-836-2184 www.mcintoshperry.com

RECTANGULAR FIXTURE SUSPENDED

LINEAR FIXTURE

LINEAR FIXTURE WALL MOUNTED

SURFACE MOUNTED LIGHT

EMERGENCY REMOTE HEAD

CEILING MOUNTED PHOTOCELL

LINEAR DIFFUSER

SUPPORT DIFFUSER

F FIRE ALARM SPEAKER

SMOKE/HEAT DETECTOR

STROBE LIGHT

STAMP

REV DATE ISSUE



1. OWNERSHIP OF THE COPYRIGHT OF THE DESIGN AND THE WORKS EXECUTED FROM THE DESIGN REMAINS WITH CSV ARCHITECTS, AND MAY NOT BE REPRODUCED IN ANY FORM WITHOUT THE WRITTEN CONSENT OF CSV ARCHITECTS.

2. THE DRAWINGS, PRESENTATIONS AND SPECIFICATIONS AS INSTRUMENTS OF SERVICE ARE AND SHALL REMAIN THE PROPERTY OF CSV ARCHITECTS. THEY ARE NOT TO BE USED BY THE CLIENT ON OTHER PROJECTS OR ON EXTENSIONS TO THIS PROJECT WITHOUT THE WRITTEN TO THIS PROJECT WITHOUT THE WRITTEN CONSENT OF CSV ARCHITECTS.

3. THIS DRAWING IS TO BE READ IN CONJUNCTION

WITH ALL OTHER PROJECT DRAWINGS AND WITH ALL OTHER PROJECT DRAWINGS AND SPECIFICATIONS.

4. DO NOT SCALE DRAWINGS. CONTRACTOR SHALL BE RESPONSIBLE TO VERIFY DIMENSIONS ON SITE.

5. ALL WORK SHALL BE IN ACCORDANCE WITH THE ONTARIO BUILDING CODE AND ALL SUPPLEMENTS AND APPLICABLE MUNICIPAL REGULATIONS.

CLIENT

78 ROSEMOUNT AVE INC.

OTTAWA ONTARIO, CANADA

PROJECT

TITLE

78 ROSEMOUNT AVE.

78 Rosemount Avenue, Ottawa, ON K1Y 1P6


FIRST FLOOR REFLECTED CEILING

PLAN
PROJECT NO: 2021-1320 DRAWN: JW APPROVED: JS As indicated

DATE PRINTED: 5/18/2022 11:09:32 AM

A601

DRAWING NO.

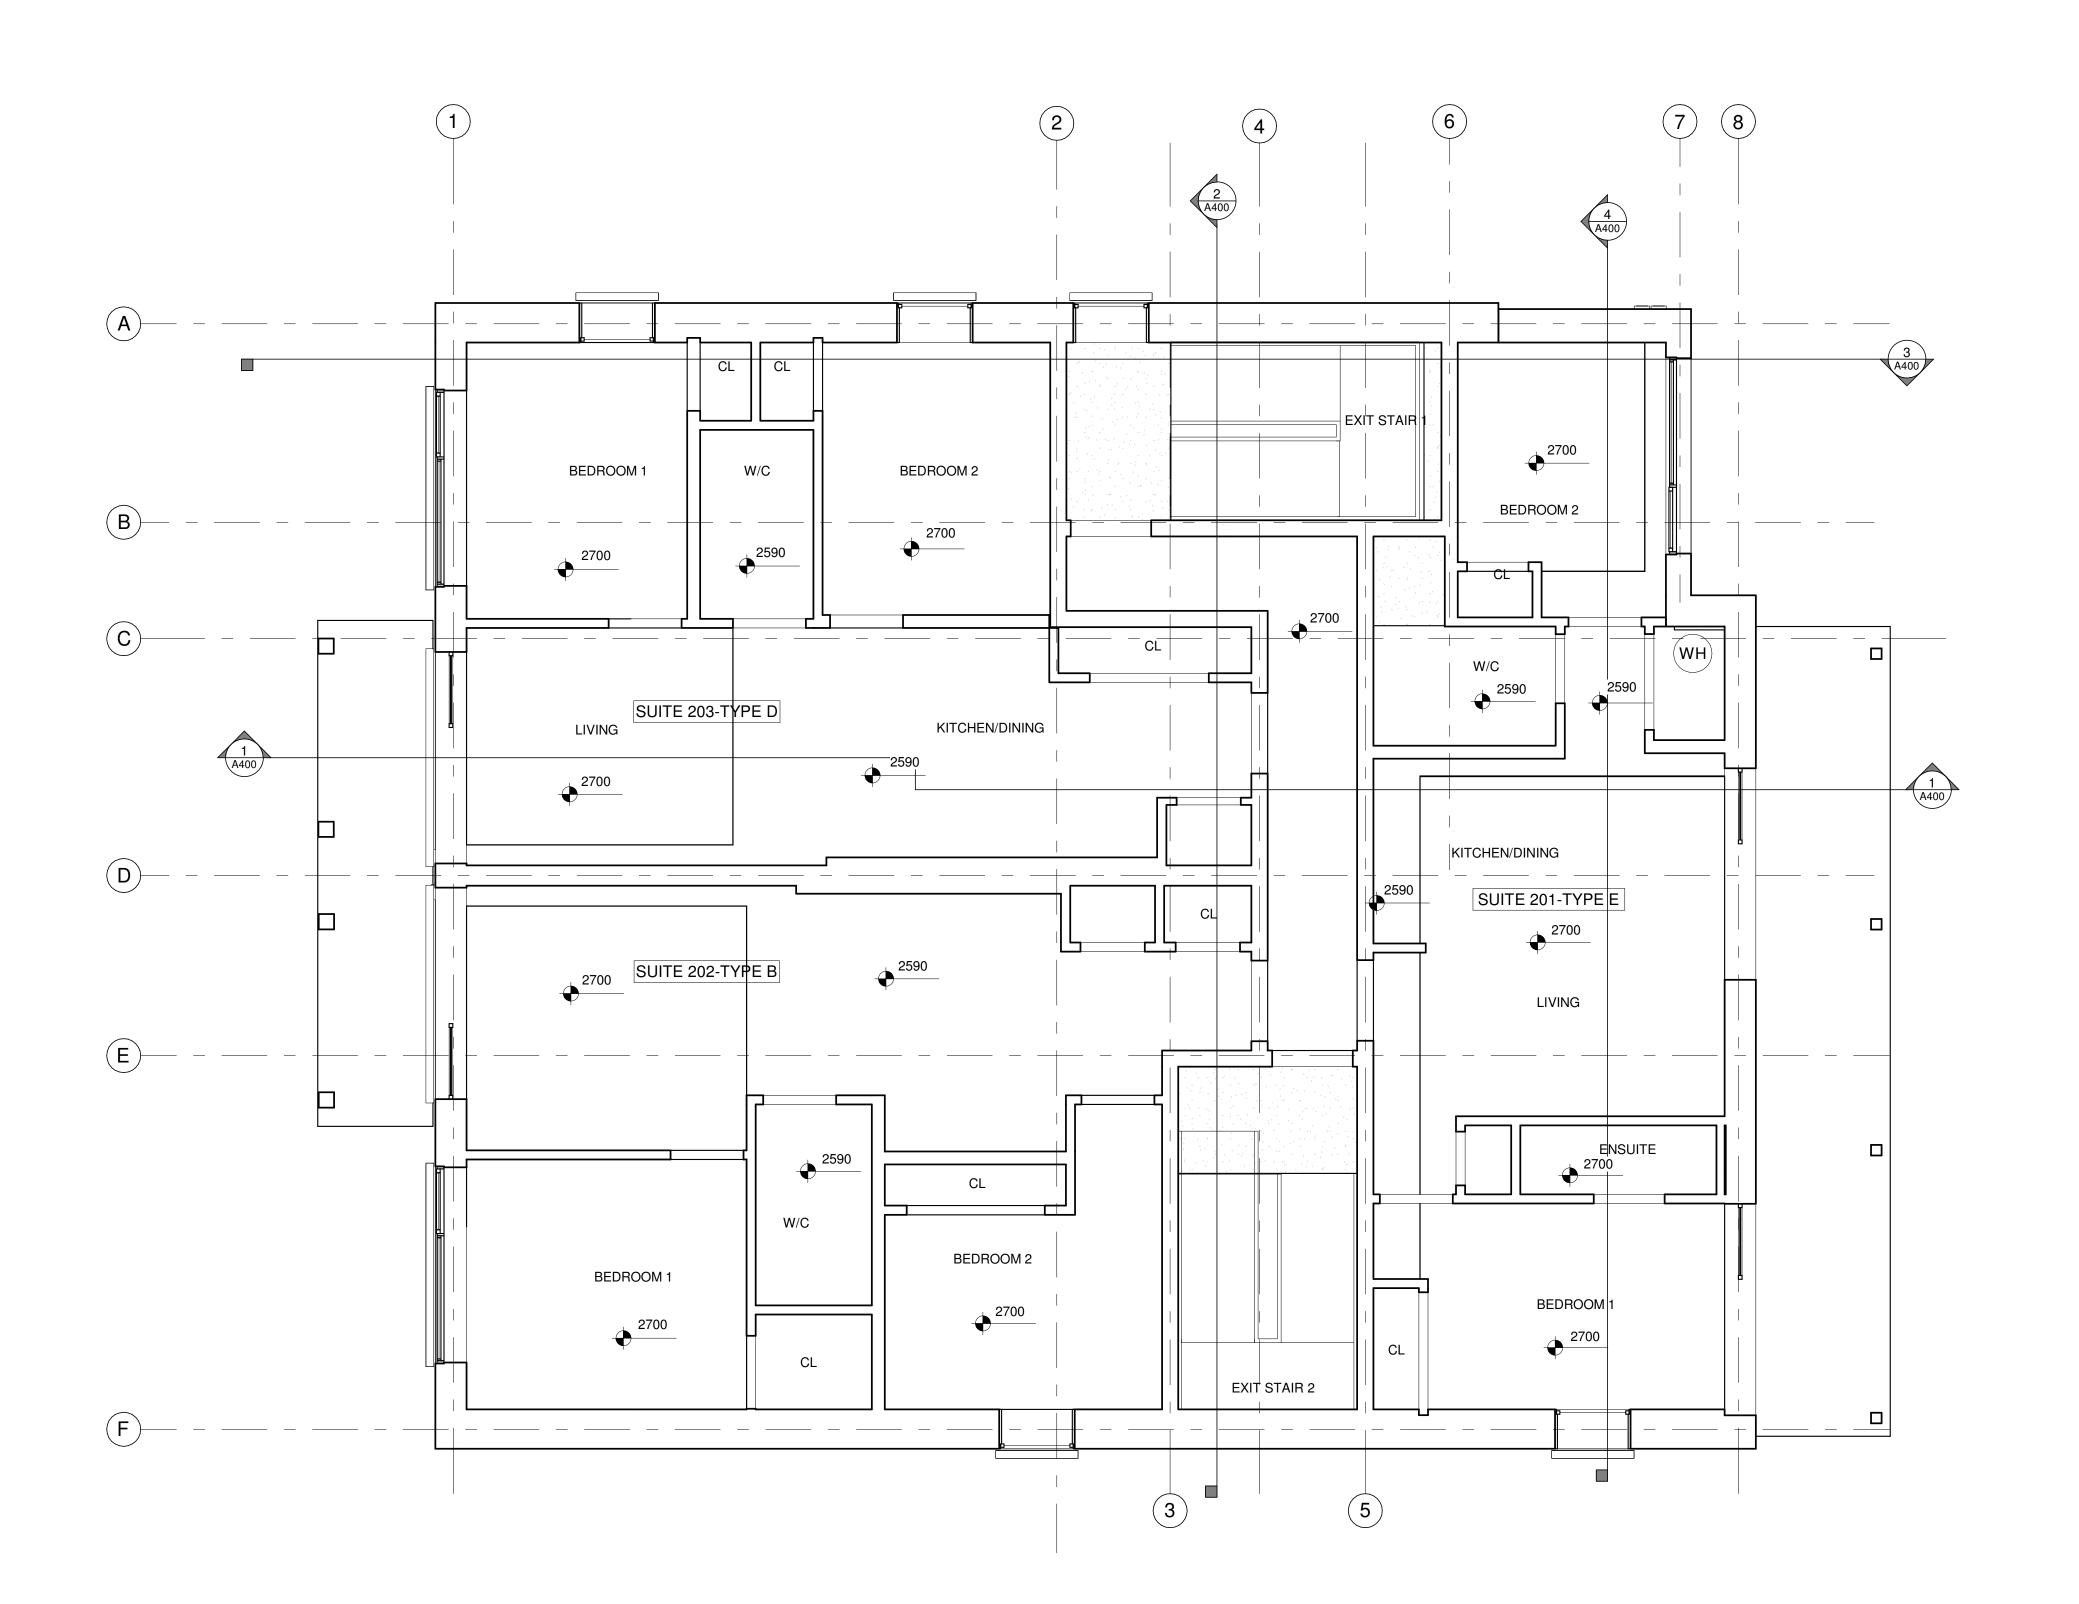

1 SECOND FLOOR REFLECTED CEILING PLAN

REFLECTED CEILING PLAN NOTES:

 NOTES 2. NOTES

REFLECTED CEILING PLAN KEYNOTES:

- # SAMPLE TEXT
- # SAMPLE TEXT
- # SAMPLE TEXT
- # SAMPLE TEXT MULTI LINE
- # SAMPLE TEXT

sustainable design · conception écologique

613.564.8118 190 O'Connor Street, Suite 100 Ottawa, Ontario,K2P 2R3 www.csv.ca

CSV ARCHITECTS

STRUCTURAL ENGINEER Cunliffe & Associates 200, 1550 Carling Ave 2nd Floor Ottawa, ON K1Z 8S8 613-729-7242 cunliffe@cunliffe.ca

MECHANICAL/ELECTRICAL ENGINEER Chorley + Bisset 250 City Centre Ave. Ottawa, ON K1R 1C7 613-241-0300 email@chorley.com

CIVIL ENGINEER McIntosh Perry 115 Walgreen Road, R.R. 3 Carp, ON K0A 1L0 613-836-2184 www.mcintoshperry.com

REFLECTED CEILING PLAN LEGEND:

<u>LIGHTING</u>

RECTANGULAR FIXTURE

RECTANGULAR FIXTURE SUSPENDED

LINEAR FIXTURE

LINEAR FIXTURE SUSPENDED

LINEAR FIXTURE WALL MOUNTED

POT LIGHT

SURFACE MOUNTED LIGHT

PENDANT LIGHT

 $rac{1}{2}$ WALL MOUNTED LIGHT

WALL MOUNTED EMERGENCY BATTERY

EMERGENCY REMOTE HEAD

EXIT SIGN WALL MOUNTED

CEILING MOUNTED OCCUPANCY SENSOR

CEILING MOUNTED PHOTOCELL

MECHANICAL

LINEAR DIFFUSER

SUPPORT DIFFUSER RETURN GRILLE

FIRE PROTECTION

SPRINKLER PENDANT

SPRINKLER CONCEALED

SPRINKLER UPRIGHT

SPRINKLER SIDEWALL

FIRE ALARM SPEAKER

STROBE LIGHT

SMOKE/HEAT DETECTOR

78 ROSEMOUNT AVE

CLIENT

STAMP

REV DATE ISSUE

1. OWNERSHIP OF THE COPYRIGHT OF THE DESIGN

1. OWNERSHIP OF THE COPYRIGHT OF THE DESIGN AND THE WORKS EXECUTED FROM THE DESIGN REMAINS WITH CSV ARCHITECTS, AND MAY NOT BE REPRODUCED IN ANY FORM WITHOUT THE WRITTEN CONSENT OF CSV ARCHITECTS.

2. THE DRAWINGS, PRESENTATIONS AND SPECIFICATIONS AS INSTRUMENTS OF SERVICE AND SHALL REMAIN THE PROPERTY OF CSV ARCHITECTS. THEY ARE NOT TO BE USED BY THE

ARCHITECTS. THEY ARE NOT TO BE USED BY THE

CLIENT ON OTHER PROJECTS OR ON EXTENSIONS TO THIS PROJECT WITHOUT THE WRITTEN

CONSENT OF CSV ARCHITECTS.

3. THIS DRAWING IS TO BE READ IN CONJUNCTION

BE RESPONSIBLE TO VERIFY DIMENSIONS ON SITE. 5. ALL WORK SHALL BE IN ACCORDANCE WITH THE ONTARIO BUILDING CODE AND ALL SUPPLEMENTS AND APPLICABLE MUNICIPAL REGULATIONS.

WITH ALL OTHER PROJECT DRAWINGS AND SPECIFICATIONS.
4. DO NOT SCALE DRAWINGS. CONTRACTOR SHALL

INC. OTTAWA ONTARIO, CANADA

PROJECT

78 ROSEMOUNT AVE.

78 Rosemount Avenue, Ottawa, ON K1Y 1P6


SECOND FLOOR REFLECTED CEILING

PLAN
PROJECT NO: 2021-1320

TITLE

DRAWN: JW APPROVED: JS As indicated DATE PRINTED: 5/18/2022 11:09:34 AM

DRAWING NO.

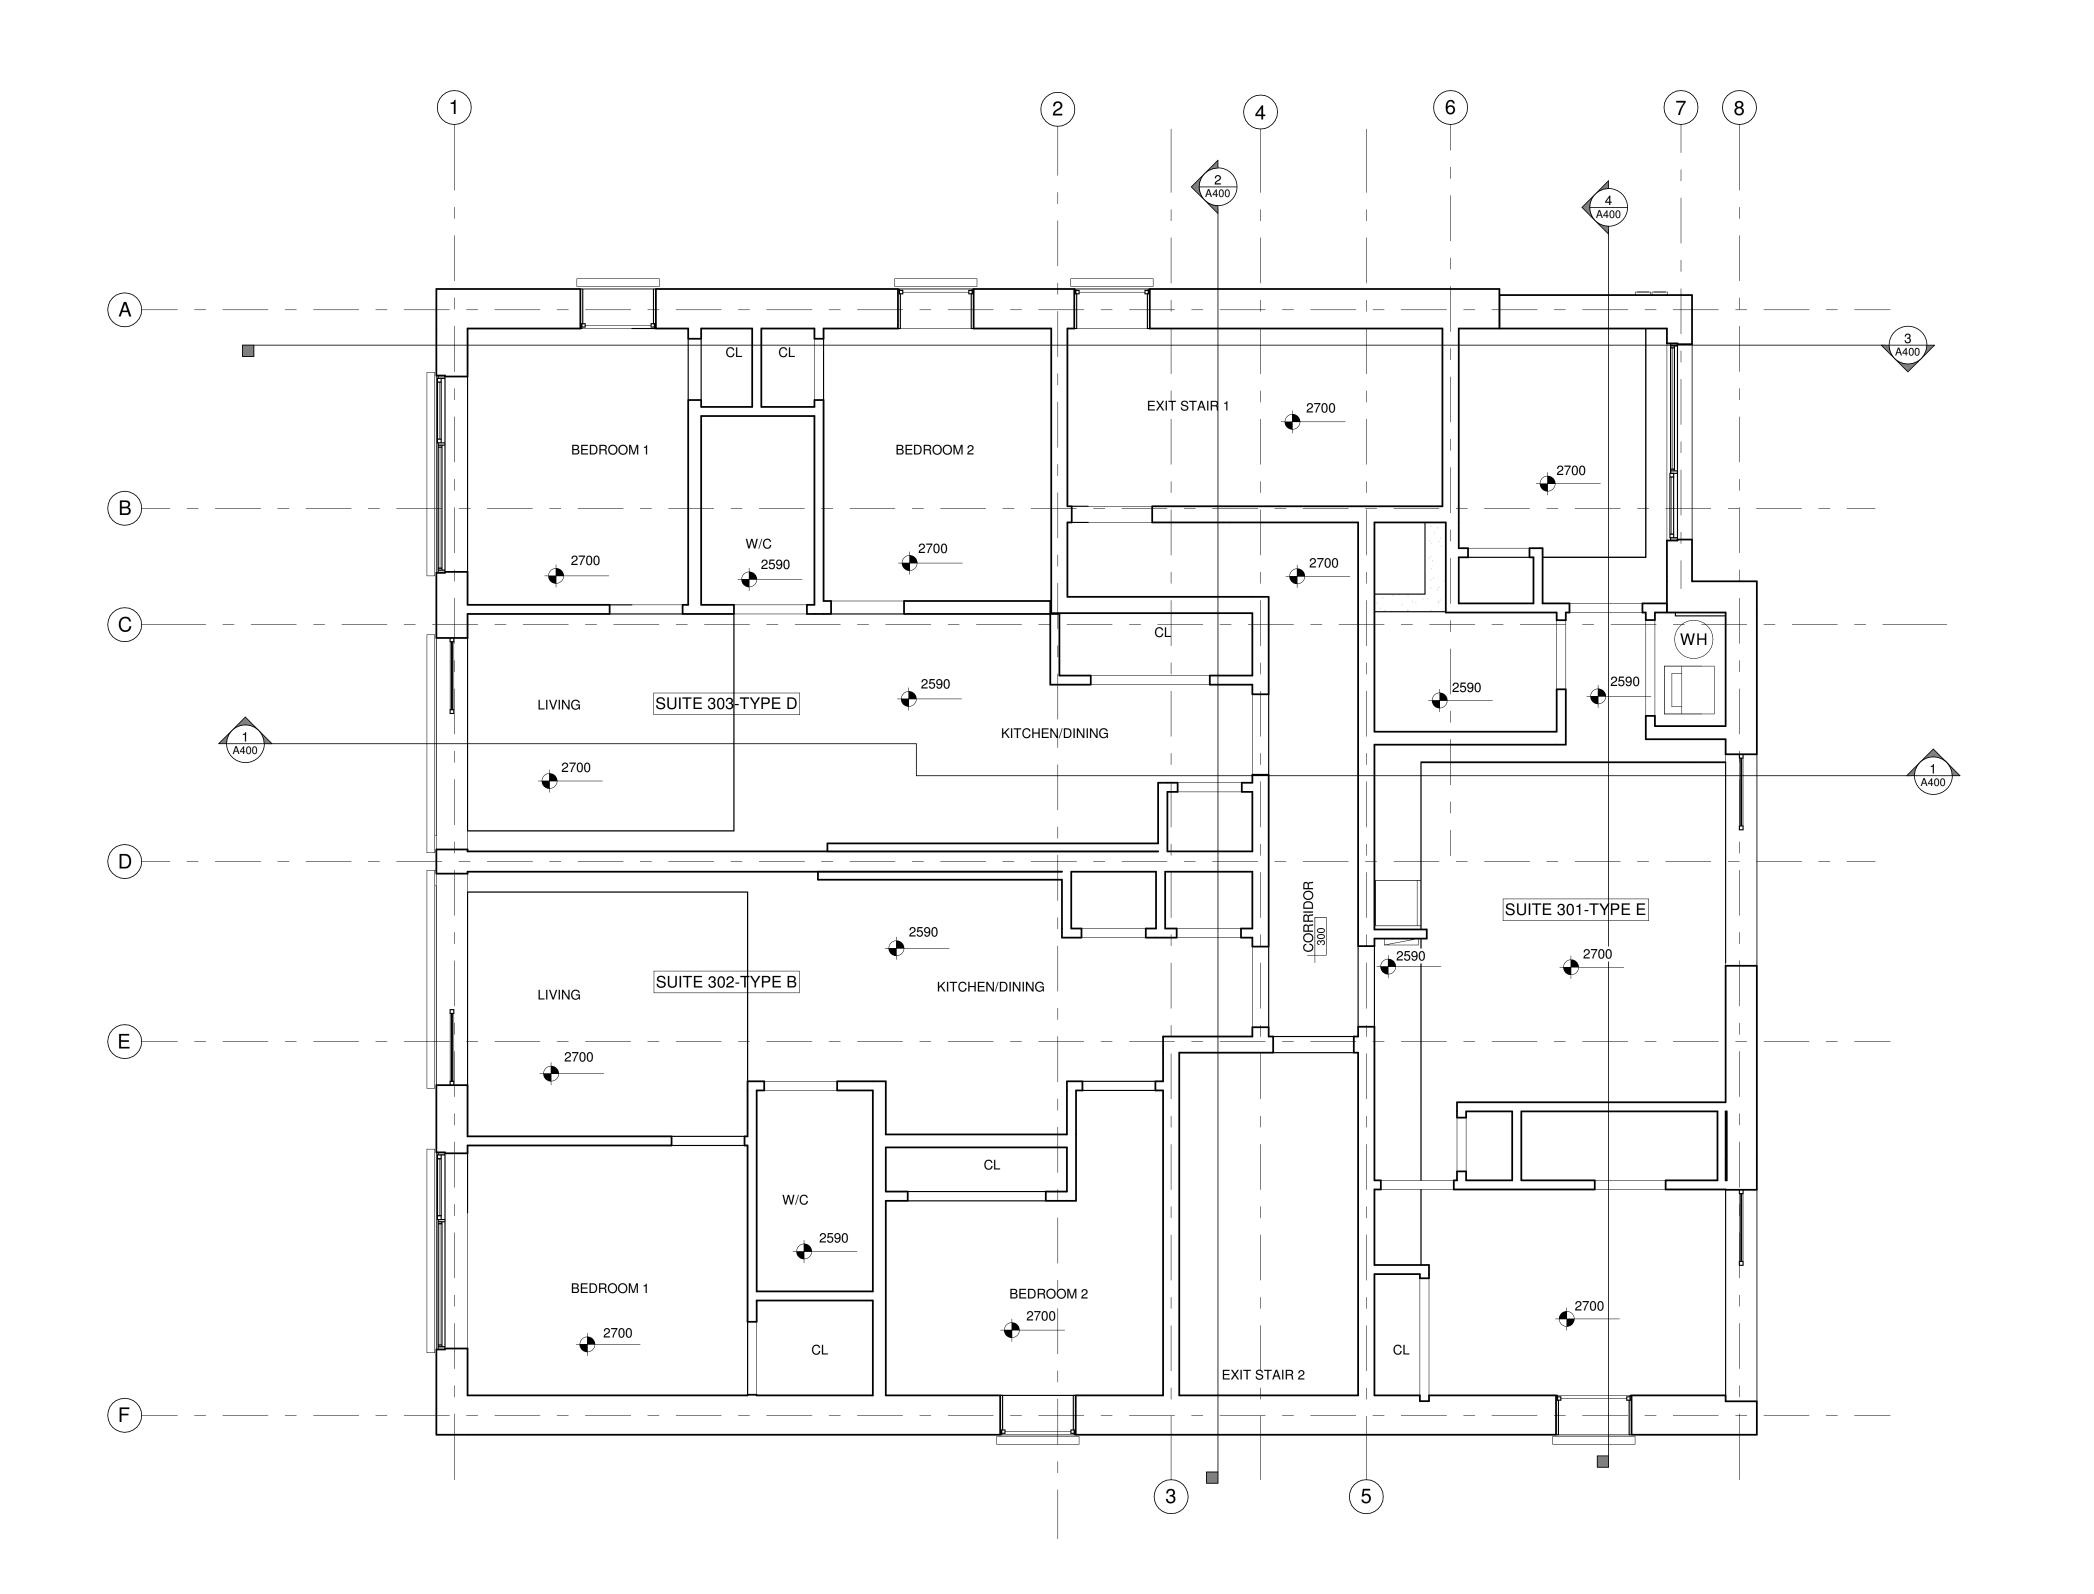

REFLECTED CEILING PLAN NOTES:

 NOTES 2. NOTES

REFLECTED CEILING PLAN KEYNOTES:

- # SAMPLE TEXT
- # SAMPLE TEXT
- # SAMPLE TEXT
- # SAMPLE TEXT MULTI LINE
- # SAMPLE TEXT

CSV ARCHITECTS

sustainable design · conception écologique

613.564.8118 190 O'Connor Street, Suite 100 Ottawa, Ontario,K2P 2R3 www.csv.ca

STRUCTURAL ENGINEER Cunliffe & Associates 200, 1550 Carling Ave 2nd Floor Ottawa, ON K1Z 8S8 613-729-7242 cunliffe@cunliffe.ca

MECHANICAL/ELECTRICAL ENGINEER Chorley + Bisset 250 City Centre Ave. Ottawa, ON K1R 1C7 613-241-0300 email@chorley.com

CIVIL ENGINEER McIntosh Perry 115 Walgreen Road, R.R. 3 Carp, ON K0A 1L0 613-836-2184 www.mcintoshperry.com

REFLECTED CEILING PLAN LEGEND:

<u>LIGHTING</u>

RECTANGULAR FIXTURE



POT LIGHT

SURFACE MOUNTED LIGHT

<u></u> WALL MOUNTED LIGHT

EMERGENCY REMOTE HEAD

MECHANICAL

LINEAR DIFFUSER

FIRE PROTECTION

SPRINKLER PENDANT

SPRINKLER UPRIGHT

RECTANGULAR FIXTURE SUSPENDED

LINEAR FIXTURE LINEAR FIXTURE SUSPENDED

LINEAR FIXTURE WALL MOUNTED

PENDANT LIGHT

WALL MOUNTED EMERGENCY BATTERY

EXIT SIGN WALL MOUNTED

CEILING MOUNTED OCCUPANCY SENSOR

CEILING MOUNTED PHOTOCELL

RETURN GRILLE

SUPPORT DIFFUSER

SPRINKLER CONCEALED

SPRINKLER SIDEWALL

FIRE ALARM SPEAKER

SMOKE/HEAT DETECTOR

STROBE LIGHT

REV DATE ISSUE



STAMP

1. OWNERSHIP OF THE COPYRIGHT OF THE DESIGN AND THE WORKS EXECUTED FROM THE DESIGN REMAINS WITH CSV ARCHITECTS, AND MAY NOT BE REPRODUCED IN ANY FORM WITHOUT THE WRITTEN CONSENT OF CSV ARCHITECTS.

2. THE DRAWINGS, PRESENTATIONS AND SPECIFICATIONS AS INSTRUMENTS OF SERVICE ARE AND SHALL REMAIN THE PROPERTY OF CSV ARCHITECTS. THEY ARE NOT TO BE USED BY THE CLIENT ON OTHER PROJECTS OR ON EXTENSIONS TO THIS PROJECT WITHOUT THE WRITTEN TO THIS PROJECT WITHOUT THE WRITTEN CONSENT OF CSV ARCHITECTS.

3. THIS DRAWING IS TO BE READ IN CONJUNCTION

WITH ALL OTHER PROJECT DRAWINGS AND WITH ALL OTHER PROJECT DRAWINGS AND SPECIFICATIONS.

4. DO NOT SCALE DRAWINGS. CONTRACTOR SHALL BE RESPONSIBLE TO VERIFY DIMENSIONS ON SITE.

5. ALL WORK SHALL BE IN ACCORDANCE WITH THE ONTARIO BUILDING CODE AND ALL SUPPLEMENTS AND APPLICABLE MUNICIPAL REGULATIONS.

CLIENT

78 ROSEMOUNT AVE INC. OTTAWA

ONTARIO, CANADA

PROJECT

TITLE

78 ROSEMOUNT AVE.

78 Rosemount Avenue, Ottawa, ON K1Y 1P6

THIRD FLOOR REFLECTED CEILING


PLAN
PROJECT NO: 2021-1320 DRAWN: JW APPROVED: JS As indicated


DATE PRINTED: 5/18/2022 11:09:35 AM

A603


DRAWING NO.

THIRD FLOOR REFLECTED CEILING PLAN
A603 1:50

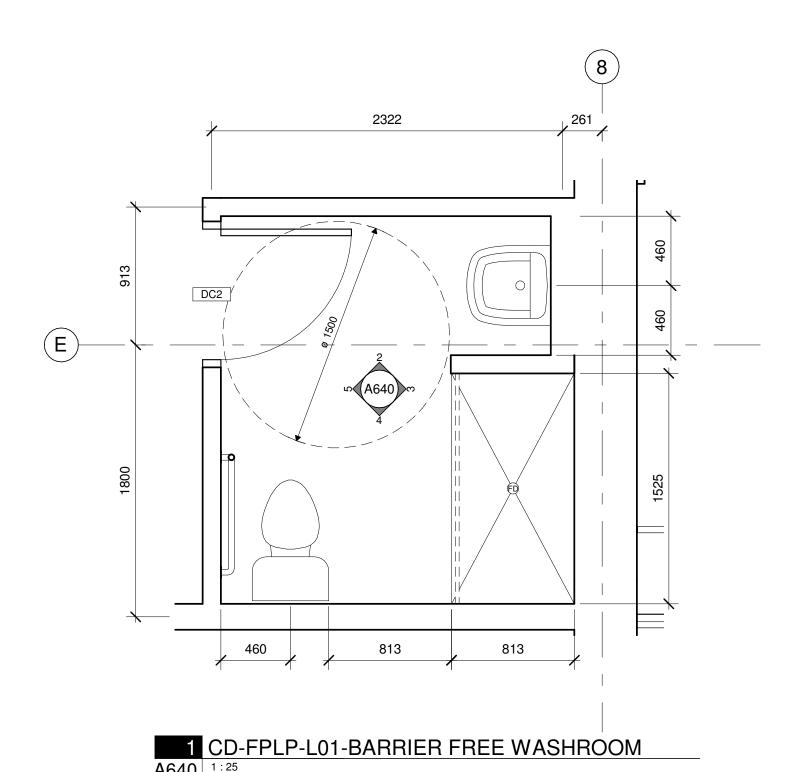


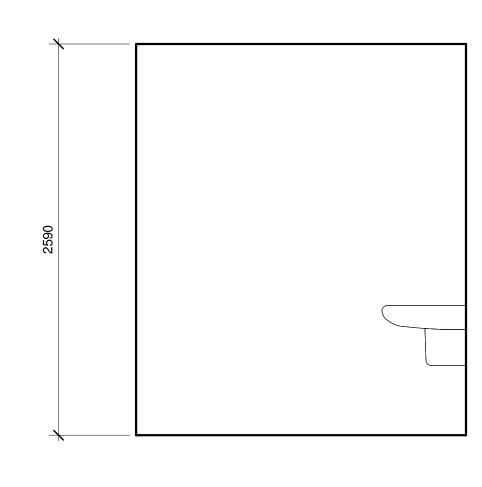


2 CD-ELIN-BF WASH - NORTH

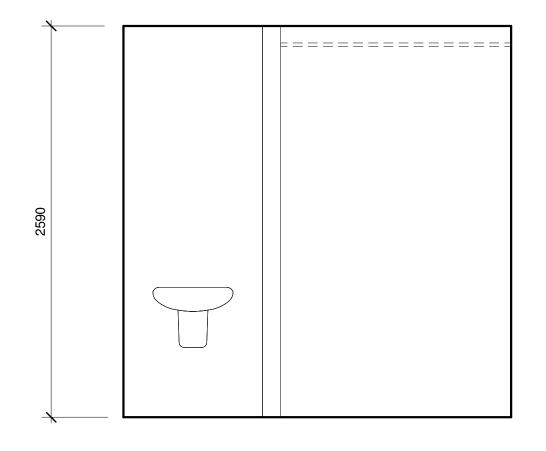

3 CD-ELIN-BF WASH -EAST

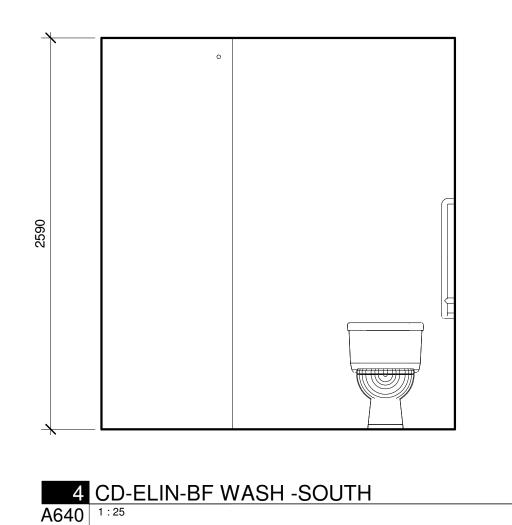

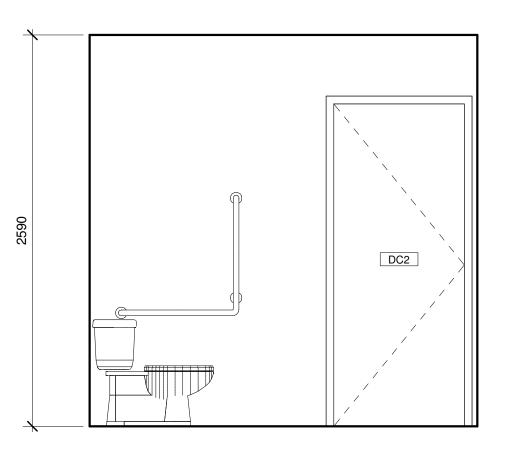

5 CD-ELIN-BF WASH -WEST A640 1:25

GENERAL NOTES:

1. *-*

KEYNOTES:

- 1 SINK
- 2 MILLWORK
- 3 DRYER
- 4 WASHER
- 5 LAUNDRY TUB
- 6 STACKED WASHER/DRYER
- 7 SHOWER CURTAIN ROD
- 8 WALL MOUNTED ACCESSIBLE LAVATORY WITH TOP LOCATED AT 840mm AFF. PROVIDE 16mm PLYWOOD BACKING BEHIND GYPSUM BOARD SEE MECHANICAL
- 9 WATER CLOSET. BARRIER FREE WATER CLOSETS TO BE 430mm MIN & 460mm MAX AFF WITH 900mm x 1500mm CLEAR TRANSFER SPACE C/W BACK SUPPORT SEE MECHANICAL.
- 10 NEW 915mm MILLWORK GATE
- NEW SURFACE MOUNTED WATER
 BOTTLE REFILL STATION. DISPENSING
 HEIGHT AT 1200mm AFF
- 12 100mm DEPTH WALL MOUNTED SHELF AT 1100mm AFF
- 13 SURFACE MOUNTED COAT HOOK AT 1200mm AFF, PROJECTION AT NOT MORE THAN 50mm
- 14 DOOR OPERATOR PUSH BUTTON
- 15 EMERGENCY CALL SYSTEM ACTIVATION BUTTON
- 16 EMERGENCY SIGN THAT CONTAINS THE WORDS:
 "IN THE EVENT OF EMERGENCY PUSH
 EMERGENCY BUTTON AND AUDIBLE AND VISUAL
- EMERGENCY BUTTON AND AUDIBLE AND VISUAL SIGNAL WILL ACTIVATE". PROVIDE SIGN IN LETTERS 25mm HIGH WITH A 5mm STROKE POSTED ABOVE EMERGENCY BUTTON
- 17 16mm PLYWOOD BACKING WALL REINFORCEMENT
- 18 MIRROR AT 1000mm AFF
- 19 SOAP DISPENSER W/ DISPENSING HEIGHT AT 1200mm AFF
- 20 WALL SURFACE MOUNTED COMBINATION PAPER TOWEL/WASTE RECEPTACLE W/ DISPENSING HEIGHT AT 1200mm AFF
- 21 SPACE FOR FUTURE ADULT-SIZE CHANGE TABLE. PROVIDE 16mm PLYWOOD BACKING BEHIND GYPSUM BOARD. PROVIDE ADEQUATE WALL REINFORCEMENT AND TABLE SUPPORT
- TOILET TISSUE DISPENSER TO BE INSTALLED NEXT TO BARRIER FREE WATER CLOSETS. LOCATE BELOW GRAB BAR, 600mm AFF IN LINE WITH OR NOT MORE THAN 300mm IN FRONT OF LEADING EDGE OF TOILET.
- 600mm HORIZONTAL STAINLESS STEEL GRAB BAR. PROVIDE 16mm PLYWOOD BACKING BEHIND GYPSUM BOARD
- L-SHAPED GRAB BAR: 750mm HORIZONTAL AND VERTICAL COMPONENTS. LOCATE HORIZONTAL COMPONENT AT 750mm AFF (850mm AFF IN SHOWERS) AND VERTICAL COMPONENT AT 150mm IN FRONT OF LEADING EDGE OF TOILET BOWL. PROVIDE 16mm PLYWOOD BACKING BEHIND GYPSUM BOARD
- 25 SANITARY NAPKIN DISPOSAL. PROVIDE 16mm PLYWOOD BACKING BEHIND GYPSUM BOARD
- 26 WALL MOUNTED EMERGENCY CALL VISUAL SIGNAL ABOVE
- DOOR BOTH WASHROOM AND CORRIDOR SIDE
- 27 FOLD DOWN GRAB BAR

CSV ARCHITECTS

613-729-7242

cunliffe@cunliffe.ca

email@chorley.com

sustainable design · conception écologique

613.564.8118 190 O'Connor Street, Suite 100 www.csv.ca Ottawa, Ontario,K2P 2R3

STRUCTURAL ENGINEER
Cunliffe & Associates
200, 1550 Carling Ave 2nd Floor
Ottawa, ON K1Z 8S8

MECHANICAL/ELECTRICAL ENGINEER Chorley + Bisset 250 City Centre Ave. Ottawa, ON K1R 1C7 613-241-0300

CIVIL ENGINEER
McIntosh Perry
115 Walgreen Road, R.R. 3
Carp, ON K0A 1L0
613-836-2184
www.mcintoshperry.com

STAMP

REV DATE ISSUE



NOTES

1. OWNERSHIP OF THE COPYRIGHT OF THE DESIGN AND THE WORKS EXECUTED FROM THE DESIGN REMAINS WITH CSV ARCHITECTS, AND MAY NOT BE REPRODUCED IN ANY FORM WITHOUT THE WRITTEN CONSENT OF CSV ARCHITECTS.

2. THE DRAWINGS, PRESENTATIONS AND SPECIFICATIONS AS INSTRUMENTS OF SERVICE ARE AND SHALL REMAIN THE PROPERTY OF CSV ARCHITECTS. THEY ARE NOT TO BE USED BY THE CLIENT ON OTHER PROJECTS OR ON EXTENSIONS TO THIS PROJECT WITHOUT THE WRITTEN CONSENT OF CSV ARCHITECTS.

3. THIS DRAWING IS TO BE READ IN CONJUNCTION WITH ALL OTHER PROJECT DRAWINGS AND SPECIFICATIONS.

4. DO NOT SCALE DRAWINGS. CONTRACTOR SHALL

BE RESPONSIBLE TO VERIFY DIMENSIONS ON SITE.
5. ALL WORK SHALL BE IN ACCORDANCE WITH THE

ONTARIO BUILDING CODE AND ALL SUPPLEMENTS AND APPLICABLE MUNICIPAL REGULATIONS.

CLIENT

78 ROSEMOUNT AVE INC.

OTTAWA ONTARIO, CANADA

PROJECT

K1Y 1P6


78 ROSEMOUNT AVE.


78 Rosemount Avenue, Ottawa, ON


WASHROOM DETAILS

PROJECT NO: 2021-1320
DRAWN: JW
APPROVED: JS
SCALE: As indicated
DATE PRINTED: 5/18/2022 11:09:37 AM

REV

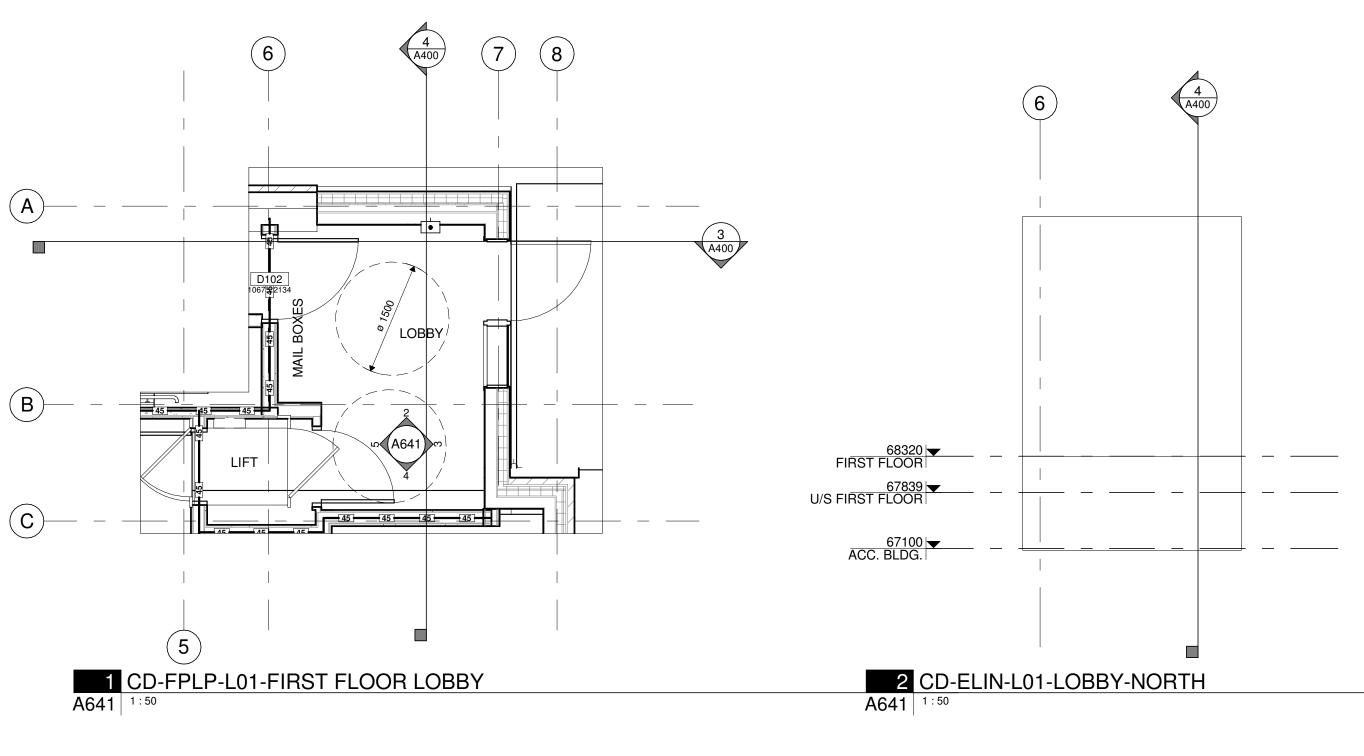

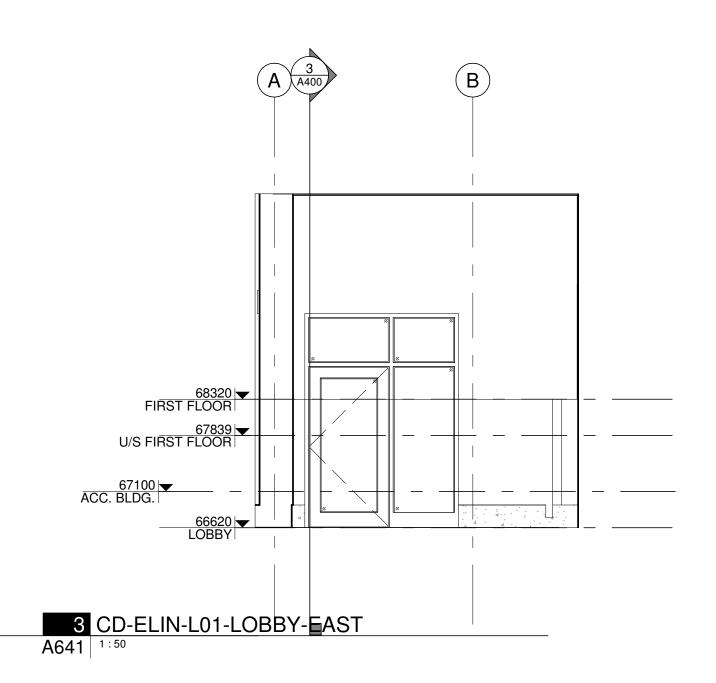

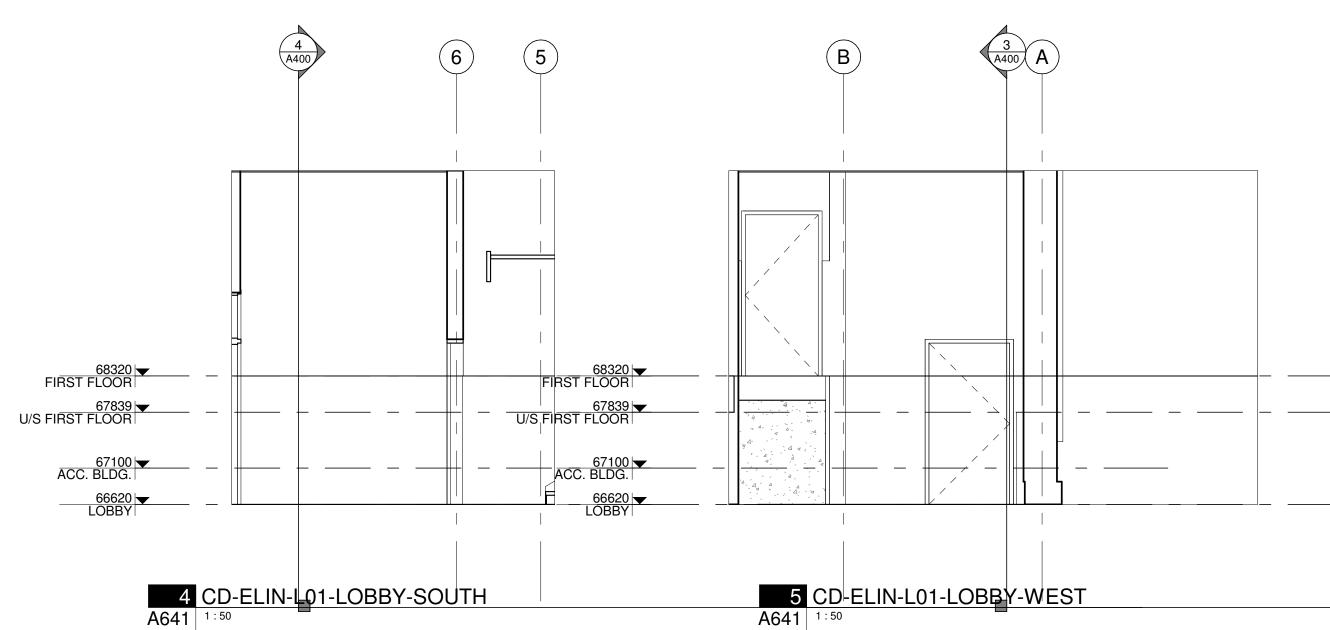

CSV ARCHITECTS

sustainable design · conception écologique

190 O'Connor Street, Suite 100 Ottawa, Ontario,K2P 2R3 613.564.8118 www.csv.ca

STRUCTURAL ENGINEER
Cunliffe & Associates
200, 1550 Carling Ave 2nd Floor
Ottawa, ON K1Z 8S8
613-729-7242
cunliffe@cunliffe.ca

MECHANICAL/ELECTRICAL ENGINEER
Chorley + Bisset
250 City Centre Ave.
Ottawa, ON K1R 1C7 613-241-0300 email@chorley.com

CIVIL ENGINEER McIntosh Perry 115 Walgreen Road, R.R. 3 Carp, ON K0A 1L0 613-836-2184 www.mcintoshperry.com

STAMP

REV DATE ISSUE



NOTES 1. OWNERSHIP OF THE COPYRIGHT OF THE DESIGN AND THE WORKS EXECUTED FROM THE DESIGN REMAINS WITH CSV ARCHITECTS, AND MAY NOT BE REPRODUCED IN ANY FORM WITHOUT THE WRITTEN CONSENT OF CSV ARCHITECTS.

2. THE DRAWINGS, PRESENTATIONS AND SPECIFICATIONS AS INSTRUMENTS OF SERVICE ARE AND SHALL REMAIN THE PROPERTY OF CSV ARCHITECTS. THEY ARE NOT TO BE USED BY THE CLIENT ON OTHER PROJECTS OR ON EXTENSIONS TO THIS PROJECT WITHOUT THE WRITTEN TO THIS PROJECT WITHOUT THE WRITTEN CONSENT OF CSV ARCHITECTS.

3. THIS DRAWING IS TO BE READ IN CONJUNCTION WITH ALL OTHER PROJECT DRAWINGS AND WITH ALL OTHER PROJECT DRAWINGS AND SPECIFICATIONS.

4. DO NOT SCALE DRAWINGS. CONTRACTOR SHALL BE RESPONSIBLE TO VERIFY DIMENSIONS ON SITE.

5. ALL WORK SHALL BE IN ACCORDANCE WITH THE ONTARIO BUILDING CODE AND ALL SUPPLEMENTS AND APPLICABLE MUNICIPAL REGULATIONS.

CLIENT

78 ROSEMOUNT AVE INC.

OTTAWA ONTARIO, CANADA

PROJECT

TITLE

78 ROSEMOUNT AVE.

78 Rosemount Avenue, Ottawa, ON K1Y 1P6


PLAN DETAILS AND INTERIOR ELEVATIONS PROJECT NO: 2021-1320

DRAWN: JW APPROVED: JS 1:50


DATE PRINTED: 5/18/2022 11:09:40 AM REV

DRAWING NO.


													A700	- Door Schedu	ıle									
		LOC	CATION			OPI	ENING						PANEL						FRAME					
MARK	ROOM NO.	ROOM NAME	ROOM NO.	ROOM NAME	WIDTH	HEIGHT	Γ R.O. WII	R.O. D HGT	TYPE	MATL FINISH	THICK	Doubl	e? Unequ	al? CONFIG	PANEL WIDTH	LEAF TYPE	LEAF WIDTH	FM Frame Type	MATL FINISI	I GLAZING MA	ATL RA	ATING HAR	RDWARE SET	COMMENTS
MECHAN	IICAL ROO	M																						
D002	294	ELECTRICAL	299	MECHANICAL	915	2134	1017	2185	F		44	No	No	SINGLE	915			FM1			1 H	HR (none	2)	
D003	295	COMM.	299	MECHANICAL	915	2134	1017	2185	F		44	No	No	SINGLE	915			FM1				(none	e)	
BASEME	NT																					_		
D004	251	EXIT STAIR 1			965	2134	1067	2185	F		44	No	No	SINGLE	965			FM1				(none	2)	
D005	244	CORRIDOR	251	EXIT STAIR 1	965	2134	1067	2185	F		44	No	No	SINGLE	965			FM1				(none	e)	
D106			231	BEDROOM 2	1829	2032	1930	2083	Р		44	Yes	No	PAIR	914							(none	e)	
D120	240	KITCHEN/DINING			592	2134	642	2159	F		44	No	No	SINGLE				FM1				(none	e)	
D121	238	KITCHEN/DINING			592	2134	642	2159	F		44	No	No	SINGLE	592			FM1				(none	e)	
LOBBY																								
D102			100	LOBBY	1067	2134	1169	2185	F		44	No	No	SINGLE	1067			FM1				(none	2)	
D130			100	LOBBY	2033	2185	1969	2153														(none	2)	
WEST G	RADE	_				_									_									
D105					965	2134	1067	2185	F		44	No	No	SINGLE	965			FM1				(none	2)	
FIRST FL	.OOR																							
D103	249	EXIT STAIR 1			965	2134	1067	2185	F		44	No	No	SINGLE	965			FM1				(none	2)	
D104			290	EXIT STAIR 2	965	2134	1067	2185	F		44	No	No	SINGLE	965			FM1				(none	2)	
D108					915	2134	1017	2185	F		44	No	No	SINGLE	915			FM1				(none	2)	
D109			100	LOBBY	965	2134	1067	2185	F		44	No	No	SINGLE	965			FM1				(none	2)	
D110	212	LIVING			1800	2050			FG		50							FM6				(none	e)	
D111	315	LIVING			1800	2050			FG		50							FM6				(none	e)	
D122	256	KITCHEN/DINING			592	2134	642	2159	F		44	No	No	SINGLE	592			FM1				(none	e)	
D123	204	KITCHEN/DINING			592	2134	642	2159	F		44	No	No	SINGLE	592			FM1				(none	e)	
SECOND	FLOOR																							
D113					813	2032	851	2083	F		44	No	No	SINGLE	813			FM4				(none	e)	
D200	324	EXIT STAIR 1	200	CORRIDOR	965	2134	1067	2185	F		44	No	No	SINGLE	965			FM1				(none	e)	
D201	200	CORRIDOR	309	EXIT STAIR 2	965	2134	1067	2185	F		44	No	No	SINGLE	965			FM1				(none	e)	
THIRD FL	_OOR																							
D107	375	KITCHEN/DINING			592	2134	642	2159	F		44	No	No	SINGLE	592			FM1				(none	e)	
D300	345	EXIT STAIR 1	300	CORRIDOR	965	2134	1067	2185	F		44	No	No	SINGLE	965			FM1				(none	e)	
D301	300	CORRIDOR	312	EXIT STAIR 2	965	2134	1067	2185	F		44	No	No	SINGLE	965			FM1				(none	2)	

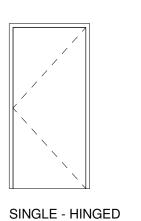


TYPE FM1

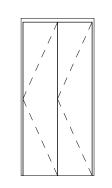


TYPE FM2

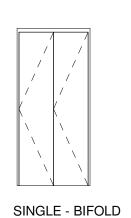


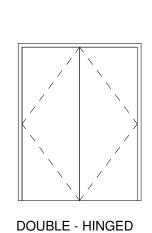


TYPE FM3

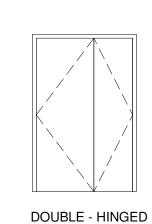


TYPE FM3.1

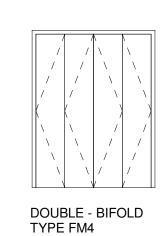


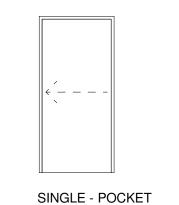

TYPE FM5

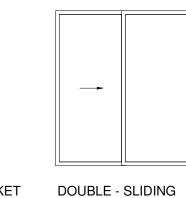

TYPE FM6

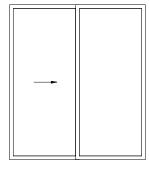


GLAZING LEGEND:


GL1 TEMPERED SAFETY GLAZING
GL2 INSULATED GLAZING UNIT - TEMPERED
GL3 FIRE RATED GLASS


			.OCI				lard			ey S	chec	lule))							
Key Name	Hardware Function Description	nic	Passage (Storeroom	Classroom	Electric Strike	Card Reader	Request For Exit	Door Contact	Closer	Astragal	Coordinator	Push/Pull	Kickplate	Drop Bolt	Floor Stop	Overhead Stop	Wall Stop	Weatherstrip	Threshold Sweep
HW1	Exit Door																			

DOOR FRAME LEGEND

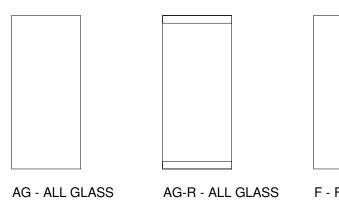


BOTTOM RAILS

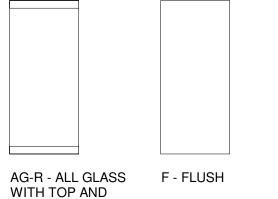


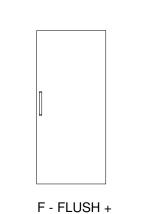


HARDWARE

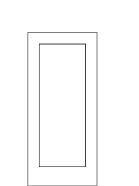


FG - FULL GLASS

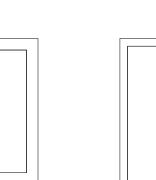


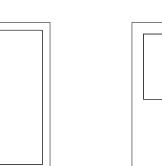


FG - FULL GLASS

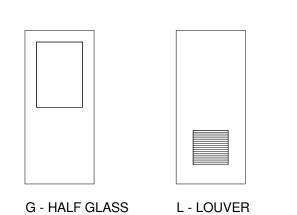


(BOTTOM)

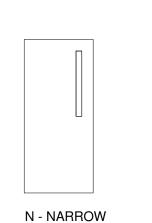


VISION LITE

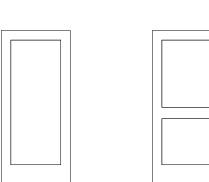

P - SINGLE PANEL P2 - 2 PANEL

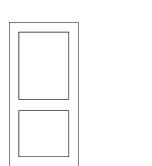

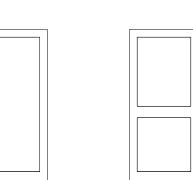

S - STOREFRONT

S2 - STOREFRONT + MIDDLE RAIL

DOOR PANEL LEGEND

CSV ARCHITECTS

sustainable design · conception écologique

613.564.8118 190 O'Connor Street, Suite 100 Ottawa, Ontario,K2P 2R3 www.csv.ca

STRUCTURAL ENGINEER Cunliffe & Associates 200, 1550 Carling Ave 2nd Floor Ottawa, ON K1Z 8S8 613-729-7242 cunliffe@cunliffe.ca

MECHANICAL/ELECTRICAL ENGINEER Chorley + Bisset 250 City Centre Ave. Ottawa, ON K1R 1C7 613-241-0300 email@chorley.com

CIVIL ENGINEER McIntosh Perry 115 Walgreen Road, R.R. 3 Carp, ON K0A 1L0 613-836-2184 www.mcintoshperry.com

STAMP

REV DATE ISSUE

NOTES 1. OWNERSHIP OF THE COPYRIGHT OF THE DESIGN AND THE WORKS EXECUTED FROM THE DESIGN REMAINS WITH CSV ARCHITECTS, AND MAY NOT BE REPRODUCED IN ANY FORM WITHOUT THE WRITTEN CONSENT OF CSV ARCHITECTS.

2. THE DRAWINGS, PRESENTATIONS AND SPECIFICATIONS AS INSTRUMENTS OF SERVICE ARE AND SHALL REMAIN THE PROPERTY OF CSV ARCHITECTS. THEY ARE NOT TO BE USED BY THE CLIENT ON OTHER PROJECTS OR ON EXTENSIONS TO THIS PROJECT WITHOUT THE WRITTEN TO THIS PROJECT WITHOUT THE WRITTEN CONSENT OF CSV ARCHITECTS.

3. THIS DRAWING IS TO BE READ IN CONJUNCTION WITH ALL OTHER PROJECT DRAWINGS AND WITH ALL OTHER PROJECT DRAWINGS AND SPECIFICATIONS.

4. DO NOT SCALE DRAWINGS. CONTRACTOR SHALL BE RESPONSIBLE TO VERIFY DIMENSIONS ON SITE.

5. ALL WORK SHALL BE IN ACCORDANCE WITH THE ONTARIO BUILDING CODE AND ALL SUPPLEMENTS AND APPLICABLE MUNICIPAL REGULATIONS.

CLIENT

78 ROSEMOUNT AVE INC.

OTTAWA ONTARIO, CANADA

PROJECT

TITLE

78 ROSEMOUNT AVE.

78 Rosemount Avenue, Ottawa, ON K1Y 1P6

DOOR SCHEDULE -COMMON AREAS

PROJECT NO: 2021-1320 DRAWN: JW APPROVED: JS

1:50 DATE PRINTED: 5/18/2022 11:09:41 AM

REV

DRAWING NO.

ROOM ROOM ROOM R.O. PANEL LEAF LEAF FM Frame		LOCATION			OPF	ENING						- Door Sched	auie Suiles				FRAM	ИE		
		ROOM		WIDTH					MATI FINISH	THIC			? CONFIG				rame		GLAZING MATI RATING	HARDWARE SET COMMENTS
P		TIOOWITH INC.						1112	WATE THAT			•					1017	(TE THRIOTT	GENZING WITTE TUTTING	
					_	_		F												
Control Cont		KITCHEN/DINING 347						F												
SO	1 237		BEDROOM 1	864	2134	966	2185	F					SINGLE	864						(none)
1	1 240							F												· · · ·
1	1 240			_				F												` '
*** PERFORM NYO	1 240							F												, ,
C	4							F												
STREAM S	4	BEDROOM 1						F												,
CL Beproof Sec S	4							F		_										
4	4			_				F								FM1				` '
Company	3	CL	BEDROOM 2					F								FM4				, ,
OCC 19	4			_				F												
2 W.C. \$50 \$11/4 \$57 \$11/4 \$10/4 \$10 \$1.0	2				2050			FG												,
Part	2	KITCHEN/DINING						F		_										
Part Manual Service Part Part Manual Service						_		F												
\$ 960 10	2	BEDROOM 1			2134		2185	F		44	No	No	SINGLE							(none)
1			BEDROOM 1	1829		1930		Р			Yes		PAIR	914						
2 VPAC OS UPING SS 202 125 265 C 50 VPAC SS 202 125 125 C C C C C C C C C	1	242	KITCHEN/DINING	915		965		F			No		SINGLF	915		FM4				
\$ WAST FORM Sep 174 186 F 44 No No 196 1964	2			1800	2050			FG												
S	1 372	CL 356	1					Р								F				
S ULYNO SERROCAT 44 25 36 215 5 44 10 10 5 5 5 44 10 10 5 5 5 6 44 10 10 5 5 6 6 6 6 6 6 6 6	3	W/C						F												
3	3							F												
3 BLEDROOM 2 NITCHENDING S20 157 158 144 No. No. SINGLE 134 145	3							F												
S	3		BEDROOM 2	864		966	2185	F												
2 LIVING 1 800 2550 1944 1950 1			KITCHEN/DINING	1525		1575	2125	I			110	INO	OIIVALL			1 101-4				
1 336 RITCHINDANNO 582 2134 612 2156 F 44 No. No. SINGLE 582 PM1 Development 1 PM1	2					851	2083	F			No	No	SINGLE	813						
2 CORRICOR 965 2134 1067 2155 F 44 No No No SINGLE 965 PM1 Correct 1 33 WC 613 2234 616 2134 966 2155 F 44 No No No SINGLE 963 PM1 Correct 1 374 CL 355 BEDROM2 72 2023 72 2025 F 44 No No No SINGLE 964 PM1 Correct 1 374 CL 355 EDROM2 72 2023 72 2025 F 44 No No No SINGLE 72 PM4 Correct 1 374 CL 355 EDROM2 72 2023 72 2023 F 44 No No No SINGLE 72 PM4 Correct 1 374 CL 355 EDROM2 72 2023 F 44 No No No SINGLE 72 PM4 Correct 1 374 CL 355 EDROM2 72 2023 F 44 No No No SINGLE 72 PM4 Correct 1 32 EDROM3 32 CORRECT MARKED MARK	2					642	2150	FG			No	No	SINGLE	502						
1		KITCHEN/DINING						F												` '
1 S74 CL 90 BEDROOM 782 2022 812 2057 F	1	333	W/C	813				F			No					FM1				
1	1 074							F												
2	1 3/4	GL 305	BEDROOM 2					F						_						
1	2					1270	2000	FG			110	110	Ontall	1220						
1 22 BEDROOM 1 827 ENSUTE 884 2032 940 2070 F 44 No No SINGLE 884 FM5 (none) 1 373 CL 326 BEDROOM 1 1804 2032 940 2070 F 5 44 No No SINGLE 154 FM6 (none) 1 373 CL 326 BEDROOM 1 884 2134 986 2185 F 44 No No SINGLE 154 FM1 (none) 1 380 BEDROOM 1 884 2032 940 2070 F 44 No No SINGLE 884 FM1 (none) 1 382 KITCHENDINING 88 1285 F 44 No No SINGLE 884 FM6 (none) 1 382 KITCHENDINING 88 1285 F 44 No No SINGLE 884 FM4 (none) 1 382 KITCHENDINING 78 BEDROOM 2 88 2185 F 44 No No SINGLE 884 FM4 (none) 1 382 KITCHENDINING 78 BEDROOM 2 884 2134 986 2185 F 44 No No SINGLE 884 FM4 (none) 1 382 KITCHENDINING 78 BEDROOM 1 1524 2032 1285 F 44 No No SINGLE 884 FM4 (none) 1 382 KITCHENDINING 78 BEDROOM 2 88 2185 F 44 No No SINGLE 884 FM4 (none) 1 382 KITCHENDINING 78 BEDROOM 2 88 2185 F 44 No No SINGLE 884 FM4 (none) 1 382 KITCHENDINING 78 BEDROOM 2 88 2185 F 44 No No SINGLE 884 FM4 (none) 1 382 KITCHENDINING 78 BEDROOM 2 88 2185 F 44 No No SINGLE 884 FM4 (none) 1 382 KITCHENDINING 78 BEDROOM 3 182 2023 1286 2083 F 44 No No SINGLE 884 FM4 (none) 1 382 KITCHENDINING 78 BEDROOM 1 1524 2032 1285 F 44 No No SINGLE 884 FM4 (none) 1 382 KITCHENDINING 78 BEDROOM 1 1524 2032 1285 F 44 No No SINGLE 884 FM4 (none) 1 382 KITCHENDINING 78 BEDROOM 1 1524 2032 1285 F 44 No No SINGLE 883 FM4 (none) 1 382 KITCHENDINING 78 BEDROOM 1 1524 2032 1285 F 44 No No SINGLE 884 FM4 (none) 1 382 KITCHENDINING 78 BEDROOM 1 1524 2032 1285 F 44 No No SINGLE 884 FM4 (none) 1 382 KITCHENDINING 78 BEDROOM 1 1524 2032 1285 F 44 No No SINGLE 884 FM4 (none) 1 382 KITCHENDINING 78 BEDROOM 1 1524 2032 1285 F 44 No No SINGLE 884 FM4 (none) 1 382 KITCHENDINING 78 BEDROOM 1 1524 2032 1285 F 44 No No SINGLE 884 FM4 (none) 1 382 KITCHENDINING 78 BEDROOM 1 1524 2032 1285 F 44 No No SINGLE 884 FM4 (none) 1 382 KITCHENDINING 78 BEDROOM 1 1524 2032 1285 F 44 No No SINGLE 884 FM4 (none) 1 382 KITCHENDINING 78 BEDROOM 1 1524 2032 1285 F 54 M4 NO NO SINGLE 884 FM4 (none) 1 382 KITCHENDINING 78 BEDROOM 1 1524 2032 1285 F 14 M4 NO NO SINGLE 884 FM4 (none) 1 382 KITCHENDINING 78 BEDROOM	1							F												
2 8EDROOM 1 3 1800 2090 1800 1800 2090 1800 1800 2090 1800 1	1 326							F												
1 382 KITCHENDINING 380 BEDROOM 1 884 2134 986 2185 F 44 No No SINGLE 884 FM5 (none) 1 380 BEDROOM 1 381 ENSURE 864 2032 940 2070 F 44 No No SINGLE 864 FM5 (none) 1 382 KITCHENDINING 378 BEDROOM 2 844 2134 986 2185 F 44 No No SINGLE 864 FM1 (none) 1 382 KITCHENDINING 378 BEDROOM 2 844 2134 986 2185 F 44 No No SINGLE 864 FM1 (none) 1 379 CL 378 BEDROOM 2 752 2032 812 2057 F 44 No No SINGLE 864 FM1 (none) 1 382 KITCHENDINING 378 SEDROOM 2 844 2032 1828 5 F 44 No No SINGLE 864 FM1 (none) 1 382 KITCHENDINING 377 W/G 380 BEDROOM 1 1524 2032 1828 2057 F 44 No No SINGLE 752 FM4 (none) 1 382 KITCHENDINING 377 W/G 380 BEDROOM 1 1524 2032 1828 2033 F 44 No No SINGLE 864 FM1 (none) 1 244 CORRIDOR 311 EXITSTAR 2 1677 2194 1107 2185 F 44 No No SINGLE 813 FM1 (none) 1 244 CORRIDOR 311 EXITSTAR 2 1677 2194 1107 2185 F 44 No No SINGLE 1220 FM4 (none) 1 244 CORRIDOR 311 EXITSTAR 2 1677 2194 1107 2185 F 44 No No SINGLE 16057 FM1 (none) 1 244 CORRIDOR 311 EXITSTAR 2 1677 2194 1107 2185 F 44 No No SINGLE 16057 FM1 (none) 1 244 CORRIDOR 311 EXITSTAR 2 1677 2194 1107 2185 F 44 No No SINGLE 16057 FM1 (none) 250 MECHANICAL 315 2134 1107 2185 F 44 No No SINGLE 16057 FM1 (none)				_		0.10	2070	FG			110		Ontall			FM6				
1 380 BEDROOM 1 381 ENSUITE 884 2032 940 2070 F					_	_		F						_						
1 382 KITCHENDINING 378 BEDROM 2 84 2134 96 2185 F 444 No No SINGLE 864 FM1 (none) (_				F												
1 379 CL 378 BEDROM 2 762 2032 812 2057 F 44 No No SINGLE 762 FM4 (none) 1 366 CL 380 BEDROM 1 1524 2032 1626 2033 F 44 No No SINGLE 1524 FM4 (none) 1 382 KITCHENDININO 377 W°C 813 2134 915 2185 F 44 No No SINGLE 813 FM1 (none) 1 244 CORRIDOR 311 EXITTAIR 2 1067 2144 1169 2185 F 44 No No SINGLE 1220 FM4 (none) 1 244 CORRIDOR 311 EXITTAIR 2 1067 2144 1169 2185 F 44 No No SINGLE 1067 FM1 (none) 1 244 CORRIDOR 311 EXITTAIR 2 1067 2144 1169 2185 F 44 No No SINGLE 1067 FM1 (none) 1 244 CORRIDOR 310 EXITTAIR 2 1067 2144 1169 2185 F 44 No No SINGLE 1067 FM1 (none) 1 244 CORRIDOR 310 EXITTAIR 2 1067 2185 F 44 No No SINGLE 1067 FM1 (none) 1 244 CORRIDOR 310 EXITTAIR 2 1067 2185 F 44 No No SINGLE 1067 FM1 (none) 1 244 CORRIDOR 310 EXITTAIR 2 1067 2185 F 44 No No SINGLE 1067 FM1 (none) 1 244 CORRIDOR 310 EXITTAIR 2 1067 2185 F 44 No No SINGLE 1067 FM1 (none) 1 244 CORRIDOR 310 EXITTAIR 2 1067 2185 F 44 No No SINGLE 1067 FM1 (none) 1 244 CORRIDOR 310 EXITTAIR 2 1067 2185 F 44 No No SINGLE 1067 FM1 (none) 1 244 CORRIDOR 310 EXITTAIR 2 1067 2185 F 44 No No SINGLE 1067 FM1 (none) 1 24 CORRIDOR 310 EXITTAIR 2 1067 2185 F 44 No No SINGLE 1067 FM1 (none) 24 CORRIDOR 310 EXITTAIR 2 1067 2185 F 44 No No SINGLE 1067 FM1 (none) 24 CORRIDOR 310 EXITTAIR 2 1067 2185 F 1067 2185						_		F												(none)
1 366 CL 330 BEDROM1 1524 2032 1826 2083 F 444 No No SINGLE 1524 FM4 1 362 KITCHEN/DINING 377 W/C 813 2134 915 2185 F 444 No No SINGLE 120 FM4 1 362 KITCHEN/DINING 1220 2032 1270 2083 F 444 No No SINGLE 120 FM4 1 244 CORRIDOR 311 EXITSTAR 2 1067 2134 1169 2185 F 444 No No SINGLE 1067 FM1 1 299 MECHANICAL 915 2134 1017 2185 F 444 No No SINGLE 1067 FM1 1 299 MECHANICAL 915 2134 1017 2185 F 444 No No SINGLE 1067 FM1 1 299 MECHANICAL 915 2134 1017 2185 F 444 No No SINGLE 1067 FM1 1 366 CL 330 BEDROM1 1524 2032 1826 F 144 No No No SINGLE 1067 FM4 1 244 CORRIDOR 311 EXITSTAR 2 1067 2134 1017 2185 F 444 No No SINGLE 1067 FM1 1 299 MECHANICAL 915 2134 1017 2185 F 444 No No No SINGLE 1067 FM1 1 299 MECHANICAL 915 2134 1017 2185 F 444 No No No SINGLE 1067 FM1 1 368 CL 330 BEDROM1 1524 FM4 1 1 244 CORRIDOR 311 EXITSTAR 2 1067 2134 1017 2185 F 444 No No No SINGLE 1067 FM1 1 1 244 CORRIDOR 311 EXITSTAR 2 1067 2134 1017 2185 F 444 No No No SINGLE 1067 FM1 1 1 249 CORRIDOR 311 EXITSTAR 2 1067 2134 1017 2185 F 444 No No No SINGLE 1067 FM1 1 299 MECHANICAL 915 2134 1017 2185 F 444 No No No SINGLE 1067 FM1 1 200 DOUBLE-HINGED DOUBLE-HINGED DOUBLE-HINGED TYPE FM3.1 TEMPERED SAFETY GLAZING GLAZING UNIT - TEMPERED SAFETY GLAZING GLAZING UNIT - TEMPERED SAFETY GLAZING GLAZING UNIT - TEMPERED GLAZING UNIT - TEMP								F												
1 362 KITCHEN/DINING 377 W.C 813 2134 915 2185 F 44 No No SINGLE 813 FM1 (none) 1 244 CORRIDOR 311 EXITSTAIR 2 1067 2134 1169 2185 F 44 No No SINGLE 1220 FM4 (none) 1 299 MECHANICAL 915 2134 1017 2185 F 44 No No SINGLE 915 FM1 (none) 299 MECHANICAL 915 2134 1017 2185 F 44 No No SINGLE 915 FM1 (none) 1 244 CORRIDOR 311 EXITSTAIR 2 1067 2134 1169 2185 F 44 No No SINGLE 915 FM1 (none) 299 MECHANICAL 915 2134 1017 2185 F 44 No No SINGLE 915 FM1 (none) 299 MECHANICAL 915 PM1 (none) 299 MECHANICAL 915 PM1 (none) 299 MECHANICAL 915 PM1 (none) 200 MECHANICAL 915 PM1 (none) 201 TEMPERED SAFETY GLAZING GI2 INSULATED GL								F												` '
1 244 CORRIDOR 311 EXIT STAIR 2 1067 2134 1169 2185 F 44 No No SINGLE 1067 FM1 (none) A700 - Door Hardware (Key Schedule) A700 - Door Hardware (Key Schedule) GLAZING LEGEND: GLI TEMPERED SAFETY GLAZING GLI TEMPERED SAFETY G								F												
TOOR FRAME LEGEND	1							F												
A700 - Door Hardware (Key Schedule) GLZ INSULEGEND: GL1 TEMPERED SAFETY GLAZING GL2 INSULATED GLAZING UNIT - TEMPERED GL2 INSULATED GLAZING UNIT - TEMPERED GL2 INSULATED GLAZING UNIT - TEMPERED GL2 INSULATED GLAZING GL3 FIRE RATED GLASS DOUBLE - HINGED DOUBLE - HINGED TYPE FM3.11 DOOR FRAME LEGEND HW1 Exit Door HW1 Exit Door	1 244							F						_						
A700 - Door Hardware (Key Schedule) GLAZING LEGEND: GLAZING LEGEND: GLAZING LEGEND: GLAZING LEGEND: GLAZING LEGEND: GLAZING UNIT - TEMPERED SAFETY GLAZING GLAZING UNIT - TEMPERED Function TYPE FM3.1 DOUBLE - HINGED TYPE FM3.1 DOUBLE - HINGED TYPE FM3.1 DOUBLE - HINGED TYPE FM3.1 DOUBLE - BIFOLD TYPE FM3.1 TYPE FM3.1 DOUBLE - BIFOLD TYPE FM3.1 DOUB			WEOTANIOAL	913	2134	1017	2103	I		44	INO	INO	SINGLE	913		I IVII				(none)
	GLE - HINGED SINGLE - E FM1 TYPE FM2	BIFOLD DOUBLE - HINGED TYPE FM3	DOUBLE - HINGED TYPE FM3.1		DOUBLE - B		SII	INGLE - POCKET	DOUBLE - SLIDIN	NG			GL1 GL2	TEMPEREI INSULATEI	D SAFETY GL D GLAZING U			_	Hardware Function E C	ric Strike ric Strike ric Strike est For Exit GS Contact dinator Pull Bolt Stop head Stop
- ALL GLASS AG-R - ALL GLASS F - FLUSH F - FLUSH + FG - FULL GLASS FG - FULL GLASS G - HALF GLASS L - LOUVER N - NARROW P - SINGLE PANEL P2 - 2 PANEL S - STOREFRONT S2 - STOREFRONT WITH TOP AND HARDWARE BOTTOM RAILS - ALL GLASS F - FLUSH F - FLUSH + FG - FULL GLASS FG - FULL GLASS G - HALF GLASS L - LOUVER N - NARROW P - SINGLE PANEL P2 - 2 PANEL S - STOREFRONT S2 - STOREFRONT S2 - STOREFRONT HARDWARE - MIDDLE RAIL - MIDDLE RAIL	WITH TOF	P AND	F - FLUSH + HARDWARE	FG - FULL	GLASS	FG - FULL	Ĺ	G - HALF GLA	ASS L - LOUVEI (BOTTOM)	∃	N - NAR VISION I	ROW LITE	P - SINGLE	E PANEL	P2 - 2 PANE	L S - STO	REFRONT	S2 - STOREFF + MIDDLE RAI	ONT -	

CSV ARCHITECTS

sustainable design · conception écologique

190 O'Connor Street, Suite 100 613.564.8118 Ottawa, Ontario,K2P 2R3 www.csv.ca

STRUCTURAL ENGINEER Cunliffe & Associates
200, 1550 Carling Ave 2nd Floor
Ottawa, ON K1Z 8S8
613-729-7242 cunliffe@cunliffe.ca

MECHANICAL/ELECTRICAL ENGINEER
Chorley + Bisset
250 City Centre Ave.
Ottawa, ON K1R 1C7 613-241-0300 email@chorley.com

CIVIL ENGINEER McIntosh Perry 115 Walgreen Road, R.R. 3 Carp, ON K0A 1L0 613-836-2184 www.mcintoshperry.com

STAMP

REV DATE ISSUE

NOTES

1. OWNERSHIP OF THE COPYRIGHT OF THE DESIGN AND THE WORKS EXECUTED FROM THE DESIGN REMAINS WITH CSV ARCHITECTS, AND MAY NOT BE REPRODUCED IN ANY FORM WITHOUT THE WRITTEN CONSENT OF CSV ARCHITECTS.

2. THE DRAWINGS, PRESENTATIONS AND SPECIFICATIONS AS INSTRUMENTS OF SERVICE ARE AND SHALL REMAIN THE PROPERTY OF CSV ARCHITECTS. THEY ARE NOT TO BE USED BY THE CLIENT ON OTHER PROJECTS OR ON EXTENSIONS TO THIS PROJECT WITHOUT THE WRITTEN CONSENT OF CSV ARCHITECTS.

3. THIS DRAWING IS TO BE READ IN CONJUNCTION WITH ALL OTHER PROJECT DRAWINGS AND SPECIFICATIONS.

4. DO NOT SCALE DRAWINGS. CONTRACTOR SHALL BE RESPONSIBLE TO VERIFY DIMENSIONS ON SITE.

5. ALL WORK SHALL BE IN ACCORDANCE WITH THE ONTARIO BUILDING CODE AND ALL SUPPLEMENTS AND APPLICABLE MUNICIPAL REGULATIONS.

CLIENT

78 ROSEMOUNT AVE INC.

OTTAWA ONTARIO, CANADA

PROJECT

TITLE

78 ROSEMOUNT AVE.

78 Rosemount Avenue, Ottawa, ON K1Y 1P6

DOOR SCHEDULE -**SUITES**

PROJECT NO: 2021-1320 DRAWN: JW APPROVED: JS 1:50

DATE PRINTED: 5/18/2022 11:09:41 AM


REV

DRAWING NO.

				W	indow Sched	lule			
Mark	Room: Number	Room: Name	Туре	Width	Height	Sill Height	Head Height	Glazing Type	Comments
BASEMEN ^T	Т								
W001A			С	1800	1500	600	2100		
W001B	236	BEDROOM 1	С	1800	1500	600	2100		
W002A	231	BEDROOM 2	D	1000	1200	1119	2319		
W002B			С	1800	1500	800	2300		
W002C	239	LIVING	С	1800	1500	800	2300		
W003A			С	1800	1500	800	2300		
W003B			С	1800	1500	800	2300		
FIRST FLO	OR								
W101A			Α	1000	1800	800	2600		
W102A	202	BEDROOM 2	Α	1000	1800	800	2600		
W102B			В	2600	1800	240	2040		
W103B			В	2600	1800	240	2040		
W103C			Α	1000	1800	800	2600		
W103D	334	BEDROOM 2	Α	1000	1800	800	2600		
SECOND F	LOOR								
W201A			Α	1000	2050	0	2050		
W201B	326	BEDROOM 1	Α	1000	2050	0	2050		
W201C			Α	1000	1800	800	2600		
W201D			В	2600	1800	253	2053		
W202A	218	BEDROOM 2	Α	1000	1800	800	2600		
W202B			В	2600	1800	250	2050		
W202C	350	LIVING	Α	1000	2050	0	2050		
W203A			Α	1000	2050	0	2050		
W203B			В	2600	1800	250	2050		
W203C			Α	1000	1800	800	2600		
W203D	339	BEDROOM 2	Α	1000	1800	800	2600		
W210	324	EXIT STAIR 1	Α	1000	1800	800	2600		
THIRD FLC	OR							<u> </u>	
W002D			110	103	103	2600	2703		
W002E			110	103	103	2600	2703		
W301A			Α	1000	2050	0	2050		
W301B	380	BEDROOM 1	Α	1000	2050	0	2050		
W301C			Α	1000	1800	800	2600		
W301D			В	2600	1800	253	2053		
W302A	313	BEDROOM 2	Α	1000	1800	800	2600		
W302B			В	2600	1800	250	2050		
W302C	346	LIVING	Α	1000	2050	0	2050		
W303A			Α	1000	2050	0	2050		
W303B			В	2600	1800	250	2050		
W303C			A	1000	1800	800	2600		
W303D	344	BEDROOM 2	A	1000	1800	800	2600		
W310	345	EXIT STAIR 1	A	1000	1800	800	2600		

GLAZING LEGEND:

- GL1 TEMPERED SAFETY GLAZING GL2 INSULATED GLAZING UNIT TEMPERED GL3 FIRE RATED GLASS

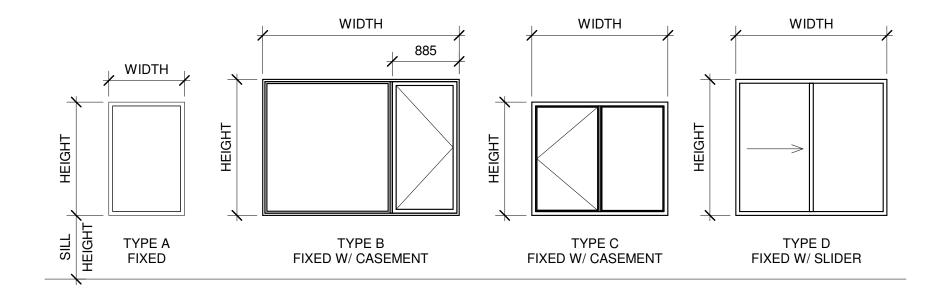

WINDOW LEGEND

CSV ARCHITECTS

sustainable design · conception écologique

613.564.8118 190 O'Connor Street, Suite 100 Ottawa, Ontario,K2P 2R3 www.csv.ca

STRUCTURAL ENGINEER Cunliffe & Associates 200, 1550 Carling Ave 2nd Floor Ottawa, ON K1Z 8S8 613-729-7242 cunliffe@cunliffe.ca

MECHANICAL/ELECTRICAL ENGINEER
Chorley + Bisset
250 City Centre Ave.
Ottawa, ON K1R 1C7 613-241-0300 email@chorley.com

CIVIL ENGINEER McIntosh Perry 115 Walgreen Road, R.R. 3 Carp, ON K0A 1L0 613-836-2184 www.mcintoshperry.com

STAMP

REV DATE ISSUE

NOTES

1. OWNERSHIP OF THE COPYRIGHT OF THE DESIGN AND THE WORKS EXECUTED FROM THE DESIGN REMAINS WITH CSV ARCHITECTS, AND MAY NOT BE REPRODUCED IN ANY FORM WITHOUT THE WRITTEN CONSENT OF CSV ARCHITECTS.

2. THE DRAWINGS, PRESENTATIONS AND SPECIFICATIONS AS INSTRUMENTS OF SERVICE ARE AND SHALL REMAIN THE PROPERTY OF CSV ARCHITECTS. THEY ARE NOT TO BE USED BY THE CLIENT ON OTHER PROJECTS OR ON EXTENSIONS TO THIS PROJECT WITHOUT THE WRITTEN CONSENT OF CSV ARCHITECTS.

3. THIS DRAWING IS TO BE READ IN CONJUNCTION WITH ALL OTHER PROJECT DRAWINGS AND SPECIFICATIONS.

4. DO NOT SCALE DRAWINGS. CONTRACTOR SHALL BE RESPONSIBLE TO VERIFY DIMENSIONS ON SITE.

5. ALL WORK SHALL BE IN ACCORDANCE WITH THE ONTARIO BUILDING CODE AND ALL SUPPLEMENTS AND APPLICABLE MUNICIPAL REGULATIONS.

CLIENT

78 ROSEMOUNT AVE INC.

OTTAWA ONTARIO, CANADA

PROJECT

TITLE

REV

78 ROSEMOUNT AVE.

78 Rosemount Avenue, Ottawa, ON K1Y 1P6

WINDOW SCHEDULE

PROJECT NO: 2021-1320 DRAWN: JW APPROVED: JS

1:50 DATE PRINTED: 5/18/2022 11:09:42 AM

DRAWING NO.