

TRAVEL DISTANCE LEGEND - BUILDING B

- TD-1 - 15 M
- TD-2 - 15 M
- TD-3 - 15 M
- TD-4 - 15 M
- TD-5 - 15 M
- TD-6 - 15 M
- TD-7 - 15 M
- TD-8 - 15 M
- TD-9 - 15 M
- TD-10 - 15 M

TRAVEL DISTANCE LEGEND - BUILDING C

- TD-1 - 15 M
- TD-2 - 15 M
- TD-3 - 15 M
- TD-4 - 15 M
- TD-5 - 15 M

LIFE SAFETY LEGEND

- PATH OF TRAVEL
- TRAVEL DISTANCE
- 1hr FIRE SEPARATION

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SCALE



CLIENT REF. #

PROJECT

ACCESS STORAGE WILLOWLEA

KEY PLAN

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2011/10/20 ISSUED FOR 33% REVIEW

PROJECT NO: 219-00059-00 DATE: NOV 11, 2021

ORIGINAL SCALE: As indicated IF THIS BAR IS NOT SHOWN, PLEASE YOUR PLOTTING SCALE.

DESIGNED BY: Designer

DRAWN BY: Author


CHECKED BY: Checker

DISCIPLINE: ARCHITECTURAL

TITLE: BUILDING B & C - TRAVEL DISTANCE PLANS

SHEET NUMBER: A1.1

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GENERAL NOTES

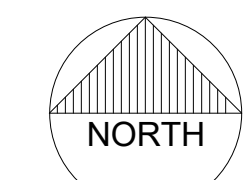
1. ALL DIMENSIONS IN MILLIMETERS UNLESS NOTED OTHERWISE.
2. SITE CONFIRM ALL EXISTING SITE CONDITIONS. VERIFY DIMENSIONS AS REQUIRED BEFORE COMMENCING WORK.
3. ALL DIMENSIONS TAKEN TO FINISHED FACE OF PARTITION, FACE OF CONCRETE BLOCK, OR TO FACE OF CAST IN PLACE CONCRETE UNLESS NOTED OTHERWISE.
4. WHERE DOOR JAMBES IN STUD PARTITIONS ARE CLOSE TO ADJACENT PERPENDICULAR WALL EDGE - OFFSET MINIMUM 150mm FROM WALLS UNLESS OTHERWISE NOTED. ALL BUILDING ASSEMBLIES TO BE READ IN CONJUNCTION WITH LIFE SAFETY PLANS A0.11 AND A0.12.

- SELF STORAGE
- A 5X5
- B 10X5
- C 10X10
- D 10X15
- E 10X20
- F 10X25
- F 10X24'9"
- G 15X5

CONSULTANT - SUB CONSULTANT

CONSULTANT - SUB CONSULTANT

SCALE

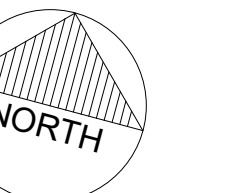

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ACCESS PROPERTY DEVELOPMENT  
 ACCESS GROUP OF COMPANIES  
 ACCESS PROPERTY DEVELOPMENT

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ACCESS STORAGE WILLOWLEA

KEY PLAN

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RE			

PROJECT NO	219-0005-00	DATE	NOV 11, 2021
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DESIGNED BY:	J.C.
DRAWN BY:	AS
CHECKED BY:	J.C.

DISCIPLINE

ARCHITECTURAL

TITLE

BUILDING B & C - LOCKER FLOOR PLANS

SHEET NUMBER


A1.2

OF

ISSUED FOR 33% REVIEW

DATE OF

1 GROUND FLOOR PLAN  
 A1.2  
 1:125

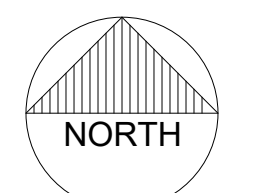




GENERAL ROOF NOTES

- DO NOT SCALE DRAWINGS AND DETAILS.
- CONTRACTOR TO VERIFY ALL DIMENSIONS ON SITE AND REPORT ANY DISCREPANCIES PRIOR TO COMMENCEMENT OF WORK IN THE CONTRACT.
- CONTRACTOR IS RESPONSIBLE TO IDENTIFY THE LOCATION OF ELECTRICAL, MECHANICAL, CONDUITS RUNNING INSIDE, ALONG AND/OR THE UNDERSIDE OF THE STRUCTURAL DECK BEFORE ANY ROOFING COMPONENTS ARE MECHANICALLY SECURED.
- CONTRACTOR IS RESPONSIBLE TO ENSURE ALL HEALTH AND SAFETY REGULATIONS ARE FOLLOWED DURING ROOF INSTALLATION AND FALL ARREST EQUIPMENT IS INSTALLED AND UTILIZED.
- COMMENCEMENT OF ANY WORK IS ONLY TO BE STARTED WHEN CONTRACTOR HAS RECEIVED REVIEWED AND/OR REVIEWED AS NOTED ROOFING SHOP DRAWINGS FROM THE CONSULTANT. PROVIDE ENLARGED DETAILED SECTION VIEWS AT MIN. 1:10 SCALE OF ROOFING SHOP DRAWINGS, INCLUDING BUT NOT LIMITED TO: ROOF DRAINS, ROOF DOWL, ROOF EXHAUST, MECHANICAL ROOF TOP UNIT CURBS, SLEEPERS, CURBS, CURBS, PARAPETS, HISS UNIT OR EQUIPMENT SUPPORTS, GAS PIPE SUPPORT, PERIMETER PARAPETS AND/OR CURBS, VENTS, FLASHINGS, AND ANY PENETRATIONS THRU NEW ROOFING SYSTEM. REFER TO SPECIFICATIONS FOR ADDITIONAL REQUIREMENTS.
- DO NOT SCALE DRAWINGS AND DETAILS.
- CONTRACTOR TO VERIFY ALL DIMENSIONS ON SITE AND REPORT ANY DISCREPANCIES PRIOR TO COMMENCEMENT OF WORK IN THE CONTRACT.
- COMMENCEMENT OF ANY WORK IS ONLY TO BE STARTED WHEN CONTRACTOR HAS RECEIVED REVIEWED AND/OR REVIEWED AS NOTED FROM THE CONSULTANT OF AN ENLARGED ASSEMBLY VIEW OF THE NEW ROOF SYSTEM. THIS SKETCH IS TO BE SUBMITTED IN COLOR FORMAT AND DESCRIBES ALL COMPONENTS OF THE ROOFING SYSTEM INCLUDING BUT NOT LIMITED TO: CAP SHEET MEMBRANE, BASE SHEET MEMBRANE, FIBREBOARD, SLOPED INSULATION, INSULATIONS, VAPOUR RETARDER, PRIMERS, ALL FASTENERS, ETC., DIFFERENTIATE EACH ROOFING COMPONENT IN CONTRASTING COLOR. ALSO, PROVIDE DATA CUT SHEETS OF EACH ROOFING COMPONENT TO BE LISTED AND USED.
- INSTALL ROOF ASSEMBLY IN STRICT ACCORDANCE WITH ROOFING MANUFACTURERS MOST RECENT PRINTED BEST PRACTICES, SPECIFICATIONS AND/OR DETAILS.
- REFER TO SPECIFICATIONS SECTION "MODIFIED BITUMINOUS MEMBRANE ROOFING" SYSTEM.
- PROVIDE 100 WIDE METAL CLEATS AT 300 C.C. FOR SUPPORT OF MAIN PREFINISHED CAP FLASHINGS FOR TOPS OF ALL PARAPETS AND UPSTANDS (TYP FOR EXTERIOR SIDES OF PARAPET AND ON THE INTERIOR SIDE OF PARAPETS USE ADHESIVE RECOMMENDED BY ROOFING MANUFACTURER).
- BENEATH PREFINISHED METAL CAP FLASHINGS, EXTEND ROOFING MEMBRANES UP AND OVER CURBS AND UPSTANDS (I.E. DO NOT TERMINATE ROOFING MEMBRANES AT THE BOTTOM OF ANY PARAPETS, UPSTANDS AND/OR EQUIPMENT FLASHINGS). PROVIDE SPACE AS REQ'D BETWEEN PREFINISHED FLASHINGS AND THE FACE OF ANY EQUIPMENT CURBS TO ENSURE A WATERTIGHT SEAL.
- ROOF PLAN DRAWING AT 3 SHOWS THE APPROXIMATE NUMBER AND LOCATION OF ROOFING CONDITIONS DETAILED THAT WILL BE REQUIRED IN THE AREA OF ROOFING. DETERMINE THE EXACT NUMBER AND LOCATION OF EACH DETAIL REQUIRED ON SITE AND COORDINATE WITH I.C., ROOFER, MECH. AND ELEC'T.
- NO SPRAYFOAM INSULATION IS TO BE APPLIED AT EXPOSED ROOF PENETRATIONS AT MULTIPURPOSE ROOF DECK. NEATLY INSTALL SEALANT AND INSULATION AROUND PENETRATION READY TO RECEIVE PAINT FINISH.

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CLIENT REF. #  
PROJECT

ACCESS STORAGE WILLOWLEA

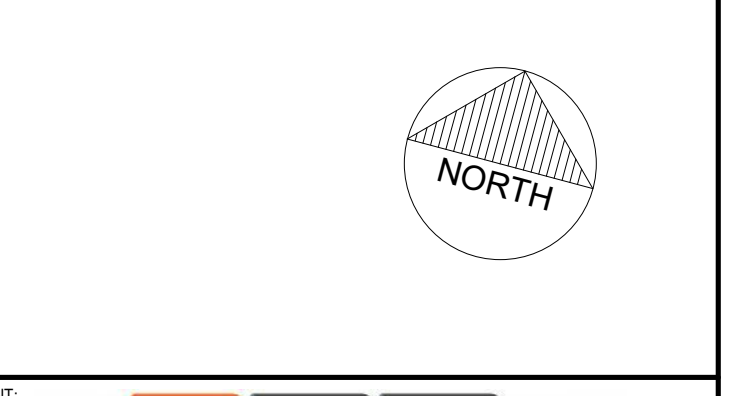REV. MARK

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REVISED FOR: REVISION

22/11/2021 ISSUED FOR 33% REVIEW

PROJECT NO: 219-00056-00 DATE: NOV 11, 2021

DESIGNED BY: J.C. DRAWN BY: AS

CHECKED BY: J.C. DISCIPLINE: ARCHITECTURAL


TITLE: BUILDING B & C - ROOF PLANS

SHEET NUMBER: A1.5 OF


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ROOF SYMBOL LEGEND

- ROOFING ASSEMBLY:**
- STANDING SEAM METAL ROOF (BUTLER MR-24)
  - THERMALBARRIER INSULATION SYSTEM (R40 INSULATION)
  - STEEL PURLINS AT 1.5m O.C.
  - PREFINISHED INTERIOR METAL LINER
  - VAPOUR RETARDER (SELF ADHERED)
  - 16mm DENSDECK SHEATHING (ADHERED)
  - METAL DECK (REFER TO STRUCTURAL)
- DIRECTION OF ROOF SLOPE AT MIN 1.5% UNLESS NOTED OTHERWISE**
- +250.00** APPROX. HEIGHT OF TOP OF TAPERED SLOPED INSULATION ABOVE STEEL DECK
- PV** PLUMBING VENT STACK AS PER AS 35. COORDINATE WITH MECH
- MU** MECHANICAL UNIT, COORDINATE WITH MECHANICAL. PROVIDE 1" CURB AROUND PERIMETER AS PER AS 35.
- RB** TYPICAL CONDUIT/PIPING THRU ROOF BOX. REFER TO AS 35.

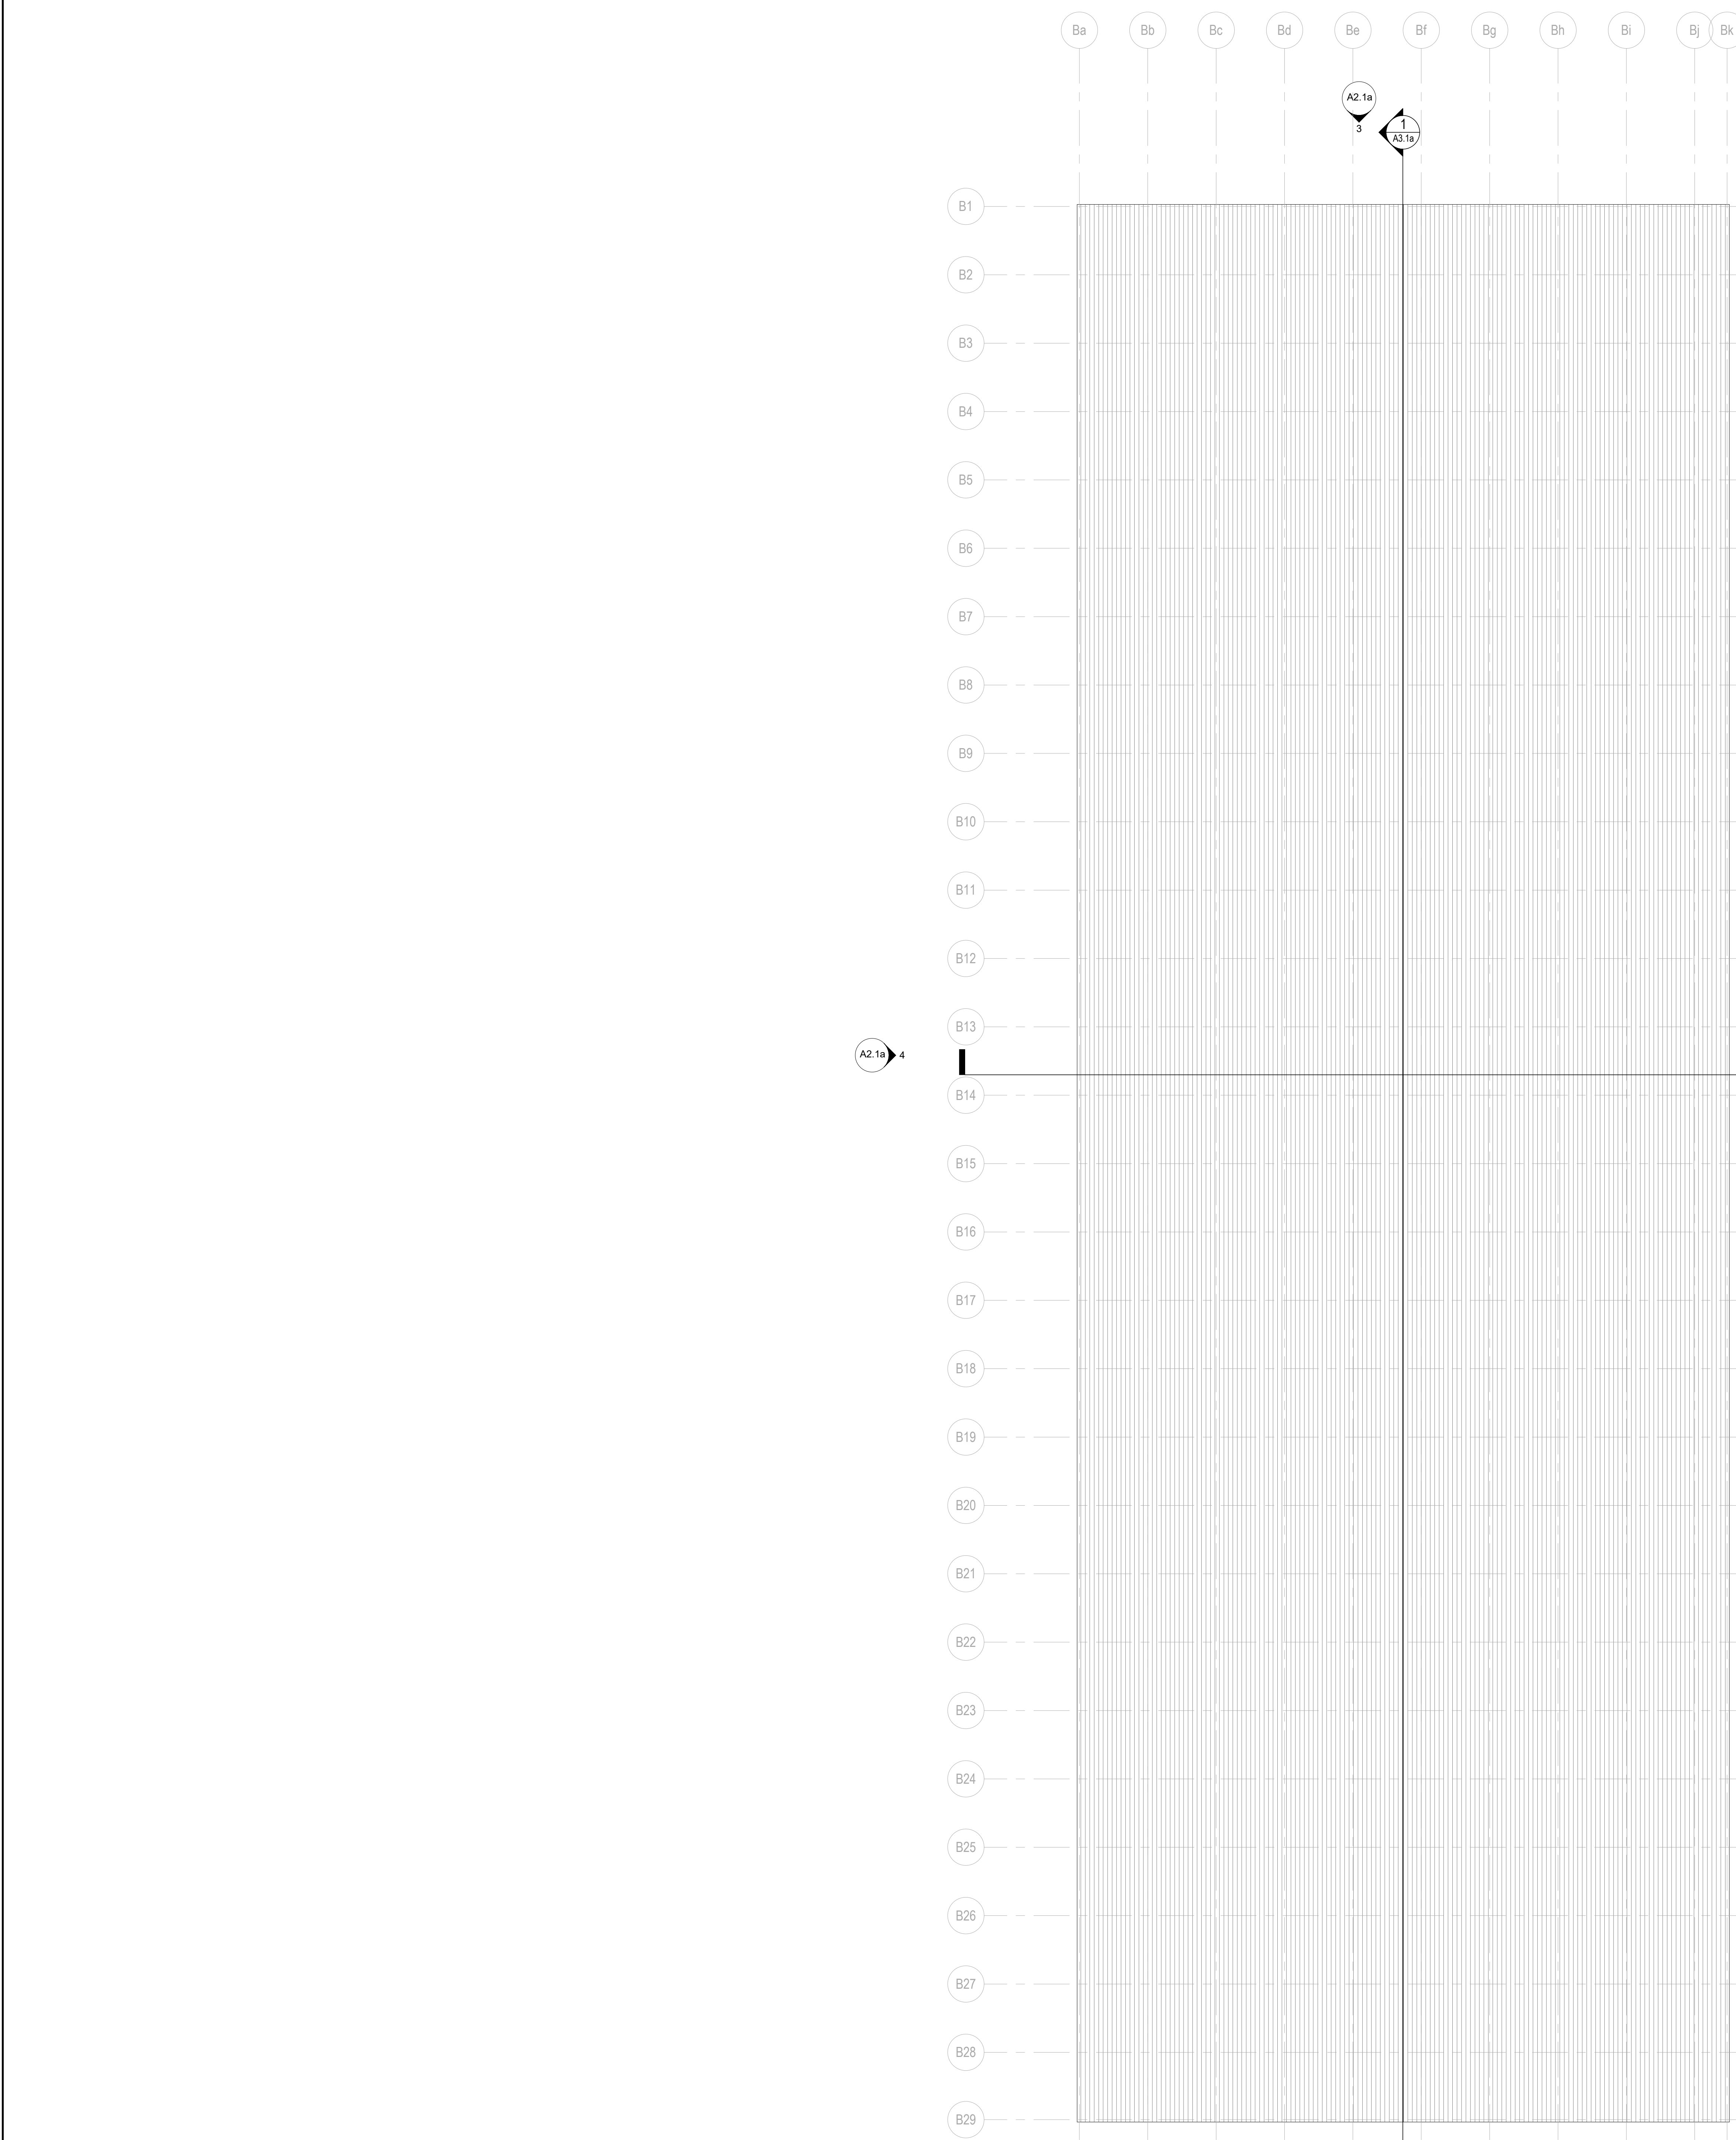

1 T/O ROOF PEAK  
A1.5 1:125

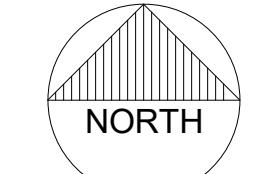

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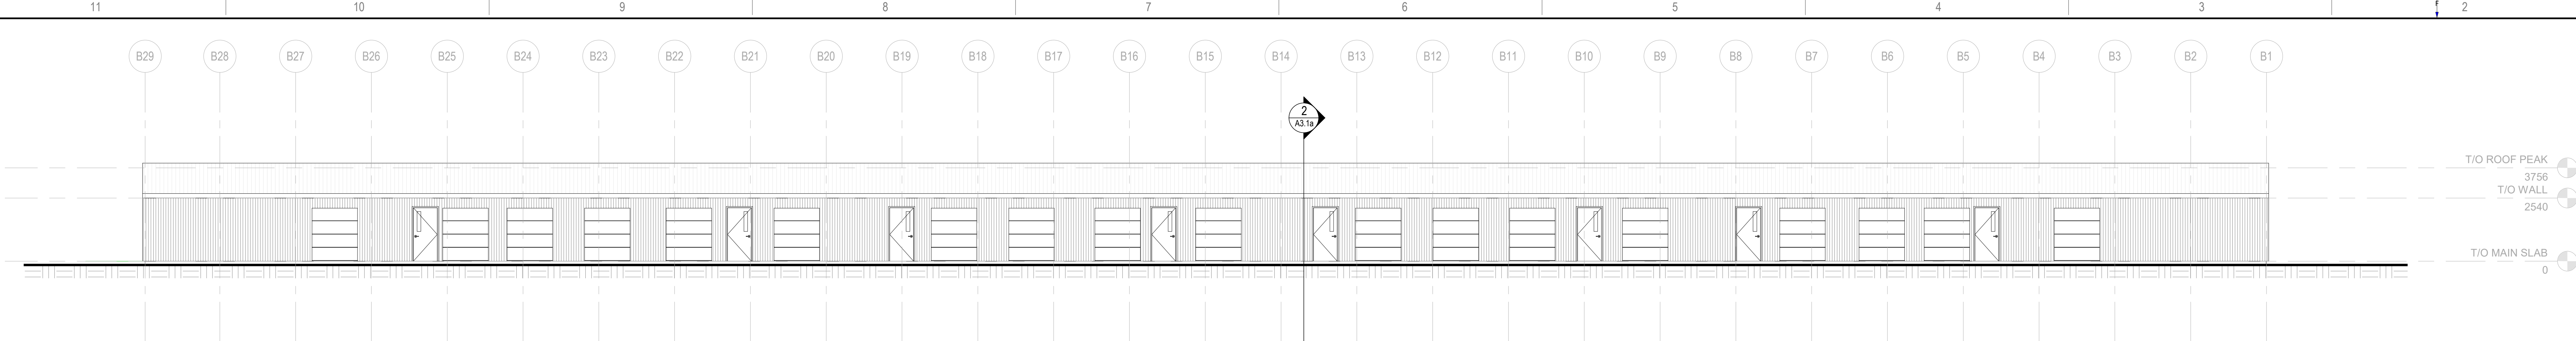


PROJECT: ACCESS STORAGE WILLOWLEA


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REVISIONS FOR REVIEW

DATE	2011/02/01	ISSUED FOR 33% REVIEW	
PROJECT NO.	219-00059-00	DATE	NOV 11, 2021
ORIGINAL SCALE	1:100	IF THIS BAR IS NOT SHOWN, PLEASE YOUR PLOTTING SCALE.	
DESIGNED BY:	JC	DRAWN BY:	AS
CHECKED BY:	JC	DATE:	2021/11/11
DISCIPLINE: ARCHITECTURAL			
TITLE: BUILDING B - EXTERIOR ELEVATIONS			
SHEET NUMBER: A2.1a			
ISSUED FOR 33% REVIEW			




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 A2.1a 1:100

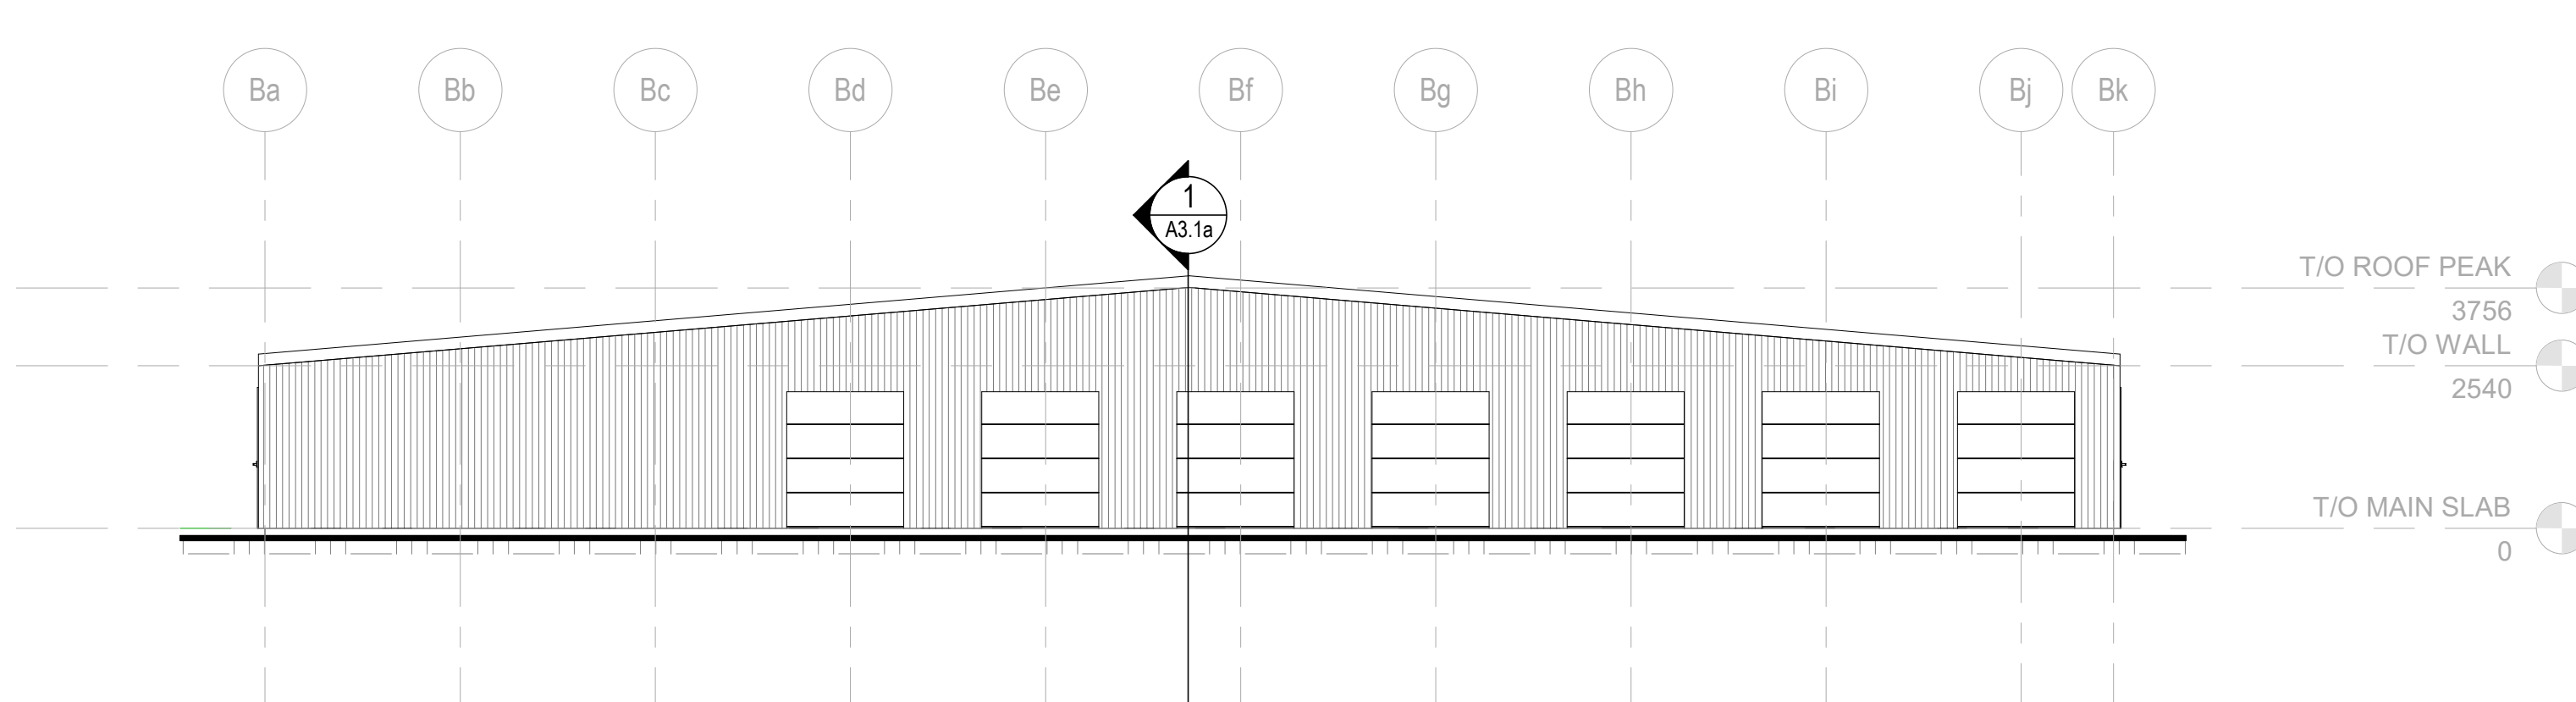

2 EXTERIOR ELEVATION - SOUTH - BUILDING B  
 A2.1a 1:100




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 A2.1a 1:100

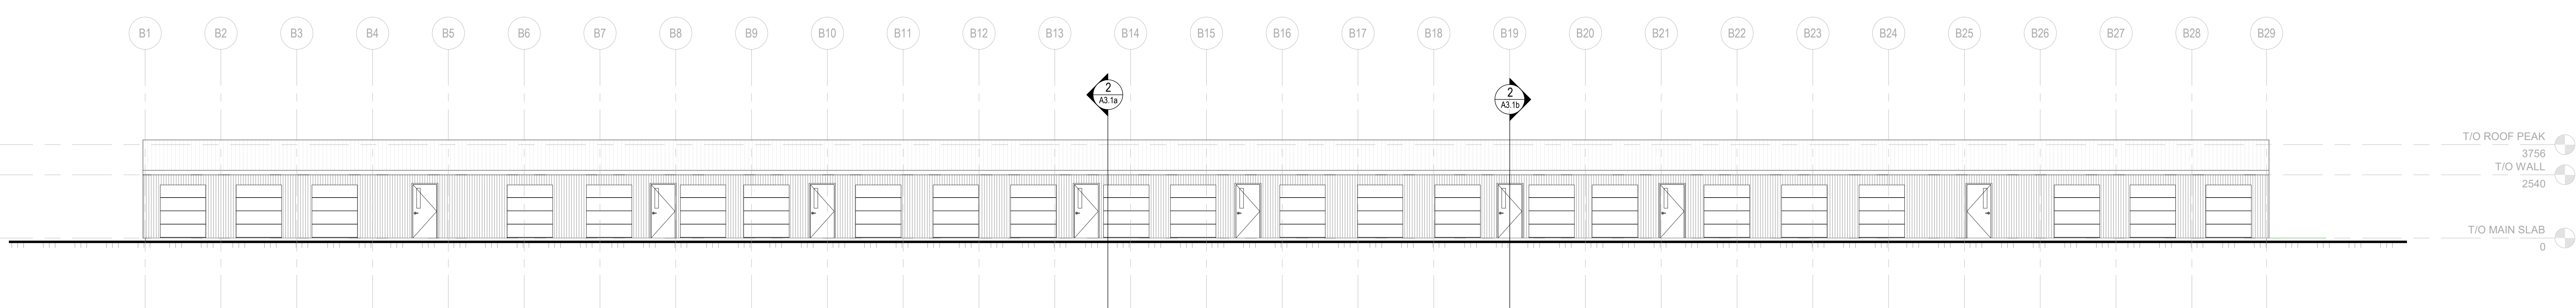


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 A2.1a 1:100




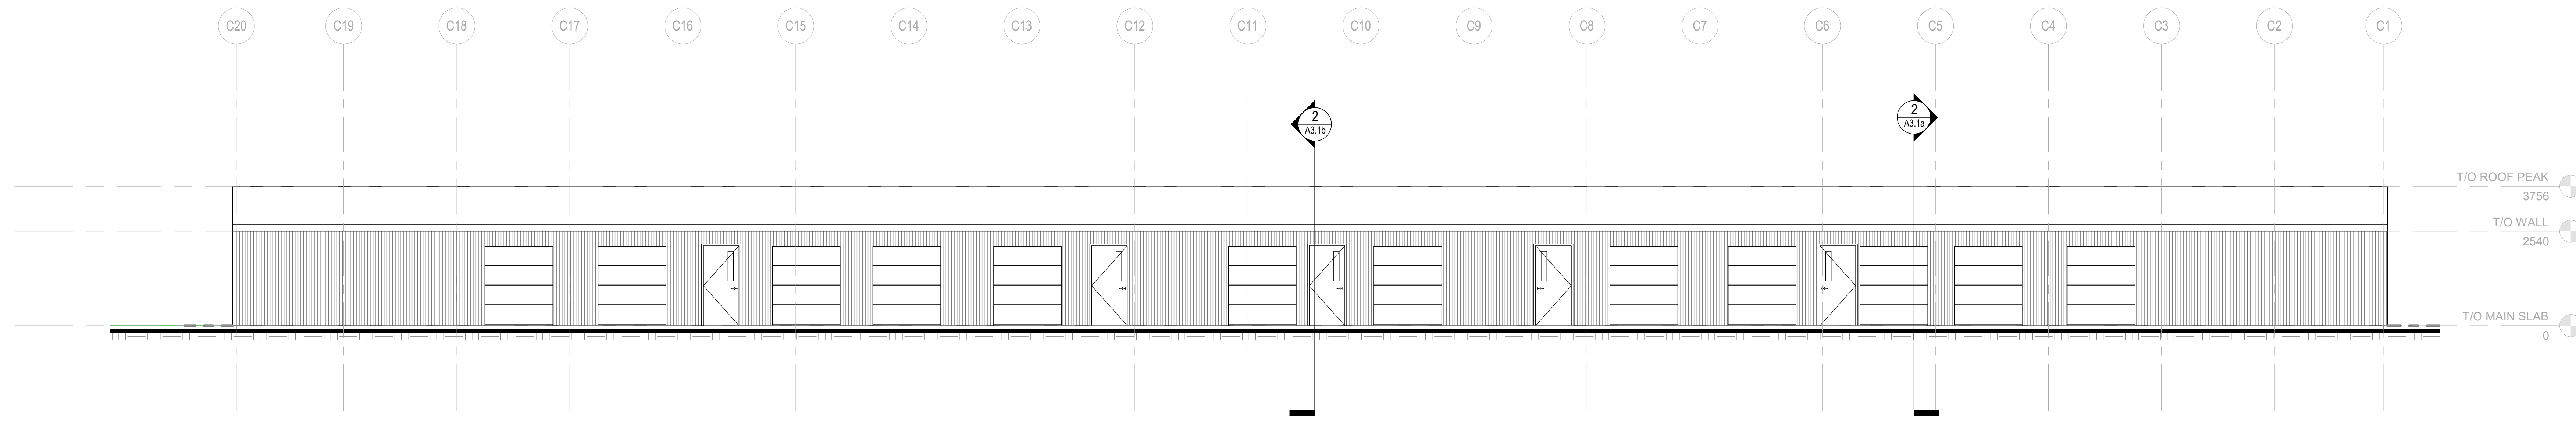


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 1:75

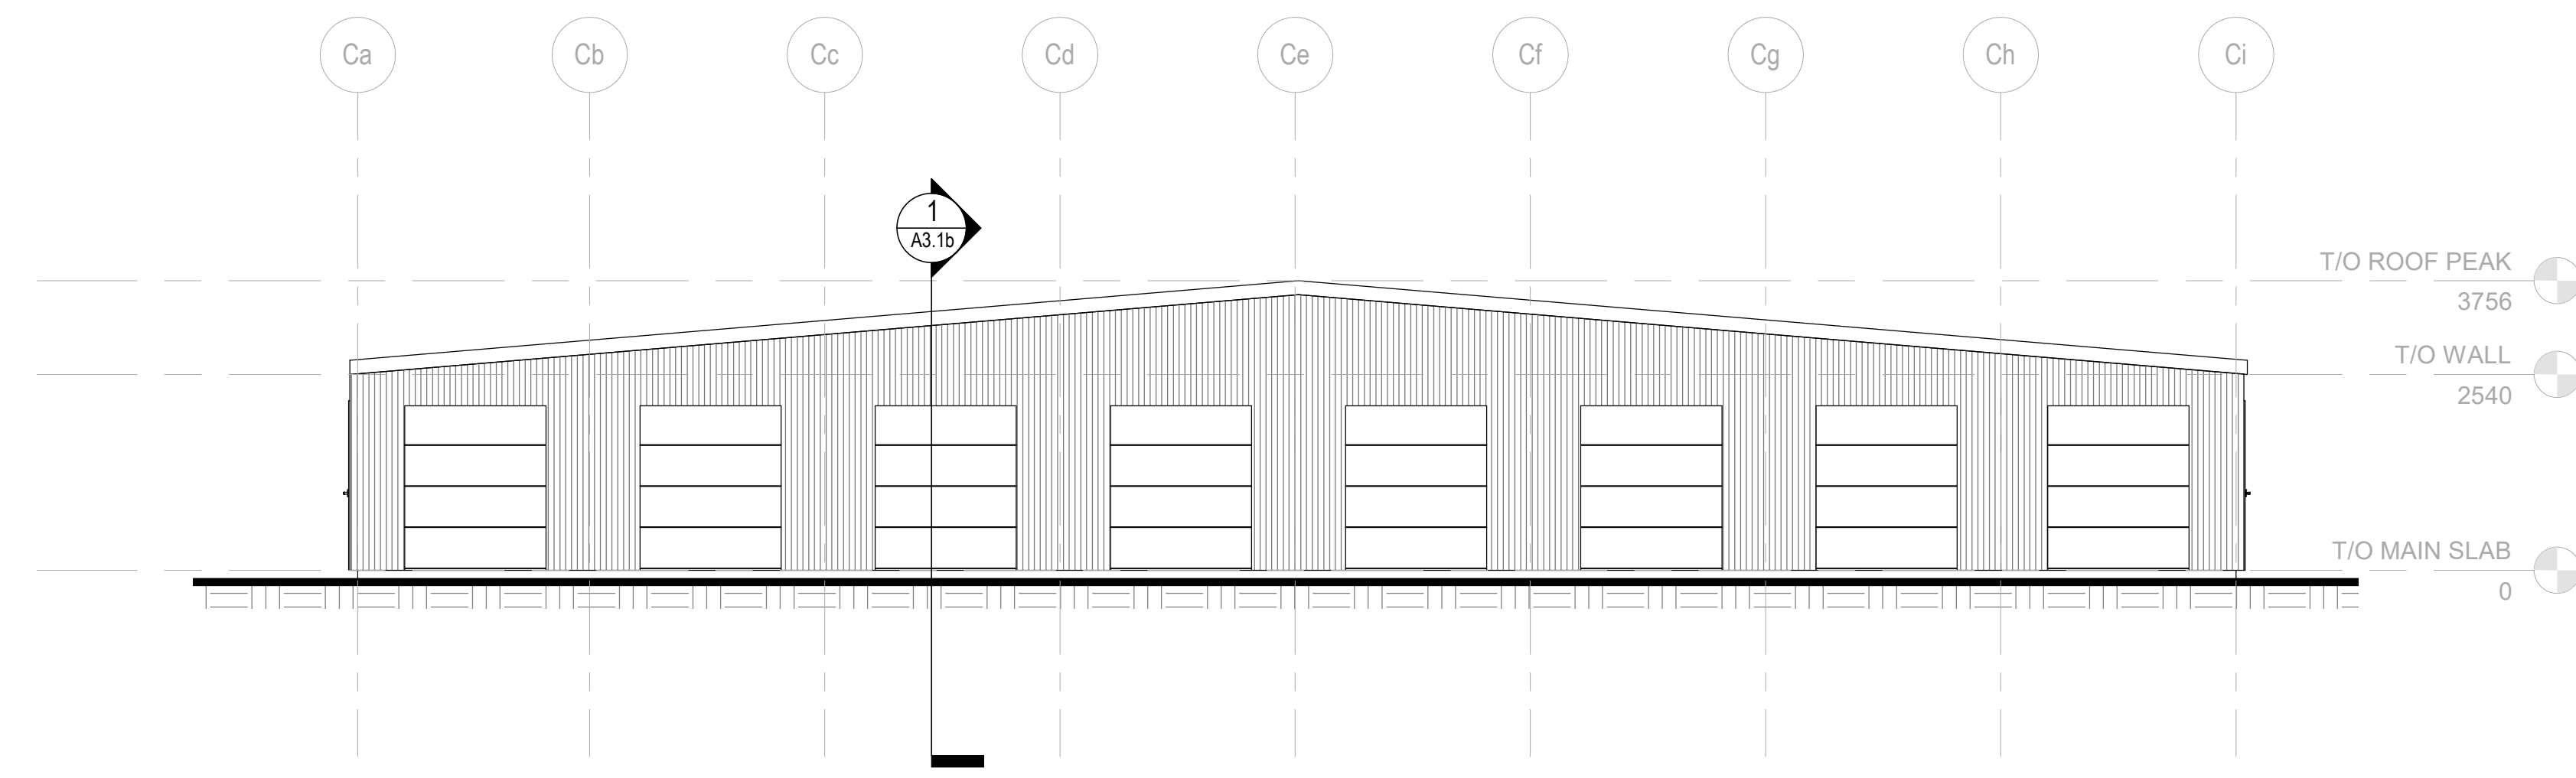

3 EXTERIOR ELEVATION - SOUTH - BUILDING C  
 1:75

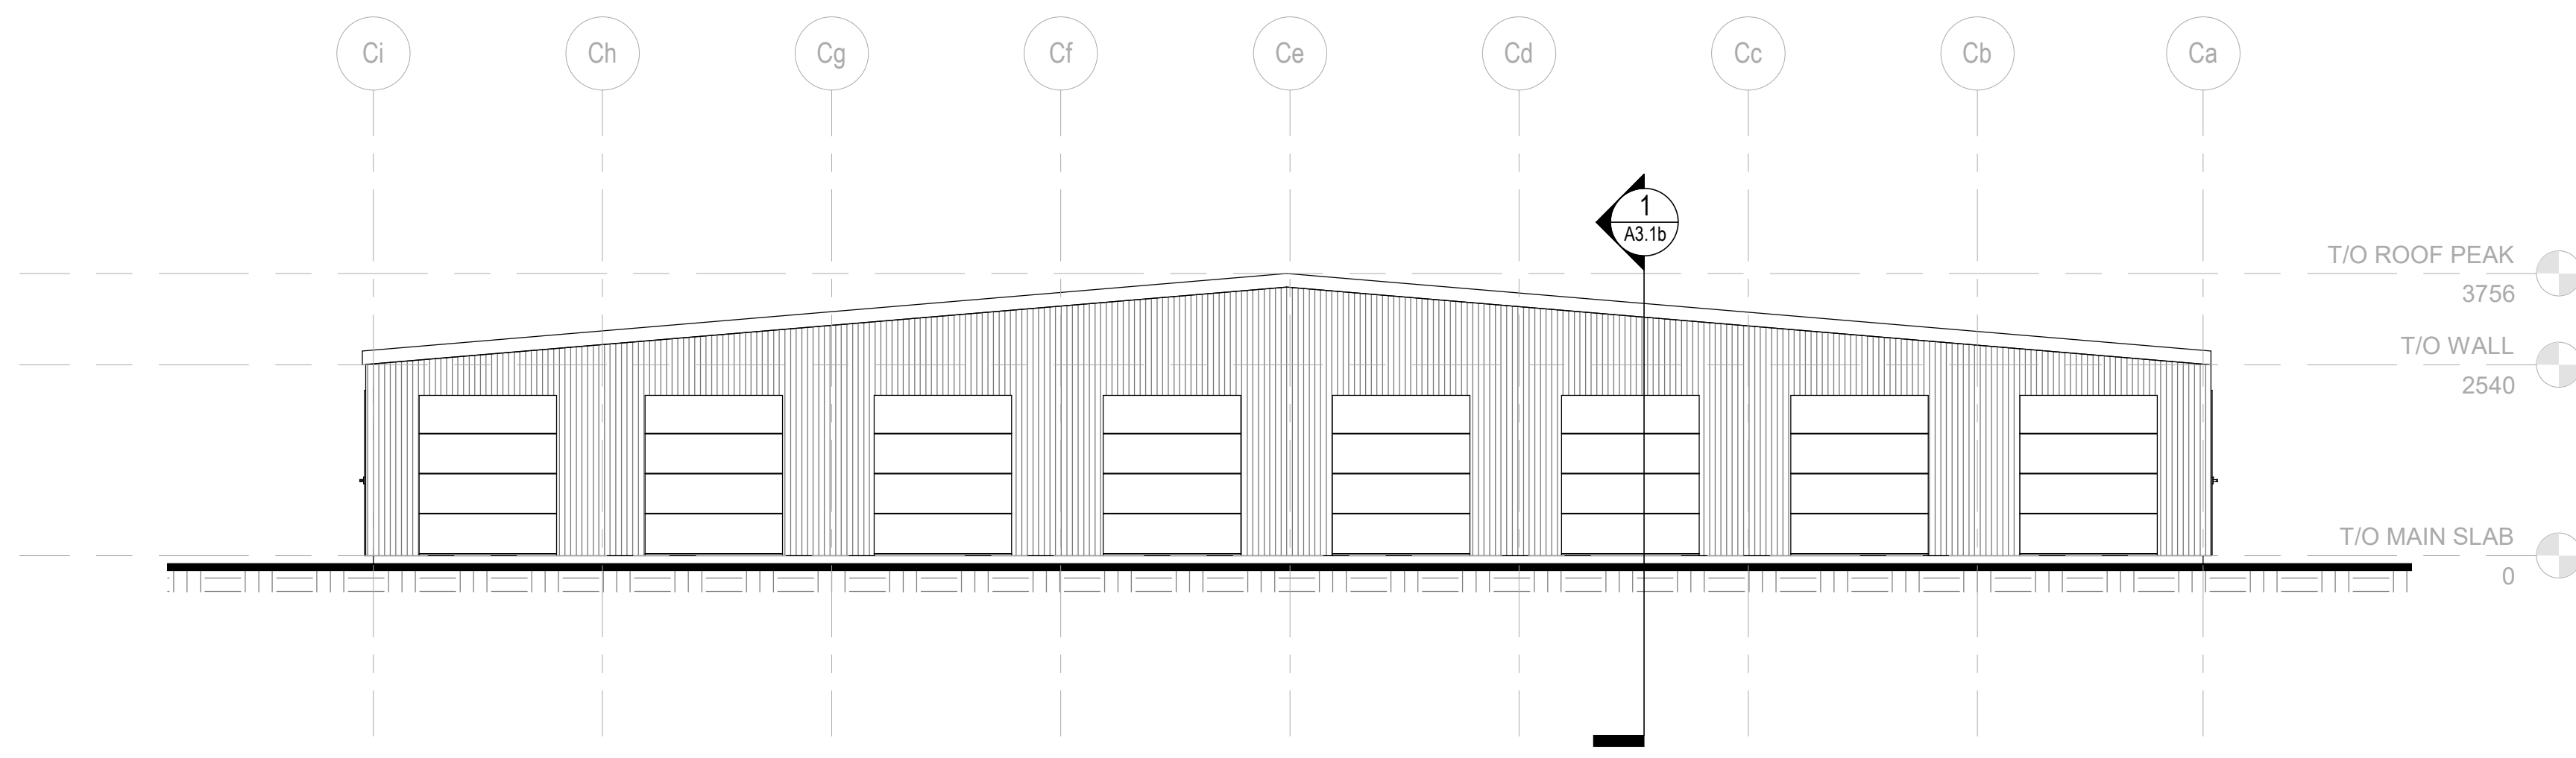

2 EXTERIOR ELEVATION - NORTH - BUILDING C  
 1:75

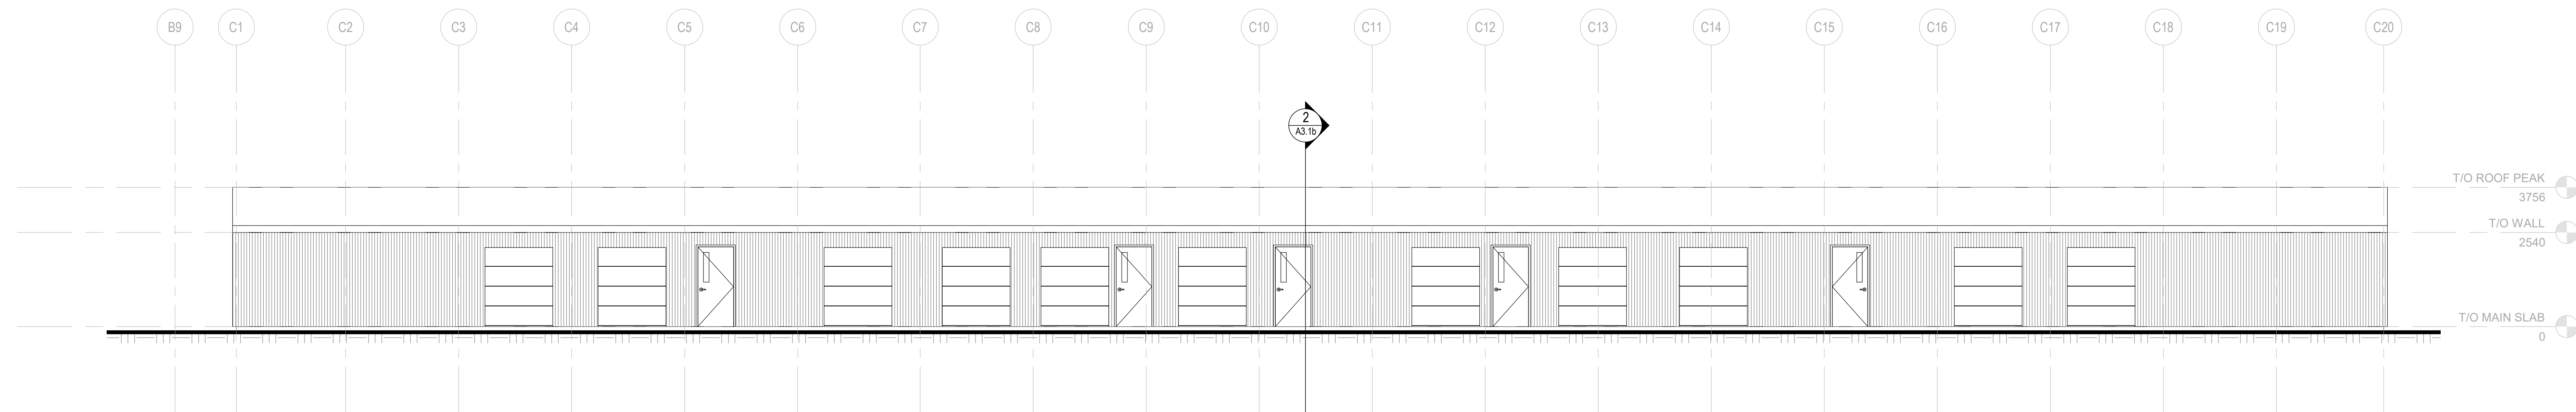

4 EXTERIOR ELEVATION - WEST - BUILDING C  
 1:75

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PROJECT

ACCESS STORAGE WILLOWLEA

REV MARK

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ISSUE	DATE	DESCRIPTION
1	2011/11/20	ISSUED FOR 33% REVIEW
2		
3		
4		
5		
6		
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PROJECT NO.	219-0005-00	DATE	NOV 11, 2021
ORIGINAL SCALE	1:75	IF THIS BAR IS NOT SHOWN, PLEASE YOUR PLOTTING SCALE.	
DESIGNED BY:	JC		
DRAWN BY:	AS		
CHECKED BY:	JC		
DISCIPLINE	ARCHITECTURAL		
TITLE	BUILDING C - EXTERIOR ELEVATIONS		
SHEET NUMBER	A2.1b		
ISSUE	ISSUED FOR 33% REVIEW		
DATE OF		REV #	

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PROJECT

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IS	2011/2020	ISSUED FOR 33% REVIEW
RE	DATE	DESCRIPTION

PROJECT NO: 219-00059-00 DATE: NOV 11, 2021

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DESIGNED BY: JIC

DRAWN BY: AS

CHECKED BY: JIC


DISCIPLINE: ARCHITECTURAL

TITLE: BUILDING B - BUILDING SECTIONS


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DATE OF:



**BUILDING SECTION**  
 1:100

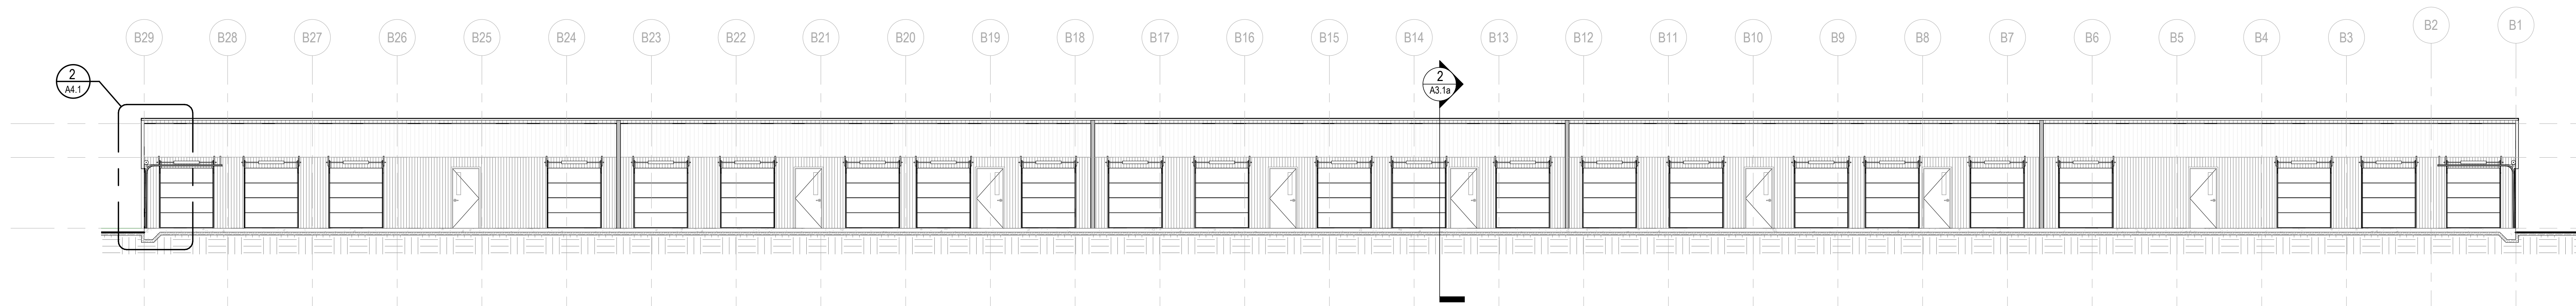

**BUILDING SECTION**  
 2:100
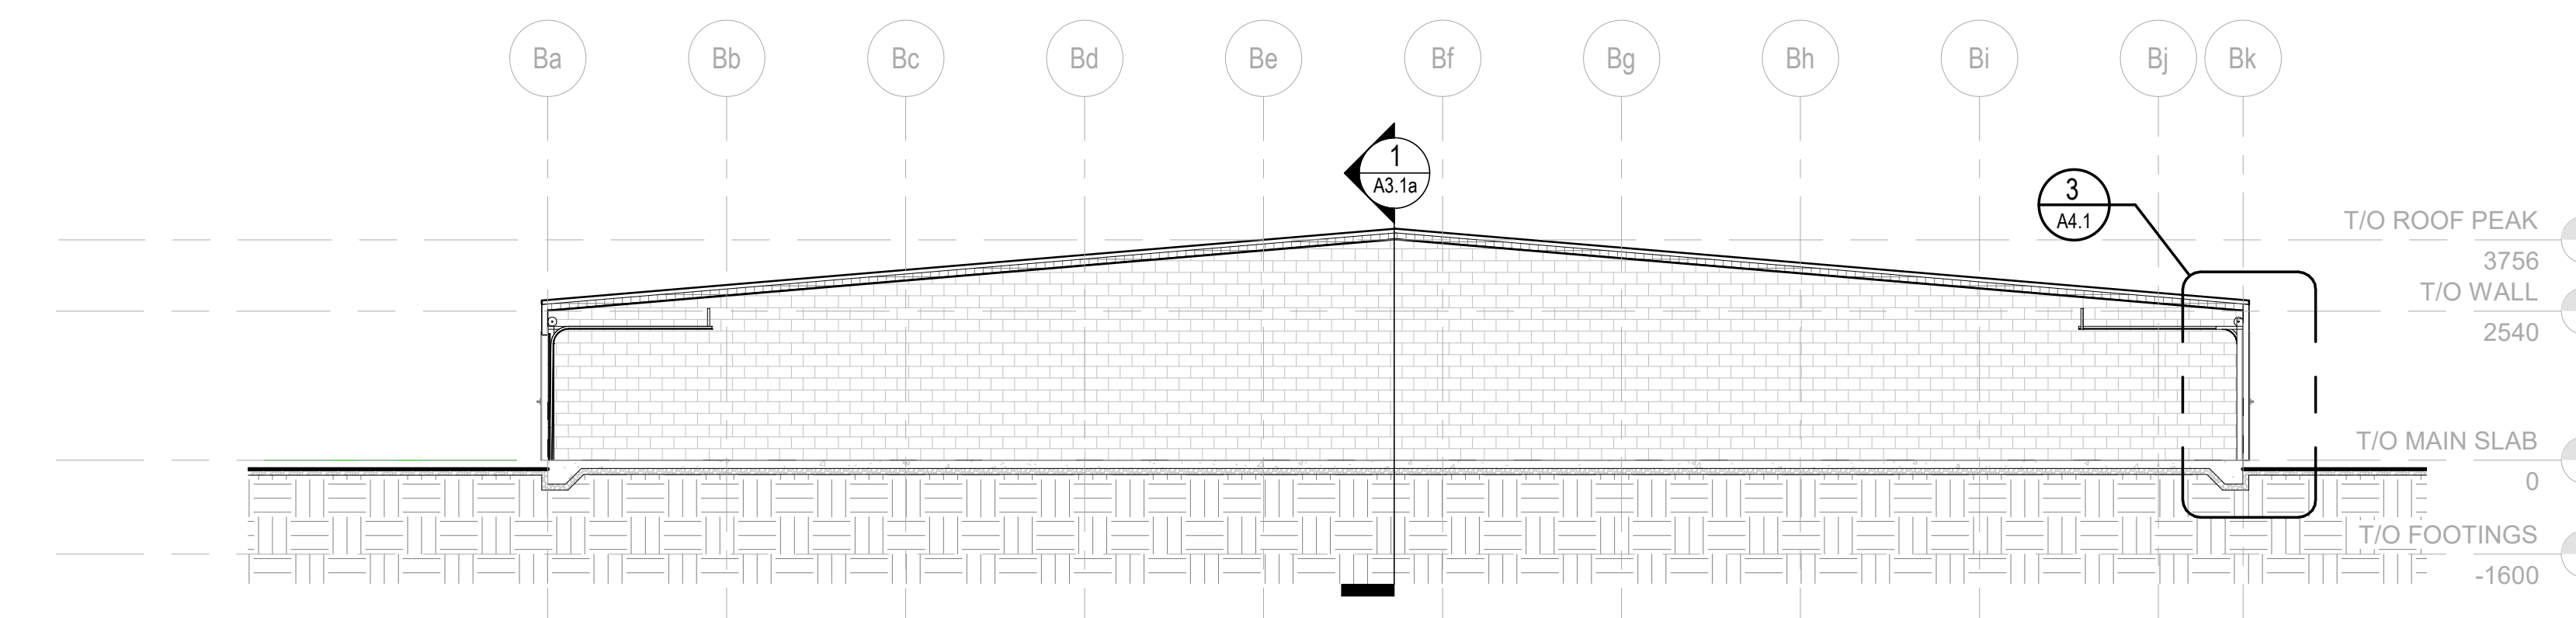
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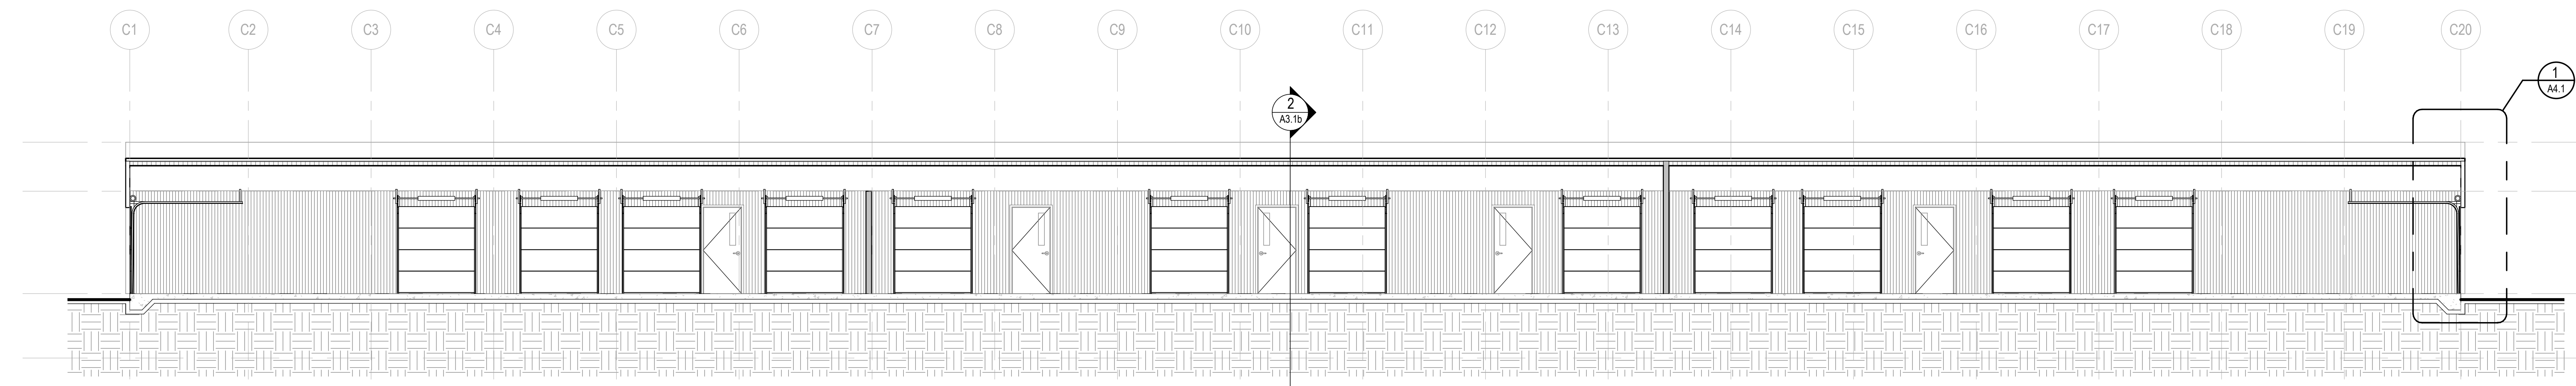
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DESIGNED BY:	JIC		
DRAWN BY:	AS		
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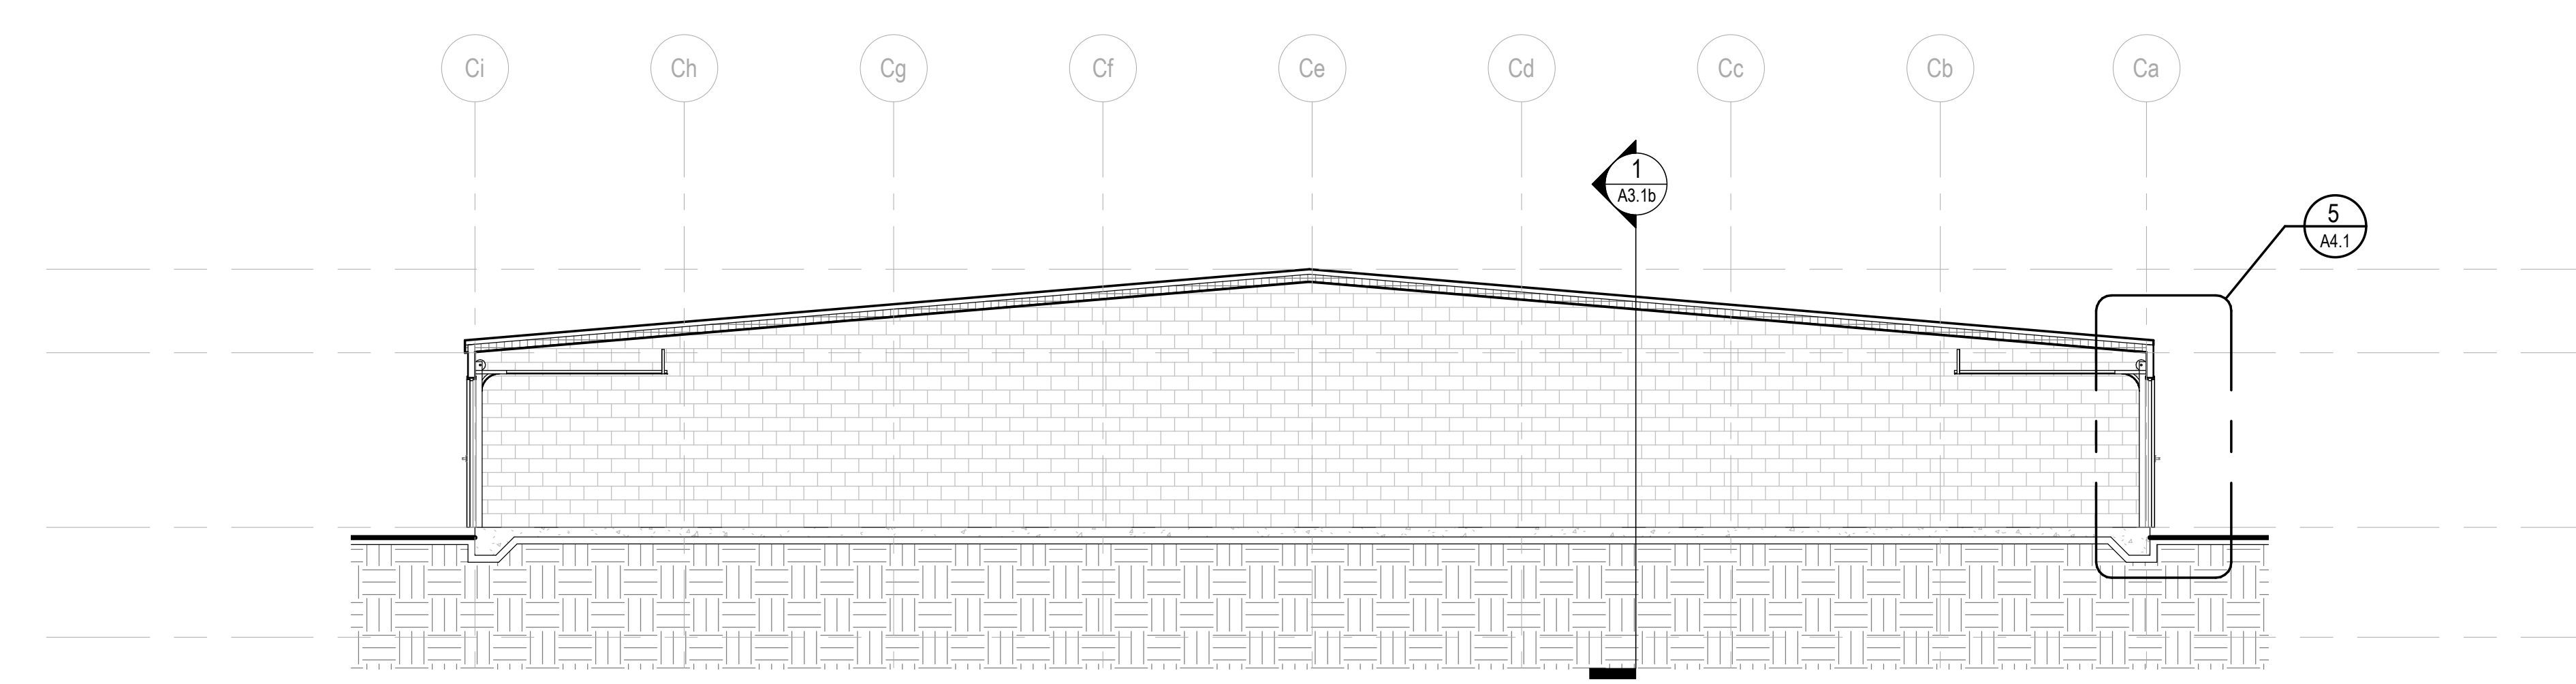
TITLE: **BUILDING C - BUILDING SECTIONS**

SHEET NUMBER: **A3.1b**

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**1 BUILDING SECTION**  
 1:75



**2 BUILDING SECTION**  
 1:75



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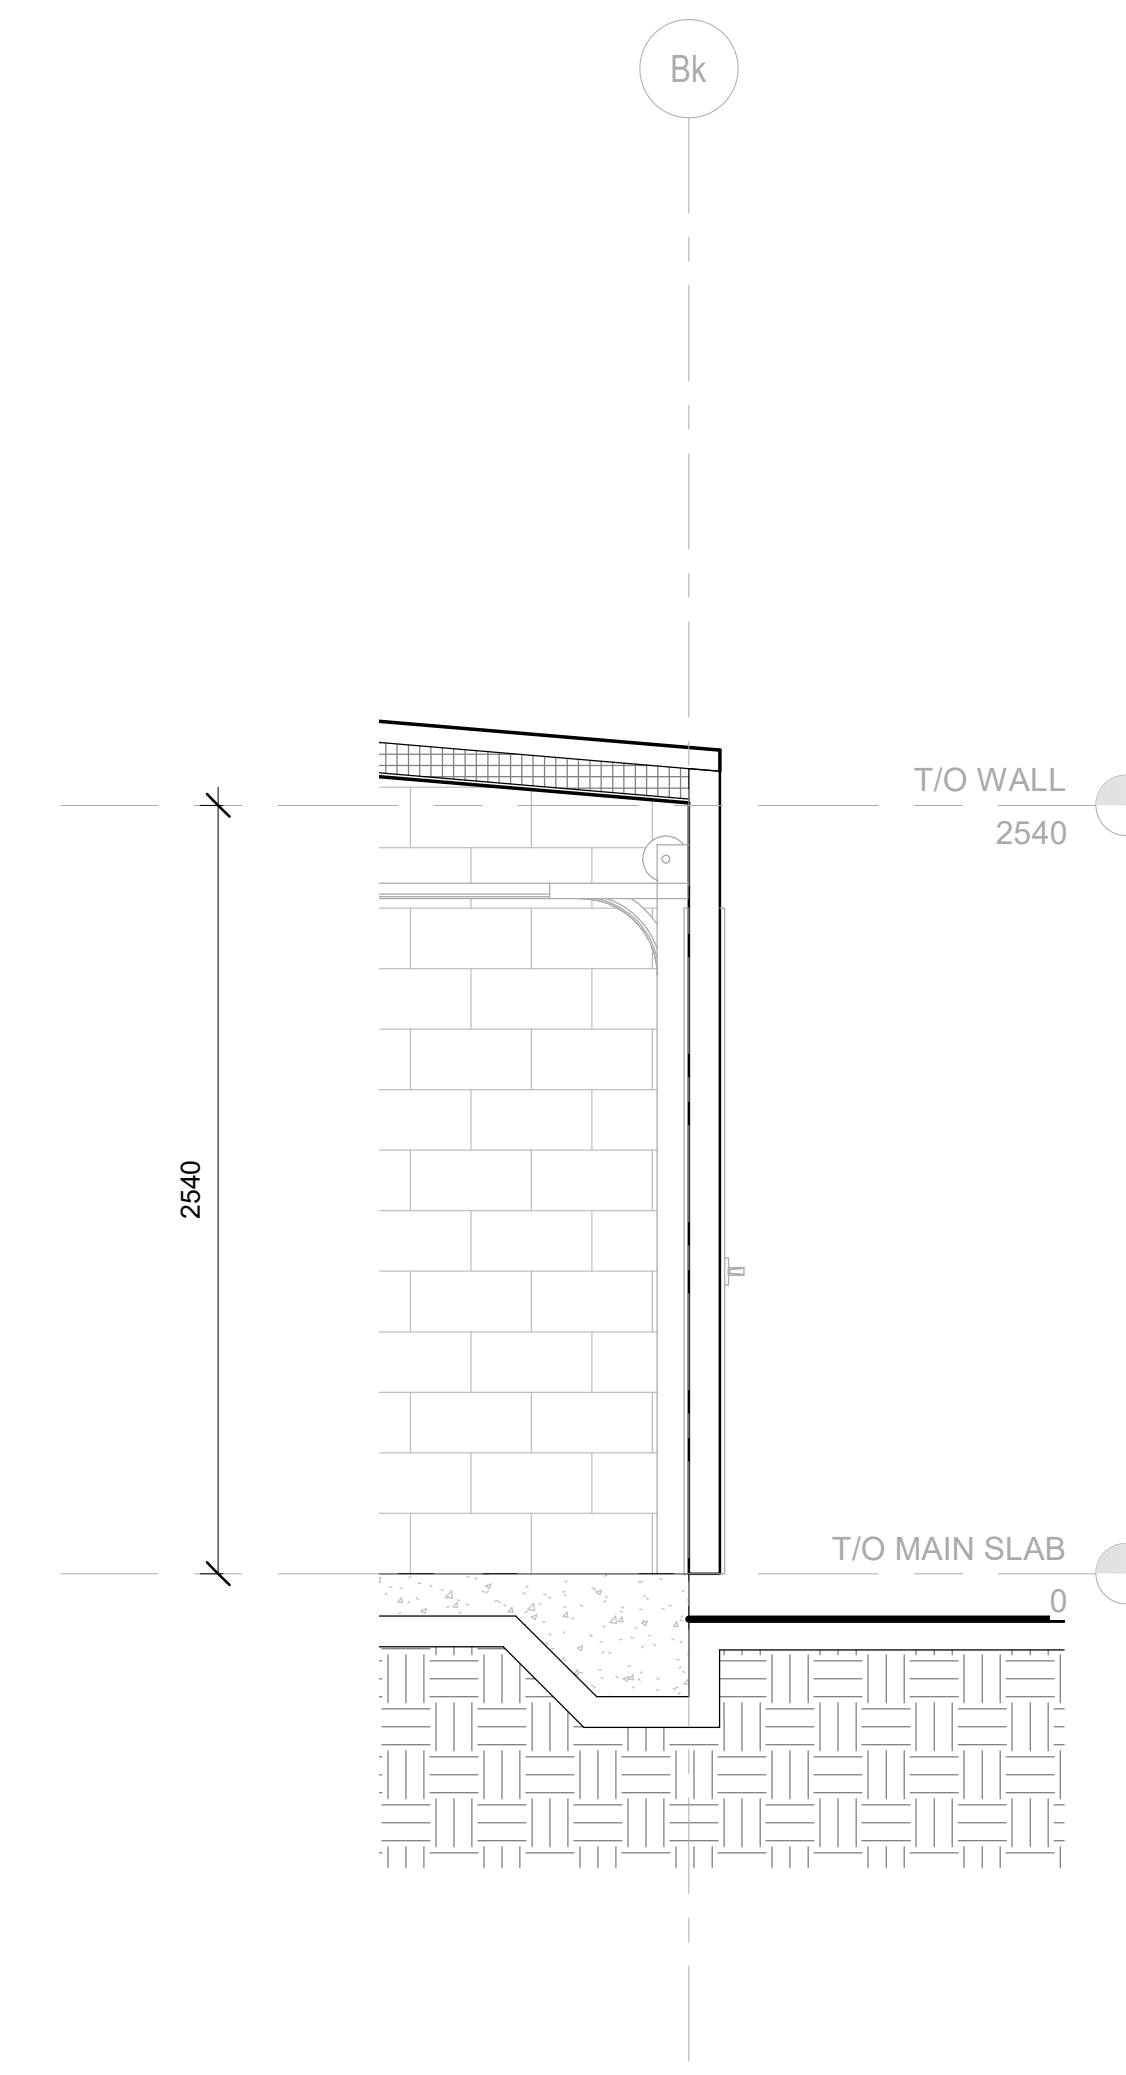
PROJECT

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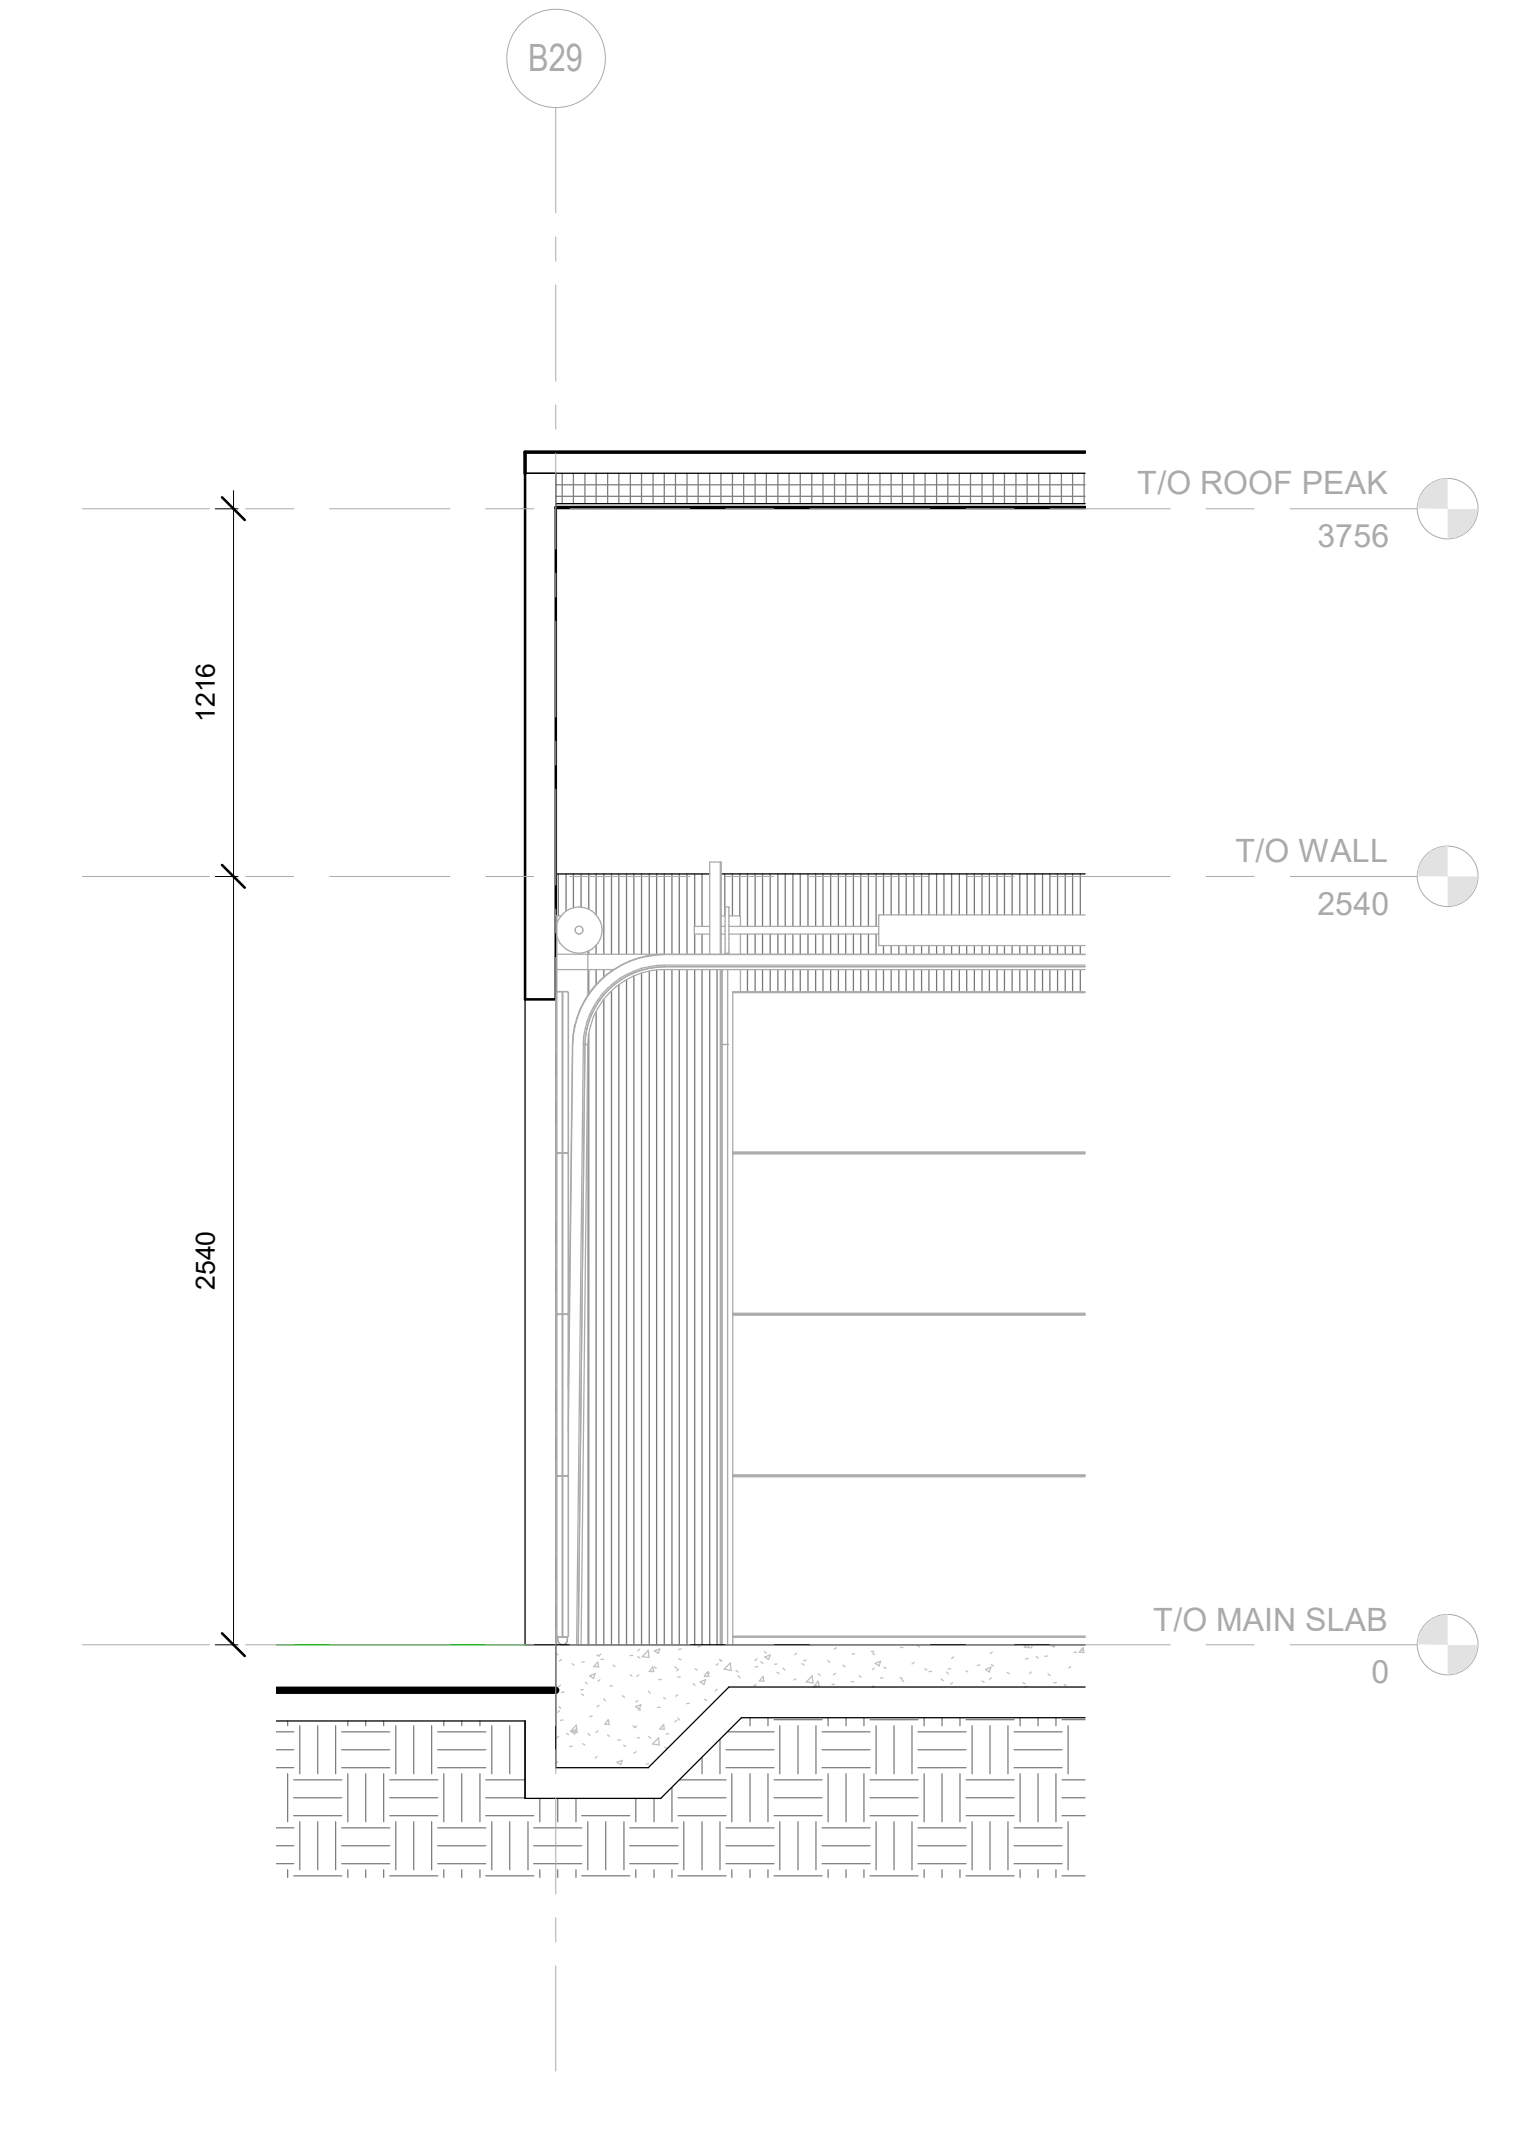
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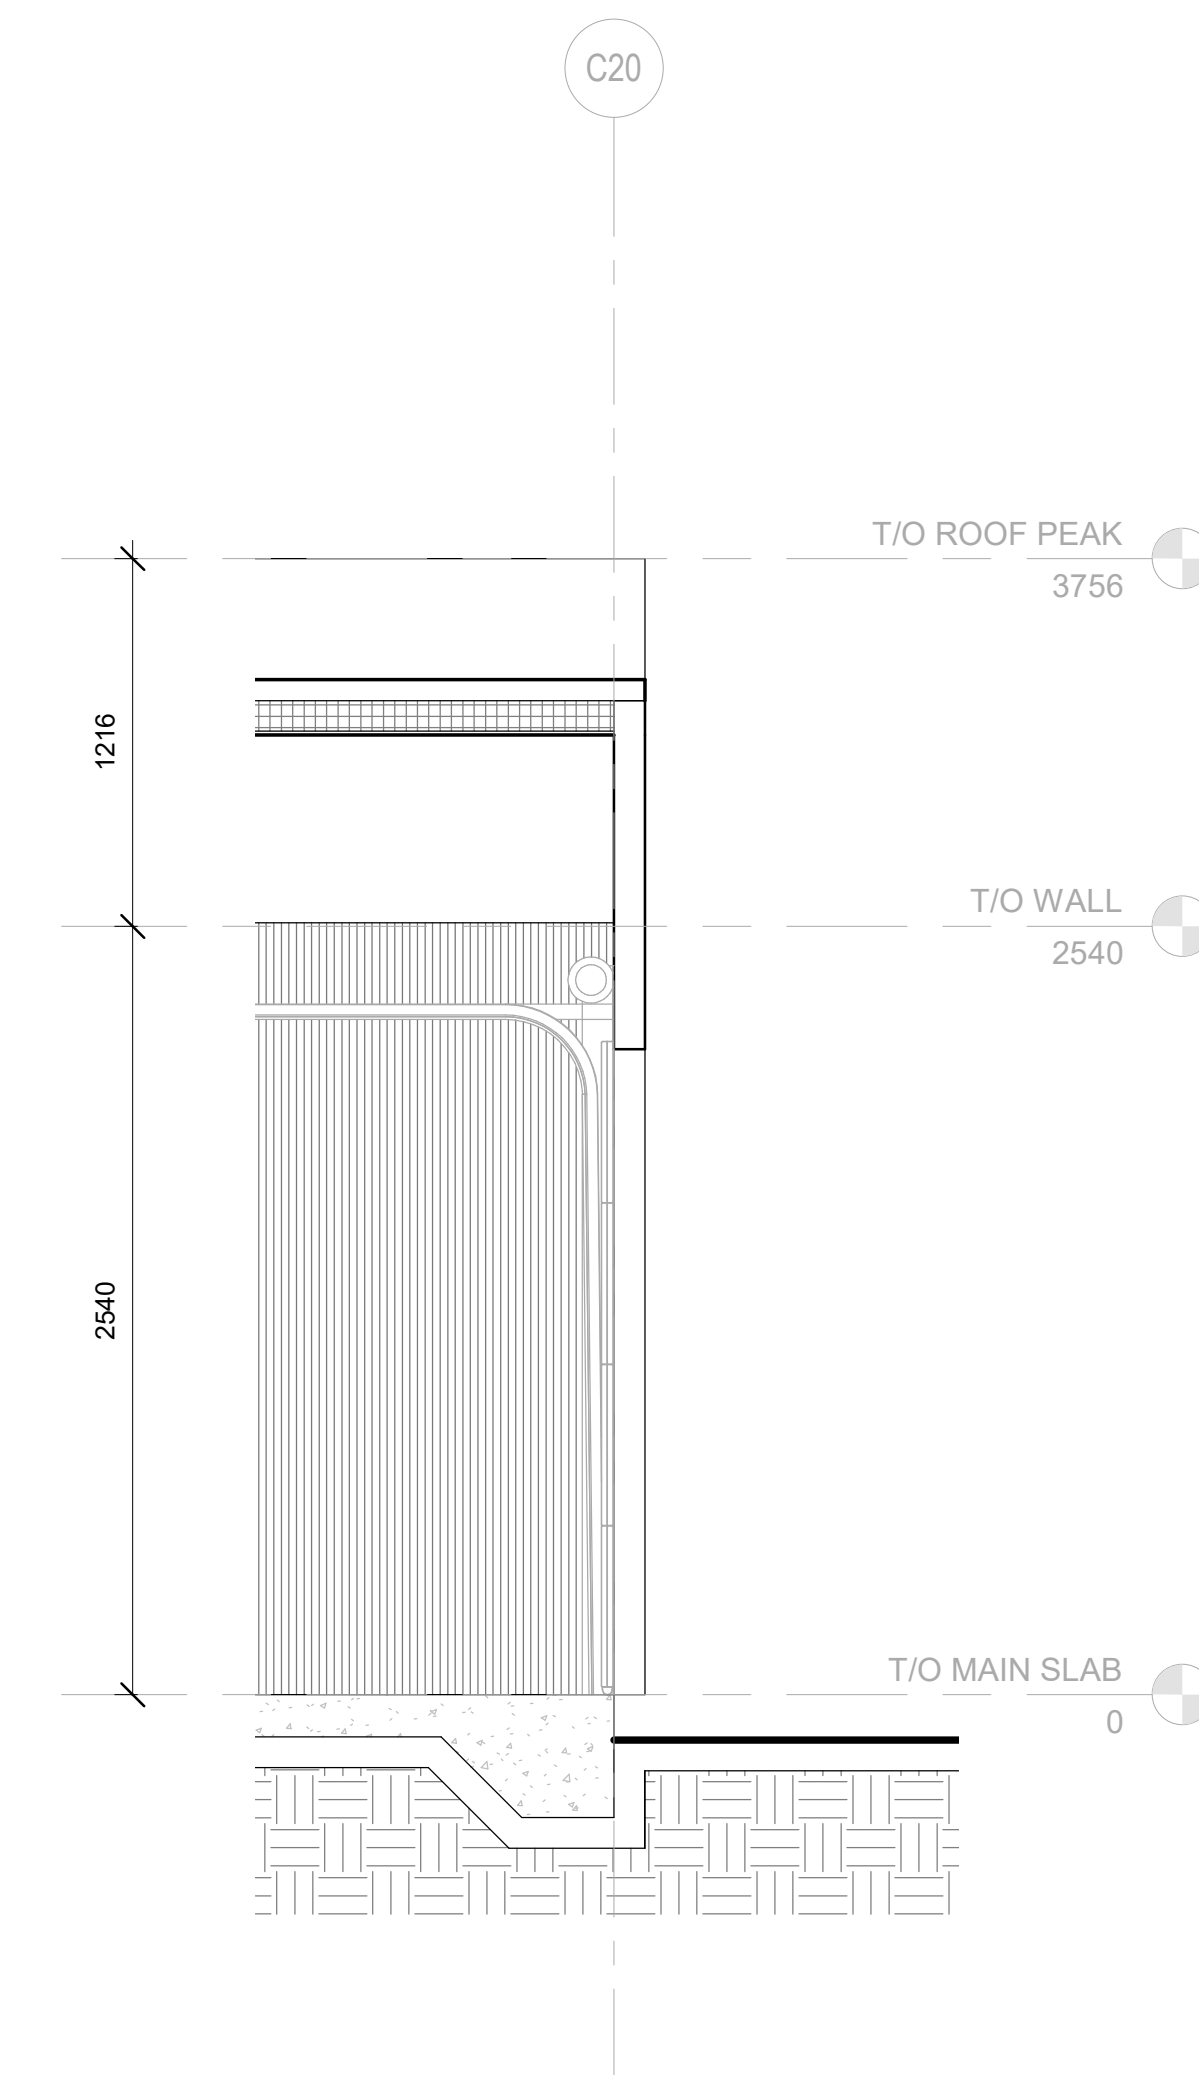
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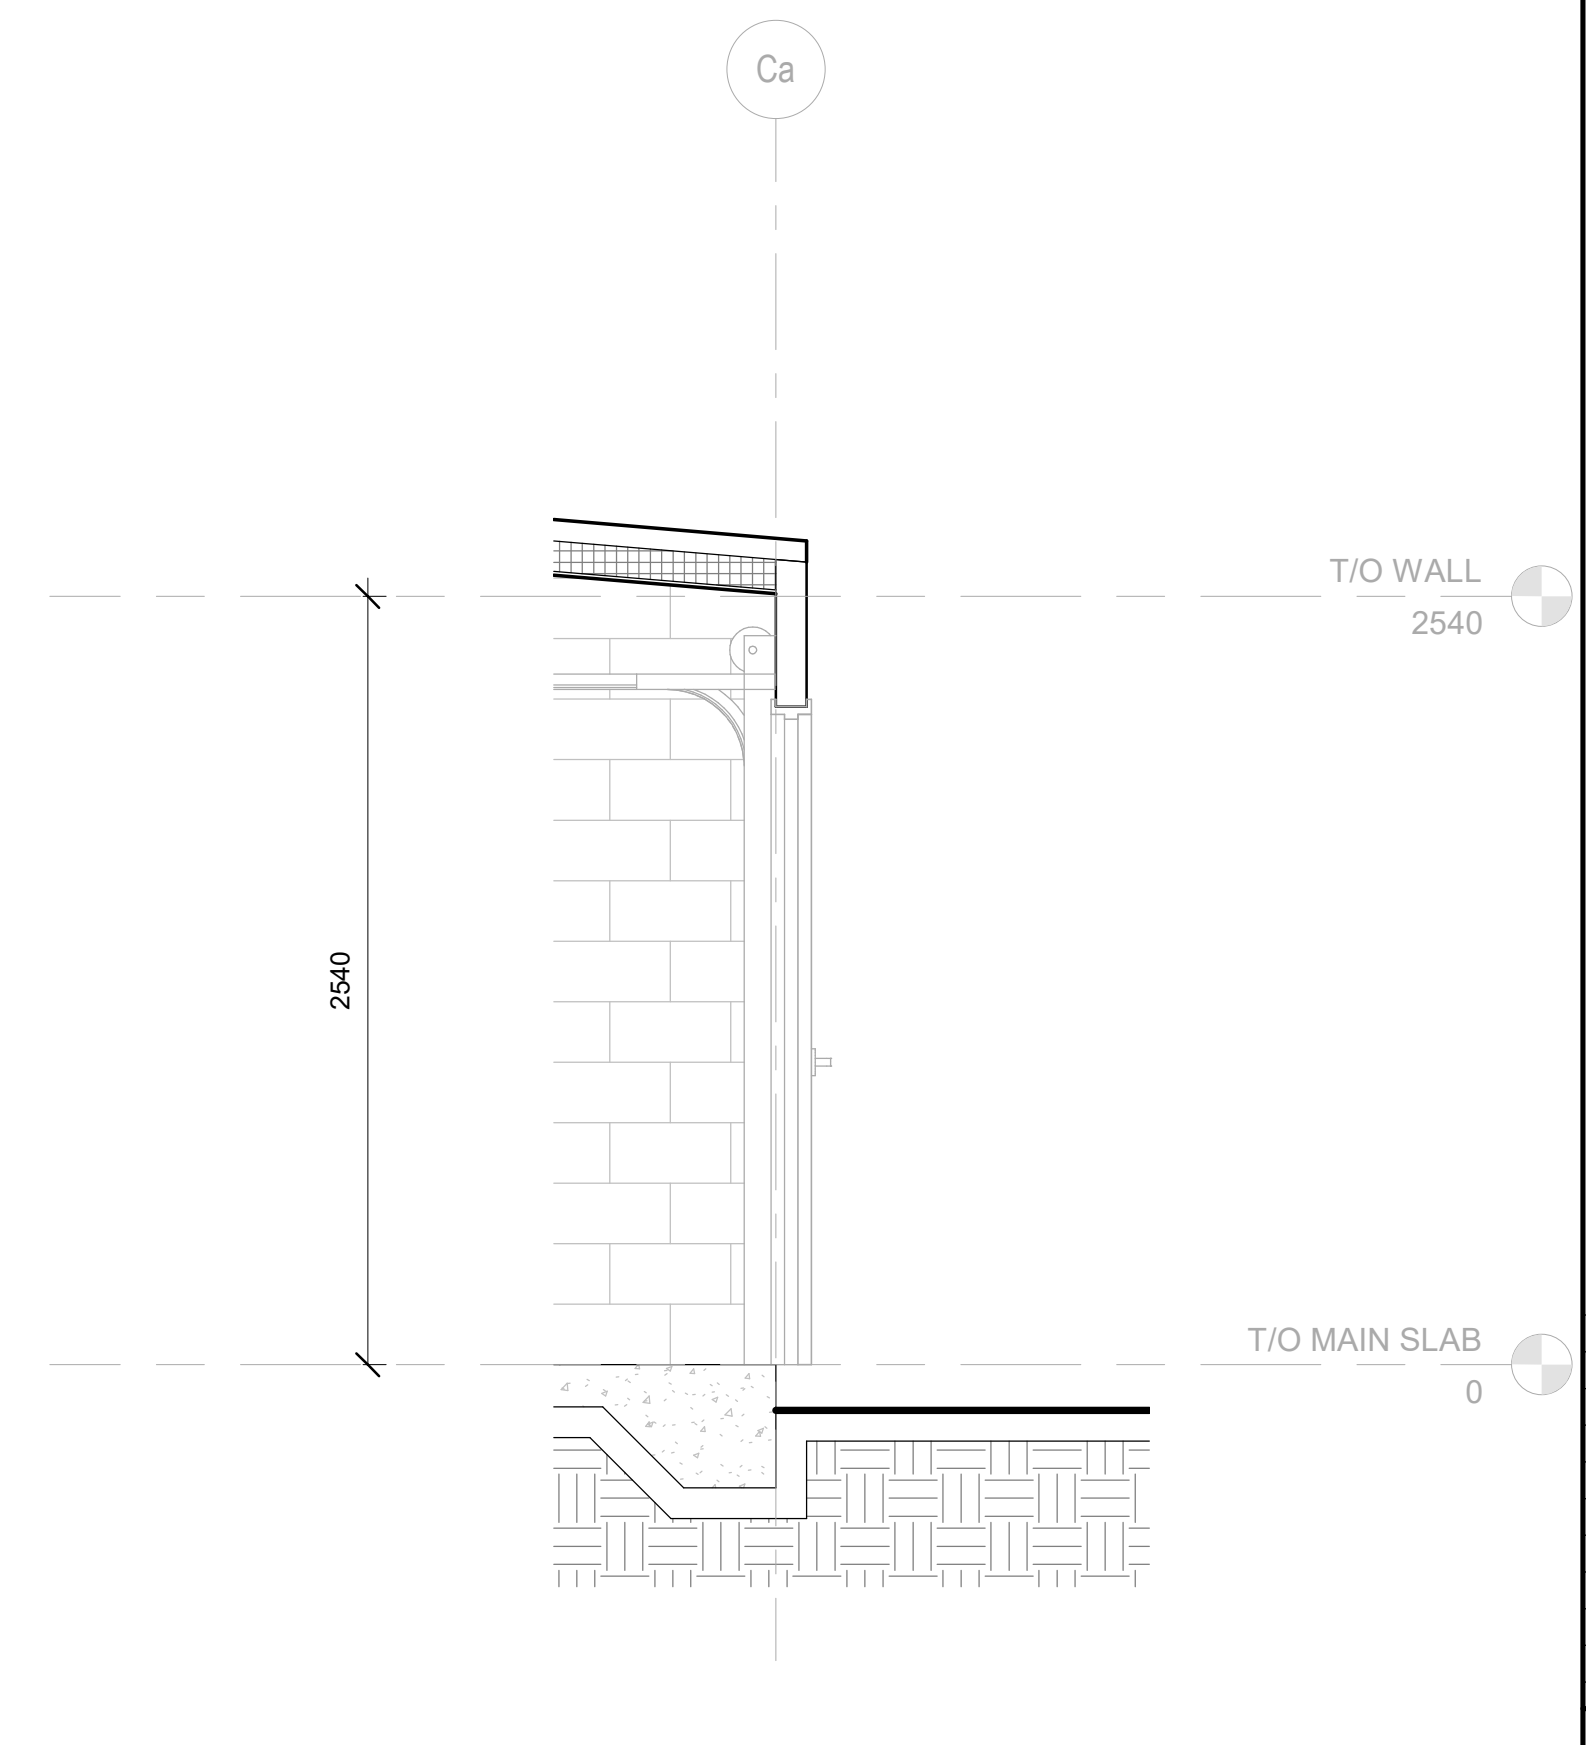
3 WALL SECTION  
 A4.1 1:25



2 WALL SECTION  
 A4.1 1:25



1 WALL SECTION  
 A4.1 1:25



5 WALL SECTION  
 A4.1 1:25

IS	2011/2020	ISSUED FOR 33% REVIEW	DATE	DESCRIPTION
PROJECT NO.	219-00059-00	DATE	NOV 11, 2021	
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DRAWN BY:	Author			
CHECKED BY:	Checker			
DISCIPLINE	ARCHITECTURAL			
TITLE	BUILDING B & C - WALL SECTIONS			
SHEET NUMBER	A4.1			
ISSUED FOR 33% REVIEW	DATE OF			