

ZONING PROVISION	REQUIRED	PROVIDED	PARKING QUEING + LOADING	REQUIRED	PROVIDED	LEGAL DESCRIPTION	SITE AREA	37582m <sup>2</sup>
MIN. LOT WIDTH	75 m	228.93 m	REGULAR SPACES	17	42	CITY OF OTTAWA PIN 04540-0186	BUILDING AREA	507.6 m <sup>2</sup>
MIN. LOT AREA	10000 m <sup>2</sup>	37582 m²	ACCESSIBLE SPACES	0	2	PIN 04540-0187	GROSS FLOOR AREA	400.22
MIN. FRONT YARD SETBACK	9 m	9 m	TOTAL PARKING SPACES	17	44		PER ZONING	400.2 m <sup>2</sup>
MIN. CORNER YARD SETBACK	9 m	N/A	BICYLCLE PARKING	1	12		BUILDING HEIGHT	6.67 m / 1 STOREY
MIN. REAR YARD SETBACK	10 m	10 m				REFERENCE SURVEY N/A	ZONE	RI3
MIN. INTERIOR YARD SETBACK	9 m	9 m						
						MUNICIPAL ADDRESS 3347 & 3349 OLD ALMONTE RD.		
MAX. HEIGHT	10 m	6.67 m				CARP, ON, CANADA		
LOT COVERAGE	30% MAX. 11275 m²	2.4% 917 m²						
LANDSCAPED AREA	20% MIN.	97.6%						

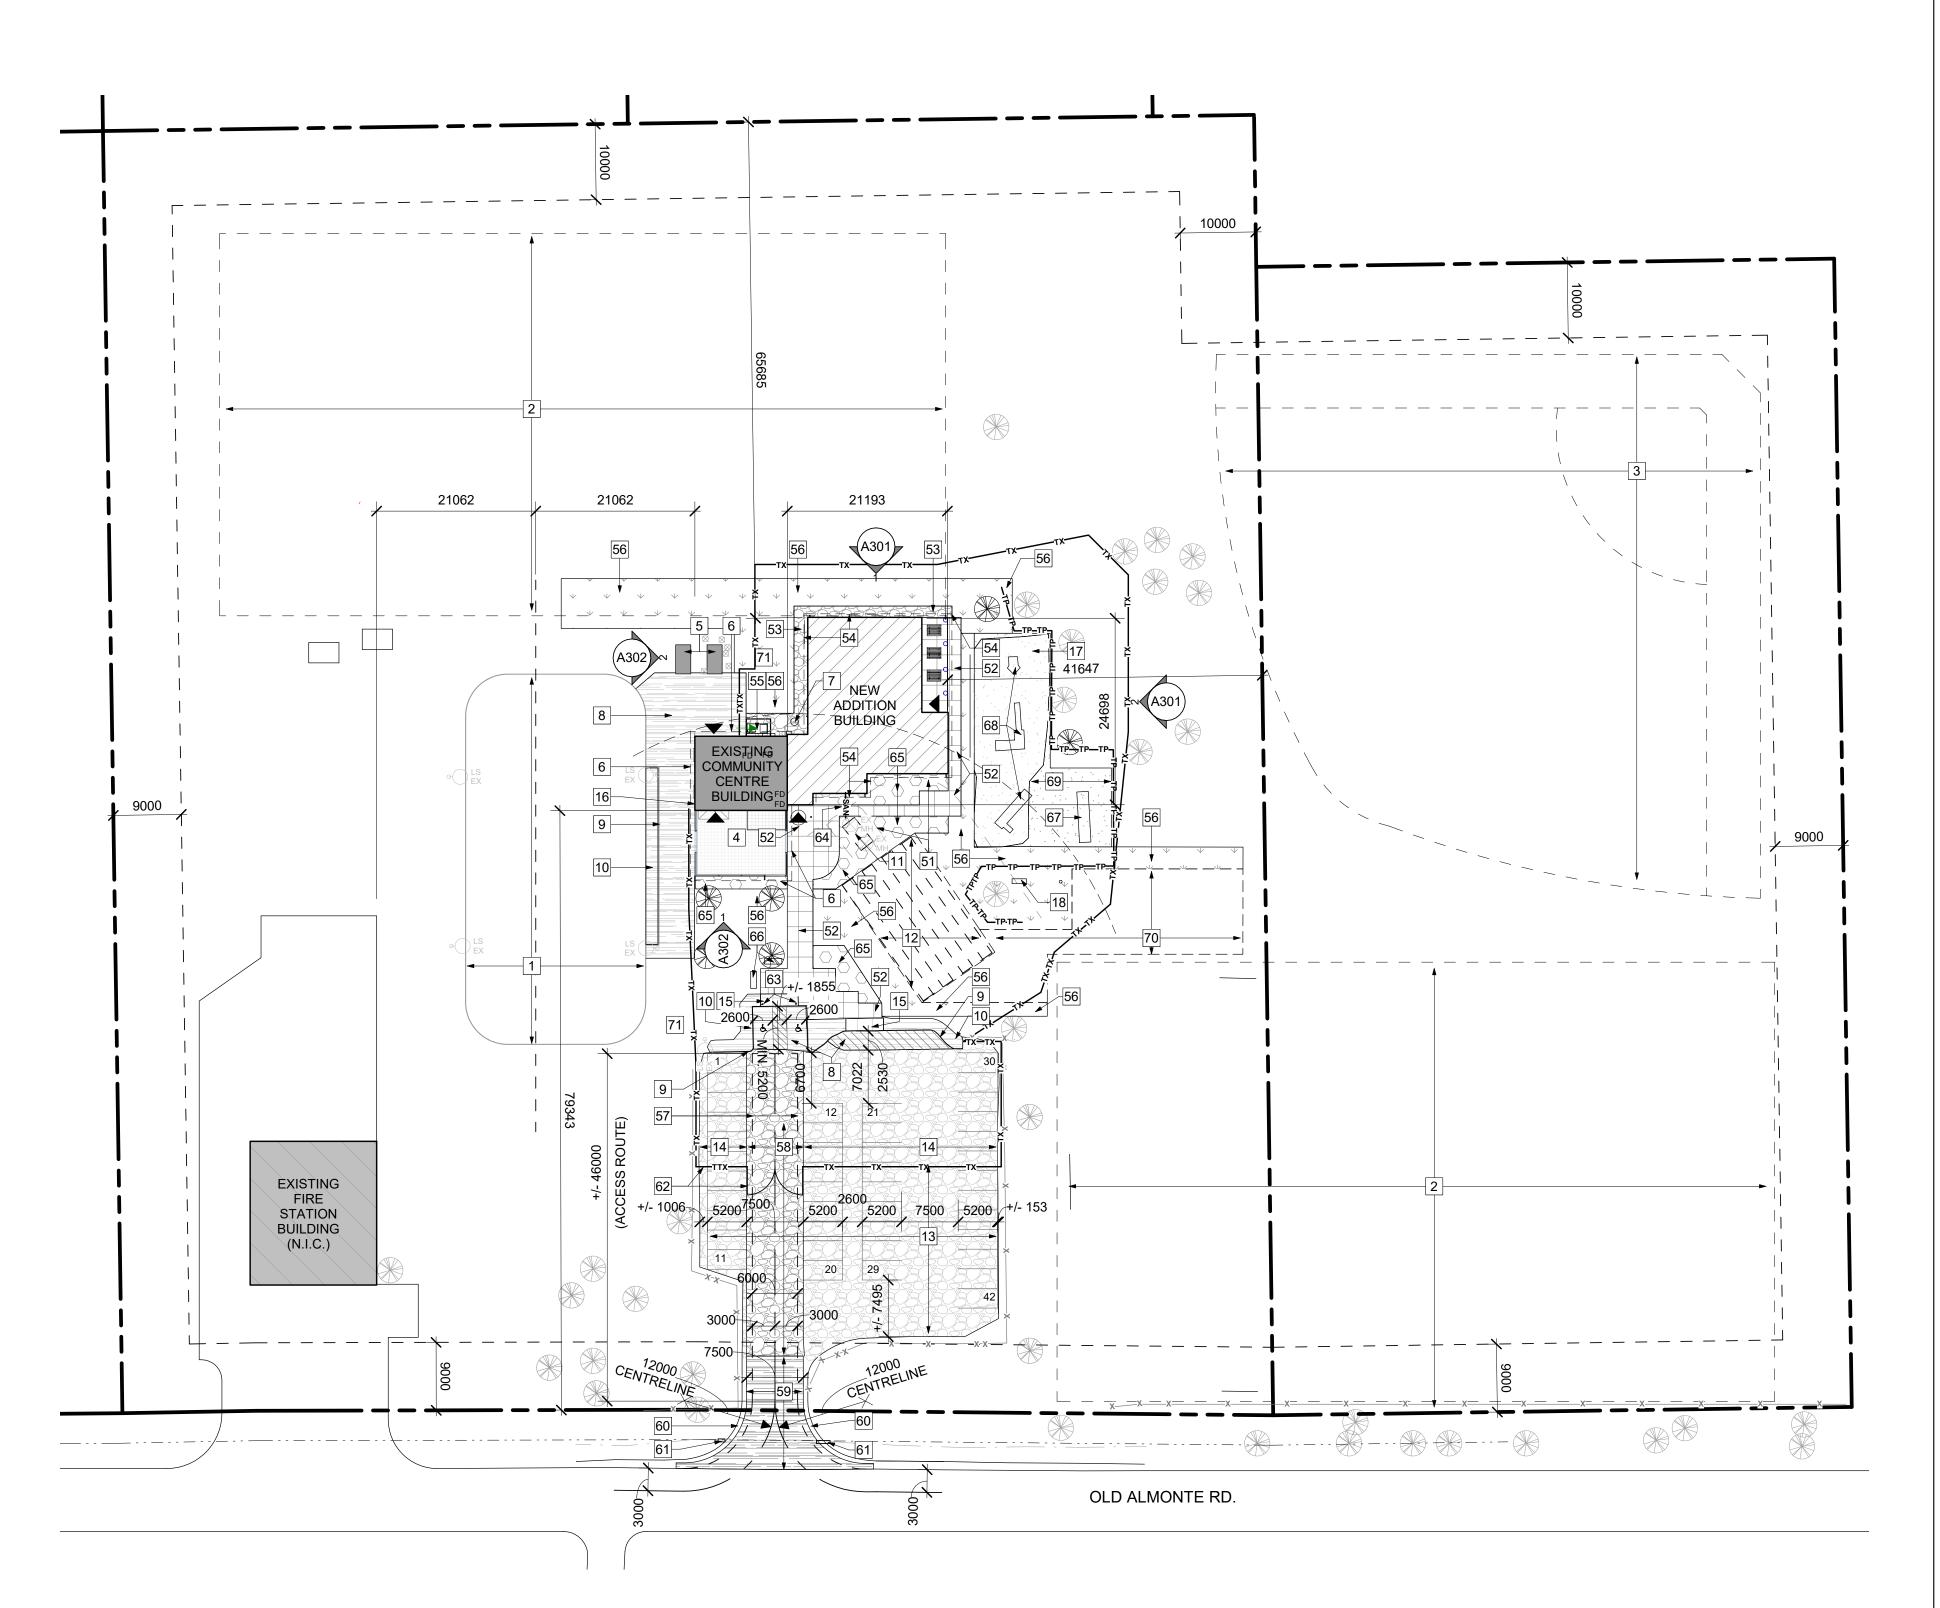

#### **NEW SITE PLAN LEGEND** SITE PLAN GENERAL NOTES:

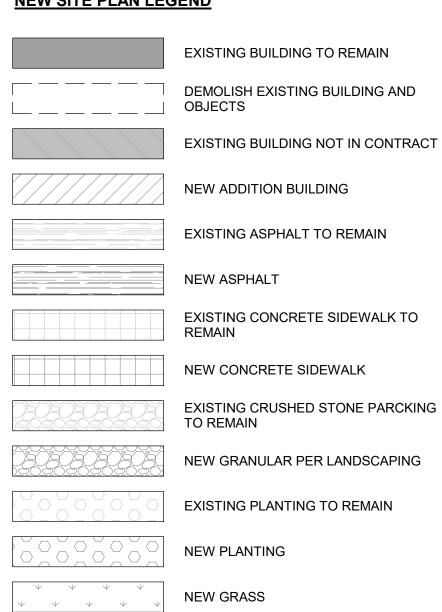

REMAIN

SETBACK LINE

ROAD SETBACK

——x——x——x—— EXISTING FENCE TO REMAIN

TEMPORARY FENCE FOR PERIOD OF

CONSTRUCTION

EXISTING ELECTRICAL SERVICE TO

NEW ELECTRICAL SERVICE (BELOW

REMAIN (BELOW GRADE)

BUILDING ENTRANCE / EXIT

LIGHT STAND - EXISTING

LIGHT STAND - NEW

MANHOLE - EXISTING

UTILITY POLE - EXISTING

UTILITY POLE - NEW

TREE - EXISTING

TREE - NEW

MANHOLE - NEW

GRADE)

TREE PROTECTION PER LANDSCAPING

PROPERTY LINE

---- OVERHEAD

——x——x——x—— NEW FENCE

——wtr——wtr—— NEW WATER SUPPLY

——SAN——SAN—— NEW SANITARY

—\_st\_\_\_st\_\_\_st\_\_\_NEW STORM

⊕ Ls

 $\bigotimes_{\mathsf{MH}}$ 

EXISTING SAND PLAYGROUND TO

NEW SAND PLAYGROUND

#### **SITE PLAN KEYNOTES:**

1	EXISTING SKATING RING TO REMAIN
2	EXISTING SOCCER FIELD TO REMAIN

A. DO NOT SCALE THIS DRAWING

CONSULTANT

CONSULTANT

**EXCAVATION** 

**EXCAVATION** 

TO DIGGING

UNKNOWN SUBSURFACE CONDITIONS

B. REPORT ANY DISCREPANCIES PRIOR TO COMMENCING WORK. NO RESPONSIBILITY IS BORN BY THE CONSULTANT FOR

SITE AND REPORT ANY ERRORS AND/OR OMISSIONS TO THE

D. REINSTATE ALL AREAS AND ITEMS DAMAGED AS A RESULT OF CONSTRUCTION ACTIVITIES TO THE SATISFACTION OF THE

E. CONTRACTOR TO LAYOUT PLANTING BEDS, PATHWAYS ETC.

TO APPROVAL OF CONSULTANT PRIOR TO ANY JOB

F. THE ACCURACY OF THE POSITION OF UTILITIES IS NOT GUARANTEED - CONTRACTOR TO VERIFY PRIOR TO

G. INDIVIDUAL UTILITY COMPANY MUST BE CONTACTED FOR

H. ALL DISTURBED AREAS TO BE RESTORED TO ORIGINAL

CONDITION OR BETTER UNLESS OTHERWISE NOTED

CONFIRMATION OF UTILITY EXISTENCE AND LOCATION PRIOR

C. CONTRACTOR TO CHECK AND VERIFY ALL DIMENSIONS ON

3 EXISTING BASEBALL DIAMOND TO REMAIN

4 EXISTING COVERED DECK TO REMAIN

5 EXISTING STORAGE UNIT TO REMAIN

6 EXISTING ROOF OVERHANG ABOVE TO REMAIN

7 EXISTING DRILLED WELL TO REMAIN

8 EXISTING ASPHALT PAVING TO REMAIN

9 EXISTING CURB TO REMAIN

10 EXISTING ASPHALT SIDEWALK TO REMAIN

11 EXISTING SEPTIC TANK TO REMAIN

12 EXISTING SEPTIC DRAIN FIELD TO REMAIN. ELIMINATE AUTOMOBILE AND EQUIPMENT MOVEMENT OVER THIS

13 PARKING SPACES RESERVED FOR SOCCER TEAMS DURING

CONSTRUCTION 14 EXISTING GRAVEL PARKING TO REMAIN

15 EXISTING ACCESSIBLE CONCRETE CURB RAMP AND

DEPRESSED CURB TO REMAIN

16 EXISTING HOSE BIB TO REMAIN. ENSURE RUNNING WATER FOR HOCKEY RING DURING CONSTRUCTION.

17 EXISTING PLAYGROUND TO REMAIN

18 EXISTING BENCH TO REMAIN

51 REQUIRED STRUCTURE SETBACK

52 NEW CONCRETE PAVING PER LANDSCAPING

53 NEW GRANULAR PER LANDSCAPING

54 NEW ROOF OVERHANG ABOVE

NEW HEAT PUMP AND CONDENSING UNITS PER MECHANICAL ON CONCRETE PAD. SURROUND BY LINK FENCE WITH LOCKABLE ACCESS GATE.

56 NEW TOP SOIL AND GRASS AT AREA AFFECTED BY

CONSTRUCTION AND PER LANDSCAPING 57 NEW ACCESS ROUTE FOR FIRE DEPARTMENT (SHOWN

NEW HEAVY DUTY GRAVEL PAVEMENT STRUCTURE DESIGNED TO SUPPORT FIREFIGHTING EQUIPMENT AND PERMIT ACCESSIBILITY UNDER ALL CLIMATIC CONDITIONS

DASHED). CLEAR WIDTH 6000mm MIN., CENTERLINE RADIUS

59 NEW ASPHALT HEAVY DUTY PAVEMENT STRUCTURE DESIGNED TO SUPPORT FIRE FIGHTING EQUIPMENT PER

60 EXTEND DRIVEWAY PER CIVIL AS REQUIRED. VERIFY EXTENT OF EXISTING DRIVEWAY ON SITE.

61 EXTEND CULVERT PER CIVIL AS REQUIRED. VERIFY EXTENT

62 TEMPORARY FENCING COMPLETED WITH ACCESS GATES FOR PERIOD OF CONSTRUCTION

63 NEW POST AND ACCESSIBLE PARKING SIGN.

OF EXISTING CULVERT ON SITE.

64 NEW SANITARY SEWAGE PER CIVIL

65 NEW PLANTING PER LANDSCAPING

66 INSTALL SALVAGED BICYCLE RACKS. ADJUST AS REQUIRED.

67 INSTALL SALVAGED SWINGS PER LANDSCAPING

68 INSTALL SALVAGED PLAY STRUCTURES PER LANDSCAPING

69 NEW PLAY GROUND EXTENSION PER LANDSCAPING

70 AREA FOR FUTURE SEPTIC FIELD EXPANSION PER LANDSCAPING

71 POND PER CIVIL

# **CSV** ARCHITECTS

sustainable design · conception écologique

613.564.8118 402-1066 Somerset St. W www.csv.ca Ottawa, Ontario, K1Y 4T3

STRUCTURAL ENGINEER 2611 Queensview Dr, Suite 300 Ottawa, Ontario, K2B 8K2 Canada 613-690-3752 wsp.com

MECHANICAL ENGINEER Chorley + Bisset Consulting Engineers 403-250 City Centre Ave, Ottawa ON K1R 6K7 613-241-0030 chorley.com

ELECTRICAL ENGINEER Chorley + Bisset Consulting Engineers 403-250 City Centre Ave, Ottawa ON K1R 6K7 613-241-0030 chorley.com

CIVIL ENGINEER McIntosh Perry 115 Walgreen Road, RR3, Carp, ON K0A 1L0 613-836-2184 mcintoshperry.com

LANDSCAPE ARCHITECT GJA InC. 110 Didsbury Road Unit # 9 Ottawa Ontario, K2T 0C2 613-286-5130 Gino@GJALA.com



STAMP

3 2022/02/23 ISSUED FOR SITE PLAN CONTROL

REV DATE ISSUE

1. OWNERSHIP OF THE COPYRIGHT OF THE DESIGN AND THE WORKS EXECUTED FROM THE DESIGN REMAINS WITH CSV ARCHITECTS, AND MAY NOT BE REPRODUCED IN ANY FORM WITHOUT THE WRITTEN CONSENT OF CSV ARCHITECTS. 2. THE DRAWINGS, PRESENTATIONS AND SPECIFICATIONS AS INSTRUMENTS OF SERVICE

ARCHITECTS. THEY ARE NOT TO BE USED BY THE CLIENT ON OTHER PROJECTS OR ON EXTENSIONS TO THIS PROJECT WITHOUT THE WRITTEN CONSENT OF CSV ARCHITECTS. 3. THIS DRAWING IS TO BE READ IN CONJUNCTION WITH ALL OTHER PROJECT DRAWINGS AND

SPECIFICATIONS. 4. DO NOT SCALE DRAWINGS. CONTRACTOR SHALL BE RESPONSIBLE TO VERIFY DIMENSIONS ON SITE. 5. ALL WORK SHALL BE IN ACCORDANCE WITH THE ONTARIO BUILDING CODE AND ALL SUPPLEMENTS AND APPLICABLE MUNICIPAL REGULATIONS.

ARE AND SHALL REMAIN THE PROPERTY OF CSV

CLIENT

# **CITY OF OTTAWA**

OTTAWA ONTARIO, CANADA

PROJECT

## **CORKERY COMMUNITY** HALL EXPANSION

3447 OLD ALMONTE RD., CARP, ON K0A 1L0 TITLE

SITE PLAN

PROJECT NO: 2020-0640 DRAWN: APPROVED:

SCALE: As indicated DATE PRINTED: 2/24/2022 7:23:01 PM


A100

DRAWING NO.

1 OVERALL SITE PLAN - NEW

7516 m<sup>2</sup>

36665 m<sup>2</sup>

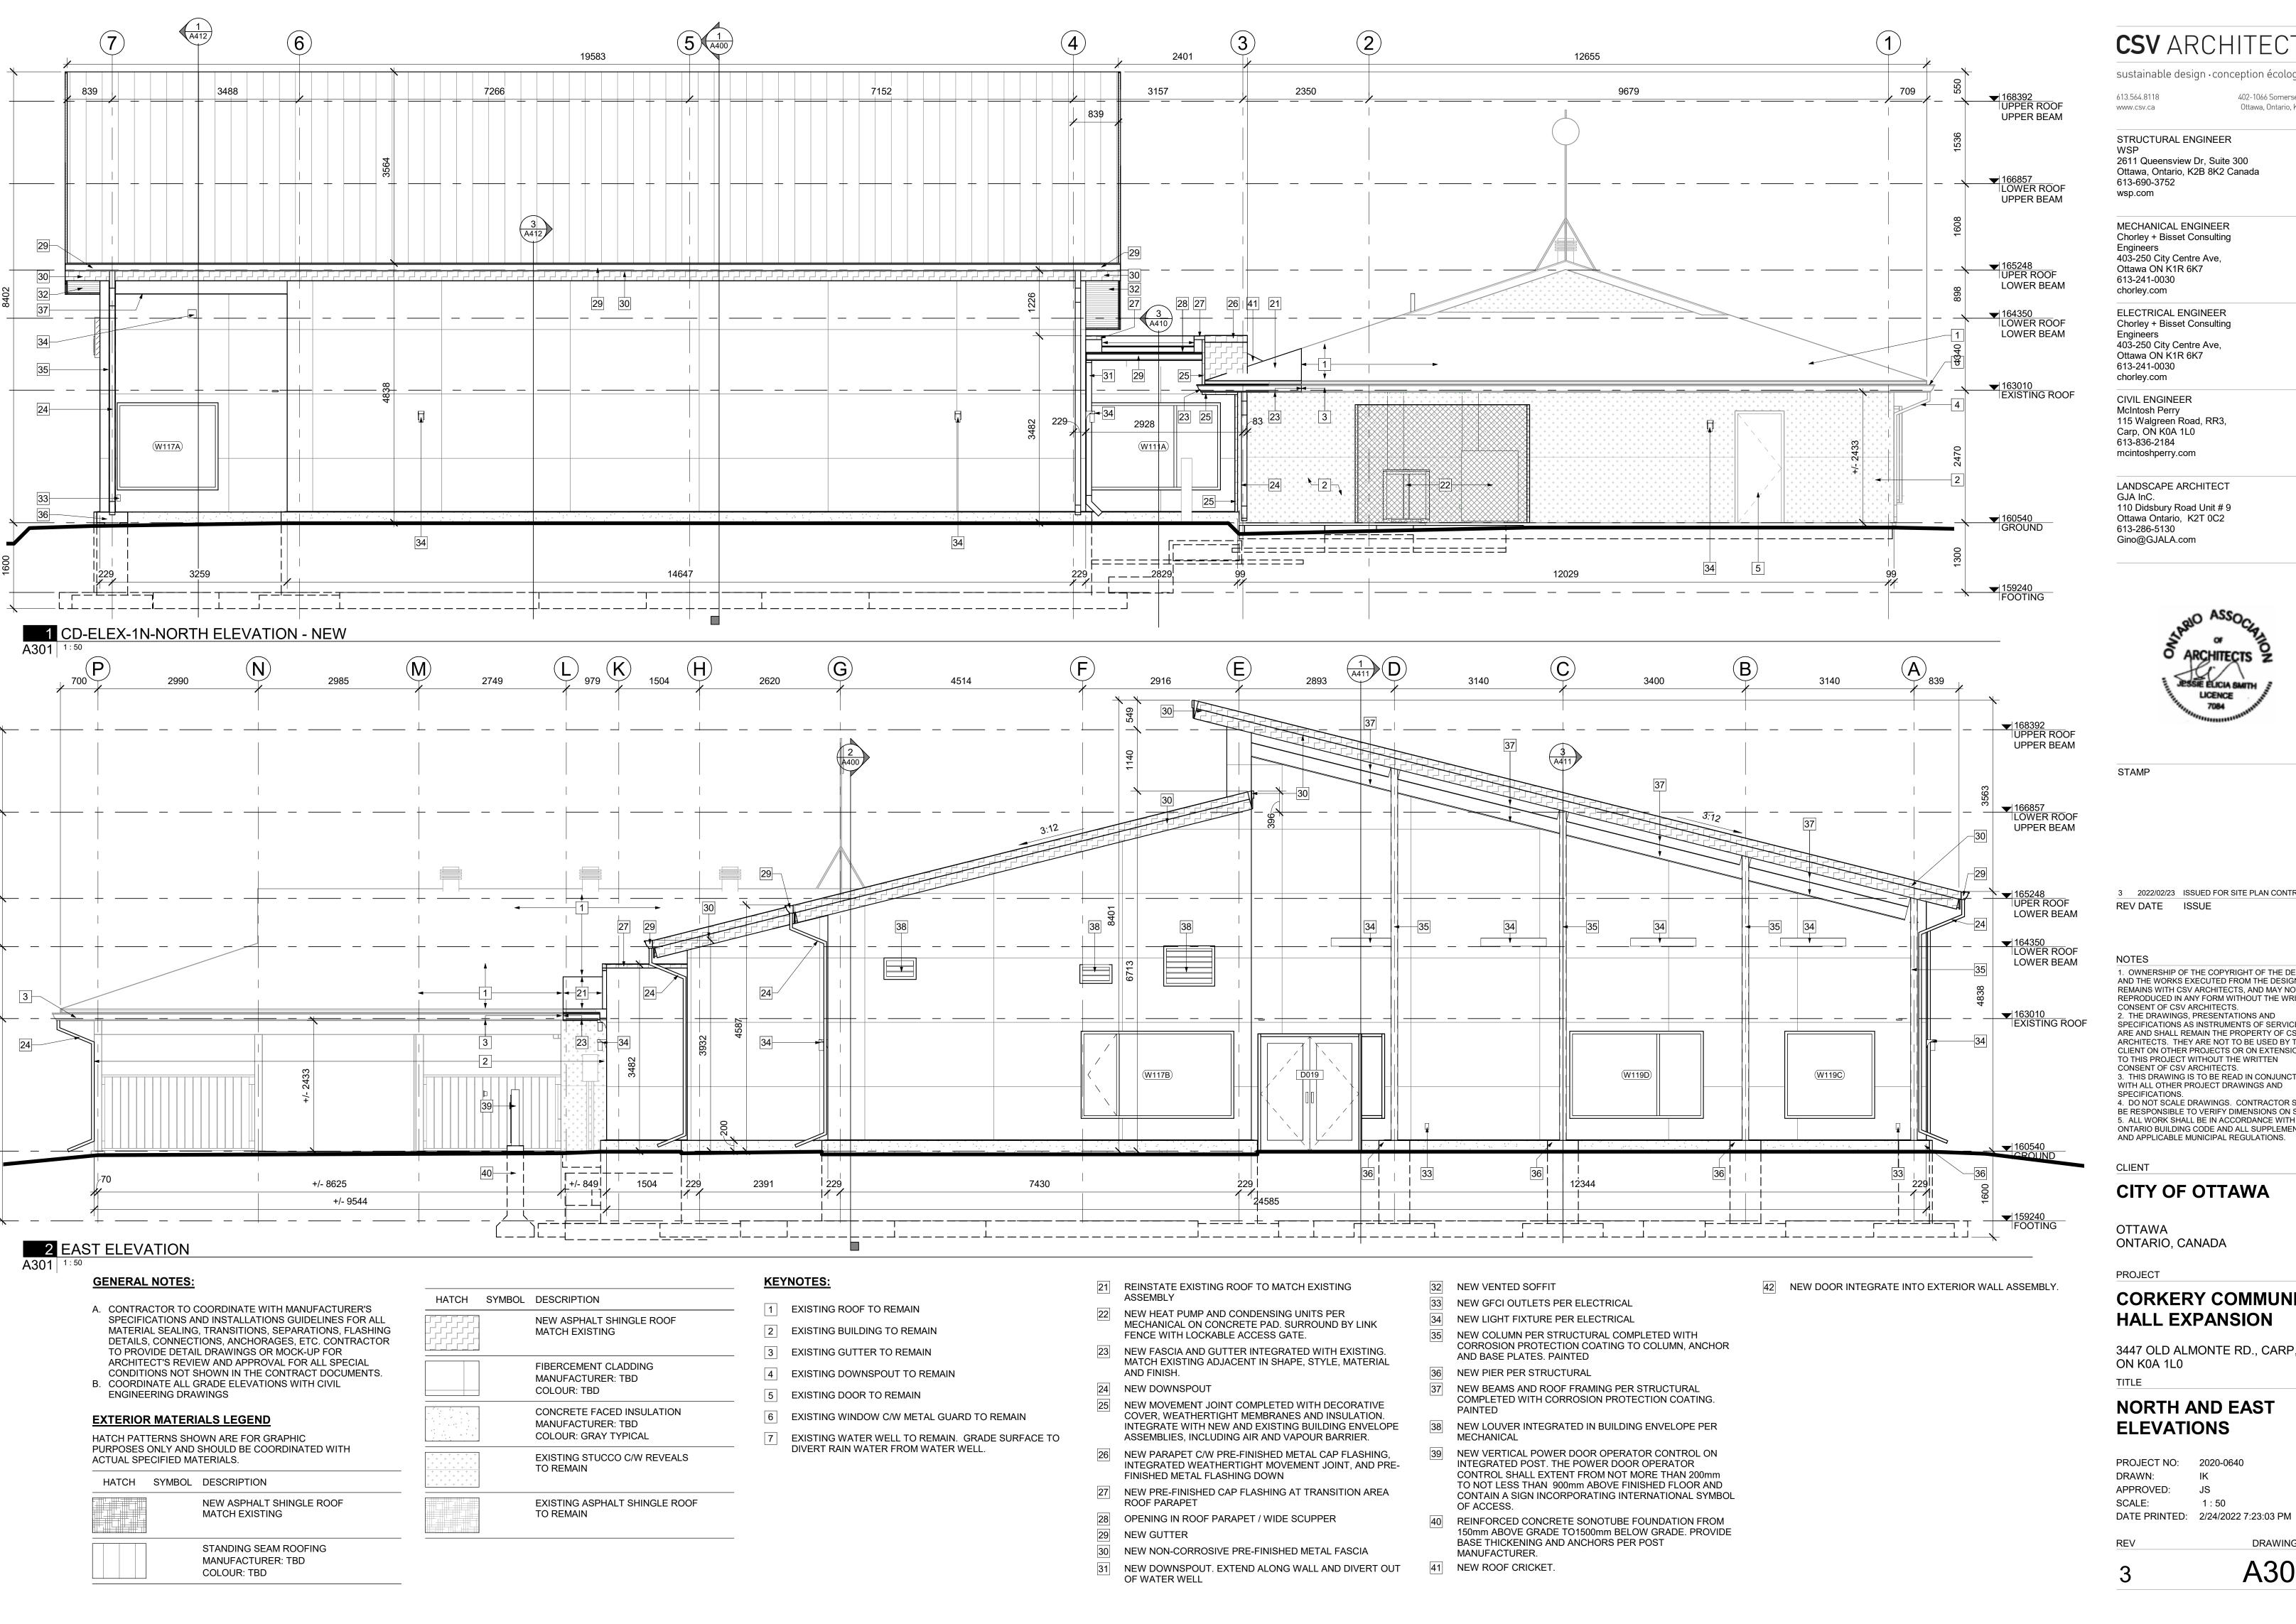

**CSV** ARCHITECTS

sustainable design · conception écologique

613.564.8118 402-1066 Somerset St. W Ottawa, Ontario, K1Y 4T3

STRUCTURAL ENGINEER 2611 Queensview Dr, Suite 300 Ottawa, Ontario, K2B 8K2 Canada 613-690-3752 wsp.com

> MECHANICAL ENGINEER Chorley + Bisset Consulting Engineers 403-250 City Centre Ave, Ottawa ON K1R 6K7 613-241-0030 chorley.com

ELECTRICAL ENGINEER Chorley + Bisset Consulting Engineers 403-250 City Centre Ave, Ottawa ON K1R 6K7 613-241-0030

CIVIL ENGINEER McIntosh Perry 115 Walgreen Road, RR3, Carp, ON K0A 1L0 613-836-2184 mcintoshperry.com

LANDSCAPE ARCHITECT GJA InC. 110 Didsbury Road Unit # 9 Ottawa Ontario, K2T 0C2 613-286-5130 Gino@GJALA.com



STAMP

3 2022/02/23 ISSUED FOR SITE PLAN CONTROL REV DATE ISSUE

1. OWNERSHIP OF THE COPYRIGHT OF THE DESIGN AND THE WORKS EXECUTED FROM THE DESIGN REMAINS WITH CSV ARCHITECTS, AND MAY NOT BE REPRODUCED IN ANY FORM WITHOUT THE WRITTEN CONSENT OF CSV ARCHITECTS.

2. THE DRAWINGS, PRESENTATIONS AND SPECIFICATIONS AS INSTRUMENTS OF SERVICE ARE AND SHALL REMAIN THE PROPERTY OF CSV ARCHITECTS. THEY ARE NOT TO BE USED BY THE CLIENT ON OTHER PROJECTS OR ON EXTENSIONS TO THIS PROJECT WITHOUT THE WRITTEN CONSENT OF CSV ARCHITECTS. 3. THIS DRAWING IS TO BE READ IN CONJUNCTION WITH ALL OTHER PROJECT DRAWINGS AND

SPECIFICATIONS. 4. DO NOT SCALE DRAWINGS. CONTRACTOR SHALL BE RESPONSIBLE TO VERIFY DIMENSIONS ON SITE. 5. ALL WORK SHALL BE IN ACCORDANCE WITH THE ONTARIO BUILDING CODE AND ALL SUPPLEMENTS AND APPLICABLE MUNICIPAL REGULATIONS.

CLIENT

### **CITY OF OTTAWA**

OTTAWA ONTARIO, CANADA

PROJECT

## **CORKERY COMMUNITY** HALL EXPANSION


3447 OLD ALMONTE RD., CARP, ON K0A 1L0

## **NORTH AND EAST ELEVATIONS**

PROJECT NO: 2020-0640 DRAWN: APPROVED: JS 1:50

DRAWING NO.

A301

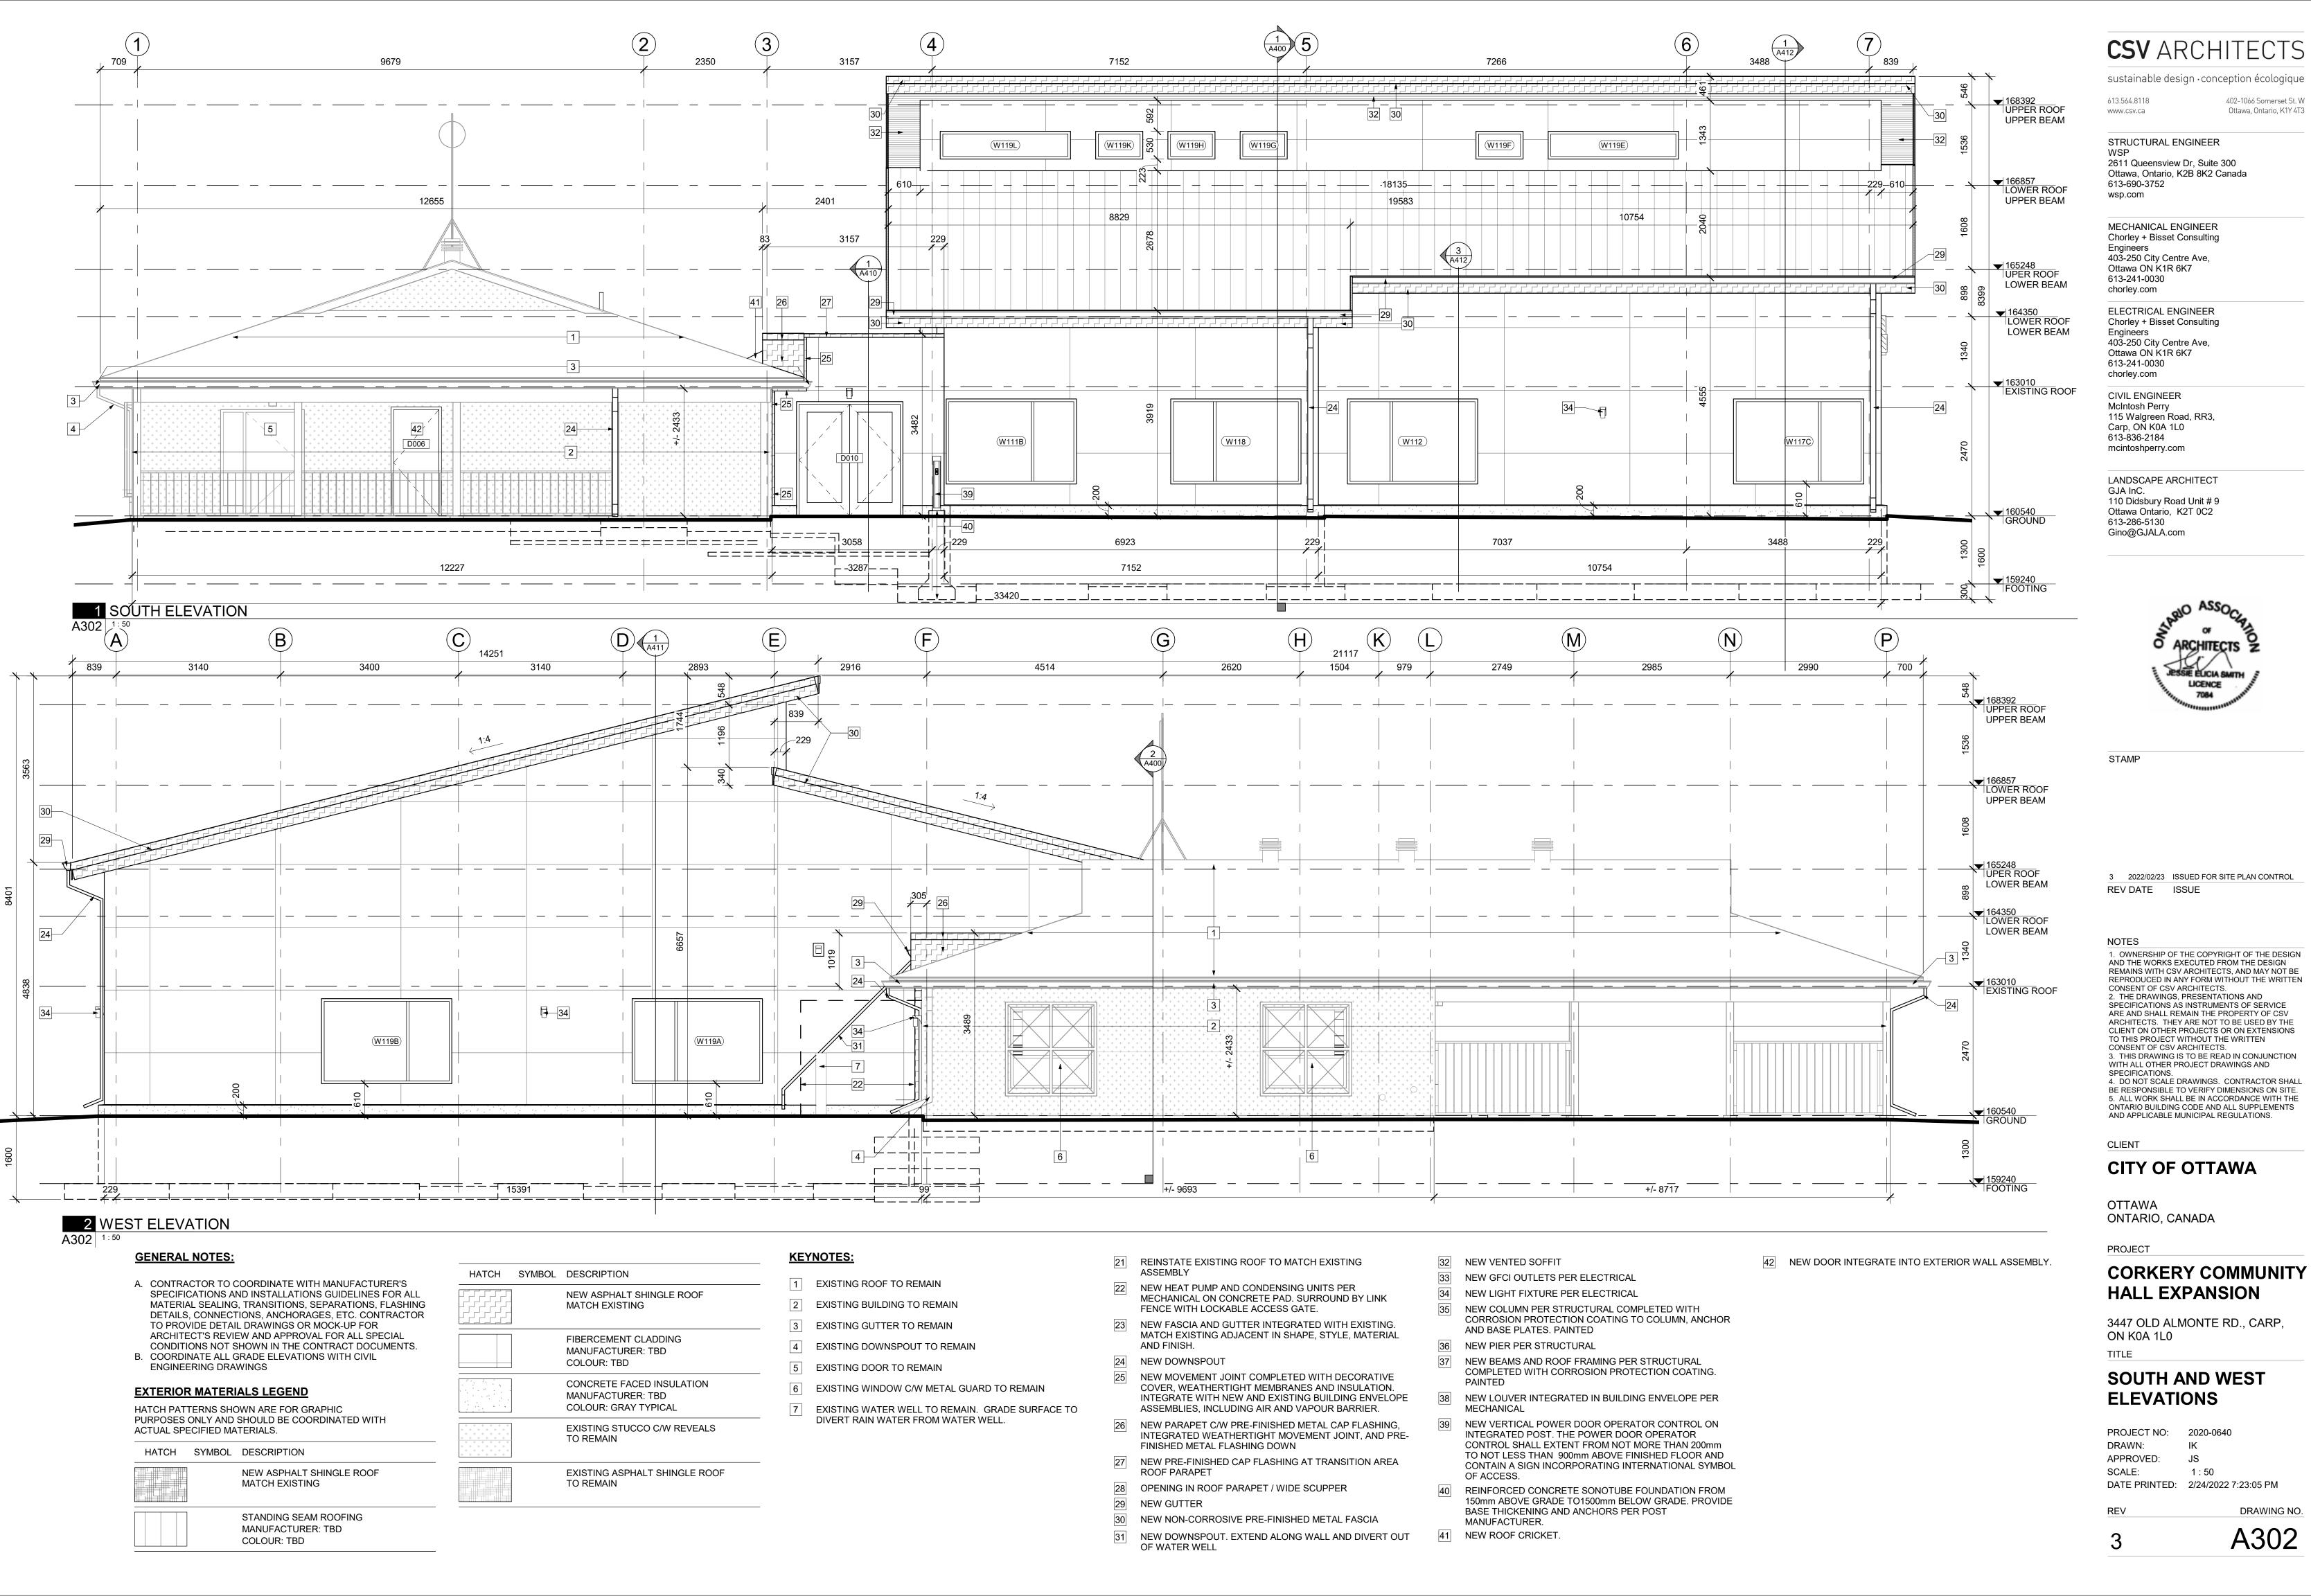

**CSV** ARCHITECTS

JS

1:50

DRAWING NO.

A302

402-1066 Somerset St. W

Ottawa, Ontario, K1Y 4T3