



RICHCRAFT TRAILSEDGE RENTAL BLOCKS 193 & 194 SITE PLAN





LIST OF DRAWINGS:

LANDSCAPE PLAN

DETAILS

DETAILS

DETAILS

DETAILS

CROSS SECTIONS

GENERAL NOTES:

TRAILSEDGE PHASE 1 -


FERN CASEY STREET

- APPROVED CUP, GRADING AND SITE PLAN.
- 3. CONTRACTOR SHALL ENSURE THAT ALL UTILITY LOCATIONS ARE OBTAINED PRIOR TO ANY EXCAVATION FOR LANDSCAPING.
- 4. LOCATION OF ALL PLANT MATERIALS TO BE STAKED BY THE CONTRACTOR AND VERIFIED IN THE FIELD BY LANDSCAPE ARCHITECT PRIOR TO THE EXCAVATION OF PITS.
- 5. ALL PLANT MATERIAL SHALL BE NURSERY GROWN STOCK UNLESS OTHERWISE NOTED.
- 6. TREES TO HAVE A MINIMUM 1800 CLEAR STEM ABOVE GRADE.
- 7. PLACE SOD ON A MINIMUM 150mm TOPSOIL.
- 8. CONTRACTOR TO MAKE GOOD ALL EXISTING AREAS DAMAGED BY HIS WORK TO THE SATISFACTION OF THE CITY OF OTTAWA.
- 9. THE CITY WILL BE NOTIFIED IF ANY TREES CANNOT BE LOCATED OR PLANTED DUE TO CONFLICTS WITH UTILITIES OR DRIVEWAYS. THE REQUIRED TREES NOT PLANTED ARE SUBJECT TO TREE BANKING. THE FINAL NUMBER OF TREES TO BE BANKED WILL BE PROVIDED TO THE CITY FOLLOWING ALL PLANTINGS.
- 10. ALL PLANT MATERIAL SHALL BE WARRANTIED FOR TWO YEARS FROM THE DATE OF SUBSTANTIAL PERFORMANCE AS DETERMINED BY THE CITY OF OTTAWA.
- 11. PERIODIC REVIEWS OF PLANTING SHALL BE CARRIED OUT BY THE LANDSCAPE ARCHITECT.
- 12. PLANTINGS TO BE STAKED FOR APPROVAL PRIOR TO CONSTRUCTION
- 13. CITY GRASS CUTTING RESPONSIBILITIES FOR SODDED AREAS SHALL BEGIN FOLLOWING PERFORMANCE ACCEPTANCE INSPECTION BY THE LANDSCAPE ARCHITECT AND THE CITY. ACCEPTANCE WILL BE PROVIDED ONLY IF: SOD IS PROPERLY ESTABLISHED. TURF IS FREE OF DEAD SPOTS AND WEEDS.
- SODDED AREAS HAVE BEEN CUT WITHIN 24 HOURS PRIOR TO ACCEPTANCE INSPECTION.
- MINIMUM OF 3 WEEKS HAVE ELAPSED FOLLOWING LAYING OF SOD. A MINIMUM OF TWO CUTS HAVE TAKEN PLACE. - SODDED AREAS HAVE BEEN TOP-DRESSED, SEEDED AND AERATED
- 14. STREET TREE PLANTING GUIDELINE NOTE: APPROVED CROSS SECTIONS SHALL TAKE PRECEDENCE
 - 4.5m STREET LIGHT 2.5m - STREET LIGHT (SMALL TREE <7m MATURE HT.)
 - 3.0m HYDRO TRANSFORMER 1.5m - PATH, DRIVEWAY, FENCE, SOUND WALL
 - 4.5m CONIFERS MINIMUM SETBACK FROM CURB 2.5m - FIRE HYDRANTS
 - 1.5m WATER SERVICE / CURB STOP 1.0m - BELL / CABLE PEDESTALS

- 1. THIS LANDSCAPE PLAN CONFORMS WITH THE TREE-TO-FOUNDATION SETBACK, SOIL VOLUME, AND SURFACE-GRADING REQUIREMENTS OUTLINED IN THE CITY OF OTTAWA' GUIDELINES FOR TREE PLANTING IN SENSITIVE MARINE CLAY SOILS (2017), BASED ON THE
- 2. ADDITIONAL REQUIREMENTS OUTLINED IN THE CITY OF OTTAWA'S <u>GUIDELINES FOR TREE</u> PLANTING IN SENSITIVE MARINE CLAY SOILS (2017), INCLUDING USF DEPTH, FOUNDATION WALL REINFORCEMENT, AND SUBDIVISION GRADING, SHOULD BE CONFIRMED BY THE PROJECT ENGINEER(S).
- 3. THE CONTRACTOR SHOULD REPORT ANY DISCREPANCIES TO THE CONTRACT ADMINISTRATOR BEFORE PLANTING TREES.

FINDINGS OUTLINED IN THE PROJECT GEOTECHNICAL REPORT.

- 4. CITY OF OTTAWA: GUIDELINES FOR TREE PLANTING IN SENSITIVE MARINE CLAY SOILS (2017): THE FOLLOWING GUIDELINES ARE PRIMARILY FOCUSED ON SMALL AND MEDIUM SIZE STREET TREES. HOWEVER, LARGE TREES (MATURE HEIGHT OVER 14M) CAN STILL BE PLANTED IN AREAS OF SMC SOILS PROVIDED A TREE TO FOUNDATION SETBACK EQUAL TO THE FULL MATURE HEIGHT OF THE TREE CAN BE PROVIDED (E.G. IN A PARK OR OTHER GREEN SPACE). FOR STREET TREES IN THE ROAD RIGHT-OF-WAY WHERE SMC SOILS HAVE BEEN IDENTIFIED, THE TREE TO FOUNDATION SETBACKS MAY BE REDUCED TO 4.5M FOR SMALL (MATURE TREE HEIGHT UP TO 7.5M) AND MEDIUM SIZE TREES (MATURE TREE HEIGHT 7.5M-14M) PROVIDED ALL OF THE FOLLOWING SIX CONDITIONS ARE MET:
- THE MODIFIED PLASTICITY INDEX OF THE SOIL BETWEEN THE UNDERSIDE OF FOOTING (USF) AND A DEPTH OF 3.5M GENERALLY DOES NOT EXCEED 40%. THIS CORRESPONDS TO SOILS WITH LOW/MEDIUM POTENTIAL FOR SOIL VOLUME CHANGE. CLAY SOILS THAT EXCEED THE 40% PLASTICITY INDEX ARE CONSIDERED TO HAVE HIGH POTENTIAL FOR SOIL VOLUME CHANGE. FOR THESE WORST-CASE SOILS, THE SETBACKS AND TREE PLANTING RESTRICTIONS REMAIN UNCHANGED FROM THE 2005 CLAY SOILS POLICY (TREE SETBACK MUST EQUAL THE
- MATURE HEIGHT OF THE TREE I.E. 7.5M SETBACK FOR SMALL TREES). THE USF IS 2.1M OR GREATER BELOW THE LOWEST FINISHED GRADE. NOTE: THIS FOOTING LEVEL MUST BE SATISFIED FOR FOOTINGS WITHIN 10M OF THE TREE, AS MEASURED FROM THE CENTRE OF THE TREE TRUNK, AND VERIFIED BY MEANS OF THE GRADING PLAN AS INDICATED IN THE PROCEDURAL CHANGES BELOW.
- A SMALL SIZE TREE MUST BE PROVIDED WITH A MINIMUM OF 25M3 OF AVAILABLE SOIL VOLUME, AS DETERMINED BY A LANDSCAPE ARCHITECT. A MEDIUM SIZE TREE MUST BE PROVIDED WITH A MINIMUM OF 30M3 OF AVAILABLE SOIL VOLUME, AS DETERMINED BY A LANDSCAPE ARCHITECT. THE DEVELOPER WILL ENSURE THE SOIL IS GENERALLY UNCOMPACTED WHEN BACKFILLING IN STREET TREE PLANTING LOCATIONS.
- THE SOIL VOLUME CALCULATION MUST BE BASED ON A DEPTH OF 1.5M BELOW FINISHED GRADE (E.G. 5M LENGTH X 4M WIDTH AT SURFACE X 1.5M DEPTH = 30M3). IT MAY INCLUDE LANDS IN THE RIGHT-OF-WAY AND ON PRIVATE PROPERTY, BUT MUST SUBTRACT THE VOLUME OF SHALLOW UTILITY TRENCHES (I.E. VOLUME OF SHALLOW UTILITY TRENCHES CANNOT COUNT TOWARDS MINIMUM SOIL VOLUME).
- THE TREE SPECIES MUST BE SMALL TO MEDIUM SIZE, AS CONFIRMED BY A LANDSCAPE ARCHITECT IN THE LANDSCAPE PLAN.
- THE FOUNDATION WALLS ARE TO BE REINFORCED AT LEAST NOMINALLY (MINIMUM OF TWO UPPER AND TWO LOWER 15M BARS IN THE FOUNDATION WALL) TO PROVIDE DUCTILITY AS DESCRIBED IN THE GEOTECHNICAL REPORT.
- GRADING SURROUNDING THE TREE MUST PROMOTE DRAINING TO THE TREE ROOT ZONE (IN SUCH A MANNER AS NOT TO BE DETRIMENTAL TO THE TREE), AS NOTED ON THE SUBDIVISION GRADING PLAN.

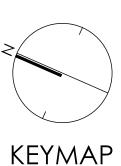



THIS PLAN IS FOR APPROVAL AND TENDERING PURPOSES ONLY, NOT FOR CONSTRUCTION. THIS PLAN SHALL BE READ IN CONJUNCTION WITH DRAWINGS PREPARED BY HYDRO OTTAWA, BELL CANADA, ROGERS CABLE AND ENBRIDGE GAS. THE CITY OF OTTAWA STANDARDS SHALL GOVERN OVER THIS DRAWING



				No.	Description
				Revi	sion
				City	Approval Stam
R	EE SOIL VOLUM	ES			
	SINGLE TREE SOIL VOLUME	MULTIPLE TREE SOIL VOLUME (m3/TREE)			
	15	9		,	ON OF LA
	15	9			VIANO TARDE
	20	12		//s	3/6/
	VOLUME 15 15	SOIL VOLUME (m3/TREE) 9 9			// 014 ==

GENERAL NOTES:

- CELTIS OCCIDENTALIS TO BE SPRING DUG SPECIMENS AND PLANTED IN THE SPRING ONLY.
- THE LOCATION OF THE TREES SHOWN ON THIS PLAN IS APPROXIMATE AND SHALL NOT BE SCALED FROM THIS DRAWING. THIS PLAN MUST BE READ IN CONJUNCTION WITH THE APPROVED CUP, GRADING AND SITE PLAN.

. CONTRACTOR SHALL ENSURE THAT ALL UTILITY LOCATIONS ARE OBTAINED

- LOCATION OF ALL PLANT MATERIALS TO BE STAKED BY THE CONTRACTOR
- AND VERIFIED IN THE FIELD BY LANDSCAPE ARCHITECT PRIOR TO THE EXCAVATION OF PITS.
- ALL PLANT MATERIAL SHALL BE NURSERY GROWN STOCK UNLESS OTHERWISE
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- 12. PLANTINGS TO BE STAKED FOR APPROVAL PRIOR TO CONSTRUCTION
- 13. EXISTING TREES TO REMAIN SHALL BE PROTECTED WITH TREE PROTECTION FENCING PER CITY STANDARD DETAIL F7.
- 14. CITY GRASS CUTTING RESPONSIBILITIES FOR SODDED AREAS SHALL BEGIN FOLLOWING PERFORMANCE ACCEPTANCE INSPECTION BY THE LANDSCAPE ARCHITECT AND THE CITY. ACCEPTANCE WILL BE PROVIDED
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- 1.5m PATH, DRIVEWAY, FENCE, SOUND WALL 4.5m - CONIFERS MINIMUM SETBACK FROM CURB
- 2.5m FIRE HYDRANTS 1.5m - WATER SERVICE / CURB STOP
- 1.0m BELL / CABLE PEDESTALS

TREE PLANTING IN MARINE CLAY SOILS


ENGINEER(S).

- *THE LANDSCAPE CONSIDERATIONS CONTAINED WITHIN SEC. 6.8 OF PATERSON GROUP'S GEOTECHNICAL INVESTIGATION, DATED 24 JULY 2020 HAVE BEEN IMPLEMENTED.
- 1. THIS LANDSCAPE PLAN CONFORMS WITH THE TREE-TO-FOUNDATION SETBACK, SOIL VOLUME, AND SURFACE-GRADING REQUIREMENTS OUTLINED IN THE CITY OF OTTAWA'S GUIDELINES FOR TREE PLANTING IN SENSITIVE MARINE CLAY SOILS (2017), BASED ON THE FINDINGS OUTLINED IN THE PROJECT GEOTECHNICAL REPORT.
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PLA	.NT LIST	- STREET TREES				
KEY	QTY.	BOTANICAL NAME		COMMON NAME	CAL/HT.	ROOT
					(mm)	
MEDI	UM DECIE	DUOUS STREET TREES (INCLUDES TRAILSEDG	E PHASE 1 CO	ULOIR STREET TREES)		
		NATURE HEIGHT				
AR	13	ACER RUBRUM 'AUTUMN SPIRE'		AUTUMN SPIRE MAPLE	60	B&B
CS	10	CATALPA SPECIOSA		NORTHERN CATALPA	60	B&B
CO	9	CELTIS OCCIDENTALIS		HACKBERRY	60	B&B
CC	9	CORYLUS COLURNA		TURKISH HAZEL	60	B&B
GB	10	GINKGO BILOBA 'AUTUMN GOLD'		AUTUMN GOLD GINKGO	60	B&B
GS	10 61	GLEDITSIA TRIACANTHOS VAR. INERMIS H	HALKA	HALKA HONEYLOCUST	60	B&B
	61					
		OUS STREET TREES				
	n MATURE					
MS	<u>3</u>	malus 'snowdrift'		SNOWDRIFT CRAB APPLE	60	B&B
	3					
	IFEROUS T					
PF	2	PINUS STROBUS 'FASTIGIATA'		COLUMNAR WHITE PINE	200cm	B&B
	2					
DECI	DUOUS SH	IRUBS (TREE FORM)				
Ac	42	AMELANCHIER CANADENSIS	SERVICEBER	RY(TREE FORM)	125cm HT.	PT
Αl	33	AMELANCHIER LAEVIS	ALLEGHENY	SERVICEBERRY(TREE FORM)	125cm HT.	PT
Ca	36	CORNUS ALTERNIFOLIA	PAGODA DO	OGWOOD(TREE FORM)	125cm HT.	PT
VI	47	VIBURNUM LENTAGO		Y(TREE FORM)	125cm HT.	
	158			•		


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LEGEND	
FENCING	PROPERTY LINE
	→ DECORATIVE FENCE
	CHAIN LINK FENCE
⊠	GATEWAY COLUMN
PLANTING	ENTRY FEATURE WALL
	EXISTING STREET TREE WITH TREE PROTECTION FENCING
\otimes	EXISTING STREET TREE TO BE REMOVED
	ROW TREE
	MEDIUM DECIDUOUS TREE (7.5m TO 14m HEIGHT)
	SMALL TREE (<7.5m HEIGHT)
0	SHRUB (TREE FORM)
	CONIFEROUS STREET TREE
	LANDSCAPE BOULDER
	SODDING
SURFACING	PLANTING BED
$\overset{\Delta}{\sim}\overset{\Delta}{\sim}\overset{\Delta}{\sim}\overset{\Delta}{\sim}\overset{\Delta}{\sim}\overset{\Delta}{\sim}\overset{\Delta}{\sim}\overset{\Delta}{\sim}$	C.I.P CONCRETE
	ASPHALT PAVING
AMENITIES	PICKLEBALL COURT SURFACE
	umbrella shade shelter
[:::::]	CONCRETE PING PONG TABLE
ठ	BASKETBALL KEY AND HOOP

	7	Re-Issued for 3rd Submission	Sept. 16/2
	6	Issued for 3rd Submission	July 16/21
	5	Issued for 2nd Submission	Apr. 23/2
	4	Re-Issued for 1st Submission with Cross Sections	Jan. 27/21
	3	Issued for 1st Submission	Dec. 14/20
	2	Issued for Client Review	Nov. 20/20
	1	Issued for Client Review	Aug. 12/20
	No.	Description	Date
	Revi	sion	



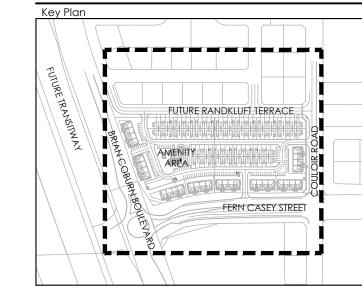

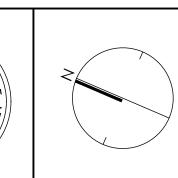


1285 WELLINGTON STREET WEST, OTTAWA, ON K1Y 3A8 CANADA T 613.237.2345 F 613.237.6423 NAKDESIG


TRAILSEDGE RENTAL BLOCKS 193 & 194 SITE PLAN


LANDSCAPE PLAN

Date AUG 2020 Scale 1:500 Drawn Is Checked jh


Job No. 20-135

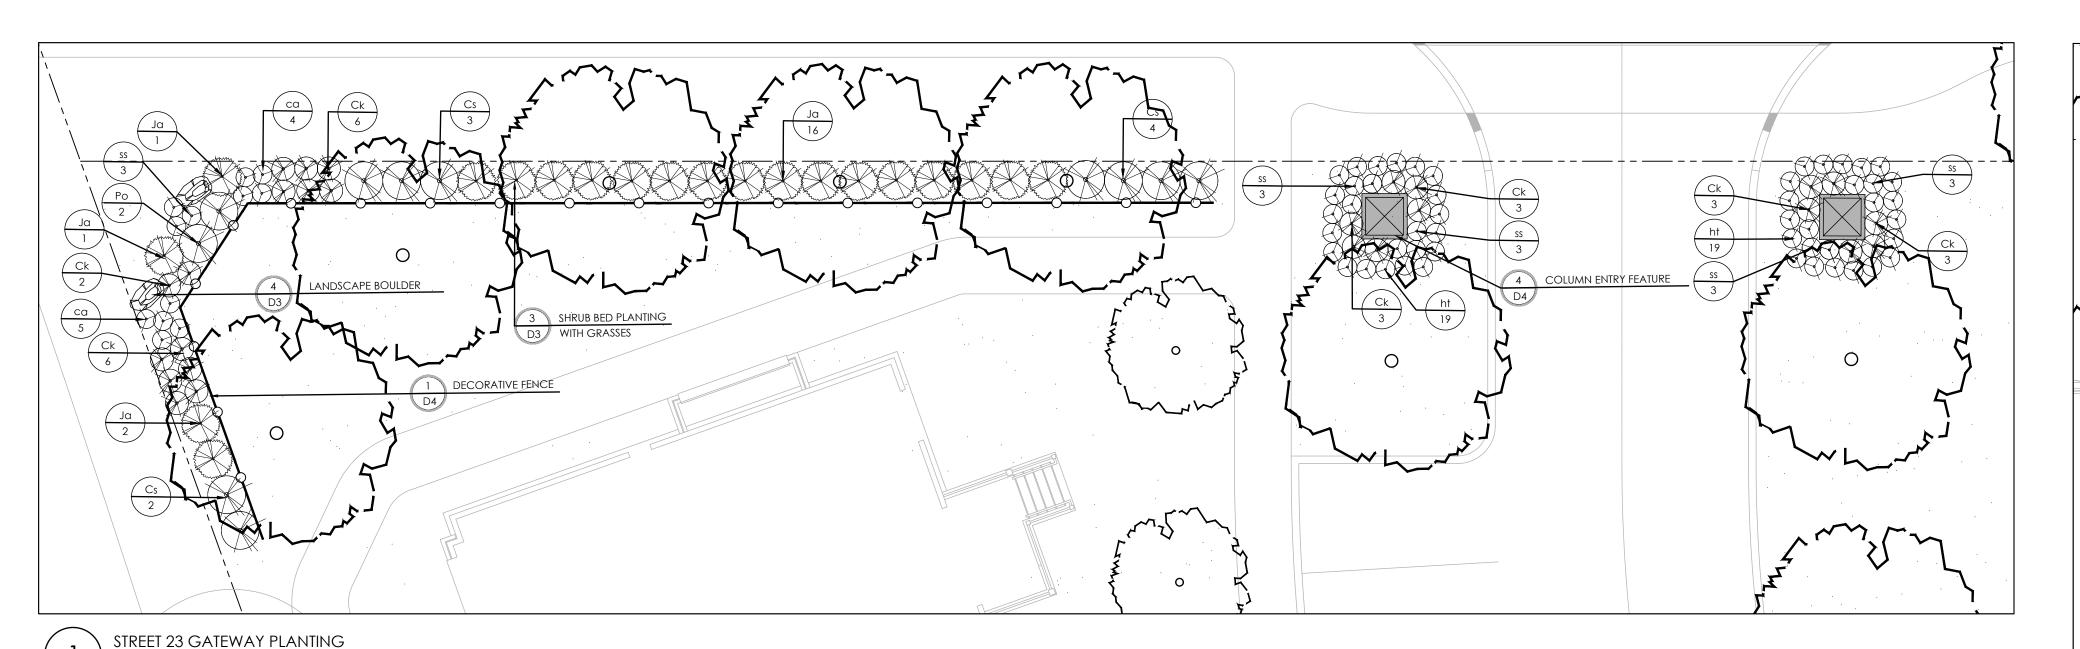

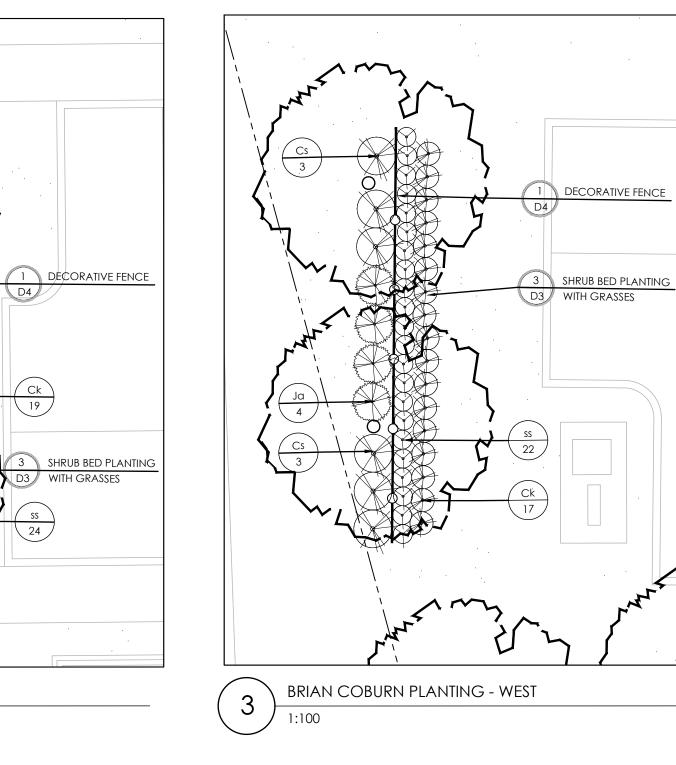

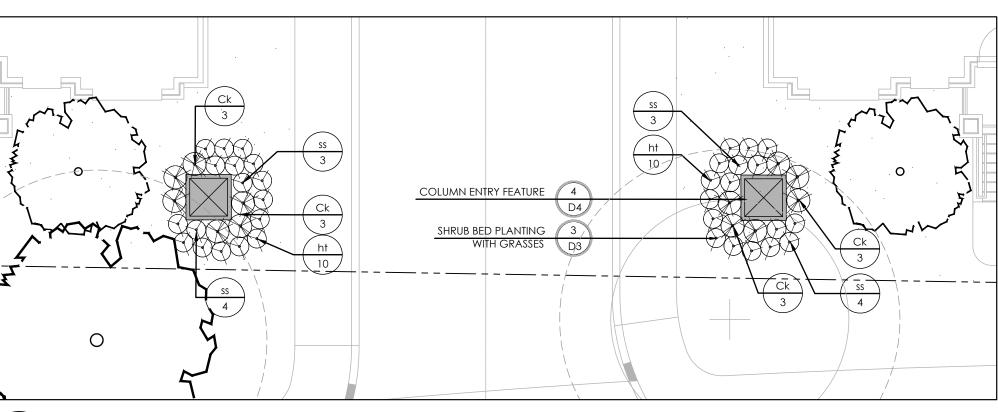

COULOIR ROAD PLANTING - WEST

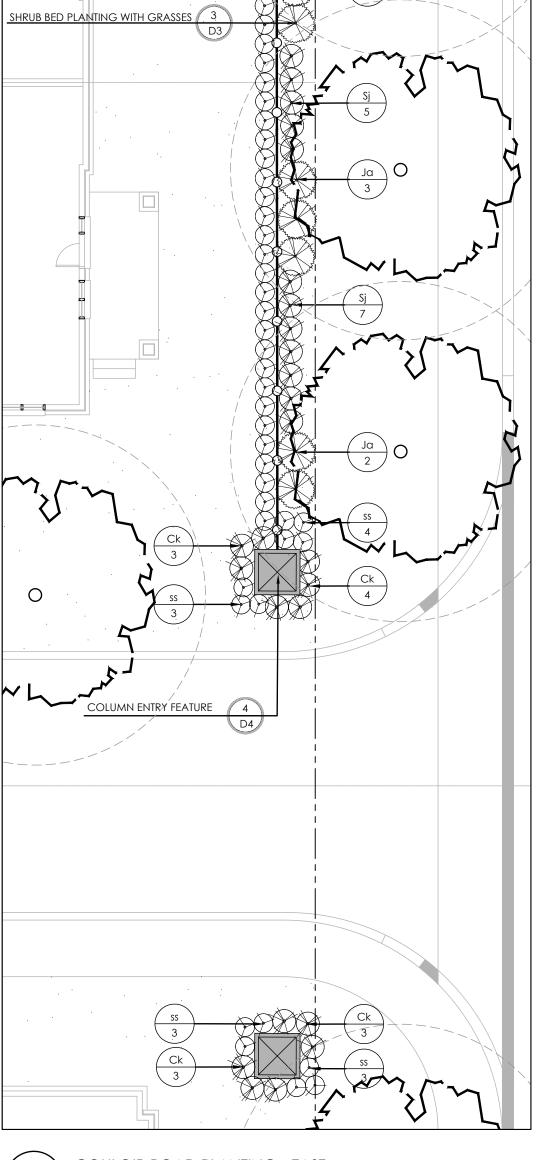

COULOIR ROAD PLANTING - EAST

PLANT LIST KEY QTY. BOTANICAL NAME COMMON NAME CAL/HT. ROOT DECIDUOUS SHRUBS Ck 101 CORNUS SERICEA 'KELSEYI' Cs 21 CORNUS SERICEA 'FARROW' KELSEYI DOGWOOD 3 GAL. PT.
ARCTIC FIRE DOGWOOD 3 GAL. PT.
DART'S GOLD NINEBARK 3 GAL. PT.
MAGIC CARPET SPIREA 3 GAL. PT. PHYSOCARPUS OPULIFOLIUS 'DART'S GOLD' SPIRAEA JAPONICA 'MAGIC CARPET' PRINCE OF WALES JUNIPER 3 GAL. PT. BRISTILECONE PINE SP. 3 GAL. PT. JUNIPERUS HORIZONTALIS 'PRINCE OF WALES' PINUS ARISTATA 'FORMAL FORM' GRASSES AND PERENNIALS

Ca 109 CALAMAGROSTIS X ACUTIFLORA 'KARL FOERSTER'

SS 97 SCHIZACHYRIUM SCOPARIUM KARL FOERSTER REED GRASS 2 GAL. PT. LITTLE BLUESTEM GRASS 2 GAL. PT. AUTUMN JOY STONECROP 1 GAL. PT. HYLOTELEPHIUM TELEPHIUM 'AUTUMN JOY'

FERN CASEY STREET GATEWAY PLANTING

BRIAN COBURN PLANTING - EAST

TRAILSEDGE RENTAL BLOCKS 193 & 194 SITE PLAN OTTAWA, ON

1285 WELLINGTON STREET WEST, OTTAWA, ON K1Y 3A8 CANADA T 613.237.2345 F 613.237.6423 NAKDESIGNSTRATEGIES.COM
Project

Contractor shall check all dimensions on the work and report any discrepancy to the Landscape Architect before proceeding. All drawings and specifications are the property of the Landscape Architect and must be returned at the completion of the work. This drawing is not to be used for construction until signed by the

FUTURE RANDKLUFT TERRACE

FERN CASEY STREE

Landscape Architect.

LEGEND

7 Re-Issued for 3rd Submission

4 Re-Issued for 1st Submission with Cross Sections Jan. 27/21

6 Issued for 3rd Submission 5 Issued for 2nd Submission

3 Issued for 1st Submission

2 Issued for Client Review

1 Issued for Client Review

No. Description

City Approval Stamp

Revision

—— — PROPERTY LINE

________ DECORATIVE FENCE ☑ GATEWAY COLUMN ENTRY FEATURE WALL

EXISTING STREET TREE

MEDIUM DECIDUOUS TREE (7.5m TO 14m HEIGHT)

SMALL TREE (<7.5m HEIGHT)

SHRUB (TREE FORM)

CONIFEROUS STREET TREE

ORNAMENTAL GRASSES LANDSCAPE BOULDER

DECIDUOUS/CONIFEROUS SHRUB

Sept. 16/21

July 16/21

Apr. 23/21

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Aug. 12/20

Date


ROW TREE

DETAILS

design strategies


Date AUG 2020 Scale 1:100 Drawn Is Checked jh Job No. 20-135

 PLA	NT LIST	-AMENITY AREA			
KEY	QTY.	BOTANICAL NAME	COMMON NAME	CAL/HT.	ROOT
				(mm)	
		UOUS TREES			
7.5m	TO 15m N	NATURE HEIGHT			
AR	3	ACER RUBRUM 'AUTUMN SPIRE'	AUTUMN SPIRE MAPLE	60	B&B
CS	4	CATALPA SPECIOSA	NORTHERN CATALPA	60	B&B
CO	2	CELTIS OCCIDENTALIS	HACKBERRY	60	B&B
CC	2	CORYLUS COLURNA	TURKISH HAZEL	60	B&B
GB	5_	GINKGO BILOBA 'AUTUMN GOLD'	AUTUMN GOLD GINKGO	60	B&B
	16				
5.501		DUD.			
	DUOUS SH				
Ac	6	AMELANCHIER CANADENSIS	SERVICEBERRY (TREE FORM)	125cm HT.	
Cs	<u>38</u>	CORNUS SERICEA 'FARROW'	ARCTIC FIRE DOGWOOD	3 GAL.	PT.
	38				
0546	0.50				
GRAS		CALAAAA CDOCTIC V A CHTIFI ODA IVADI FOFDSTEDI	KADI FOEDSTED DEED ODASS	0.041	DT
ca	19	CALAMAGROSTIS X ACUTIFLORA 'KARL FOERSTER'	KARL FOERSTER REED GRASS	Z GAL.	PT.
SZ	$\frac{41}{12}$	SCHIZACHYRIUM SCOPARIUM	LITTLE BLUESTEM		2 GAL.
1	60				

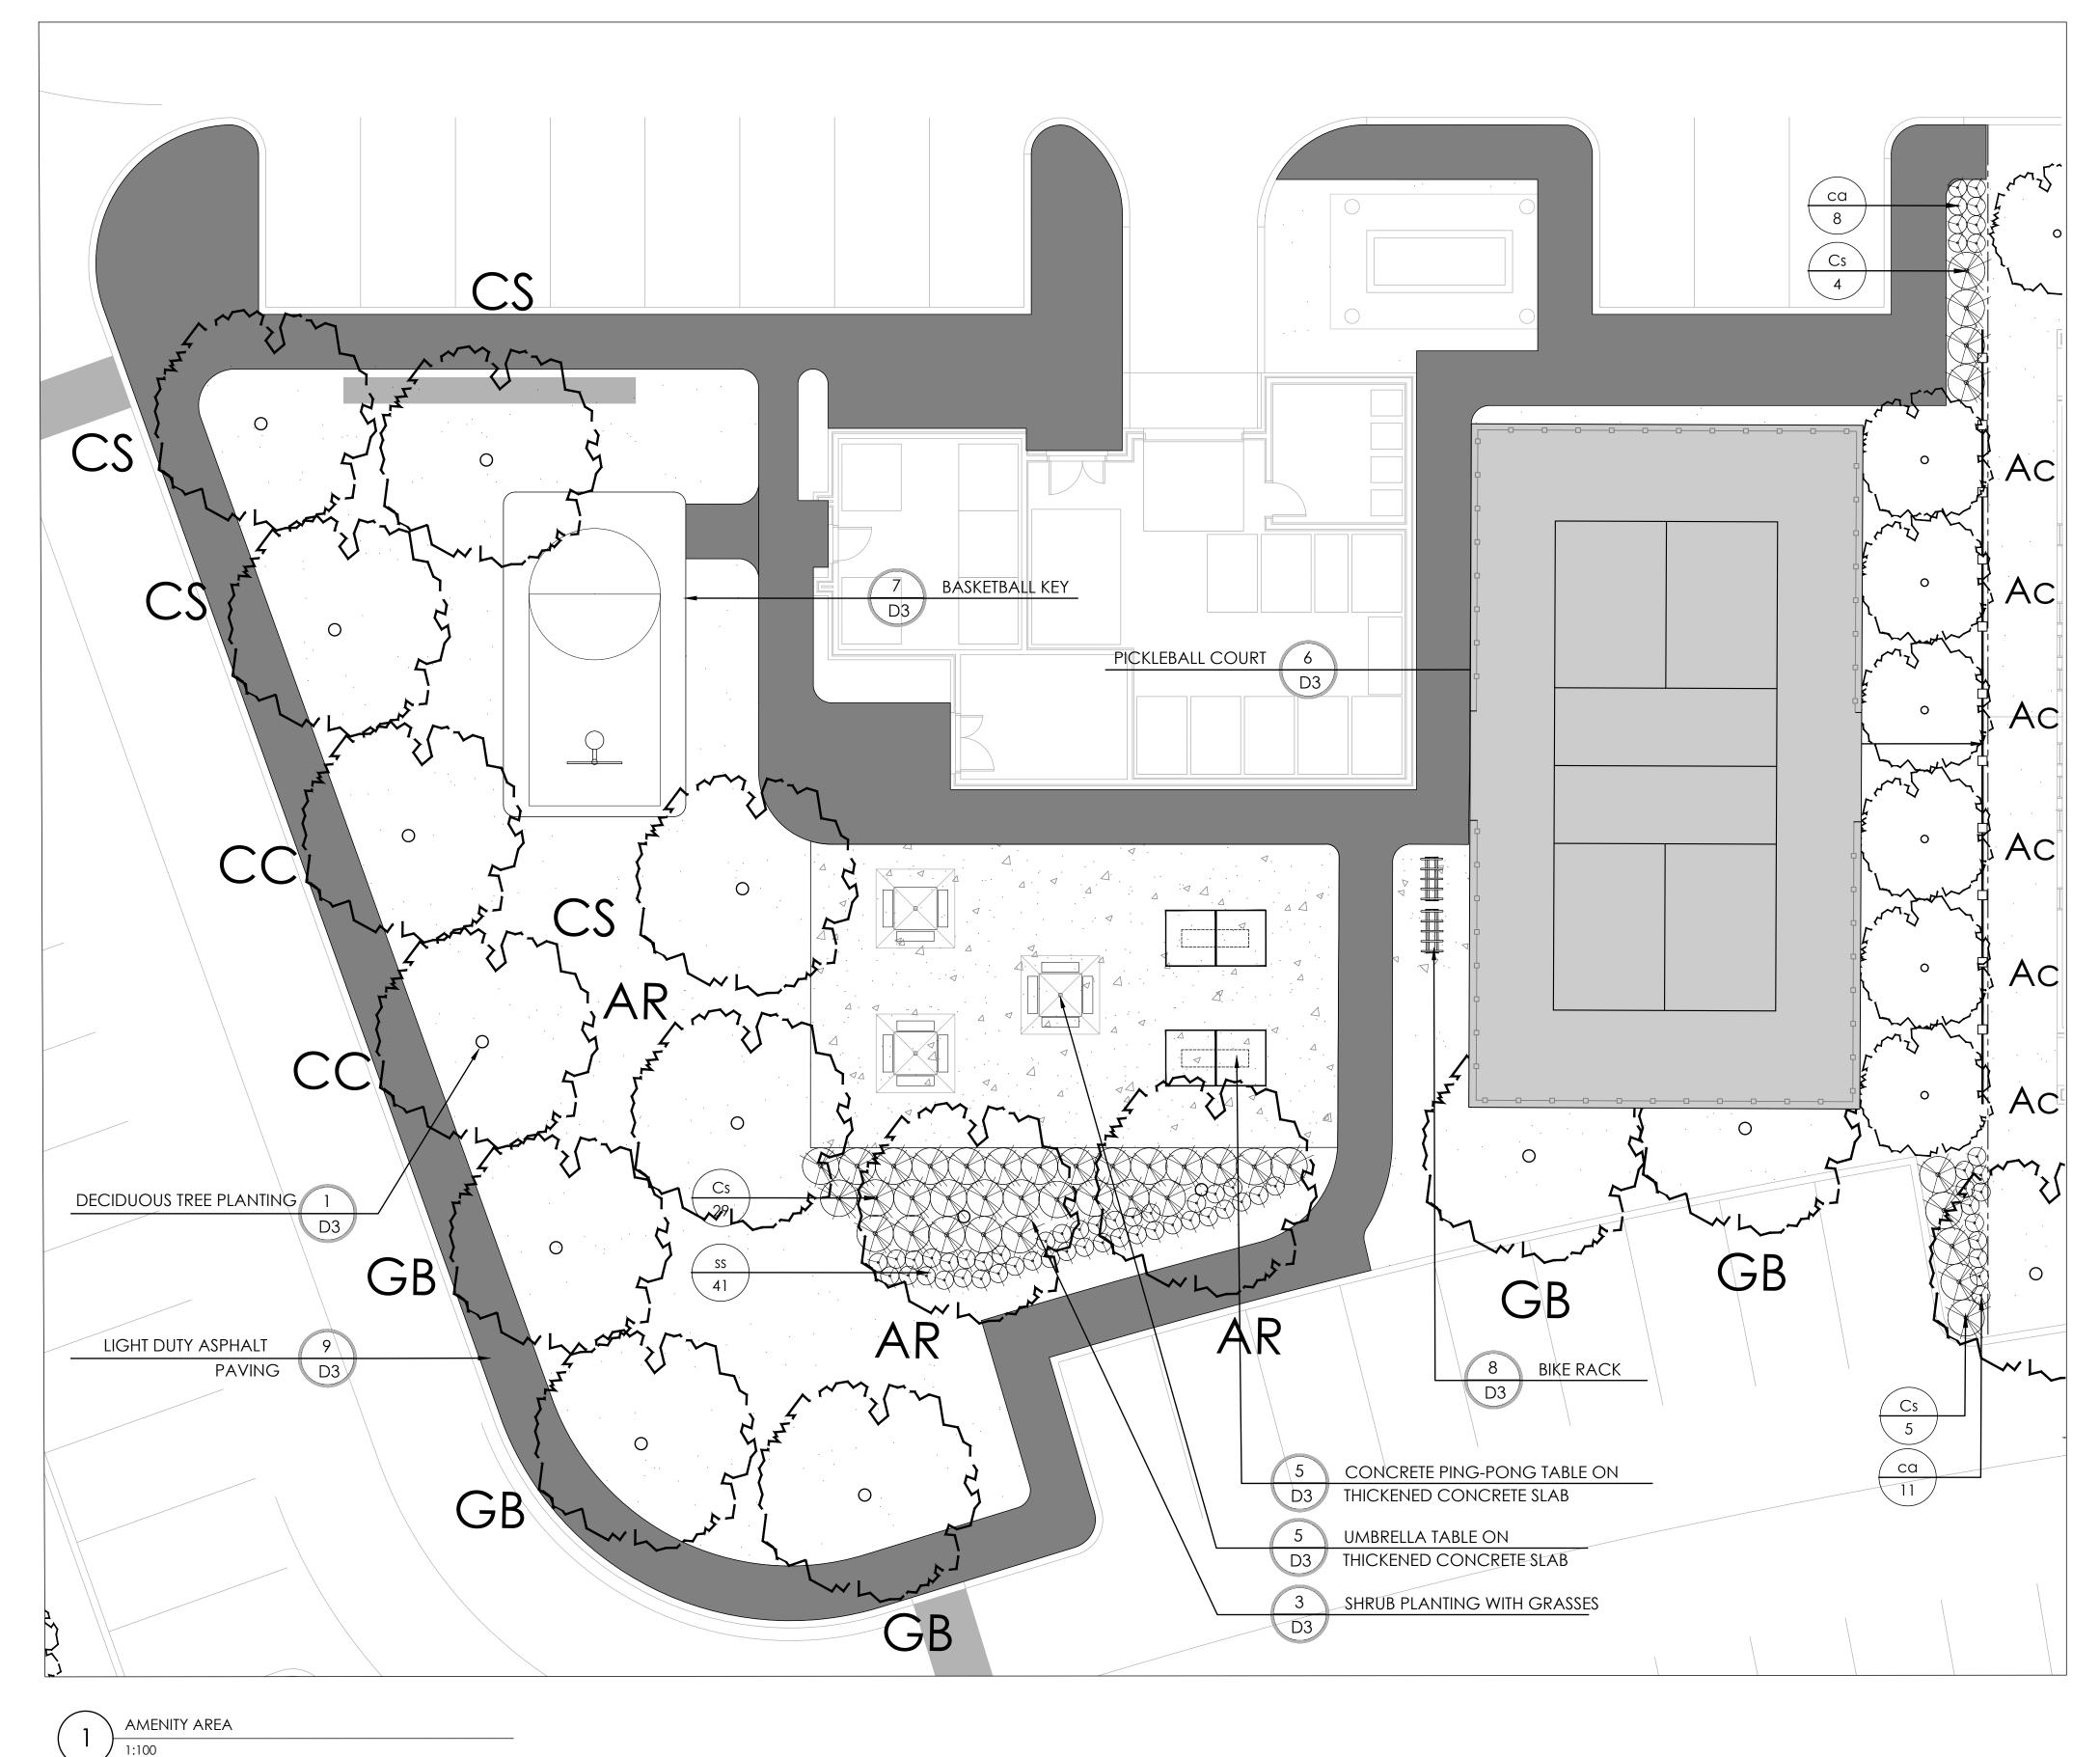

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FUTURE RANDKLUFT TERRACE

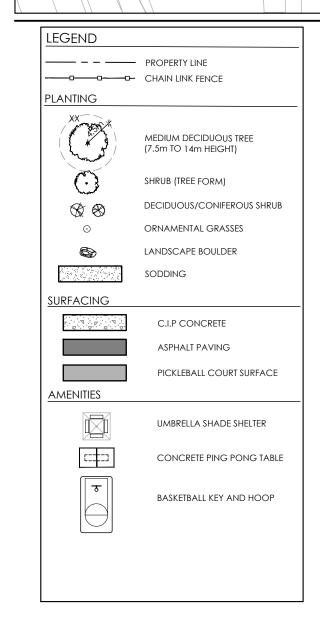

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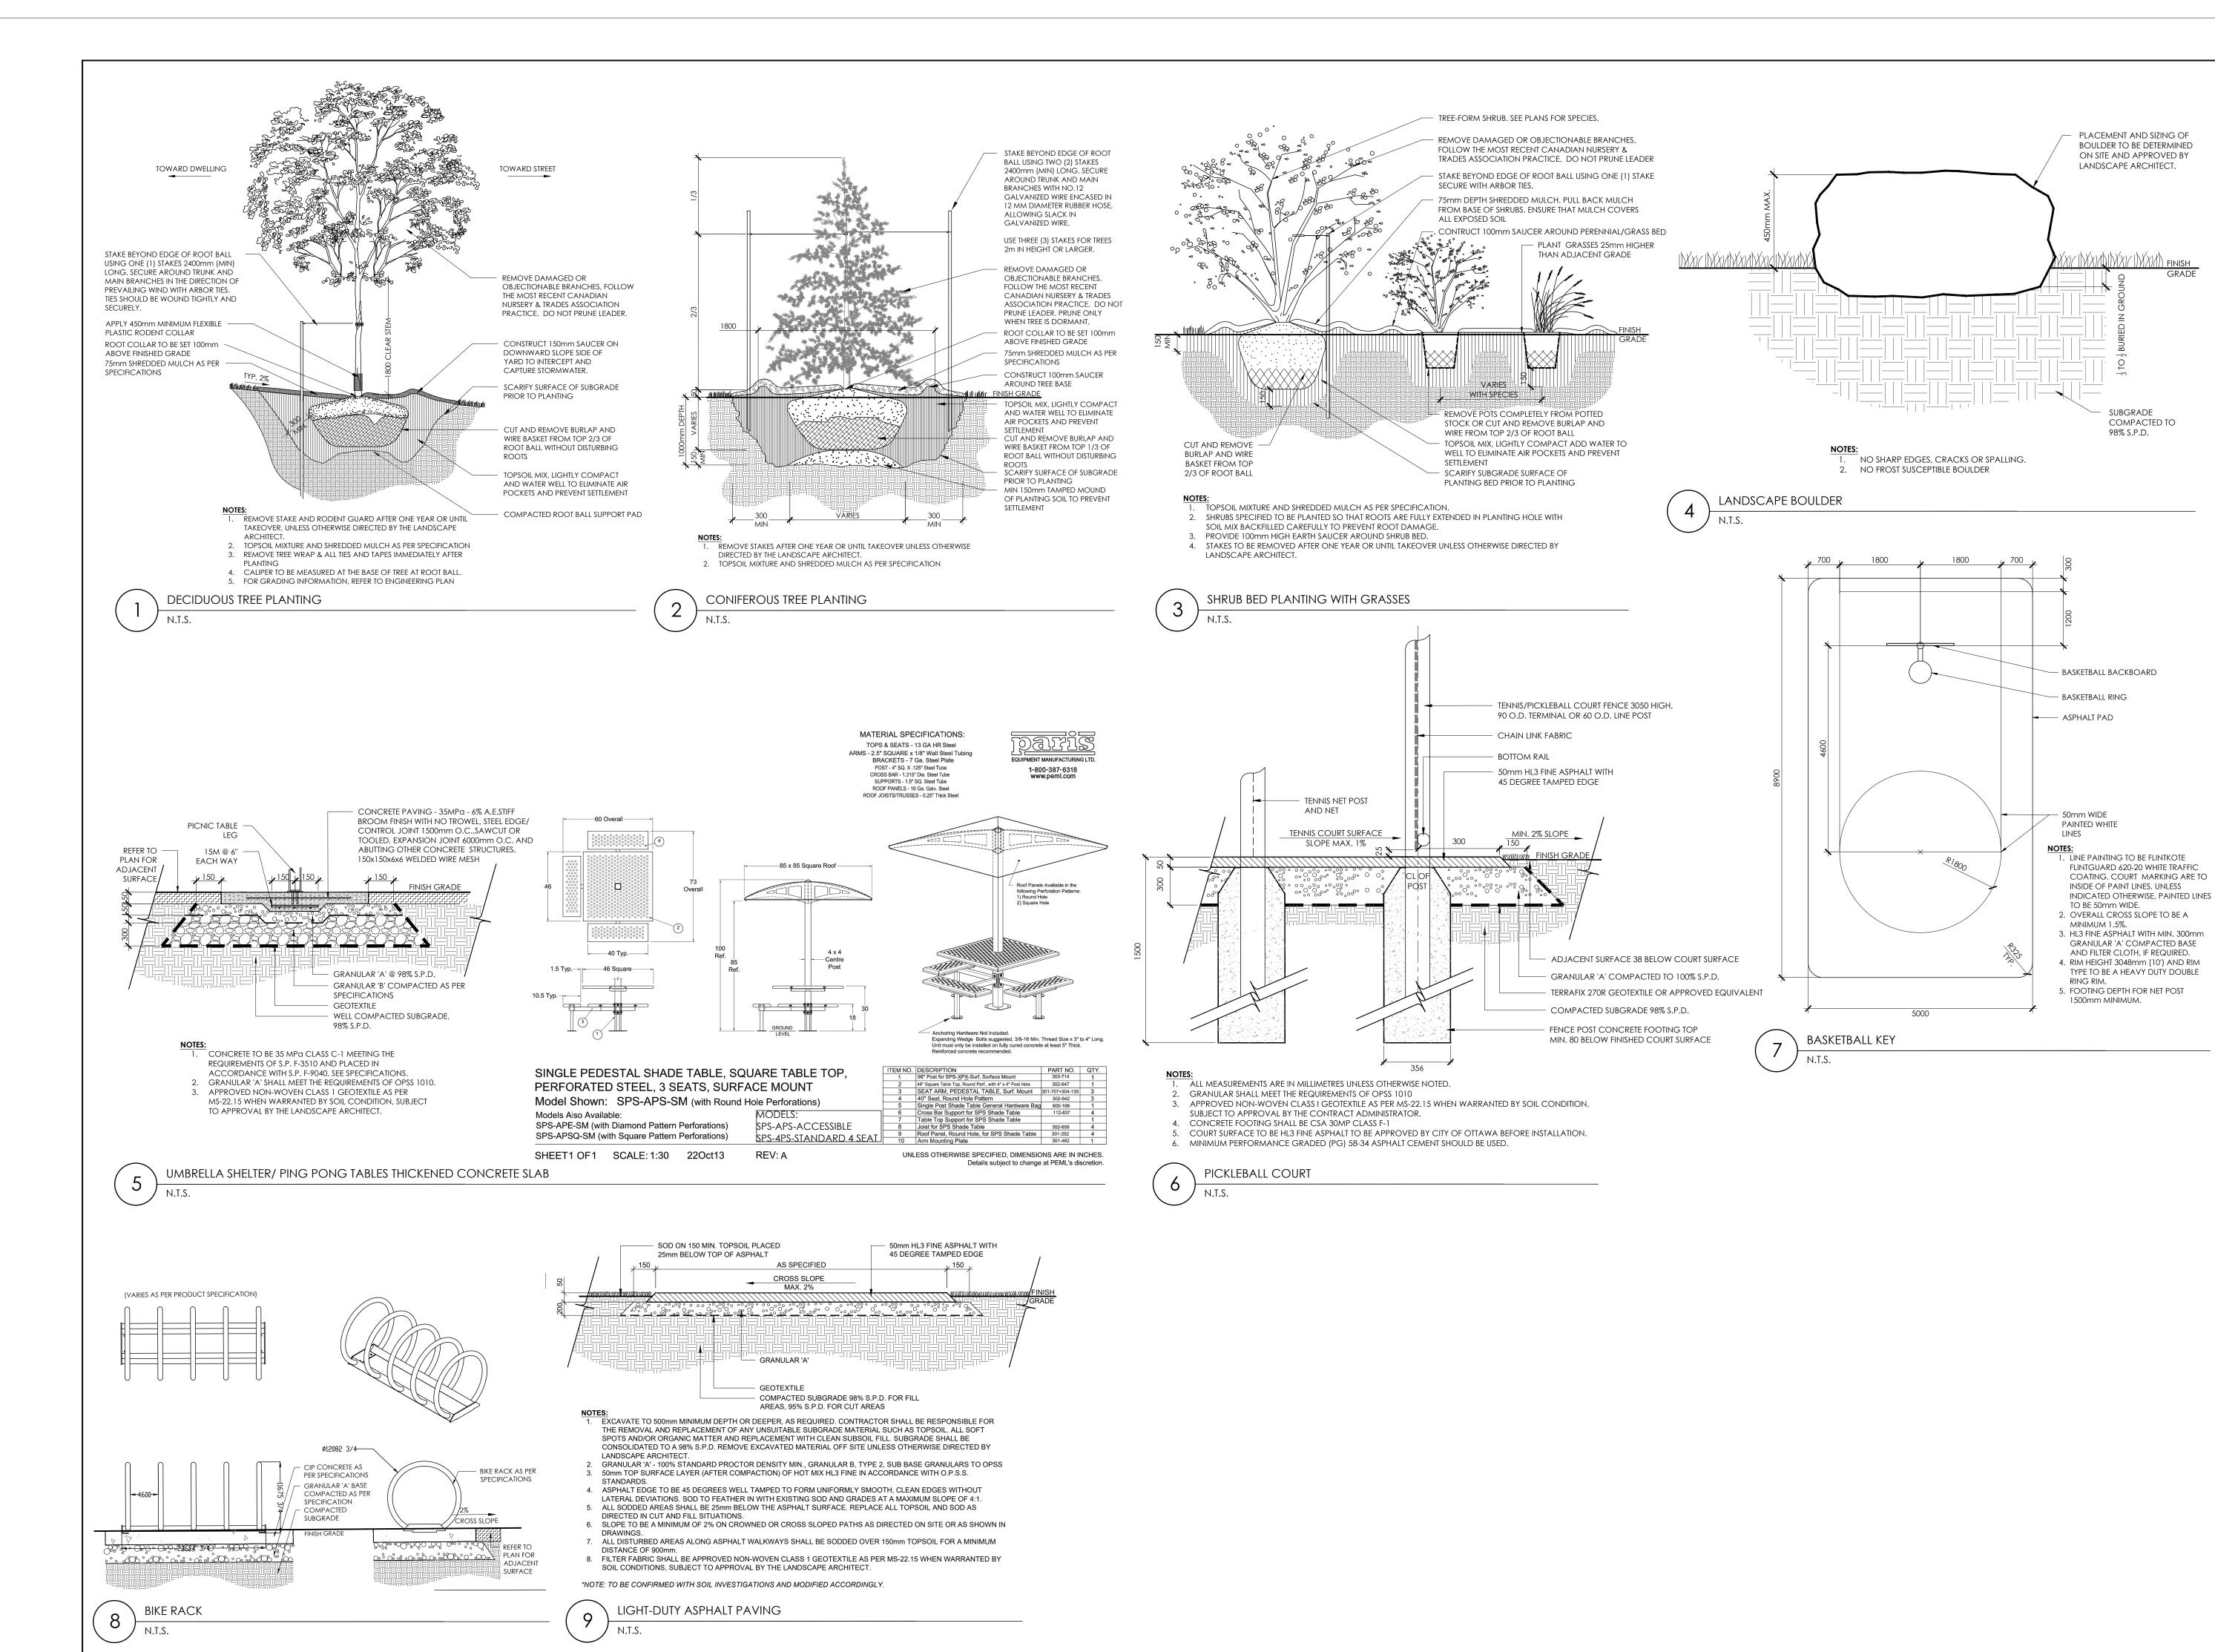


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TRAILSEDGE RENTAL BLOCKS 193 & 194 SITE PLAN OTTAWA, ON

DETAILS

Date AUG 2020 Scale 1:100 Drawn Is Checked jh Job No. 20-135



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5	Issued for 2nd Submission	Apr. 23/21
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3	Issued for 1st Submission	Dec. 14/20
2	Issued for Client Review	Nov. 20/20
1	Issued for Client Review	Aug. 12/20
No.	Description	Date

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Revision



NAK design strategies

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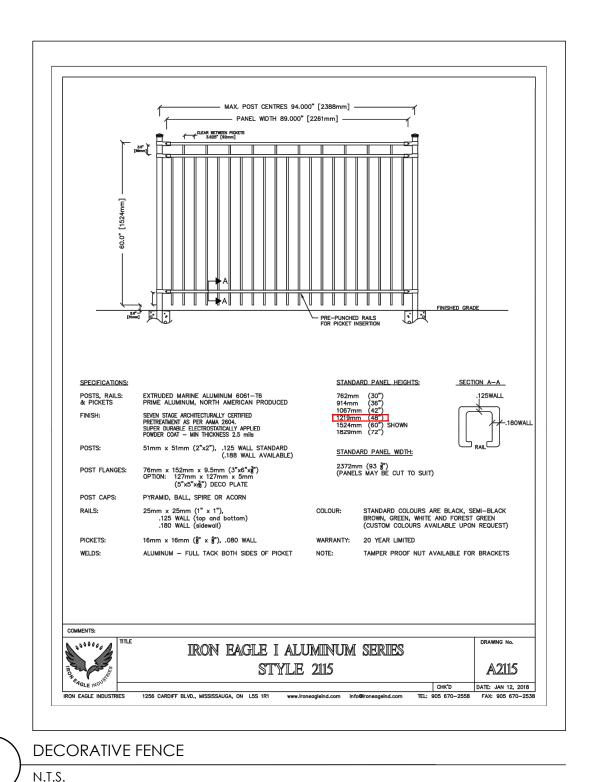
TRAILSEDGE RENTAL BLOCKS


193 & 194 SITE PLAN
OTTAWA, ON

DETAILS

Date AUG 2020
Scale N.T.S.
Drawn Is
Checked jh
Job No. 20-135

D-07-1



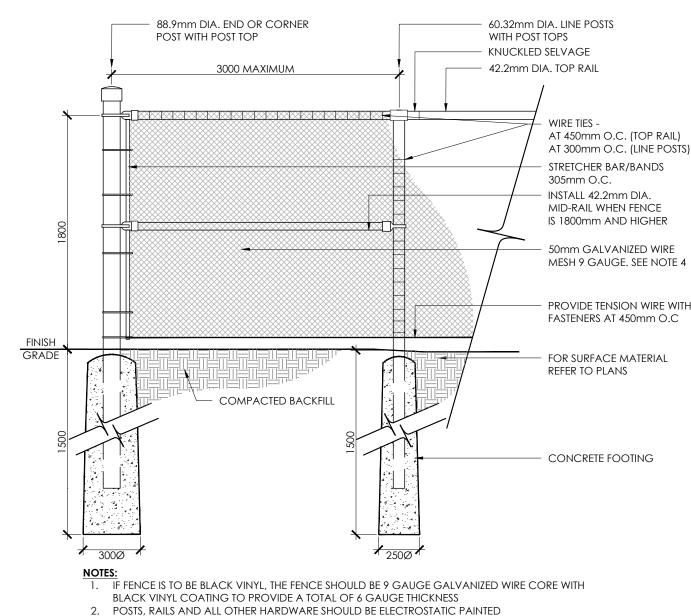

4. FENCING ADJACENT TO PRIVATE RESIDENTIAL PROPERTY SHALL MEET THE POOL ENCLOSURE BY-LAW, NAMELY THE MESH SHALL BE 38mm AND THE GAUGE OF VINYL COATED 9 GAUGE GALVANIZED WIRE

AT 300mm O.C. (LINE POSTS) MESH 9 GAUGE. SEE NOTE 4 PROVIDE TENSION WIRE WITH

1.8m CHAINLINK FENCE

SHALL BE 6. COLOUR AS SPECIFIED.


CONCRETE FOOTING SHALL BE CSA 30MPa CLASS F-1


1000

HORIZONTAL JOINTS - GROUT W/ ELASTOMERIC

ONLY VINC IN DEED

559 CAULKING $\frac{1}{2}$ " DEEP 4" PRECAST CAP w/ DRIP — MEMBRANE FROM O/S BLOCK TO O/S BLOCK — STAINLESS STEEL DOWELS -1" AIR SPACE (MIN.) — MASONRY TIES AS REQUIRED -8" CONCRETE BLOCK c/w BLOCK LOCK -AND VERTICAL RE-BAR STONE VENEER $3\frac{1}{2}$ FRONT FACE THRU-WALL DAMPROOFING FINISH GRADE

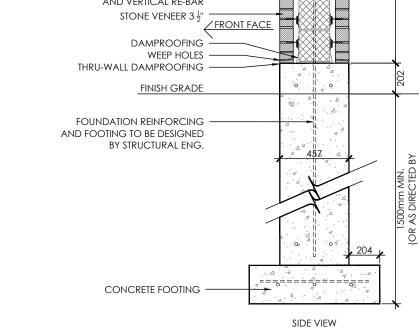

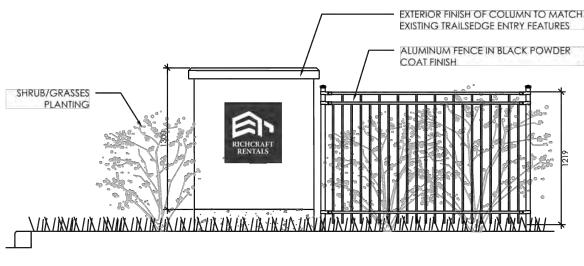

ELEVATION

COLUMN ENTRY FEATURE

FRONT FACE VIEW

4" PRECAST CAP w/ DRIP

FRONT FACE -

PARGING -

STONE VENEER 3 $\frac{1}{2}$ " —

FINISH GRADE

FOUNDATION -REINFORCING AND FOOTING TO BE DESIGNED BY STRUCTURAL ENG.

CONCRETE FOOTING -


EXTERIOR FINISH OF COLUMN TO MATCH EXISTING TRAILSEDGE ENTRY FEATURES

CRITICAL ROOT ZONE DBH x 10cm — 38x38 T-BAR POST AT 1500 O.C. MAX. - 1200 PAIGE WIRE FARM FENCE SECURED WITH WIRE TWIST TIES --- UNDISTURBED SOIL

- NOTES:

 1. THE AREA WITHIN THE CRITICAL ROOT ZONE OF ALL EXISTING TREES SHALL BE PROPERLY PROTECTED WITH TEMPORARY FENCING AS PER THE APPROVED LANDSCAPE PLAN. 2. THE SURVEY SHALL SHOW EXISTING ELEVATION AT BASE OF ALL TREES TO BE PRESERVED
- AS SHOWN BY "+". 3. THE AREA WITHIN THE PROTECTED FENCING SHALL REMAIN UNDISTURBED AND SHALL
- NOT BE USED FOR THE STORAGE OF BUILDING MATERIALS OR EQUIPMENT. REMOVE ALL DEBRIS.
- 4. PRUNE BRANCHES TO REMOVE DAMAGED OR OBJECTIONABLE BRANCHES. DO NOT PRUNE LEADERS. 5. TREE PROTECTION SHALL REMAIN UNTIL SUBSTANTIAL PERFORMANCE OF THE PROJECT.
- 6. IF CUTTING OF ROOTS OR CHANGING OF GRADES AROUND EXISTING TREES IS CALLED FOR, FOLLOW APPROPRIATE DETAILS AS DIRECTED BY LANDSCAPE ARCHITECT.
- 7. IF TREES ARE BEING AFFECTED BY CONSTRUCTION, A WATER AND FERTILIZING PROGRAM WILL BE REQUIRED TO THE SATISFACTION OF THE LANDSCAPE ARCHITECT.

TREE PROTECTION FENCE

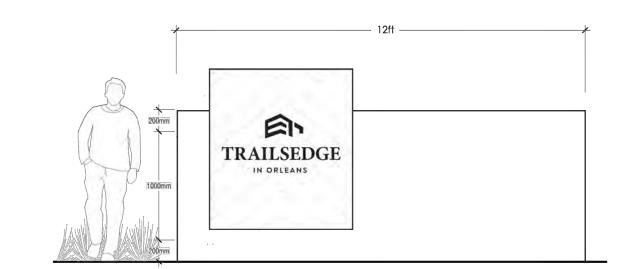



STONE COLUMN

GATEWAY ENTRY FEATURE N.T.S.

Contractor shall check all dimensions on the work and report any discrepancy to the Landscape Architect before proceeding. All drawings and specifications are the property of the Landscape Architect and must be returned at the completion of the work. This drawing is not to be used for construction until signed by the Landscape Architect.

2	Issued for Client Review	Nov. 20/20
4 3	Issued for 1st Submission	Jan. 27/21 Dec. 14/20
5	Issued for 2nd Submission Re-Issued for 1st Submission with Cross Sections	Apr. 23/21
6	Issued for 3rd Submission	July 16/21
7	Re-Issued for 3rd Submission	Sept. 16/2

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TRAILSEDGE RENTAL BLOCKS 193 & 194 SITE PLAN OTTAWA, ON


DETAILS

D4

Date AUG 2020 Scale N.T.S. Drawn Is Checked jh Job No. 20-135



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7	Re-Issued for 3rd Submission	Sept. 16/21
6	Issued for 3rd Submission	July 16/21
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Project

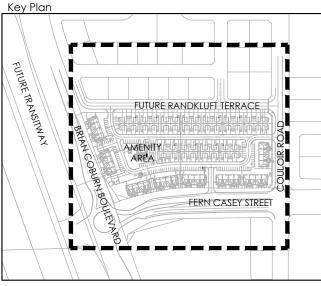TRAILSEDGE RENTAL BLOCKS

193 & 194 SITE PLAN OTTAWA, ON

CROSS SECTIONS

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