WALL TAG	WALL TYPE & LOCATION	WALL COMPOSITION	FIRE RATING	OBC WALL No
WT1>	EXTERIOR – FOUNDATION	-TUFF-N-DRI WATERPROOF LIQUID APPLIED MEMBRANE -8"/10" FOUNDATION WALL -2-15M REINFORCING RODS CONT. @ TOP		
WT3>	TYP. EXTERIOR LOAD BEARING WASTE MANAGEMENT RM EXTERIOR WALLS	-BRICK + 1" AIR SPACE OR HARDIBOARD CLADDING -7/16" OSB SHEATHING -TYYEK AIR BARRIER -2x6's @ 24"o.c2 LAYERS 5/8" TYPE "X" GYPSUM BOARD	*1 HOUR	BASED ON W1a
WT4	TYP. EXTERIOR LOAD BEARING WASTE MANAGEMENT RM EXTERIOR WALLS	-BRICK + 1" AIR SPACE OR HARDIBOARD CLADDING OR ALUM SIDING -7/16" OSB SHEATHING -TYVEK AIR BARRIER -2x4's @ 16"o.c2 LAYERS 5/8" TYPE "X" GYPSUM BOARD	*1 HOUR	BASED ON W1a

LUMBER

- LUMBER GRADE: SPF No. 2 OR BETTER
- ALL BUILT-UP WOOD POSTS CONTAIN AT LEAST THREE PLIES AND MATCH THE WALL THICKNESS
- ALL EXTERIOR WOOD FRAME TO BE PRESSURE TREATED UNLESS NOTED OTHERWISE

SOIL

• MINIMUM SAFE SOIL BEARING PRESSURE = 1600 psf

FLOOR ASSEMBLY SCHEDULE

WASTE MANAGEMENT RM

FLOOR TAG FLOOR TYPE & LOCATION FLOOR COMPOSITION



- -4" CONCRETE SLAB
- -5-8% AIR ENTRAINMENT & FIBERSTRAND 200 -6 MIL POLY VAPOUR BARRIER
- -3" RIGID INSULATION (R15)
- -6" CRUSHED STONE


STEEL TAKE-OFF

B1- W10x22 @ 17'6L

P1/P2- ADJ. 2.5"x2.5"x.125 HSS POSTS @ 101"L W/ EMBEDDED ANCHOR PL

GENERAL STEEL NOTES:

1. PROVIDE MINIMUM 4"x6"x1/2" CAP AND BASE PLATES TO ALL HSS

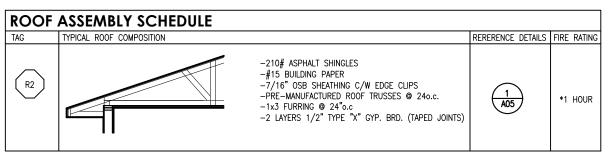

2.3.4. METHOD OF CALCULATION

*USING SECTION 2.3.4 OF THE SUPPLEMENTARY GUIDELINES OF THE OBC

WOOD ROOF TRUSS ASSEMBLIES AT 24"o.c. 5 MINS-(2.3.4.c.)

2x6 STUDS AT 24"o.c.- 15 MINS-(2.3.4.c.) FIBERGLASS INSULATION - 5 MINS-(2.3.4.d) 5/8" TYPE X GYP BRD- 40 MINS-(2.3.4.a)

2x6 STUDS AT 16"o.c. 20 MINS-(2.3.4.c.)

LILY XU, MCIP, RPP MANAGER, DEVELOPMENT REVIEW SOUTH PLANNING, INFRASTRUCTURE & ECONOMIC **DEVELOPMENT DEPARTMENT, CITY OF OTTAWA**

REVIEWED:

GENERAL NOTES:

TO THE ARCHITECT PROMPLY.

RECENT AMENDMENTS.

COPYRIGHT:

ISSUE RECORD:

DISCRIPTION

ARE TO BE READ TOGETHER.

. DO NOT SCALE DRAWINGS, ONLY FIGURED DIMENSIONS ARE TO BE USED. WHERE DOUBT EXISTS, FILE REQUEST

. It is the responsibility of the general contractor TO VERIFY DIMENSIONS ON SITE, REPORT DISCREPANCES

3. GENERAL CONTRACTOR TO TAKE INTO ACCOUNT CONSTRUCTION TOLERANCE & COORDINATE THE WORK OF

DIFFERENT TRADES TO COMPLY WITH DESIGN INTENT.

SPECIFICATIONS ARE TO COMPLY WITH THE CURRENT EDITION OF THE ONTARIO BUILDING CODE 2012 OR NATIONAL BUILDING CODE 2015, INCLUDING MOST

DRAWINGS & SPECIFICATIONS ARE COMPLIMENTARY AND

. THIS DRAWING IS AN INSTRUMENT OF SERVICE AND IS PROTECTED BY COPYRIGHT AND IS THE SOLE PROPERTY

INCLUDING ELECTRONIC COPIES, MAY ONLY BE USED

FOR THE PURPOSE INTENDED, FOR THE SINGLE PROJECT

OFFERED FOR SALE OR TRANSFER WITHOUT THE EXPRESS

DATE

OF JIM BELL ARCHITCTURAL DESIGN INC. COPIES,

FOR WHICH THEY ARE ISSUED AND MAY NOT BE

WRITTEN PERMISSION OF THE ARCHITECT.

ALL WORK DISCRIBED IN THESE DRAWINGS AND

FOR INTERPRETATION AND REQUEST CLARITY.

LOCALE FLATS **PHASE 2 - WASTE** MANAGEMENT ROOM

APPROVED:

URBANDALE CONSTRUCTION LTD

2193 ARCH STREET, OTTAWA TEL: 613-731-6331

GENERAL NOTES WALL & FLR ASSEMBLIES

SCALE: 3/16" = 1'-0"

DATE: OCT 10,2020

OF 7


DWG No: **A01**

JOB NO.

ARCHITECTURAL

APPROVED

By Lily Xu at 7:51 pm, Aug 30, 2021

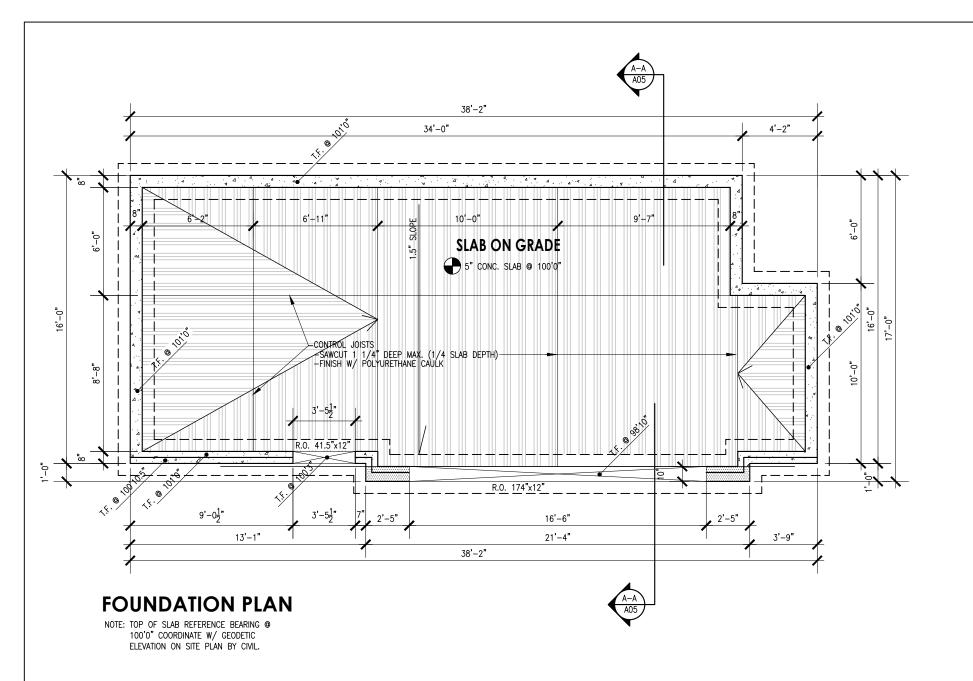

GENERAL NOTES:

- . DO NOT SCALE DRAWINGS, ONLY FIGURED DIMENSIONS ARE TO BE USED. WHERE DOUBT EXISTS, FILE REQUEST FOR INTERPRETATION AND REQUEST CLARITY.
- . It is the responsibility of the general contractor TO VERIFY DIMENSIONS ON SITE, REPORT DISCREPANCES TO THE ARCHITECT PROMPLY.
- 3. GENERAL CONTRACTOR TO TAKE INTO ACCOUNT CONSTRUCTION TOLERANCE & COORDINATE THE WORK OF DIFFERENT TRADES TO COMPLY WITH DESIGN INTENT.
- ALL WORK DISCRIBED IN THESE DRAWINGS AND SPECIFICATIONS ARE TO COMPLY WITH THE CURRENT EDITION OF THE ONTARIO BUILDING CODE 2012 OR NATIONAL BUILDING CODE 2015, INCLUDING MOST RECENT AMENDMENTS.
- . Drawings & specifications are complimentary and are to be read together.

COPYRIGHT:

. This drawing is an instrument of service and is PROTECTED BY COPYRIGHT AND IS THE SOLE PROPERTY OF JIM BELL ARCHITCTURAL DESIGN INC. COPIES, INCLUDING ELECTRONIC COPIES, MAY ONLY BE USED FOR THE PURPOSE INTENDED, FOR THE SINGLE PROJECT FOR WHICH THEY ARE ISSUED AND MAY NOT BE OFFERED FOR SALE OR TRANSFER WITHOUT THE EXPRESS WRITTEN PERMISSION OF THE ARCHITECT.

ISSUE RECORD:

NO.	DISCRIPTION	DATE

URBANDALE CONSTRUCTION LTD 2193 ARCH STREET, OTTAWA TEL: 613-731-6331

APPROVED

By Lily Xu at 7:51 pm, Aug 30, 2021

LEGEND: 2 7/8" (R12.1) RIGID GLASS FIBER BOARD INSULATION IRREGULAR FOUNDATION CONCRETE WALL (DIM. ARE SPECIFIED) 10" FOUNDATION CONCRETE WALL 8" TYP. FOUNDATION CONCRETE

CONCRETE S	PECIFICATIONS	
TYPE	DESCRIPTION	
FOUNDATION WALLS:	• 8"/10" CONCRETE WALLS (18 MPA) W/ • 2-15M REINFORCING RODS ⊕ TOP (UNLESS OTHERWISE NOTED) • ½" ANCHOR BOLTS MAX. 4'-0"O.C. W/ 12" MIN. EMB.	
FOUNDATION FOOTINGS	• 24"x8" CONTINUOUS CONCRETE FOOTINGS (17 MPA) -(UNLESS OTHERWISE NOTED)	
WASTE MANAGEMENT RM	• 4" CONCRETE SLAB (32 MPA) W/ • 5-8% AIR ENTRAINMENT & FIBERSTRAND 200	
ELEC. RM	• 4" CONCRETE SLAB (20 MPA) W/ 6 MIL POLY VAPOUR BARRIER	

FOUNDATION PLAN NOTES:

- 1. TYPICAL FOUNDATION WALL HEIGHT 76".
- 2. TYPICAL FOUNDATION BRICK CHECK HEIGHT 1.5".
- 3. REFER TO SECTIONS AND ELEVATIONS FOR ELEVATIONS OF WALLS
- 4. AT ALL INTERIOR HEATED SLABS PROVIDE MINIMUM OF 24" POLYSTYRENE INSULATION (R10) TO U/S OF SLAB.
- 5. PROVIDE 1/2" DIAM. ANCHOR BOLTS TO A MAXIMUM OF 8'-0"o.c. PER SILL PLATE.

LILY XU, MCIP, RPP MANAGER, DEVELOPMENT REVIEW SOUTH PLANNING, INFRASTRUCTURE & ECONOMIC DEVELOPMENT DEPARTMENT, CITY OF OTTAWA REVIEWED:

JOB NO. APPROVED:


PROJECT: LOCALE FLATS **PHASE 2 - WASTE MANAGEMENT ROOM**


FOUNDATION PLAN

3/16" = 1'-0"

DWG No: **A02** DATE: OCT 10,2020


ARCHITECTURAL

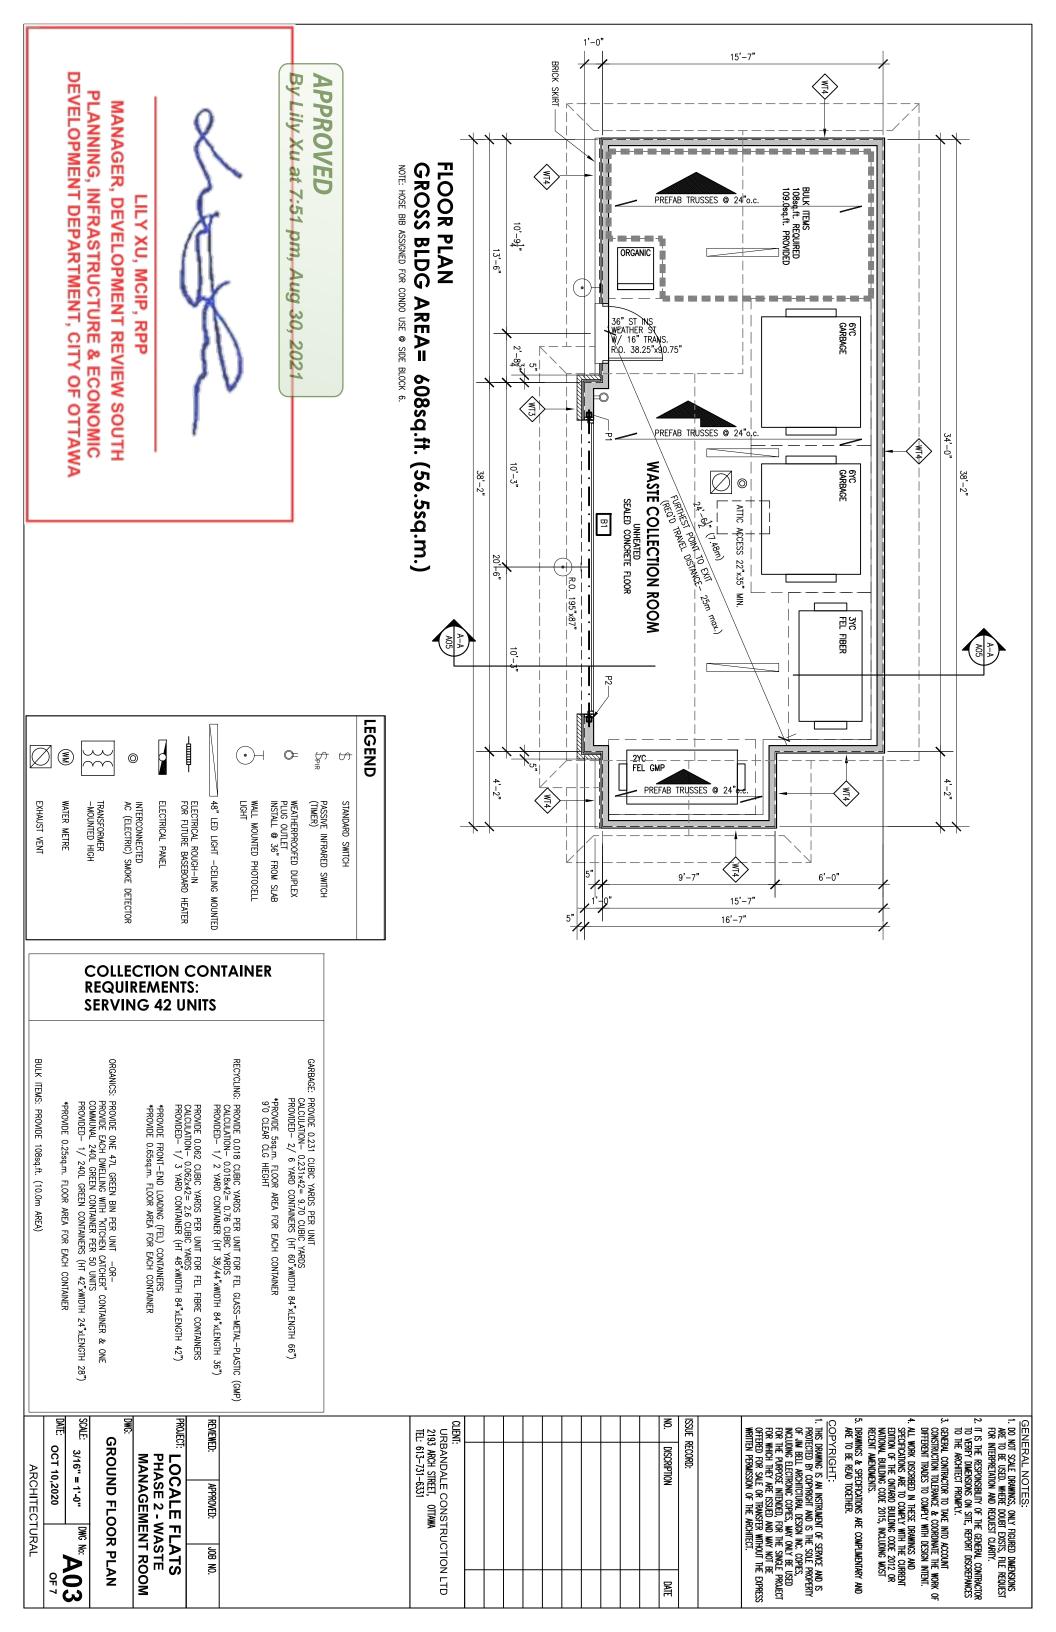

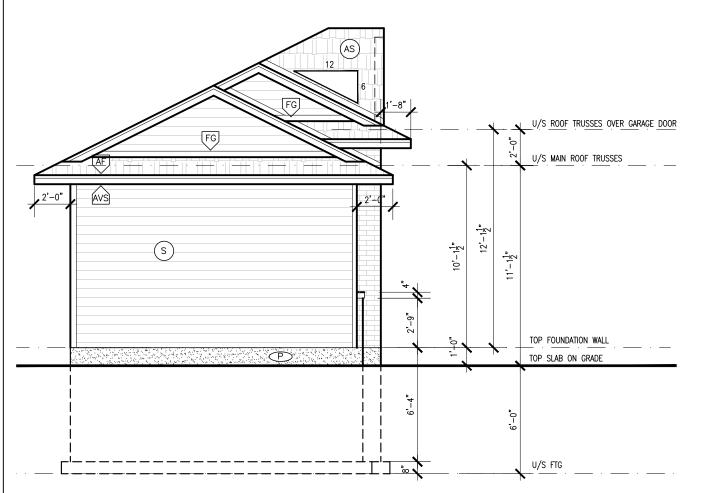

LEFT SIDE ELEVATION

TOTAL EXPOSED BLDG FACE (TEBF)= 191.91 sq.ft. (17.83 sq.m.) TOTAL GLAZED OPENING AREA= 0=0%LIMITING DISTANCE 197'-2" (60.10m)

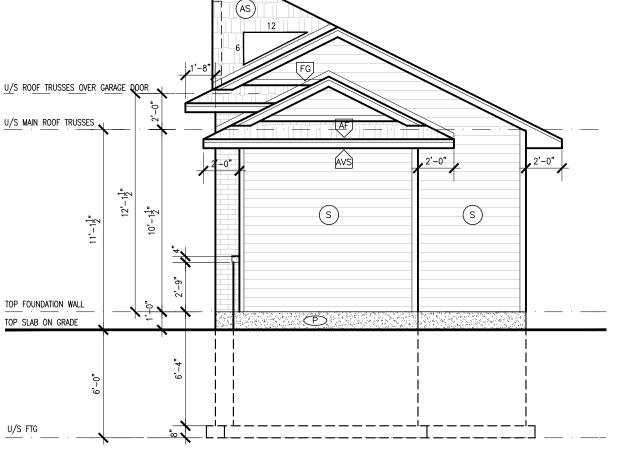

RIGHT SIDE ELEVATION

TOTAL EXPOSED BLDG FACE (TEBF)= 191.91 sq.ft. (17.83 sq.m.) TOTAL GLAZED OPENING AREA= 0 = 0% LIMITING DISTANCE 119'-5" (36.4m)

LILY XU, MCIP, RPP MANAGER, DEVELOPMENT REVIEW SOUTH **PLANNING, INFRASTRUCTURE & ECONOMIC DEVELOPMENT DEPARTMENT, CITY OF OTTAWA**

APPROVED By Lily Xu at 7:51 pm, Aug 30, 2021

9.19.1 VENT REQUIREDMENTS

MATERIAL SPEC .:

ALUM. SOFFIT = 0.02833 sq.ft.

ROOF VENT = 1.0 sq.ft

	TEITI 110 Oquit	
≒	UNINSULATED CEILING	590.26 sq.ft.
Ý	- 1/300	1.97 sq.ft.
MANAGEMENT	- 1/300 X 25%	0.49 UNITS REQUIRED
Ř		
₹	SOFFIT	235.00 sq.ft.
밀	- UNOBSTRUCTED VENT AREA	6.7 sq.ft.
WASTE		
>	RFQ'D # OF ROOF VENT	1 UNIT

ATTIC ACCESS PROVIDED AS PER OBC 9.19.2.1

- ROOF AREA EXCEEDS 108sq.ft. (10m.sq.)
 ROOF SPACE EXCEEDS 3'3" (1m) IN WIDTH OR LENGTH
 ROOF SPACE EXCEEDS 24" (600mm)

BRICK FACADE

- •WEEP HOLES @ WALL @ BASE & OVER ALL
- OPENING TO BE SPACED 31" MAX.
 •FLASHING @ TOP & BOTTOM OF OPENINGS & TOP OF BRICK SKIRT

ELEVATION LEGEND

- (AS) ASPHALT SHINGLES
- AF ALUM. FASCIA
- AVS VENT. ALUM. SOFFIT
- RV ROOF VENT
- FG FLASHING
- (S) ALUM. OR VINYL SIDING
- HP HARDI BOARD PANEL (REVEAL PANEL INSTALLATION)
- P PARGING

GENERAL NOTES:

- . DO NOT SCALE DRAWINGS, ONLY FIGURED DIMENSIONS ARE TO BE USED. WHERE DOUBT EXISTS, FILE REQUEST FOR INTERPRETATION AND REQUEST CLARITY.
- . It is the responsibility of the general contractor TO VERIFY DIMENSIONS ON SITE, REPORT DISCREPANCES TO THE ARCHITECT PROMPLY.
- 3. GENERAL CONTRACTOR TO TAKE INTO ACCOUNT CONSTRUCTION TOLERANCE & COORDINATE THE WORK OF DIFFERENT TRADES TO COMPLY WITH DESIGN INTENT.
- ALL WORK DISCRIBED IN THESE DRAWINGS AND SPECIFICATIONS ARE TO COMPLY WITH THE CURRENT EDITION OF THE ONTARIO BUILDING CODE 2012 OR NATIONAL BUILDING CODE 2015, INCLUDING MOST RECENT AMENDMENTS.
- DRAWINGS & SPECIFICATIONS ARE COMPLIMENTARY AND ARE TO BE READ TOGETHER.

. THIS DRAWING IS AN INSTRUMENT OF SERVICE AND IS PROTECTED BY COPYRIGHT AND IS THE SOLE PROPERTY OF JIM BELL ARCHITCTURAL DESIGN INC. COPIES, INCLUDING ELECTRONIC COPIES, MAY ONLY BE USED FOR THE PURPOSE INTENDED, FOR THE SINGLE PROJECT FOR WHICH THEY ARE ISSUED AND MAY NOT BE OFFERED FOR SALE OR TRANSFER WITHOUT THE EXPRESS WRITTEN PERMISSION OF THE ARCHITECT.

ISSUE RECORD:

	NO.	DISCRIPTION	DATE
Ī			
Ī			
Ī			
Ī			

URBANDALE CONSTRUCTION LTD 2193 ARCH STREET, OTTAWA TEL: 613-731-6331

REVIEWED:	APPROVED:	J0B	NO.


LOCALE FLATS PHASE 2 - WASTE **MANAGEMENT ROOM**

LEFT & RIGHT SIDE ELEVATION

SCALE: 3/16" = 1'-0"

DWG No: A04 DATE: OCT 10,2020

ARCHITECTURAL

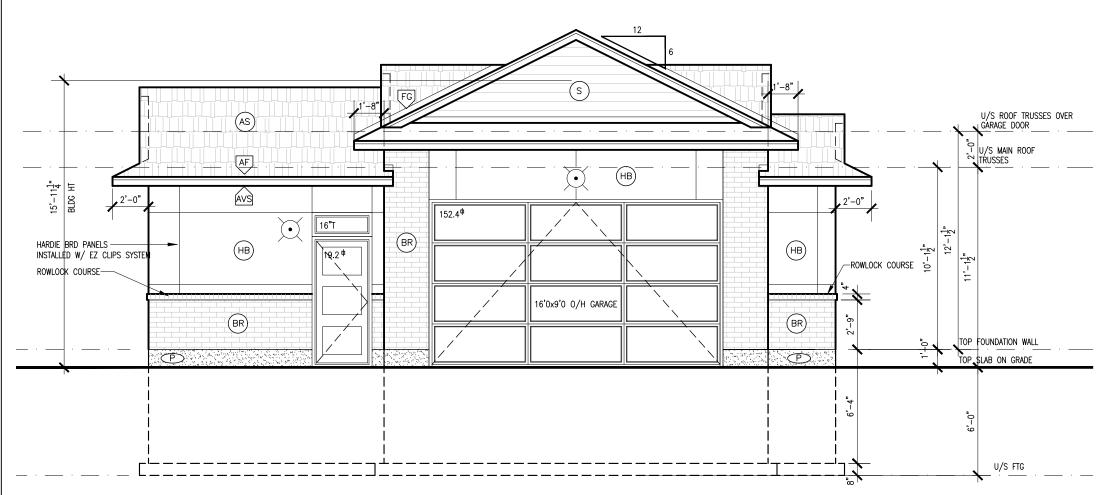

FRONT ELEVATION

TOTAL EXPOSED BLDG FACE (TEBF)= 424.53 sq.ft. (39.44 sq.m.) TOTAL GLAZED OPENING AREA = 171.6sq.ft. = 40.4% LIMITING DISTANCE 49'-4" (15.05m)- FACING PRIVATE ROAD

LILY XU, MCIP, RPP MANAGER, DEVELOPMENT REVIEW SOUTH PLANNING, INFRASTRUCTURE & ECONOMIC DEVELOPMENT DEPARTMENT, CITY OF OTTAWA

APPROVED By Lily Xu at 7:51 pm, Aug 30, 2021

BRICK FACADE

- WEEP HOLES @ WALL @ BASE & OVER ALL OPENING TO BE SPACED 31" MAX.
- •FLASHING @ TOP & BOTTOM OF OPENINGS & TOP OF BRICK SKIRT

ELEVATION LEGEND

(AS) ASPHALT SHINGLES

AF ALUM. FASCIA

AVS VENT. ALUM. SOFFIT

RV ROOF VENT

FG FLASHING

(BR) BRICK

(S) ALUM. OR VINYL SIDING

HP HARDI BOARD PANEL (REVEAL PANEL INSTALLATION)

P PARGING

GENERAL NOTES:

- . DO NOT SCALE DRAWINGS, ONLY FIGURED DIMENSIONS ARE TO BE USED. WHERE DOUBT EXISTS, FILE REQUEST FOR INTERPRETATION AND REQUEST CLARITY.
- . It is the responsibility of the general contractor TO VERIFY DIMENSIONS ON SITE, REPORT DISCREPANCES TO THE ARCHITECT PROMPLY.
- 3. GENERAL CONTRACTOR TO TAKE INTO ACCOUNT CONSTRUCTION TOLERANCE & COORDINATE THE WORK OF DIFFERENT TRADES TO COMPLY WITH DESIGN INTENT.
- . ALL WORK DISCRIBED IN THESE DRAWINGS AND SPECIFICATIONS ARE TO COMPLY WITH THE CURRENT EDITION OF THE ONTARIO BUILDING CODE 2012 OR NATIONAL BUILDING CODE 2015, INCLUDING MOST RECENT AMENDMENTS.
- DRAWINGS & SPECIFICATIONS ARE COMPLIMENTARY AND ARE TO BE READ TOGETHER.

COPYRIGHT:

. This drawing is an instrument of service and is PROTECTED BY COPYRIGHT AND IS THE SOLE PROPERTY OF JIM BELL ARCHITCTURAL DESIGN INC. COPIES, INCLUDING ELECTRONIC COPIES, MAY ONLY BE USED FOR THE PURPOSE INTENDED, FOR THE SINGLE PROJECT FOR WHICH THEY ARE ISSUED AND MAY NOT BE OFFERED FOR SALE OR TRANSFER WITHOUT THE EXPRESS WRITTEN PERMISSION OF THE ARCHITECT.

ISSUE RECORD:

NO.	DISCRIPTION	DAT

URBANDALE CONSTRUCTION LTD 2193 ARCH STREET, OTTAWA TEL: 613-731-6331

APPROVED: JOB NO. REVIEWED:


> **LOCALE FLATS PHASE 2 - WASTE** MANAGEMENT ROOM

FRONT ELEVATION

SCALE: 3/16" = 1'-0"

DWG No: A05

DATE: OCT 10,2020 **ARCHITECTURAL**

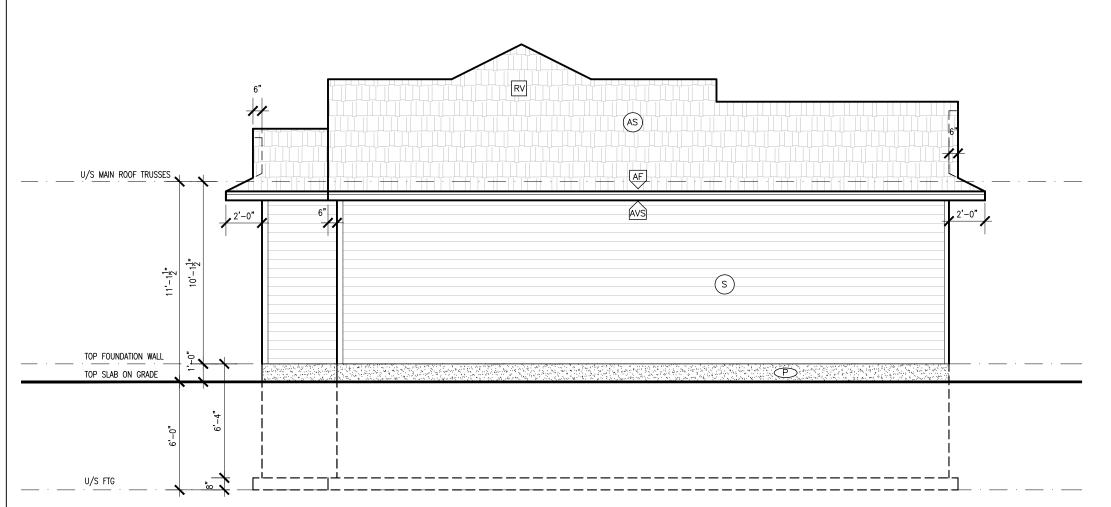

REAR ELEVATION

TOTAL EXPOSED BLDG FACE (TEBF)= 424.53 sq.ft. (39.44 sq.m.) TOTAL GLAZED OPENING AREA= 0= 0% LIMITING DISTANCE 3'-3" (1.0m)

LILY XU, MCIP, RPP MANAGER, DEVELOPMENT REVIEW SOUTH **PLANNING, INFRASTRUCTURE & ECONOMIC DEVELOPMENT DEPARTMENT, CITY OF OTTAWA**

APPROVED

By Lily Xu at 7:52 pm, Aug 30, 2021

. DO NOT SCALE DRAWINGS, ONLY FIGURED DIMENSIONS ARE TO BE USED. WHERE DOUBT EXISTS, FILE REQUEST FOR INTERPRETATION AND REQUEST CLARITY.

GENERAL NOTES:

- . It is the responsibility of the general contractor TO VERIFY DIMENSIONS ON SITE, REPORT DISCREPANCES TO THE ARCHITECT PROMPLY.
- 3. General contractor to take into account construction tolerance & coordinate the work of different trades to comply with design intent.
- . ALL WORK DISCRIBED IN THESE DRAWINGS AND SPECIFICATIONS ARE TO COMPLY WITH THE CURRENT EDITION OF THE ONTARIO BUILDING CODE 2012 OR NATIONAL BUILDING CODE 2015, INCLUDING MOST RECENT AMENDMENTS.
- DRAWINGS & SPECIFICATIONS ARE COMPLIMENTARY AND ARE TO BE READ TOGETHER.

. THIS DRAWING IS AN INSTRUMENT OF SERVICE AND IS PROTECTED BY COPYRIGHT AND IS THE SOLE PROPERTY OF JIM BELL ARCHITCTURAL DESIGN INC. COPIES, INCLUDING ELECTRONIC COPIES, MAY ONLY BE USED FOR THE PURPOSE INTENDED, FOR THE SINGLE PROJECT FOR WHICH THEY ARE ISSUED AND MAY NOT BE
OFFERED FOR SALE OR TRANSFER WITHOUT THE EXPRESS WRITTEN PERMISSION OF THE ARCHITECT.

ISSUE RECORD:

NO.	DISCRIPTION	DA
CLIE	IT.	

URBANDALE CONSTRUCTION LTD 2193 ARCH STREET, OTTAWA TEL: 613-731-6331

BRICK FACADE

- WEEP HOLES @ WALL @ BASE & OVER ALL OPENING TO BE SPACED 31" MAX.

 • FLASHING @ TOP & BOTTOM OF OPENINGS &
- TOP OF BRICK SKIRT

ELEVATION LEGEND

(AS) ASPHALT SHINGLES

AF ALUM. FASCIA

AVS VENT. ALUM. SOFFIT

RV ROOF VENT

FG FLASHING

(BR) BRICK

(S) ALUM. OR VINYL SIDING

HP HARDI BOARD PANEL (REVEAL PANEL INSTALLATION)

P PARGING

APPROVED: JOB NO. REVIEWED:

LOCALE FLATS PHASE 2 - WASTE MANAGEMENT ROOM


REAR ELEVATION

SCALE: 3/16" = 1'-0"

DATE: OCT 10,2020

DWG No: A06

ARCHITECTURAL

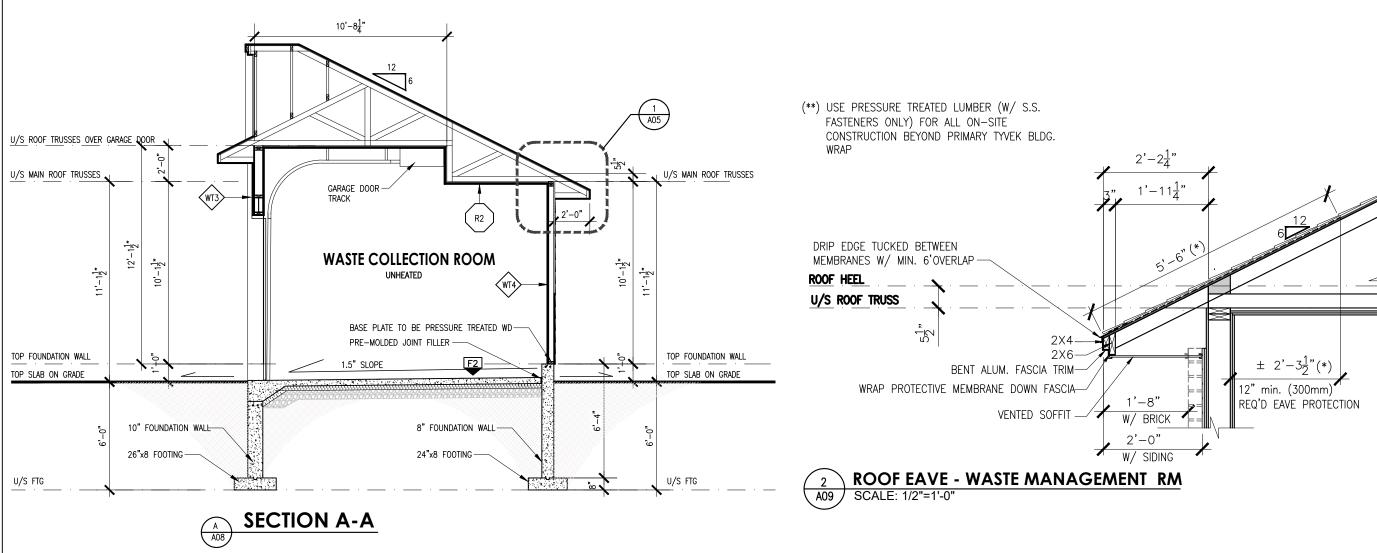

GENERAL NOTES:

- DO NOT SCALE DRAWINGS, ONLY FIGURED DIMENSIONS
 ARE TO BE USED. WHERE DOUBT EXISTS, FILE REQUEST
 FOR INTERPRETATION AND REQUEST CLARITY.
- 2. It is the responsibility of the general contractor to verify dimensions on site, report discrepances to the architect promply.
- 3. General contractor to take into account construction tolerance & coordinate the work of different trades to comply with design intent.
- ALL WORK DISCRIBED IN THESE DRAWINGS AND SPECIFICATIONS ARE TO COMPLY WITH THE CURRENT EDITION OF THE ONTARIO BUILDING CODE 2012 OR NATIONAL BUILDING CODE 2015, INCLUDING MOST RECENT AMENDMENTS.
- 5. Drawings & Specifications are complimentary and are to be read together.

COPYRIGH

1. This drawing is an instrument of service and is protected by copyright and is the sole property of Jim Bell architctural design inc. copies, including electronic copies, may only be used for the purpose intended, for the single project for which they are issued and may not be offered for sale or transfer without the express written permission of the architect.

ISSUE RECORD:

NO.	DISCRIPTION	DATE
CLIEN	лт.	

CLI

URBANDALE CONSTRUCTION LTD 2193 ARCH STREET, OTTAWA TEL: 613-731-6331

REVIEWED:

APPROVED:

JOB NO.

CI: LOCALE FLATS
PHASE 2 - WASTE
MANAGEMENT ROOM

NC:

SECTIONS

SCALE: 3/16" = 1'-0"

______ DWG No: A07

DATE: OCT 10,2020

ARCHITECTURAL

alexander.

LILY XU, MCIP, RPP
MANAGER, DEVELOPMENT REVIEW SOUTH
PLANNING, INFRASTRUCTURE & ECONOMIC
DEVELOPMENT DEPARTMENT, CITY OF OTTAWA

APPROVED

By Lily Xu at 7:52 pm, Aug 30, 2021