

5-HaA

1-AgF

3-PoLD

35-PvA

3-TcM

1-AgF

17-PvA

3-TcM

10-PvD

1-Md

3-TcM

6-PoLD


1-AgF

5-HaA

ENTRANCE AND RAMP

SEE ARCH. DRAWINGS

11-PvD 🕠

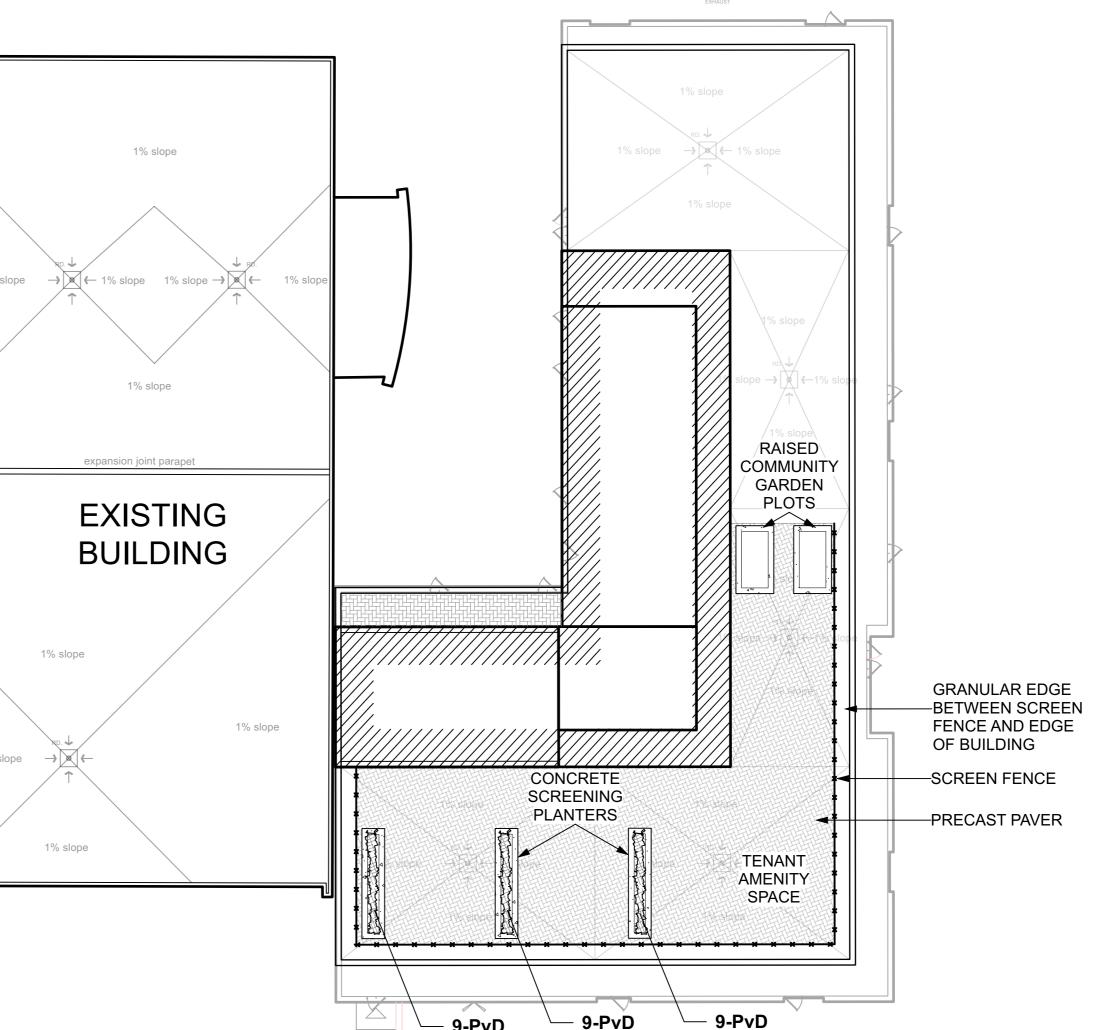


THIS PLAN IS ISSUED FOR SITE PLAN CONTROL SUBMISSION ONLY. ADDITIONAL DETAILING AND SPECIFICATIONS ARE REQUIRED PRIOR TO TENDERING OR CONSTRUCTION.

DRAWING TO BE READ IN CONJUNCTION WITH TREE CONSERVATION REPORT. REFER TO TREE CONSERVATION REPORT BY RUHLAND & ASSOCIATES LTD. DATED MAY 26, 2021 FOR TREE PROTECTION MEASURES AND DÉTAILS.

GENERAL NOTES

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- .9 Maintain positive surface runoff through the entire construction period.
- .10 Reinstate all areas and items damaged as a result of construction activities.
- .11 Street tree species locations and numbers were selected based on soil volume calculations in accordance with the City of Ottawa's requirements for tree planting.

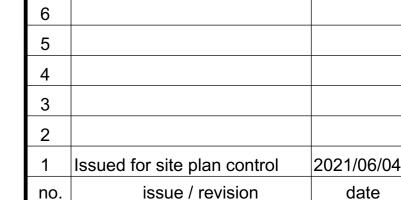

**Ruhland & Associates Ltd** 

project

**18 LOUISA ST** 

OTTAWA, ON

drawing title

LANDSCAPE AND **ROOF PLAN** 

designed by J. K. / T.F. J.K. / M.R. date checked by plot date JUNE 2021 2021 06 04 drawing number

project number

20-1629

L - 01

Contractor to check and verify all dimensions on the job

Scale: 1:200

EXISTING PARKING

LANDSCAPE PLAN AT GRADE

EXISTING PRECAST PAVER ENTRANCE

LOUISA ST.

CONCRETE PAD;

EXISTING PRECAST PAVER ENTRANCE

SIAMESE CONNECTION -

DETERMINE EXACT

LOCATION ON SITE

**EXISTING SIGN-**

8 CAPACITY; DOUBLE

2-PvC

3-Sa 3-PvB

1-Apal

10-PvC

2-PvB

13-PvC

EXISTING TREES # 12, 13, 14

ARLINGTON AVE.

**EXISTING** 

BUILDING

BIKE RACK ON CONCRETE PAD;

12 CAPACITY; DOUBLE LOADED

PRECAST CONCRET BENCHES WIT

CONCRETE / PLANTERS WITH //

SEATING EDGES

PLANTER

- 11-ToH-1

2-PvB

4-PvC

5-PvC

2-PvB

2-PvB

9-PvC

- 3-PvC

7-PvB

PROPOSED 9

STOREY

RESIDENTIAL

BUILDING

9-PvD

4-ToH-1


11-PvD

4-PvB


1-Cc-1

2-CoPS


3-Sa

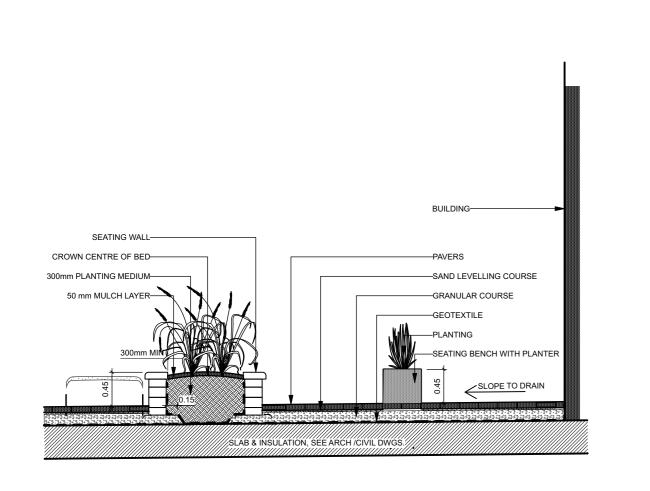

SECTION A-A - INTERIOR COURTYARD SEATING PLANTERS
Scale: NTS

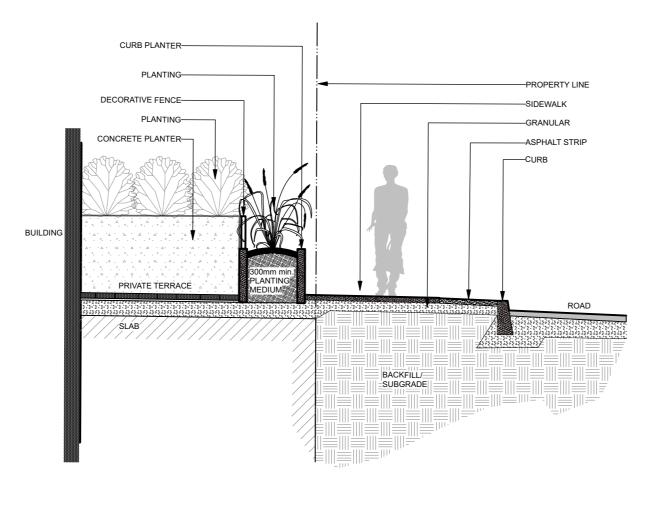

2 SECTION B-B - EXTERIOR TERRACE Scale: NTS

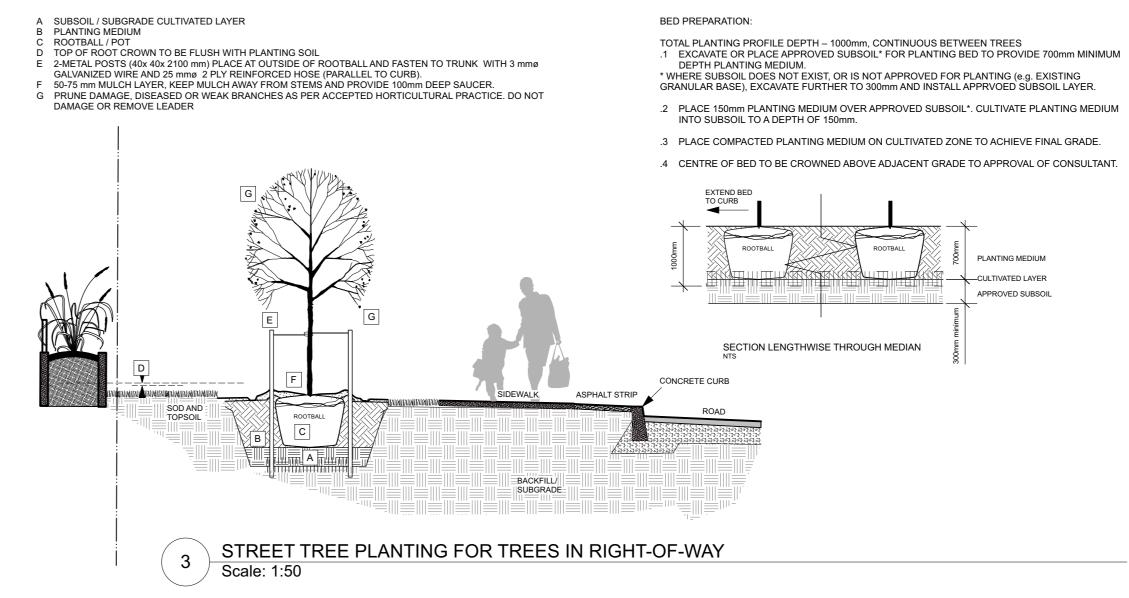

SLOPE TO DRAIN

A. SMALL TREE

A. SM

4 SECTION OF SOIL PROFILES ON SLAB
Scale: NTS

TO PROPER LEVEL WITH COMPACTED PLANTING MEDIUM.

A 450mm COMPACTED PLANTING MEDIUM, DEEPEN AT TREES

AND 50mm ABOVE SOIL OUTSIDE PLANTING PIT / POT

B ROOTBALL, TOP OF ROOT CROWN TO BE FLUSH WITH PLANTING SOIL

C 350mm PLANTING MEDIUM / SUBSOIL CULTIVATED LAYER. CULTIVATE AT


FIRST ROW OF PERENNIALS TO BE PLANTED 600mm FROM EDGE OF BED/CURB FIRST ROW OF SHRUBS TO BE PLANTED 900mm FROM EDGE

**Bed Preparation** 

## Tree Planting

- .1 CUT AND REMOVE TOP 1/3 OF BURLAP AND WIRE BASKET FROM ROOTBALL.
   .2 PLACE 2-METAL POSTS (40 x 40 x 2100 mm) AT OUTSIDE OF ROOTBALL AND FASTEN
- TO TRUNK WITH APPROVED TREE TIES.

  3. WATER THOROLIGHLY SUBSECLIENT TO PLANT
- .3 WATER THOROUGHLY SUBSEQUENT TO PLANTING..4 WRAP TREE TRUNK AFTER INSPECTION OF TREES BY LANDSCAPE ARCHITECT.
- .5 PROTECT TREE FROM RODENT DAMAGE.
- .6 REMOVE TREE RINGS, STAKES AND TRUNK WRAPPING AFTER WARRANTY PERIOD.

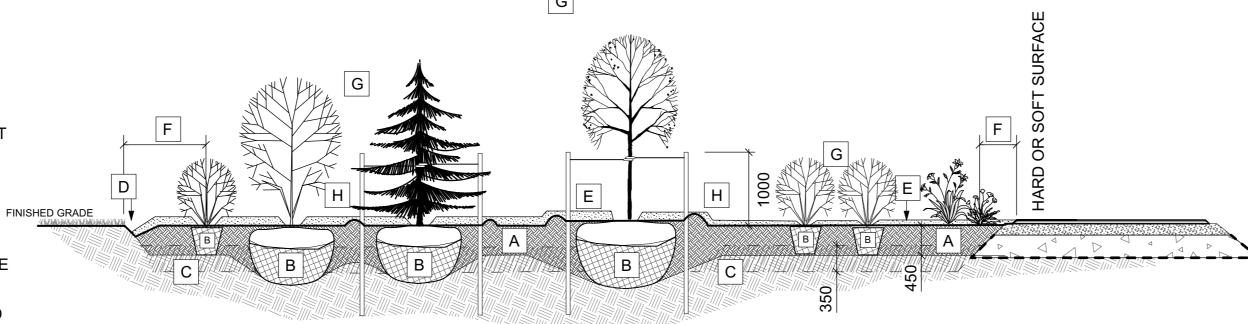

G PRUNE DAMAGED, DISEASED OR WEAK BRANCHES AS PER ACCEPTED HORTICULTURAL PRACTICE, DO NOT DAMAGE OR REMOVE LEADER

50-75 mm MULCH LAYER, KEEP MULCH AWAY FROM STEMS

.1 EXCAVATE OR PLACE FILL FOR PLANTING BED TO PROVIDE 450mm MINIMUM DEPTH OF PLANTING MEDIUM.

.2 PLACE 150mm PLANTING MEDIUM ON SUBGRADE AND CULTIVATE INTO TOP 200mm OF SUBSOIL. SEE NOTE

.3 PLACE REMAINDER OF PLANTING MEDIUM OVER CULTIVATED PORTION TO ACHIEVE FINAL GRADE.

.4 CENTRE OF BED TO BE CROWNED ABOVE ADJACENT GRADE TO APPROVAL OF CONSULTANT.

.5 ENSURE POSITIVE DRAINAGE AWAY FROM BUILDING WALLS WHERE APPLICABLE.

PLANTING BED TO BE DEEPENED AT TREE LOCATIONS. IF BASE OF PIT IS OVER EXCAVATED, RAISE BOTTOM

H PROVIDE 150 mm DEEP SAUCER AT TREES

TREE PIT BOTTOM. SEE NOTE BELOW.


D EDGE TO DEPTH OF 100mm

OF BED/CURB

## NOTES:

- PLANTING BED AREAS EXCAVATED TO 500mm BELOW FINAL GRADE FOR ROUGH GRADE.
   REFER TO PLANT LIST FOR PLANT SPACING.
- REFER TO PLANT LIST FOR PLANT SPACING.

7 PAVING PATTERNS
Scale: NTS

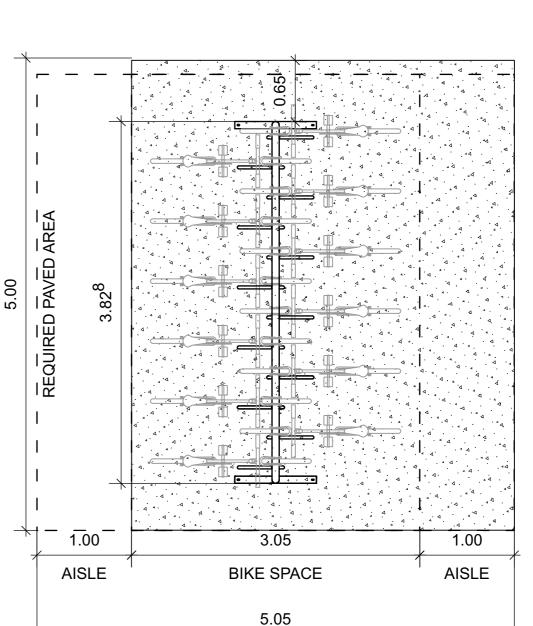

ACCESSIBLE SPACE REQUIREMENTS- BOTH SIDES

12 CAPACITY DOUBLE-LOADED BIKE RACK Scale: 1:40

PRIVATE TERRACE—PAVERS

ROOFTOP AMENITY—SPACE PAVERS


COURTYARD—PAVERS

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issue / revision da

north

Ruhland & Associates Ltd

project

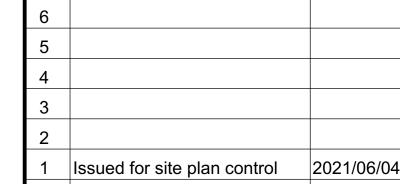**18 LOUISA ST** 

OTTAWA, ON

drawing title

SECTIONS / DETAILS

scale drawn by designed by
J. K. / T.F. J.K. / M.R.

date checked by plot date
JUNE 2021 M. R. 2021 06 04

project drawing number

20-1629

\_ - 02

Contractor to check and verify all dimensions on the job

6 PLANTING DETAIL ON GRADE Scale: NTS