# **MARITIME WAY - FORMAL UDRP**

June 4, 2021









# SITE CONTEXT

#### North

To the north across Maritime Way is a five-storey hotel (Marriott Towne Place Suites), a 1.64 ha lot that is currently vacant and the 'William's Court' residential complex which comprises five buildings 5-12 storeys in height.

#### **East**

To the east is a 2.98 ha vacant parcel, from which the Subject Site was recently severed. Further east is a stormwater management pond.

#### West

To the west is 'Timberwalk', a recently completed seven storey retirement home. At 6301 Campeau Drive applications have been filed to develop 798 residential units in buildings of up to ten storeys. Across Kanata Avenue, the main commercial portion of the Kanata Town Centre, with a ten-storey hotel and a large area of retail further west including a Walmart.

#### South

To the south is provincial highway 417. Across the highway is the Holy Trinity Catholic High School, The Royal Canadian Legion Dominion Command and the Kanata Leisure Centre. Further south is predominantly residential.













#### **Surrounding Uses**


- 1 OC Transpo Terry Fox Park & Ride
- 2 Loblaws Supermarket and pharmacy
- 3 Walmart Supercentre
- 4 CIBC Bank and ATM
- 5 Morning Owl Coffee

- 6 Kanata Leisure Centre & Wave Pool
- 7 Holy Trinity Catholic Highschool
- 3 Appletree Medical Centre
- Existing OC Transpo (Within 250 m)
- Tuture Light Rail Transit Station

**Pathways** 



# **EXISTING CONDITIONS - SITE AND SURROUNDING CONTEXT**

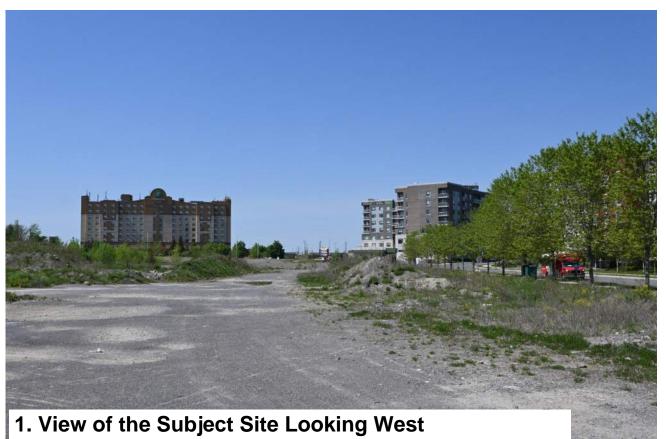







Page 3

# **EXISTING CONDITIONS - SITE AND SURROUNDING CONTEXT**










NOVATECH

# **EXISTING CONDITIONS - SITE AND SURROUNDING CONTEXT**

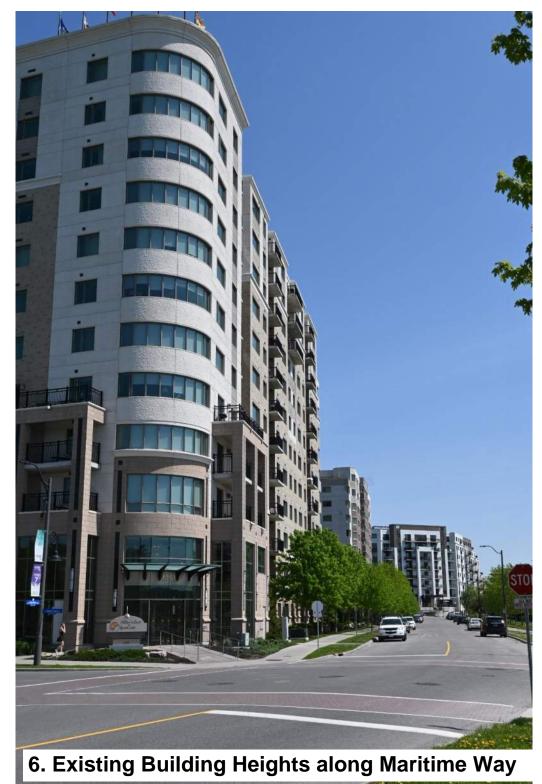







# POLICY CONTEXT - OFFICAL PLAN

Per **Section 3.6.2** of the Official Plan, the subject site is within a Mixed Use Centre and a Town Centre. The section speaks to the importance of these centres (Kanata is one of three in Ottawa):

Town Centres and Mixed Use Centres occupy strategic locations on the Rapid-Transit network and act as central nodes of activity within their surrounding communities and the city as a whole. These centres are a critical element in the City's growth management strategy, being areas with potential to achieve high densities and compact and mixed-use development oriented to rapid transit. More jobs and housing at these locations will increase transit ridership and draw more commuter travel to these locations. In the long term the centres will become complete, livable communities that attract people for the jobs, leisure, lifestyle, and business opportunities they provide.

**Policy 1** goes on to describe the criteria a Town Centre should meet. Criteria a), b) and c) are of particular relevance:

a.Most of the centre is within an 800m walking distance of one or more rapid transit stations, and contains one or more arterial roads with all day, frequent transit service;

b. There is opportunity to achieve high densities of jobs and housing through intensification and redevelopment of older sites and development of vacant land;

c.High-Rise Buildings of 10 storeys and more can be accommodated in a manner that provides appropriate transition to the surrounding area;


The proposal is a good example of a site and a development that meets all these criteria.

Policy 5 outlines the uses that Mixed Use Centres permit high density residential.

Policy 9 provides that: "All development applications and Community Design Plans for Mixed-Use Centres will be reviewed in the context of this Plan and in particular:

1. Will be evaluated in the context of the Design Objectives and Principles in Section 2.5.1 and the criteria set out in Section 4.11, particularly with regard to achieving a compact, mixed-use, transit-oriented, pedestrian-friendly environment and creating a place with visual interest; 2. Will, where possible, contribute to a range of housing options in the area.

#### **Subject Site**

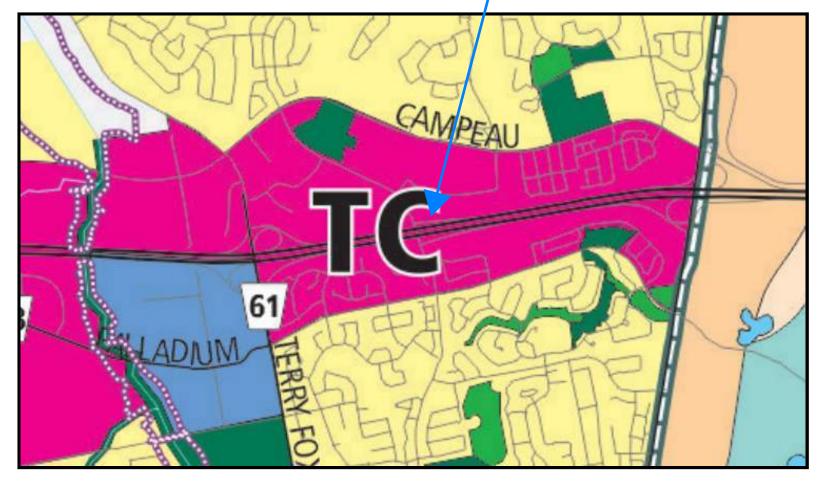



# POLICY CONTEXT - SECONDARY PLAN

Following is an assessment of the proposal against the relevant provisions of the Kanata Town Centre Secondary Plan. The plans vision statement is that:

"The Kanata Town Centre will be an active, vibrant core area containing a diverse mix of urban uses arranged in a form and a scale, which is both human and appropriate to its function. It will be a uniquely identifiable place that caters to residents and attracts visitors and will be a constant source of pride for future generations."

At 5.7.4 Broad Issues, Residential is described as follows:

"As the City grows and matures, demographic indicators suggest the need for residential development, which caters to smaller household size, lower incomes, and households which are less dependent on the private automobile."

The proposal addresses this issue by providing 1 and 2 bedroom rental apartments which are inherently more affordable than larger ground based dwellings, within 400m of a BRT stop that will become an LRT station in the future.

Land Use designations are mapped in Schedule B1 and described at Section 5.7.5. The subject site is designated CBD (Central Business District). It is the intent of this designation that these lands become: "an urban place that provides for employment uses, complemented by higher density residential uses."

In relation to phasing, the plan states that: "It is expected that residential developments within the Central Business District may occur sooner than office and commercial developments and this is permitted provided the capacity to achieve the 10,000 job target within the Central Business District and Regional Shopping Centre designations is retained."

As a number of parcels in the CBD designation remain undeveloped, it is expected that the 10,000 jobs target can be achieved.


Schedule B2 and Section 5.7.5.8 set out building heights. The subject site is designated for 10-30 storey high-rise development. In combination with Schedule B2, the following applies to this designation:

1. Subject to a zoning amendment, a High-Rise 10 to 30 storey building may be considered where it is demonstrated that the development satisfies all of the following:

A minimum of three storeys is required for residential and office development. [Amendment #136, LPAT # PL141243, September 18, 2020]

- ·Meets the Urban Design and Compatibility policies in Section 4.11 of the Official Plan.
- Meets the Designing Ottawa policies in Section 2.5.1 of the Official Plan.
- The appropriate maximum building height will be determined on the basis of site conditions and constraints and the ultimate height must be supportable by the required submissions for a Zoning By-law Amendment, which will include but is not limited to a Transportation Impact Study, Geotechnical Study, Servicing Brief, Sun Shadow Study, and a Concept Plan demonstrating compliance with Section 4.11 of the Official Plan. [Amendment #136, October 16, 2014]

In response to the above, the proposal is a minimum of seven storeys. It meets the policies at Sections 2.5.1 and 4.11 of the Official Plan. The required submissions form part of the Zoning By-law Amendment and Site Plan applications.

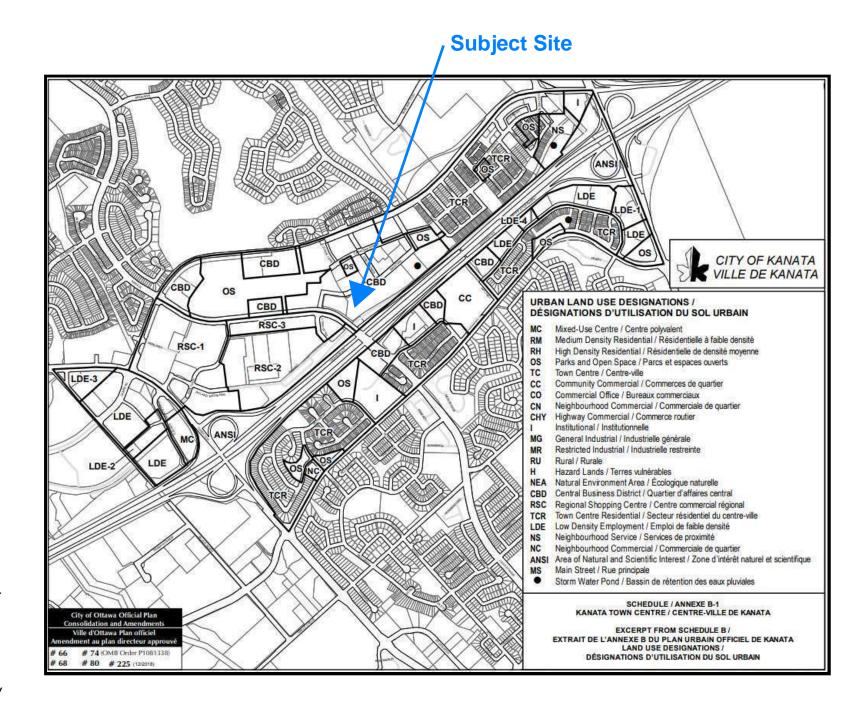




# **REGULATORY CONTEXT - ZONING BY-LAW**

The site is currently in two zones – the western part is Mixed Use Centre sub-zone 5 with a height limit (MC5 H[35]). The eastern part is Mixed Use Centre sub-zone 15 with an exception and a hold (MC15[2165]-h).

The purpose of the MC zone is to:

- 1) ensure that the areas designated Mixed-Use Centres in the Official Plan, or a similar designation in a Secondary Plan, accommodate a combination of transit-supportive uses such as offices, secondary and post-secondary schools, hotels, hospitals, large institutional buildings, community recreation and leisure centres, day care centres, retail uses, entertainment uses, service uses such as restaurants and personal service businesses, and high- and medium-density residential uses; (By-law 2015-293)
- 2) allow the permitted uses in a compact and pedestrian-oriented built form in mixed-use buildings or side by side in separate buildings; and
- 3) impose development standards that ensure medium to high profile development while minimizing its impact on surrounding residential areas.

Apartment dwelling high-rise is a permitted use in both the MC5 and MC15 sub-zones. They also list zoning provisions additional to the MC zone. Of note, the MC5 zone has a height limit of 35m and the exception that applies to the eastern part of the site (Exception 2165) introduces a height limit of 67m.

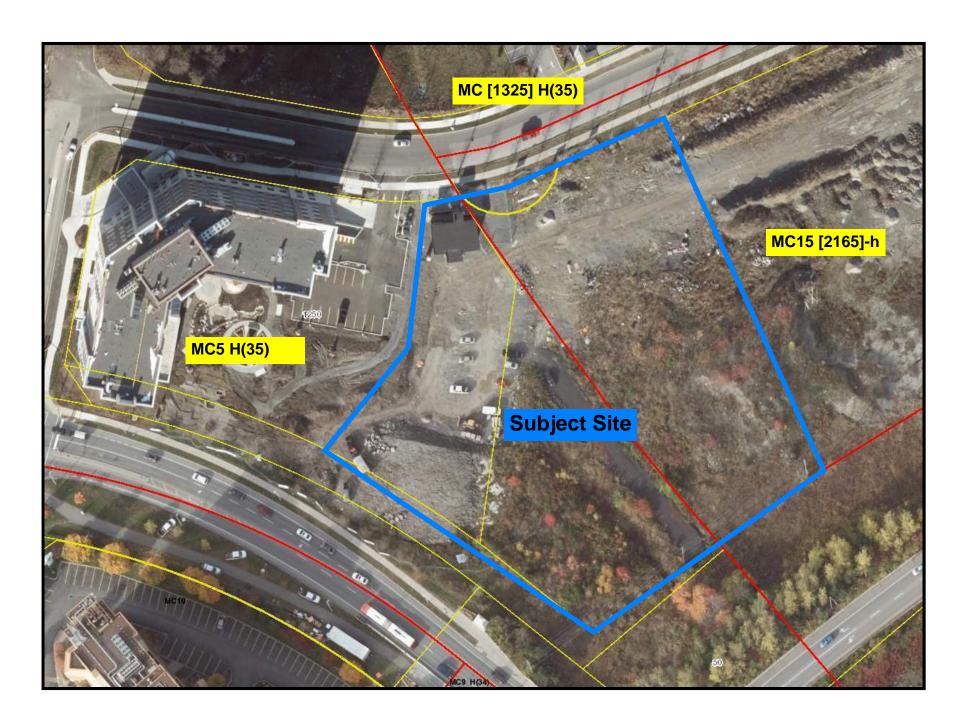



# URBAN DESIGN GUIDELINES FOR HIGH-RISE BUILDINGS

Approved by City Council in 2018, the City of Ottawas Urban Design Guidelines for High-Rise Buildings are to be used during the review of development proposals to promote and achieve appropriate high-rise development. The design guidelines will be applied wherever high-rise residential buildings are proposed. Following is an assessment of the proposal against the applicable sections of the guidelines.

#### 1. Context

#### At the site level:

1.12 Include base buildings that relate directly to the height and typology of the existing or planned streetwall context.

The existing streetwall context of this section of Kanata Avenue comprises the nine storey Holiday Inn on the west side and the seven storey Timberwalk retirement home on the east, with landscaped setbacks. The proposal is consistent with this as it has a seven storey base building facing Kanata Avenue and completing this section of Kanata Avenue.

1.13 An angular plane, typically 45°, measured from the relevant property lines, should be used to provide a frame of reference for transition in scale from proposed high-rise buildings down to lower scale areas.

There is an angular plan transition from the towers to the podium. They are located at the edge of the Kanata Town Centre, separated from Kanata South by the wide right of way required by Highway 417. The transition to the surrounding area to the north, east and west is via the seven-storey podium. Combined with the separation of the buildings from neighbouring mid-rise buildings, the transition is suitable.

#### 2. Built Form

#### Base-middle-top:

- 2.3 Depending on the function and context, high-rise buildings can take many different forms to serve both the experience and expression functions:
- a. high-rise building that includes three distinctive and integrated parts base, middle, and top is generally accepted as a good approach to built form design in order to effectively achieve many urban design objectives.

The proposal is consistent with this policy, having a clear base, middle and top.

#### Placement:

- 2.13 Place the base of a high-rise building to form continuous building edges along streets, parks, and public spaces or Privately Owned Public Space (POPS):
- a. where there is an existing context of streetwall buildings, align the facades of the base with adjacent building facades;
- b. in the absence of an existing context of streetwall buildings, create a new streetwall condition to allow for phased development and evolution.

The facades of the buildings address Maritime Way and Kanata Avenue, enclosing and animating the streets. The existing streetwall context of this section of Kanata Avenue comprises the nine storey Holiday Inn on the west side and the seven storey Timberwalk retirement home on the east. The proposal is consistent with this as it has a seven storey base building facing Kanata Avenue and completing this section of Kanata Avenue.





# URBAN DESIGN GUIDELINES FOR HIGH-RISE BUILDINGS

#### **Height and Transition:**

2.15 The maximum height of the base of a proposed high-rise building should be equal to the width of the ROW (Diagram 2-6) to provide sufficient enclosure for the street without overwhelming the street.

The rights of way that the site has frontage to vary in width 26m for Maritime Way and 50m for Kanata Avenue (and 150m for Highway 417 but this less of a public realm). The proposed podium is approximately 22.5m high, consistent with the narrowest right of way. A lower podium would not provide adequate enclosure, particularly to Kanata Avenue as it enters the town centre.

- 2.19 For sites where the adjacent context is lower-scale and not anticipated to change:
- a. the height of the base or the portion of the base immediately adjacent to the neighbouring lower-scale buildings should match the height of the neighbouring buildings (Diagram 2-6 and 2-7); and
- b. provide a transition in height on the base through setbacks and architectural articulation (Diagram 2-6 and 2-7).

The buildings closest to the subject site (the retirement home and the Marriott hotel on Maritime Way and the Holiday Inn Hotel on Kanata Avenue) are mid-rise buildings of 5 to 9 storeys without distinct podiums. The podium of this taller proposal reflects this, being 7 storeys. The distinct outline of the buildings, with the podium extending well beyond the towers in one direction clearly differentiates the podium.

#### **Articulation and materials:**

- 2.20 Respect the character and vertical rhythm of the adjacent properties and create a comfortable pedestrian scale by:
- a. breaking up a long façade vertically through massing and architectural articulation to fit into the existing finer grain built form context (Figure 2-13);
- b. determining appropriateness of larger-scale façades in certain areas, such as along the ceremonial routes (Figure 2-14); and
- c. introducing multiple entrances, where possible, through creative store layout and organization where a large format retail use is located on the ground floor.

The ground level of the proposal is extensively glazed and activated by amenity uses (e.g. gym, lounge) and ground level apartments. The buildings have multiple entrances fronting the area in between the two buildings and connected by curbed sidewalks. The proposed cladding emphasizes these entrances and animates the street level, podium and tower portions of the development while breaking up the longest portions of the façade.

- 2.24 Encourage small tower floor plates to minimize shadow and wind impacts, loss of skyviews, and allow for the passage of natural light into interior spaces (Figure 2-15):
- a. the maximum tower floor plate for a high-rise residential building should be 750m² (Diagram 2-8);

The floor plates of approximately 720m<sup>2</sup> and 880m<sup>2</sup> are generally consistent with this policy, and allow for natural light to enter between the buildings and into interior spaces at all levels.

- 2.25 Provide proper separation distances between towers to minimize shadow and wind impacts, and loss of skyviews, and allow for natural light into interior spaces:
- a. the minimum separation between towers should be 23m (Diagram 2-9);

The two towers are separated by 23m at the narrowest point, as the vee shape between the towers results in a wider separation closer to Maritime Way.

- 2.29 Step back the tower, including the balconies, from the base to allow the base to be the primary defining element for the site and the adjacent public realm, reducing the wind impacts, and opening skyviews:
- a. a step back of 3m or greater is encouraged.
- b. the minimum step back, including the balconies, should be 1.5m; and

The podium of the buildings extends well beyond the towers, closest to the street. This design, and distinct building outline clearly differentiates podium from tower. The base of the buildings addresses the public realm, and the vee shape creates an inviting area with visitor parking, pedestrian connections and landscaping between the two podiums.

- 2.35 The top should be integral to the overall architecture of a high-rise building, either as a distinct or lighter feature of the building or a termination of the continuous middle portion of the tower.
- 2.36 Integrate roof-top mechanical or telecommunications equipment, signage, and amenity spaces into the design and massing of the upper floors.

Mechanical elements have been designed to line up with elements of the building cladding, and as such are visually minimized on top of the tower, and the podium.





# URBAN DESIGN GUIDELINES FOR HIGH-RISE BUILDINGS

#### 3. Pedestrian Realm

- 3.1 Provide a minimum 6m space between the curb and the building face along the primary frontages of a high-rise building, including the City-owned portion within the right-of-way (ROW) and the building setback area:
- a. the pedestrian clearway must be within the ROW;
- b. on a street with commercial character, introduce hard surfaces between the curb and the building face to maximize the walkable area and provide flexible spaces to accommodate seasonal uses such as outdoor patios, where appropriate; and
- c. on a street with residential character, introduce landscaping and/or residential patios between the sidewalk and the building face to allow for public-private transition.


The proposal has a landscape setback to the curb on Maritime Way and Kanata Avenue of more than 6m, and additional landscaped area is proposed in the vee shaped area between the two buildings. The emerging character of the area is of mid-rise buildings that front the street, combined amenity or access areas mostly enclosed by buildings but also visible from the street. Good examples of this is are the Williams Court development further east on Maritime Way and the Timberwalk retirement home next to the Subject Site. The proposal is consistent with this character.

3.8 Where appropriate, break up larger street blocks or larger development parcels by introducing mid-block pedestrian or multi-use connections, public or private, outdoor or indoor to increase and enhance the overall pedestrian accessibility and walkability of the area.

The proposal makes use of portion of a large vacant parcel along Maritime way, and as the rest of the site is currently undeveloped, there are few opportunities to introduce pedestrian connections, but the site design allows for future connections to be made on, or around the site.

3.9 When a mid-block connection is on private lands, it should be properly signed and designed to welcome pedestrians and may be integrated into the lobby or atrium of a high-rise building.

The proposal connects directly to Maritime Way and Kanata Avenue and provides a connection between the two. Maritime Way, Kanata Avenue and Lord Byng Way provide a convenient connection to the BRT and future LRT station which is 400m-500m. The activated facades facing the public realm animate it.

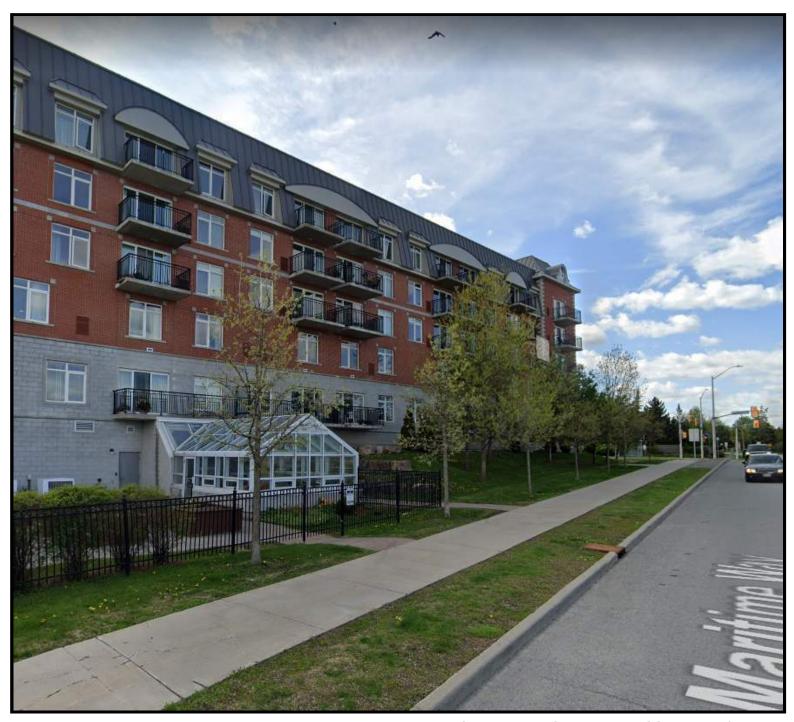

Red Oak Retirement Residence - Maritime Way frontage



# SUSTAINABILITY STATEMENT

Create intensified, mixed-use development, incorporating amenities and encourage public realm at nodes and gateways by concentrating height and mass and articulating facade features to create scale and encourage pedestrian flow.

Transition in the scale and density of the built form on the site next to lower density neighbourhoods to create accessibility to rapid transit hub.

The ground floor of the base to be animated and transparent encouraging safety and properly illuminated transition areas. Articulate with quality materials, rhythm, and design features as active and animated surfaces.

Landscape the area in front of a buildings and in between them to create a welcoming pedestrian approach. Foundation planting, trees, street furniture, permeable paved areas and walkways to the public sidewalk to encourage pedestrian use and activity as well as creating shade for the users.

Well insulated building envelope and increased energy efficiency informed with recommendations from a building energy report including energy efficient HVAC and electrical installations.


Use of clear glass low-e argon sealed unit glazing and doors to achieve good thermal efficiency.

Use of green vegetative roofs for water retention.

Use of white membrane roofs and light colored pavers to minimize solar reflection.

# PLANS OF PROPOSED DEVELOPMENT

Site Plan Floor Plans **Elevations** Section Sun Study 3D Renders Landscape Plan **General Plan of Services** 

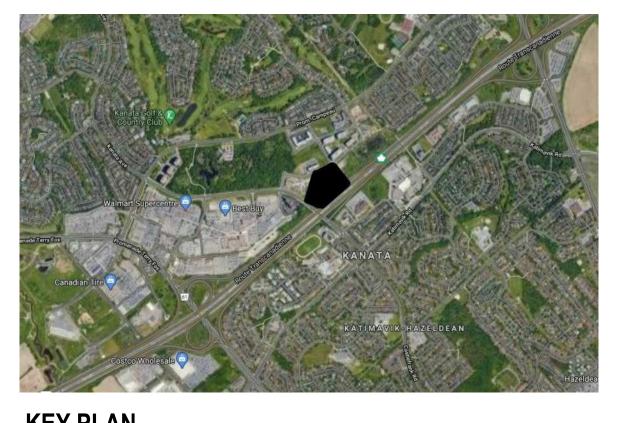

#### **KEY PLAN**

ZONE AM10 REQUIRED PROVIDED PROVISION Min Lot Width +/- 69.65 m no minimum +/- 12 808 m<sup>2</sup> Min Lot Area no minimum Max Building Height +/- 93.5 m Min Front Yard Setback 3.05 m / 3.09 m no mininum Min Corner Side Yard Setback 16.74 m no minimum Min FSI +/- 4.88 Min Interior Side Yard Setback 14.70 m / 15.13 m no minimum

SITE AREA: +/- 12 808 sq.m. (To be confirmed by surveyor) SITE COVERAGE +/- 2 207 m² (East Tower) +/- 1 968 m² (West Tower)

Total =  $\pm -4 \ 175 \ \text{m}^2 = 32.6 \ \%$ +/- 2 298 m<sup>2</sup> = **17.9**% GROUND PARKING AREA : LANDSCAPED AREA (EXCLUDING PARKING): +/- 6 335 m<sup>2</sup> = **49.5** %

#### **RENTAL - EAST TOWER**

PROPOSED GROSS FLOOR AREA: +/- 21 964 m<sup>2</sup> BASEMENT G.F.A. : +/- 0m<sup>2</sup> GROUND FLOOR G.F.A. : +/- 635 m<sup>2</sup> RENTAL FLOORS G.F.A. (2nd to 30th floor): +/- 21 329 m<sup>2</sup> PRIVATE AMENITY AREA (G.F.A.) : +/- 1 953 m<sup>2</sup> COMMUNAL AMENITY AREA: + /- 925 m<sup>2</sup> NUMBER OF FLOORS AND BUILDING HEIGHT 28 FLOORS + MECH. / +/- 87.50m DWELLING UNITS: PARKING STALLS : 315 (300 INSIDE / 15 VISITORS OUTSIDE) PROVIDED BICYCLE STALLS : **150** (142 INSIDE / 8 OUTSIDE)

NUMBER OF SUITES REQUIRED TO BE BARRIER-FREE: 300 UNITS = **45 UNITS** HAVE TO BE BARRIER-FREE THEY WILL BE DISTRIBUTED BETWEEN THE 28 FLOORS

#### **RENTAL - WEST TOWER**

PROPOSED GROSS FLOOR AREA: +/- 30 179 m<sup>2</sup> BASEMENT G.F.A. : +/- 0m<sup>2</sup> GROUND FLOOR G.F.A. : +/- 375 m<sup>2</sup> RENTAL FLOORS G.F.A. (2nd to 30th floor): +/- 29 804 m<sup>2</sup> PRIVATE AMENITY AREA (G.F.A.): +/- 2 247 m<sup>2</sup> COMMUNAL AMENITY AREA: + /- 1 045 m<sup>2</sup> 30 FLOORS + MECH. / +/- 93.50m NUMBER OF FLOORS AND BUILDING HEIGHT: DWELLING UNITS: **347** (332 INSIDE / 15 VISITORS OUTSIDE) **166** (159 INSIDE / 7 OUTSIDE) PARKING STALLS : PROVIDED BICYCLE STALLS:

NUMBER OF SUITES REQUIRED TO BE BARRIER-FREE 332 UNITS = **50 UNITS** HAVE TO BE BARRIER-FREE

THEY WILL BE DISTRIBUTED BETWEEN THE 30 FLOORS FOR EXISTING SITE CONDITIONS, SEE SURVEY PLAN BY ANNIS, O'SULLIVAN, VOLLEBEKK LTD., SUBMITTED SEPARATELY;

FOR NEW GRADES AND SITE SERVICES, SEE CIVIL ENGINEERING PLAN BY NOVATECH ENGINEERING CONSULTANTS, SUBMITTED SEPARATELY; FOR PROPOSED VEGETATION AND LANDSCAPE INFORMATION, SEE LANDSCAPE PLAN BY JAMES B. LENNOX & ASSOCIATES, SUBMITTED SEPARATELY.

REFER TO CIVIL PARKING LIMIT 52 400 TOWER OUTLINE MAIL **AMENITIES** 795 ft<sup>2</sup> SNAIL-E 801 ft<sup>2</sup> LANDSCAPED AREA 4744 ft<sup>2</sup> OFFICES A404 / MAIN LOBBY SNAIL-E **OFFICES** PROPOSED SIAMESE CURB & SIDEWALK (MONOLITHIC) CONNECTION 9 CARS (VISITORS) TACTILE INDICATORS REQUIRED AT DEPRESSED LANDSCAPED AREA CURBS (TYPICAL). MAY REFER TO CIVIL. CURB 6 CARS R 1 325 UNDERGROUND PARKING LIMIT MARITIME - CURB & SIDEWALK (MONOLITHIC) FIRE ROUTE DEPRESSED CURBS AND SIDEWALK AS PER FOUNTAIN - TACTILE INDICATORS REQUIRED AT CITY STANDARDS DEPRESSED CURBS (TYPICAL). REFER TO CIVIL. URB & SIDEWALK (MONOLITHIC) PROPERTY LINE REFER TO SURVEYOR PLAN SIDEWALK PARKING ENTRANCE LANDSCAPED AREA UNDERGROUND -PARKING LIMIT PROVIDE HEAVY DUTY CLEARANCE BAR -SIGNAGE WARNING VEHICULE OF HEIGHT LIMIT: 'LIMIT CLEARANCE 2.2m (7'-2")'. UNDERSIDE OF SIGN TO BE AT 2.2m CLEAR. ANCHORED ON GLAVANIZED STEEL POSTS. 1652 ft<sup>2</sup> 850 ft<sup>2</sup> 850 ft<sup>2</sup> LANDSCAPED AREA

NOTES GÉNÉRALES General Notes

- PROPERTY LINE

A404

SETBACK

- PROPERTY LINE

REFER TO SURVEYOR PLAN

REFER TO SURVEYOR PLAN

1 Ces documents d'architecture sont la propriété exclusive de NEUF architect(e)s et ne pourront être utilisés, reproduits ou copiés sans autorisation écrite préalable. / These architectural documents are the exclusive property of NEUF architect(e)s and cannot be used, copied or reproduced without written pre-authorisation

2 Les dimensions apparaissant aux documents devront être vérifiées par l'entrepreneur avant le début des travaux. / All dimensions which appear on the documents must be verify by the contractor before to

 Veuillez aviser l'architecte de toute dimension erreur et/ou
 divergences entre ces documents et ceux des autres professionnels. /
 The architect must be notified of all errors, omissions and discrepancies between these documents and those of the others

4 Les dimensions sur ces documents doivent être lues et non mesurées. / The dimensions on these documents must be read and

STRUCTURE Structural Goodeve Structural Inc. 18-77, Auriga Drive, Ottawa ON K2E 7Z7 T 613 226 4558 goodevestructural.ca

ARCHITECTURE DE PAYSAGE Landscape Architect James B. Lennox & Associates 3332, Carling Avenue, Ottawa ON K2H 5A8 T 613 722 5168 jbla.ca

Novatech Eng. Consultants Ltd. 240, Michael Cowpland Drive, Suite 200, Ottawa ON K2M 1P6 T 613 234 9643 novatech-eng.com

ARCHITECTES Architect NEUF architect(e)s SENCRL 630, boul. René-Lévesque O. 32e étages, Montréal QC H3B 1S6 T 514 847 1117 NEUFarchitectes.com

SCEAU / Seal







OUVRAGE Project

#### **1200 MARITIME WAY** (KANATA RENTAL)

EMPLACEMENT Location OTTAWA

12371.00

ÉCHELLE Scale

1:300

NO	RÉVISION	DATE (aa-mm-jj)
Α	FOR COMMENTS	2020.05.28
В	FOR COMMENTS	2020.06.05
С	FOR COMMENTS	2020.07.23
D	IN PROGRESS	2020.09.16
Е	SITE PLAN COORDINATION	2020.12.08
F	SITE PLAN COORDINATION	2020.12.16
G	SITE PLAN COORDINATION	2021.02.22
Н	PER TRANSPORTATION COMMENTS	2021.05.18

DESSINÉ PAR Drawn by VÉRIFIÉ PAR Checked


05/28/20 TITRE DU DESSIN Drawing Title

SITE PLAN AT **GROUND FLOOR LEVEL** 

DATE (aa.mm.jj)

\*SNOW WILL BE HAULED OFF SITE\*

RÉVISION Revision NO. DESSIN Dwg Number

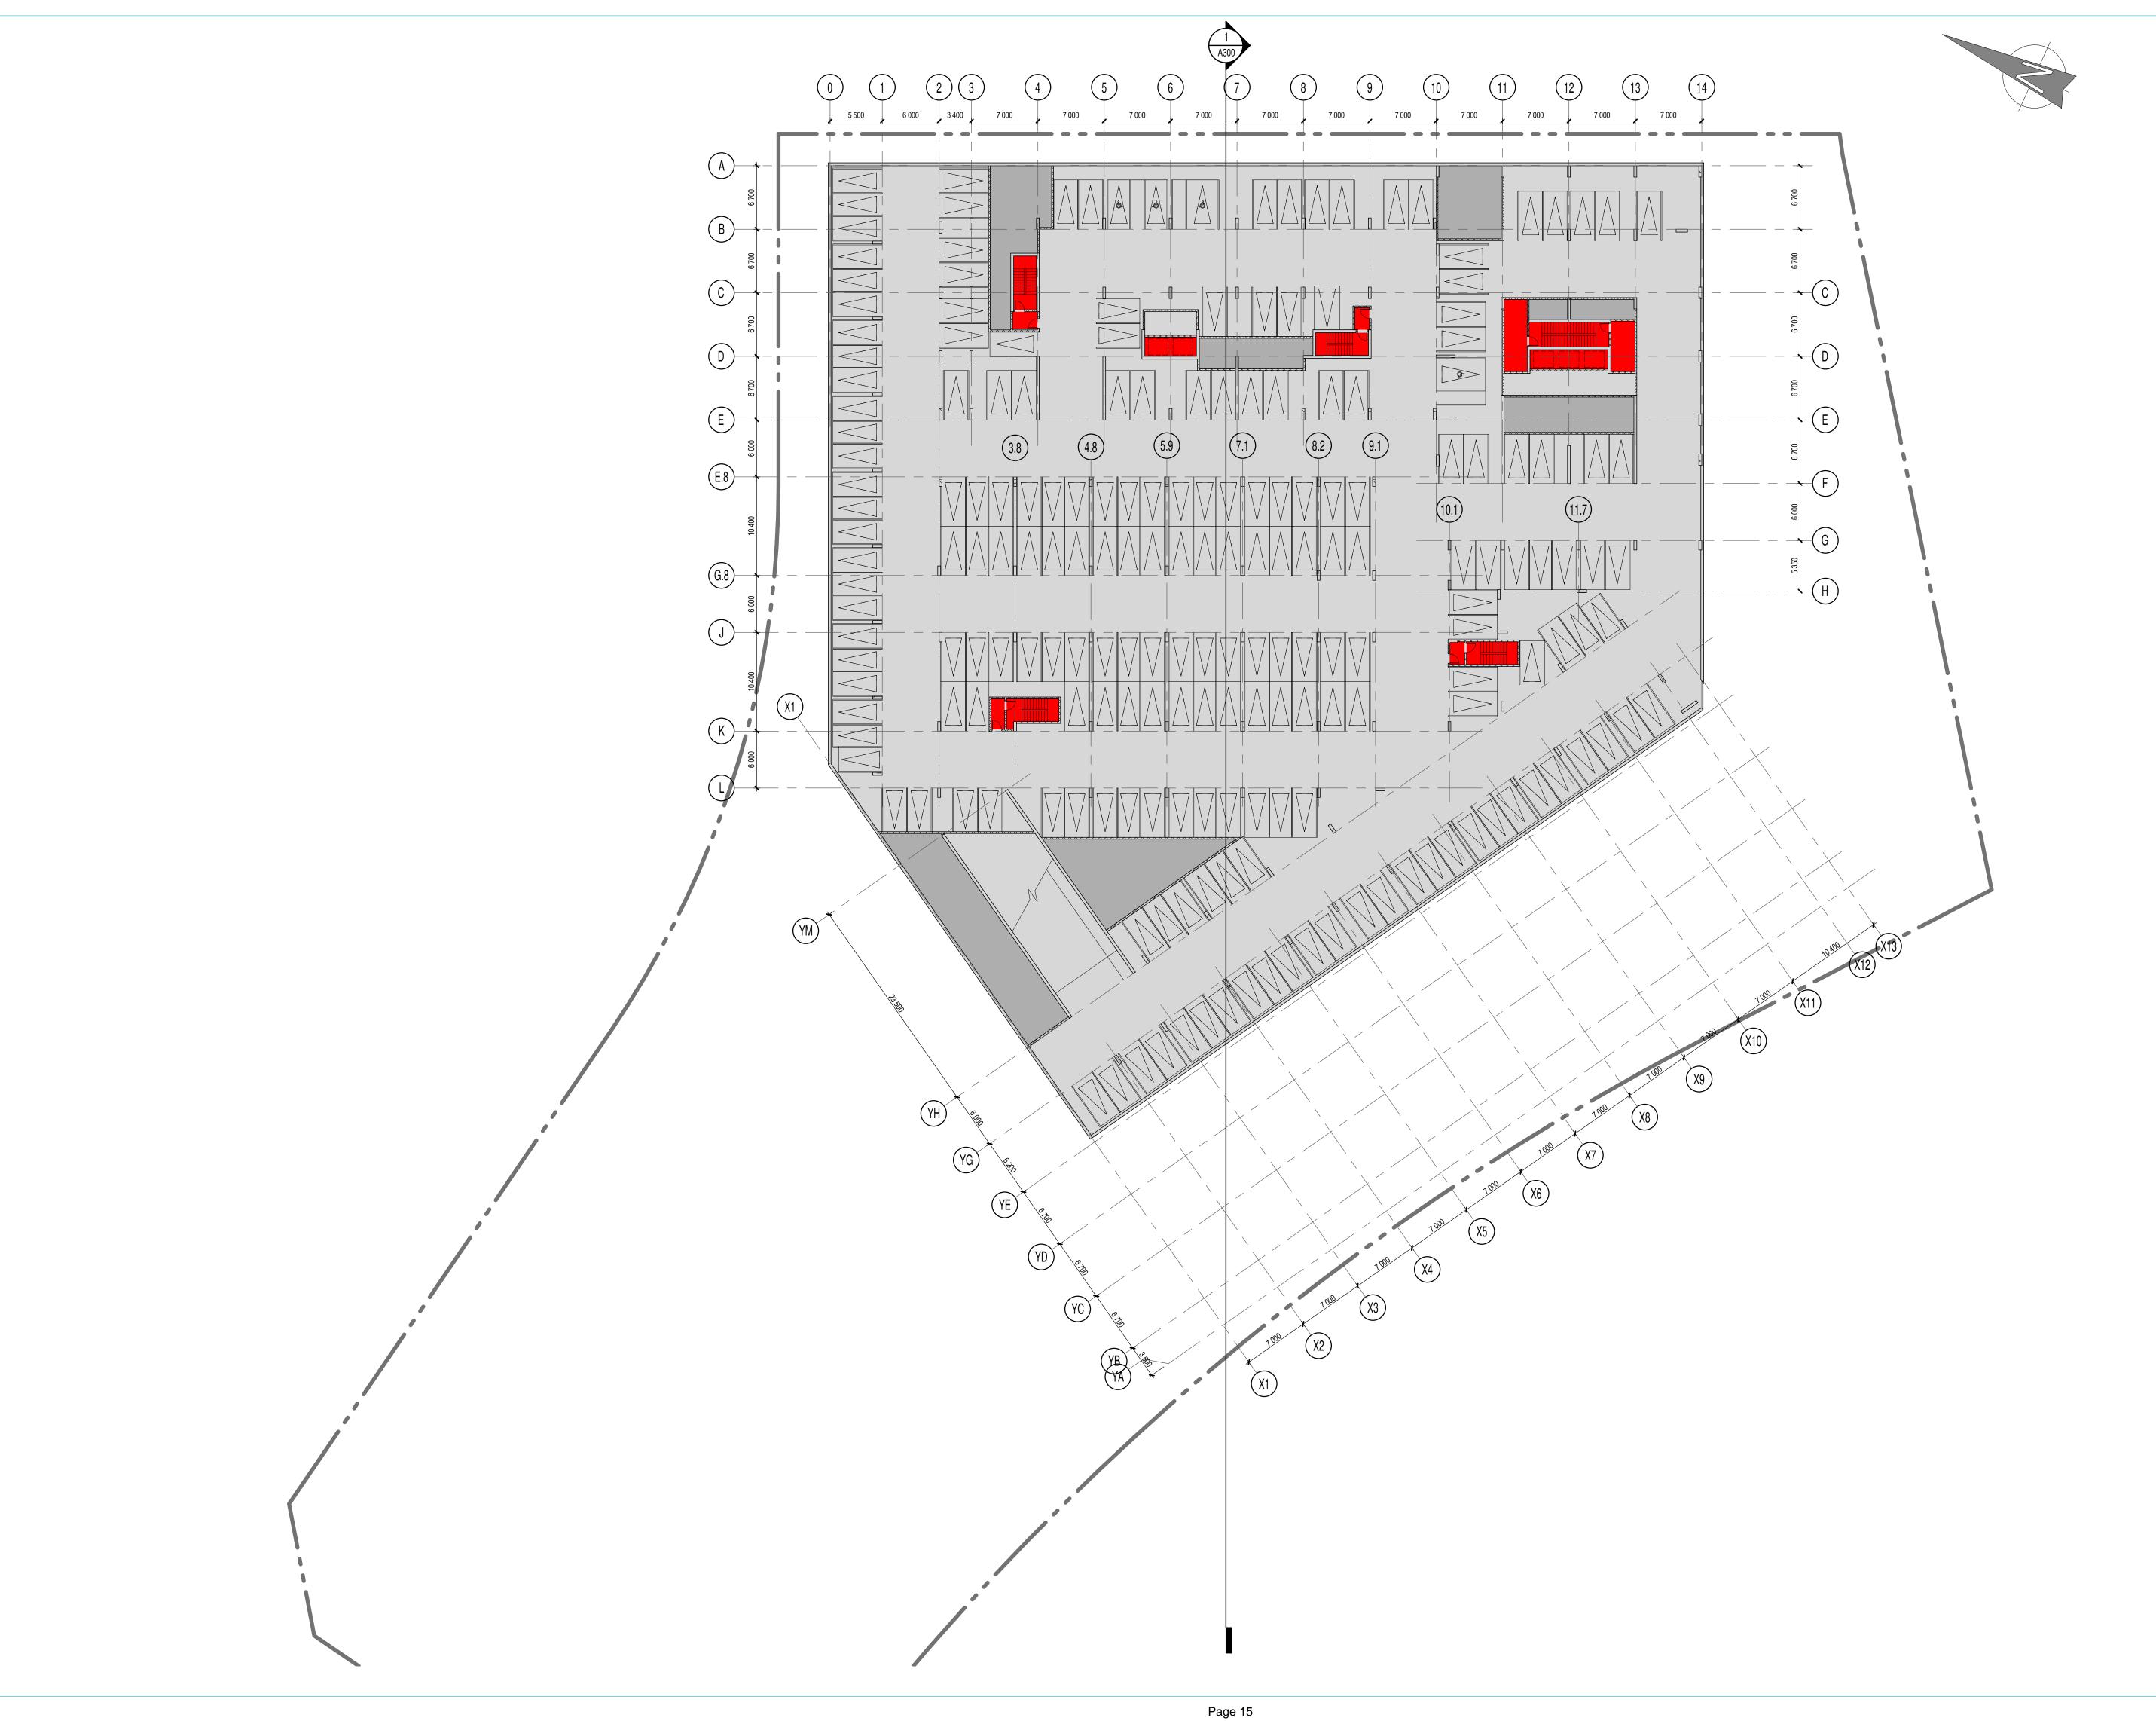

- 1 Ces documents d'architecture sont la propriété exclusive de
- NEUF architect(e)s et ne pourront être utilisés, reproduits ou copiés sans autorisation écrite préalable. / These architectural documents are the exclusive property of NEUF architect(e)s and cannot be used, copied or reproduced without written pre-authorisation

  Les dimensions apparaissant aux documents devront être vérifiées par l'entrepreneur avant le début des travaux. / All dimensions which appear on the documents must be verify by the contractor before to start the work.
- start the work.

  3 Veuillez aviser l'architecte de toute dimension erreur et/ou
  divergences entre ces documents et ceux des autres professionnels. /
  The architect must be notified of all errors, omissions and
  discrepancies between these documents and those of the others
  professionnals
- professionnals.

  4 Les dimensions sur ces documents doivent être lues et non
  . mesurées. / The dimensions on these documents must be read and
  not measured.

STRUCTURE Structural Goodeve Structural Inc.
18-77, Auriga Drive, Ottawa ON K2E 7Z7
T 613 226 4558 goodevestructural.ca

ARCHITECTURE DE PAYSAGE Landscape Architect James B. Lennox & Associates
3332, Carling Avenue, Ottawa ON K2H 5A8
T 613 722 5168 jbla.ca

Novatech Eng. Consultants Ltd. 240, Michael Cowpland Drive, Suite 200, Ottawa ON K2M 1P6 T 613 234 9643 novatech-eng.com

ARCHITECTES Architect **NEUF architect(e)s** SENCRL 630, boul. René-Lévesque O. 32e étages, Montréal QC H3B 1S6 T 514 847 1117 NEUFarchitectes.com

SCEAU / Seal







OUVRAGE Project

## **1200 MARITIME WAY** (KANATA RENTAL)

EMPLACEMENT Location OTTAWA

NO RÉVISION DATE (aa-mm-jj) 2020.07.23 2020.09.16 2020.12.08 2021.05.17 A FOR COMMENTS B IN PROGRESS C SITE PLAN COORDINATION
D FOR INFORMATION

NO PROJET No. 12371.00

ÉCHELLE Scale 1:300

DESSINÉ PAR Drawn by

VÉRIFIÉ PAR Checked LH DATE (aa.mm.jj) 07/22/20

TITRE DU DESSIN Drawing Title

**PARKING LEVEL 3** 



- 1 Ces documents d'architecture sont la propriété exclusive de NEUF architect(e)s et ne pourront être utilisés, reproduits ou copiés sans autorisation écrite préalable. / These architectural documents are the exclusive property of NEUF architect(e)s and cannot be used, copied or reproduced without written pre-authorisation

  Les dimensions apparaissant aux documents devront être vérifiées par l'entrepreneur avant le début des travaux. / All dimensions which appear on the documents must be verify by the contractor before to start the work.
- start the work.

  3 Veuillez aviser l'architecte de toute dimension erreur et/ou
  divergences entre ces documents et ceux des autres professionnels. /
  The architect must be notified of all errors, omissions and
  discrepancies between these documents and those of the others
  professionnals
- professionnals.

  4 Les dimensions sur ces documents doivent être lues et non
  . mesurées. / The dimensions on these documents must be read and
  not measured.

STRUCTURE Structural Goodeve Structural Inc.
18-77, Auriga Drive, Ottawa ON K2E 7Z7
T 613 226 4558 goodevestructural.ca

ARCHITECTURE DE PAYSAGE Landscape Architect James B. Lennox & Associates
3332, Carling Avenue, Ottawa ON K2H 5A8
T 613 722 5168 jbla.ca

Novatech Eng. Consultants Ltd. 240, Michael Cowpland Drive, Suite 200, Ottawa ON K2M 1P6 T 613 234 9643 novatech-eng.com

ARCHITECTES Architect NEUF architect(e)s SENCRL 630, boul. René-Lévesque O. 32e étages, Montréal QC H3B 1S6 T 514 847 1117 NEUFarchitectes.com

SCEAU / Seal







## **1200 MARITIME WAY** (KANATA RENTAL)

EMPLACEMENT Location
OTTAWA

NO RÉVISION DATE (aa-mm-jj)

NO PROJET No. 12371.00

Α	FOR COMMENTS	2020.05.28
В	FOR COMMENTS	2020.07.23
С	IN PROGRESS	2020.09.16
D	SITE PLAN COORDINATION	2020.12.08
Е	FOR INFORMATION	2021.05.17

VÉRIFIÉ PAR Checked LH DESSINÉ PAR Drawn by ÉCHELLE Scale 1:300

DATE (aa.mm.jj) 05/28/20 TITRE DU DESSIN Drawing Title

**PARKING LEVEL 2** 



- 1 Ces documents d'architecture sont la propriété exclusive de NEUF architect(e)s et ne pourront être utilisés, reproduits ou copiés sans autorisation écrite préalable. / These architectural documents are the exclusive property of NEUF architect(e)s and cannot be used, copied or reproduced without written pre-authorisation

  Les dimensions apparaissant aux documents devront être vérifiées par l'entrepreneur avant le début des travaux. / All dimensions which appear on the documents must be verify by the contractor before to start the work.
- start the work.

  3 Veuillez aviser l'architecte de toute dimension erreur et/ou
  divergences entre ces documents et ceux des autres professionnels. /
  The architect must be notified of all errors, omissions and
  discrepancies between these documents and those of the others
  professionnals
- professionnals.

  4 Les dimensions sur ces documents doivent être lues et non
  . mesurées. / The dimensions on these documents must be read and
  not measured.

STRUCTURE Structural Goodeve Structural Inc.
18-77, Auriga Drive, Ottawa ON K2E 7Z7
T 613 226 4558 goodevestructural.ca

ARCHITECTURE DE PAYSAGE Landscape Architect James B. Lennox & Associates 3332, Carling Avenue, Ottawa ON K2H 5A8 T 613 722 5168 jbla.ca

Novatech Eng. Consultants Ltd. 240, Michael Cowpland Drive, Suite 200, Ottawa ON K2M 1P6 T 613 234 9643 novatech-eng.com

ARCHITECTES Architect **NEUF architect(e)s** SENCRL 630, boul. René-Lévesque O. 32e étages, Montréal QC H3B 1S6 T 514 847 1117 NEUFarchitectes.com

SCEAU / Seal







## **1200 MARITIME WAY** (KANATA RENTAL)

EMPLACEMENT Location OTTAWA

NO RÉVISION

DATE (aa-mm-jj)

NO PROJET No. 12371.00

Α	FOR COMMENTS	2020.05.28
В	FOR COMMENTS	2020.06.05
С	FOR COMMENTS	2020.07.23
D	IN PROGRESS	2020.09.16
Ε	SITE PLAN COORDINATION	2020.12.08
F	FOR INFORMATION	2021.05.17

DESSINÉ PAR Drawn by

DATE (aa.mm.jj) 05/28/20 ÉCHELLE Scale 1:300 TITRE DU DESSIN Drawing Title

**PARKING LEVEL 1** 

NO. DESSIN Dwg Number

VÉRIFIÉ PAR Checked LH



1 Ces documents d'architecture sont la propriété exclusive de NEUF architect(e)s et ne pourront être utilisés, reproduits ou copiés sans autorisation écrite préalable. / These architectural documents are the exclusive property of NEUF architect(e)s and cannot be used, copied or reproduced without written pre-authorisation

2 Les dimensions apparaissant aux documents devront être vérifiées
par l'entrepreneur avant le début des travaux. / All dimensions which
appear on the documents must be verify by the contractor before to

start the work.

3 Veuillez aviser l'architecte de toute dimension erreur et/ou

divergences entre ces documents et ceux des autres professionnels. /
The architect must be notified of all errors, omissions and discrepancies between these documents and those of the others

professionnals.

4 Les dimensions sur ces documents doivent être lues et non
. mesurées. / The dimensions on these documents must be read and
not measured.

STRUCTURE Structural Goodeve Structural Inc. 18-77, Auriga Drive, Ottawa ON K2E 7Z7 T 613 226 4558 goodevestructural.ca

ARCHITECTURE DE PAYSAGE Landscape Architect James B. Lennox & Associates 3332, Carling Avenue, Ottawa ON K2H 5A8 T 613 722 5168 jbla.ca

CIVIL Civil Novatech Eng. Consultants Ltd. 240, Michael Cowpland Drive, Suite 200, Ottawa ON K2M 1P6 T 613 234 9643 novatech-eng.com

ARCHITECTES Architect **NEUF architect(e)s** SENCRL 630, boul. René-Lévesque O. 32e étages, Montréal QC H3B 1S6 T 514 847 1117 NEUFarchitectes.com

SCEAU / Seal







## **1200 MARITIME WAY** (KANATA RENTAL)

EMPLACEMENT Location
OTTAWA

NO PROJET No. 12371.00

NO	RÉVISION	DATE (aa-mm-jj)
Α	FOR COMMENTS	2020.05.28
В	FOR COMMENTS	2020.06.05
С	FOR COMMENTS	2020.07.23
D	IN PROGRESS	2020.09.16
Е	SITE PLAN COORDINATION	2020.12.08
F	FOR INFORMATION	2021.05.17

DESSINÉ PAR Drawn by

DATE (aa.mm.jj) 05/28/20 ÉCHELLE Scale 1:300

TITRE DU DESSIN Drawing Title LOWER TYPICAL FLOOR (3rd TO 7th)

NO. DESSIN Dwg Number

VÉRIFIÉ PAR Checked



1 Ces documents d'architecture sont la propriété exclusive de NEUF architect(e)s et ne pourront être utilisés, reproduits ou copiés sans autorisation écrite préalable. / These architectural documents are the exclusive property of NEUF architect(e)s and cannot be used, copied or reproduced without written pre-authorisation

Les dimensions apparaissant aux documents devront être vérifiées par l'entrepreneur avant le début des travaux. / All dimensions which appear on the documents must be verify by the contractor before to start the work.

start the work.

3 Veuillez aviser l'architecte de toute dimension erreur et/ou
divergences entre ces documents et ceux des autres professionnels. /
The architect must be notified of all errors, omissions and
discrepancies between these documents and those of the others
professionnals professionnals.

4 Les dimensions sur ces documents doivent être lues et non

mesurées. / The dimensions on these documents must be read and
not measured.

STRUCTURE Structural Goodeve Structural Inc.
18-77, Auriga Drive, Ottawa ON K2E 7Z7
T 613 226 4558 goodevestructural.ca

ARCHITECTURE DE PAYSAGE Landscape Architect James B. Lennox & Associates 3332, Carling Avenue, Ottawa ON K2H 5A8 T 613 722 5168 jbla.ca

Novatech Eng. Consultants Ltd. 240, Michael Cowpland Drive, Suite 200, Ottawa ON K2M 1P6 T 613 234 9643 novatech-eng.com

ARCHITECTES Architect **NEUF architect(e)s** SENCRL 630, boul. René-Lévesque O. 32e étages, Montréal QC H3B 1S6 T 514 847 1117 NEUFarchitectes.com

SCEAU / Seal







OUVRAGE Project

## **1200 MARITIME WAY** (KANATA RENTAL)

EMPLACEMENT Location
OTTAWA

NO RÉVISION

NO PROJET No. 12371.00 DATE (aa-mm-jj)

Α	FOR COMMENTS	2020.05.28
В	FOR COMMENTS	2020.06.05
С	FOR COMMENTS	2020.07.23
D	IN PROGRESS	2020.09.16
Ε	SITE PLAN COORDINATION	2020.12.08
F	FOR INFORMATION	2021.05.17

DESSINÉ PAR Drawn by

DATE (aa.mm.jj) 05/28/20 TITRE DU DESSIN Drawing Title

ÉCHELLE Scale 1:300

**UPPER TYPICAL FLOOR** (8th TO 28th / 30th)

VÉRIFIÉ PAR Checked LH

	EXTERIOR FINISH LEGEND	_
NOTE	DESCRIPTION	
Α	MASONRY VENEER BRICK - BEIGE	
В	MASONRY VENEER BRICK - CHARCOAL	
С	SEALED THERMAL UNIT / ALUMINUM FRAME	
D	GLASS SPANDREL PANEL	
Е	METAL PANEL CLADDING	
F	ALUMINUM GUARD RAIL WITH TEMPERED GLASS	
G	MASONRY VENEER ARTIFICIAL STONE	

METAL SIDING



WEST TOWER - West Elevation

NOTES GÉNÉRALES General Notes

1 Ces documents d'architecture sont la propriété exclusive de NEUF architect(e)s et ne pourront être utilisés, reproduits ou copiés sans autorisation écrite préalable: / These architectural documents are

the exclusive property of NEUF architect(e)s and cannot be used, copied or reproduced without written pre-authorisation 2 Les dimensions apparaissant aux documents devront être vérifiées par l'entrepreneur avant le début des travaux. / All dimensions which appear on the documents must be verify by the contractor before to

3 Veuillez aviser l'architecte de toute dimension erreur et/ou divergences entre ces documents et ceux des autres professionnels. / The architect must be notified of all errors, omissions and

discrepancies between these documents and those of the others 4 Les dimensions sur ces documents doivent être lues et non mesurées. / The dimensions on these documents must be read and

STRUCTURE Structural Goodeve Structural Inc. 18-77, Auriga Drive, Ottawa ON K2E 7Z7 T 613 226 4558 goodevestructural.ca

ARCHITECTURE DE PAYSAGE Landscape Architect James B. Lennox & Associates 3332, Carling Avenue, Ottawa ON K2H 5A8 T 613 722 5168 jbla.ca

CIVIL Civil Novatech Eng. Consultants Ltd. 240, Michael Cowpland Drive, Suite 200, Ottawa ON K2M 1P6 T 613 234 9643 novatech-eng.com

ARCHITECTES Architect NEUF architect(e)s SENGRL 630, boul. René-Lévesque O. 32e étages, Montréal QC H3B 1S6 T 514 847 1117 NEUFarchitectes.com

SCEAU / Seal







OUVRAGE Project

#### **1200 MARITIME WAY** (KANATA RENTAL)

EMPLACEMENT Location OTTAWA

NO PROJET No. 12371.00

NO	RÉVISION		DATE (aa-mm
Α	SITE PLAN COO	ORDINATION	2020.12.0
В	SITE PLAN COO	ORDINATION	2020.12.1
	+ *		
	* .		
		in the second	
	•		
	* •		
	•	g e totalisa	
		*********	

VÉRIFIÉ PAR Checked DEC 2020

TITRE DU DESSIN Drawing Title **WEST TOWER** 

**WEST ELEVATION** 

NO. DESSIN Dwg Number A400

ÉCHELLE Scale

1:200



|MASONRY VENEER BRICK - BEIGE

GLASS SPANDREL PANEL

METAL PANEL CLADDING

|METAL SIDING

|MASONRY VENEER BRICK - CHARCOAL

MASONRY VENEER ARTIFICIAL STONE

|SEALED THERMAL UNIT / ALUMINUM FRAME

ALUMINUM GUARD RAIL WITH TEMPERED GLASS

DESCRIPTION

NOTES GÉNÉRALES General Notes

1 Ces documents d'architecture sont la propriété exclusive de NEUF architect(e)s et ne pourront être utilisés, reproduits ou copiés sans autorisation écrite préalable. / These architectural documents are

the exclusive property of NEUF architect(e)s and cannot be used, copied or reproduced without written pre-authorisation 2 Les dimensions apparaissant aux documents devront être vérifiées

par l'entrepreneur avant le début des travaux. / All dimensions which appear on the documents must be verify by the contractor before to

Veuillez aviser l'architecte de toute dimension erreur et/ou divergences entre ces documents et ceux des autres professionnels. /

The architect must be notified of all errors, omissions and discrepancies between these documents and those of the others

4 Les dimensions sur ces documents doivent être lues et non mesurées. / The dimensions on these documents must be read and

STRUCTURE Structural Goodeve Structural Inc. 18-77, Auriga Drive, Ottawa ON K2E 7Z7 T 613 226 4558 goodevestructural.ca

ARCHITECTURE DE PAYSAGE Landscape Architect James B. Lennox & Associates 3332, Carling Avenue, Ottawa ON K2H 5A8 T 613 722 5168 jbla.ca

CIVIL Civil Novatech Eng. Consultants Ltd. 240, Michael Cowpland Drive, Suite 200, Ottawa ON K2M 1P6 T 613 234 9643 novatech-eng.com

ARCHITECTES Architect NEUF architect(e)s seneral 630, boul. René-Lévesque O. 32e étages, Montréal QC H3B 1S6 T 514 847 1117 NEUFarchitectes.com

SCEAU / Seal





OUVRAGE Project

#### **1200 MARITIME WAY** (KANATA RENTAL)

EMPLACEMENT Location OTTAWA

NO PROJET No. 12371.00

VÉRIFIÉ PAR Checked

ÉCHELLE Scale

1:200

NO	RÉVISION		DATE (aa-mm-
Α	SITE PLAN COO	ORDINATION	2020.12.08
В	SITE PLAN COO	ORDINATION	2020.12.16
	4.5		
	٠.		
	• •		
	•		
		************	

DESSINÉ PAR Drawn by

DATE (aa.mm.jj) 12/08/20 TITRE DU DESSIN Drawing Title

**WEST TOWER** 

**NORTH & SOUTH ELEV.** 

RÉVISION Revision NO. DESSIN Dwg Number **A40**1



MASONRY VENEER BRICK - BEIGE

GLASS SPANDREL PANEL

METAL PANEL CLADDING

METAL SIDING

D

MASONRY VENEER BRICK - CHARCOAL

MASONRY VENEER ARTIFICIAL STONE

SEALED THERMAL UNIT / ALUMINUM FRAME

ALUMINUM GUARD RAIL WITH TEMPERED GLASS

DESCRIPTION

NOTES GÉNÉRALES General Notes

1 Ces documents d'architecture sont la propriété exclusive de

 NEUF architect(e)s et ne pourront être utilisés; reproduits ou copiés sans autorisation écrite préalable. / These architectural documents are the exclusive property of NEUF architect(e)s and cannot be used,

copied or reproduced without written pre-authorisation 2 Les dimensions apparaissant aux documents devront être vérifiées

par l'entrepreneur avant le début des travaux. / All dimensions which appear on the documents must be verify by the contractor before to

3 Veuillez aviser l'architecte de toute dimension erreur et/ou divergences entre ces documents et ceux des autres professionnels. / The architect must be notified of all errors, omissions and

discrepancies between these documents and those of the others 4 Les dimensions sur ces documents doivent être lues et non mesurées. / The dimensions on these documents must be read and

STRUCTURE Structural Goodeve Structural Inc. 18-77, Auriga Drive, Ottawa ON K2E 7Z7 T 613 226 4558 goodevestructural.ca

ARCHITECTURE DE PAYSAGE Landscape Architect James B. Lennox & Associates 3332, Carling Avenue, Ottawa ON K2H 5A8 T 613 722 5168 jbla.ca

CIVIL Civil Novatech Eng. Consultants Ltd.

T 613 234 9643 novatech-eng.com

ARCHITECTES Architect NEUF architect(e)s seneral 630, boul. René-Lévesque O. 32e étages, Montréal QC H3B 1S6 T 514 847 1117 NEUFarchitectes.com

SCEAU / Seal







OUVRAGE Project

## **1200 MARITIME WAY** (KANATA RENTAL)

EMPLACEMENT Location OTTAWA

12371.00

NO PROJET No.

ÉCHELLE Scale

1:200

NO RÉVISION DATE (aa-mm-jj) A SITE PLAN COORDINATION 2020.12.08 B SITE PLAN COORDINATION

VÉRIFIÉ PAR Checked 12/08/20

**WEST TOWER** 

**EAST ELEVATION** 

TITRE DU DESSIN Drawing Title

RÉVISION Revision NO. DESSIN Dwg Number A402



MASONRY VENEER BRICK - BEIGE

GLASS SPANDREL PANEL

METAL PANEL CLADDING

METAL SIDING

|MASONRY VENEER BRICK - CHARCOAL

MASONRY VENEER ARTIFICIAL STONE

|SEALED THERMAL UNIT / ALUMINUM FRAME

ALUMINUM GUARD RAIL WITH TEMPERED GLASS

NOTE

DESCRIPTION

NOTES GÉNÉRALES General Notes

1 Ces documents d'architecture sont la propriété exclusive de NEUF architect(e)s et ne pourront être utilisés, reproduits ou copiés sans autorisation écrite préalable. / These architectural documents are

the exclusive property of NEUF architect(e)s and cannot be used, copied or reproduced without written pre-authorisation 2 Les dimensions apparaissant aux documents devront être vérifiées

par l'entrepreneur avant le début des travaux. / All dimensions which appear on the documents must be verify by the contractor before to

3 Veuillez aviser l'architecte de toute dimension erreur et/ou divergences entre ces documents et ceux des autres professionnels. / The architect must be notified of all errors, omissions and discrepancies between these documents and those of the others

4 Les dimensions sur ces documents doivent être lues et non

mesurées. / The dimensions on these documents must be read and

STRUCTURE Structural Goodeve Structural Inc. 18-77, Auriga Drive, Ottawa ON K2E 7Z7 T 613 226 4558 goodevestructural.ca

ARCHITECTURE DE PAYSAGE Landscape Architect James B. Lennox & Associates 3332, Carling Avenue, Ottawa ON K2H 5A8 T 613 722 5168 jbla.ca

CIVIL Civil Novatech Eng. Consultants Ltd. 240, Michael Cowpland Drive, Suite 200, Ottawa ON K2M 1P6 T 613 234 9643 novatech-eng.com

ARCHITECTES Architect NEUF architect(e)s seneral 630, boul. René-Lévesque O. 32e étages, Montréal QC H3B 1S6 T 514 847 1117 NEUFarchitectes.com

SCEAU / Seal







OUVRAGE Project

## **1200 MARITIME WAY** (KANATA RENTAL)

EMPLACEMENT Location OTTAWA

NO PROJET No. 12371.00

ÉCHELLE Scale

1:200

NO RÉVISION DATE (aa-mm-jj) A SITE PLAN COORDINATION 2020.12.08 B SITE PLAN COORDINATION

DESSINÉ PAR Drawn by

TITRE DU DESSIN Drawing Title

VÉRIFIÉ PAR Checked DATE (aa.mm.jj) 12/08/20

**EAST TOWER WEST ELEVATION** 



|MASONRY VENEER BRICK - BEIGE

GLASS SPANDREL PANEL

METAL PANEL CLADDING

|METAL SIDING

|MASONRY VENEER BRICK - CHARCOAL

MASONRY VENEER ARTIFICIAL STONE

|SEALED THERMAL UNIT / ALUMINUM FRAME

ALUMINUM GUARD RAIL WITH TEMPERED GLASS

DESCRIPTION

NOTES GÉNÉRALES General Notes

Ces documents d'architecture sont la propriété exclusive de
 NEUF architect(e)s et ne pourroit être utilisés; reproduits ou copiés
 serve exteriorité précible y (Elbert, Though documents et le la comment de la comme

sans autorisation écrite préalable. / These architectural documents are the exclusive property of NEUF architect(e)s and cannot be used, copied or reproduced without written pre-authorisation.

2 Les dimensions apparaissant aux documents devront être vérifiées.

copied or reproduced without written pre-authorisation

2 Les dimensions apparaissant aux documents devront être vérifiées
par l'entrepreneur avant le début des travaux. / All dimensions which
appear on the documents must be verify by the contractor before to

appear on the documents must be verify by the contractor before to start the work.

3 Veuillez aviser l'architecte de toute dimension erreur et/ou divergences entre ces documents et ceux des autres professionnels.

divergences entre ces documents et ceux des autres professionn
 The architect must be notified of all errors, omissions and
 discrepancies between these documents and those of the others
 professionnals.

discrepancies between these documents and those of the others professionnals.

4 Les dimensions sur ces documents doivent être lues et non mesurées. / The dimensions on these documents must be read and

STRUCTURE Structural

Goodeve Structural Inc.

18-77, Auriga Drive, Ottawa ON K2E 7Z7
T 613 226 4558 goodevestructural.ca

ARCHITECTURE DE PAYSAGE Landscape Architect

James B. Lennox & Associates
3332, Carling Avenue, Ottawa ON K2H 5A8
T 613 722 5168 jbla.ca

Novatech Eng. Consultants Ltd. 240, Michael Cowpland Drive, Suite 200, Ottawa ON K2M 1P6 T 613 234 9643 novatech-eng.com

ARCHITECTES Architect

NEUF architect(e)S SENCRL

630, boul. René-Lévesque O. 32e étages, Montréal QC H3B 1S6
T 514 847 1117 NEUFarchitectes.com

SCEAU / Seal

CIVIL Civil





CLIENT Clien



OUVRAGE Project

## 1200 MARITIME WAY (KANATA RENTAL)

EMPLACEMENT Location
OTTAWA

NO PROJET No. 12371.00

VÉRIFIÉ PAR Checked

ÉCHELLE Scale

1:200

NO RÉVISION DATE (aa-mm-jj)

A SITE PLAN COORDINATION 2020.12.08

B SITE PLAN COORDINATION 2020.12.16

DESSINÉ PAR Drawn by
MH

DATE (aa.mm.jj)

12/08/20

EAST TOWER

NORTH & SOUTH ELEV.

RÉVISION Revision

DN Revision NO. DESSIN Dwg Number  $\mathbb{A}404$ 



|MASONRY VENEER BRICK - BEIGE

GLASS SPANDREL PANEL

METAL PANEL CLADDING

METAL SIDING

MASONRY VENEER BRICK - CHARCOAL

MASONRY VENEER ARTIFICIAL STONE

SEALED THERMAL UNIT / ALUMINUM FRAME

ALUMINUM GUARD RAIL WITH TEMPERED GLASS

DESCRIPTION

NOTE

EAST TOWER - East Elevation

1:200



NOTES GÉNÉRALES General Notes

1 Ces documents d'architecture sont la propriété exclusive de NEUF architect(e)s et ne pourront être utilisés; reproduits ou copiés sans autorisation écrite préalable: / These architectural documents are

the exclusive property of NEUF architect(e)s and cannot be used, copied or reproduced without written pre-authorisation

2 Les dimensions apparaissant aux documents devront être vérifiées par l'entrepreneur avant le début des travaux. / All dimensions which appear on the documents must be verify by the contractor before to

par l'entrepreneur avant le début des travaux. / All dimensions which appear on the documents must be verify by the contractor before to start the work.
3 Veuillez aviser l'architecte de toute dimension erreur et/ou

3 Veuillez aviser l'architecte de toute dimension erreur et/ou divergences entre ces documents et ceux des autres professionnels. / The architect must be notified of all errors, omissions and discrepancies between these documents and those of the others

Les dimensions sur ces documents doivent être lues et non mesurées. / The dimensions on these documents must be read and not measured.

STRUCTURE Structural

Goodeve Structural Inc.
18-77, Auriga Drive, Ottawa ON K2E 7Z7
T 613 226 4558 goodevestructural.ca

ARCHITECTURE DE PAYSAGE Landscape Architect

James B. Lennox & Associates
3332, Carling Avenue, Ottawa ON K2H 5A8
T 613 722 5168 jbla.ca

CIVIL Civil

Novatech Eng. Consultants Ltd.
240, Michael Cowpland Drive, Suite 200, Ottawa ON K2M 1P6
T 613 234 9643 novatech-eng.com

ARCHITECTES Architect

NEUF architect(e)s SENCRL
630, boul. René-Lévesque O. 32e étages, Montréal QC H3B 1S6
T 514 847 1117 NEUFarchitectes.com

SCEAU / Seal

NEUF



CLIENT Clien



OUVRAGE Project

1200 MARITIME WAY (KANATA RENTAL)

EMPLACEMENT Location
OTTAWA

NO PROJET No. 12371.00

VÉRIFIÉ PAR Checked

ÉCHELLE Scale

1:200

NO RÉVISION DATE (aa-mm-jj)

A SITE PLAN COORDINATION 2020.12.08

B SITE PLAN COORDINATION 2020.12.16


DESSINÉ PAR Drawn by MH

DATE (aa.mm.jj)
12/08/20

EAST TOWER

EAST TOWER
EAST ELEVATION

EVISION Revision NO. DESSIN Dwg Number A405

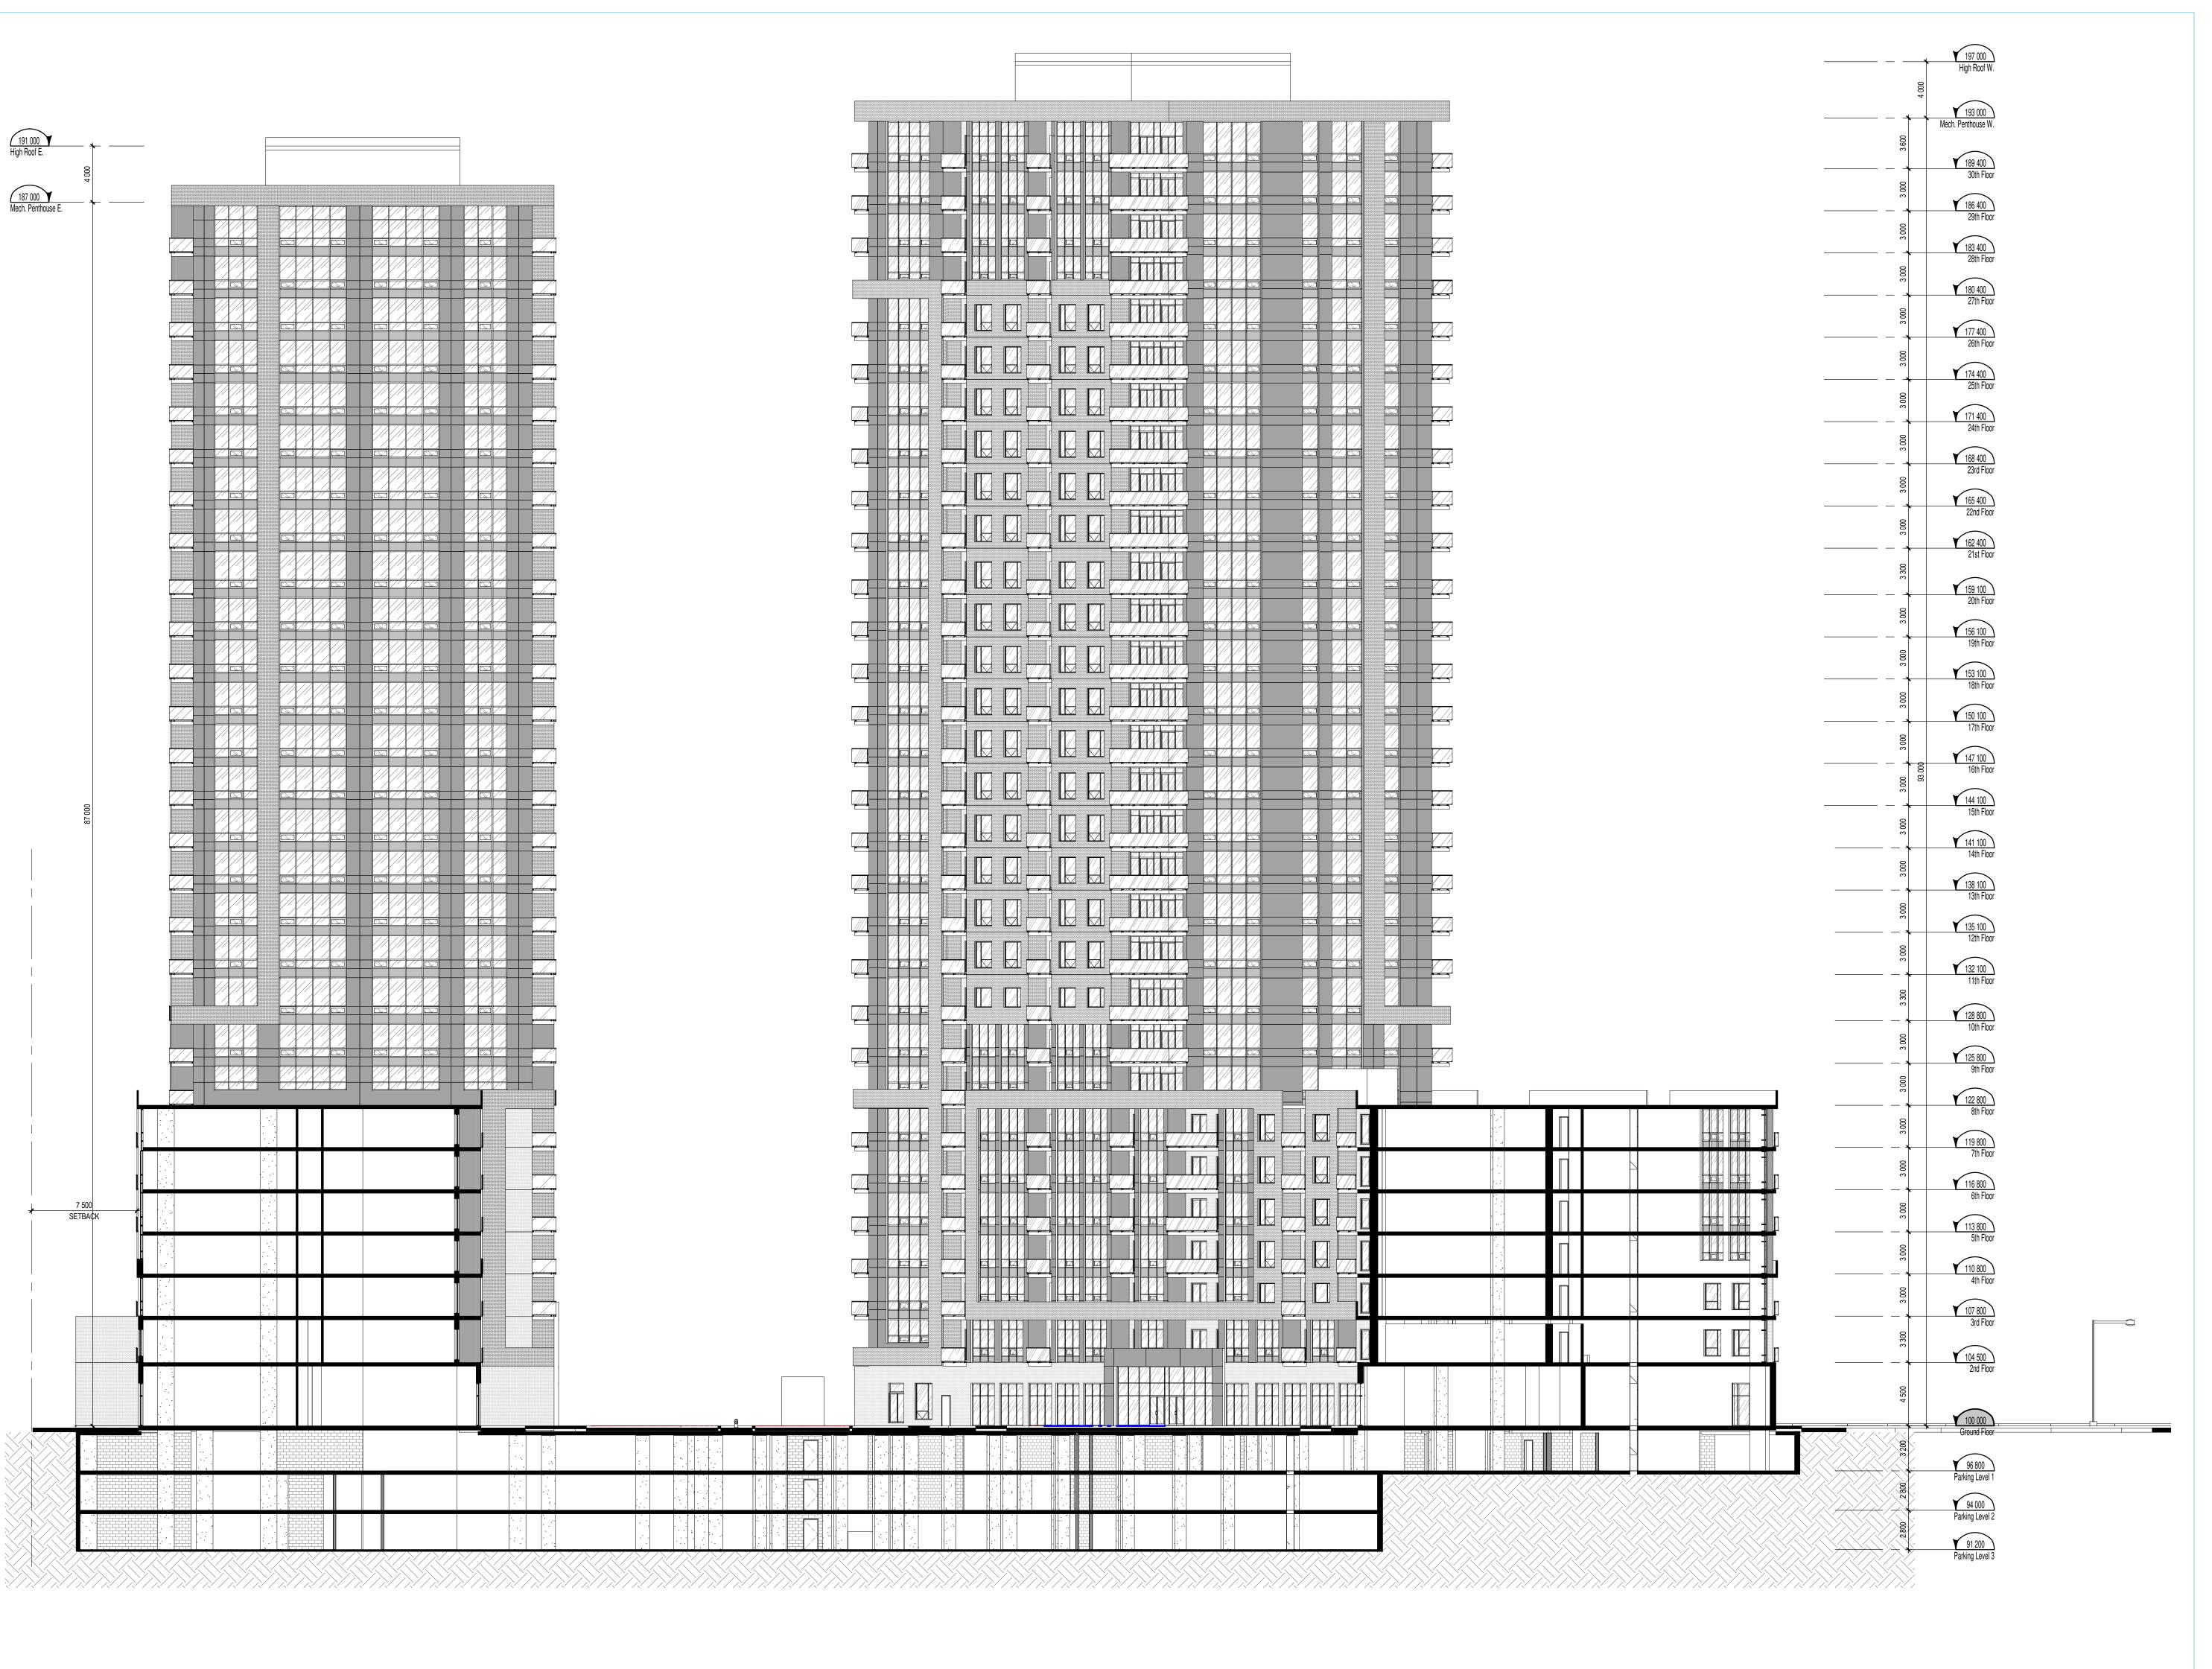

- 1 Ces documents d'architecture sont la propriété exclusive de NEUF architect(e)s et ne pourront être utilisés, reproduits ou copiés sans autorisation écrite préalable. / These architectural documents are the exclusive property of NEUF architect(e)s and cannot be used, copied or reproduced without written pre-authorisation
- 2 Les dimensions apparaissant aux documents devront être vérifiées . par l'entrepreneur avant le début des travaux. / All dimensions which appear on the documents must be verify by the contractor before to
- 3 Veuillez aviser l'architecte de toute dimension erreur et/ou
  divergences entre ces documents et ceux des autres professionnels. /
  The architect must be notified of all errors, omissions and discrepancies between these documents and those of the others
- Les dimensions sur ces documents doivent être lues et non mesurées. / The dimensions on these documents must be read and

STRUCTURE Structural Goodeve Structural Inc. 18-77, Auriga Drive, Ottawa ON K2E 7Z7 T 613 226 4558 goodevestructural.ca

ARCHITECTURE DE PAYSAGE Landscape Architect James B. Lennox & Associates 3332, Carling Avenue, Ottawa ON K2H 5A8 T 613 722 5168 jbla.ca

Novatech Eng. Consultants Ltd. 240, Michael Cowpland Drive, Suite 200, Ottawa ON K2M 1P6 T 613 234 9643 novatech-eng.com

ARCHITECTES Architect NEUF architect(e)s SENCRL 630, boul. René-Lévesque O. 32e étages, Montréal QC H3B 1S6 T 514 847 1117 NEUFarchitectes.com

SCEAU / Seal







OUVRAGE Project

## **1200 MARITIME WAY** (KANATA RENTAL)

EMPLACEMENT Location OTTAWA

12371.00

NO	RÉVISION	DATE (aa-mm-jj)
Α	FOR INFORMATION	2021.05.17

DESSINÉ PAR Drawn by


DATE (aa.mm.jj) NOV 2018 VÉRIFIÉ PAR Checked ÉCHELLE Scale 1:200

A300


TITRE DU DESSIN Drawing Title **BUILDING CROSS** 

**SECTION** 


RÉVISION Revision NO. DESSIN Dwg Number

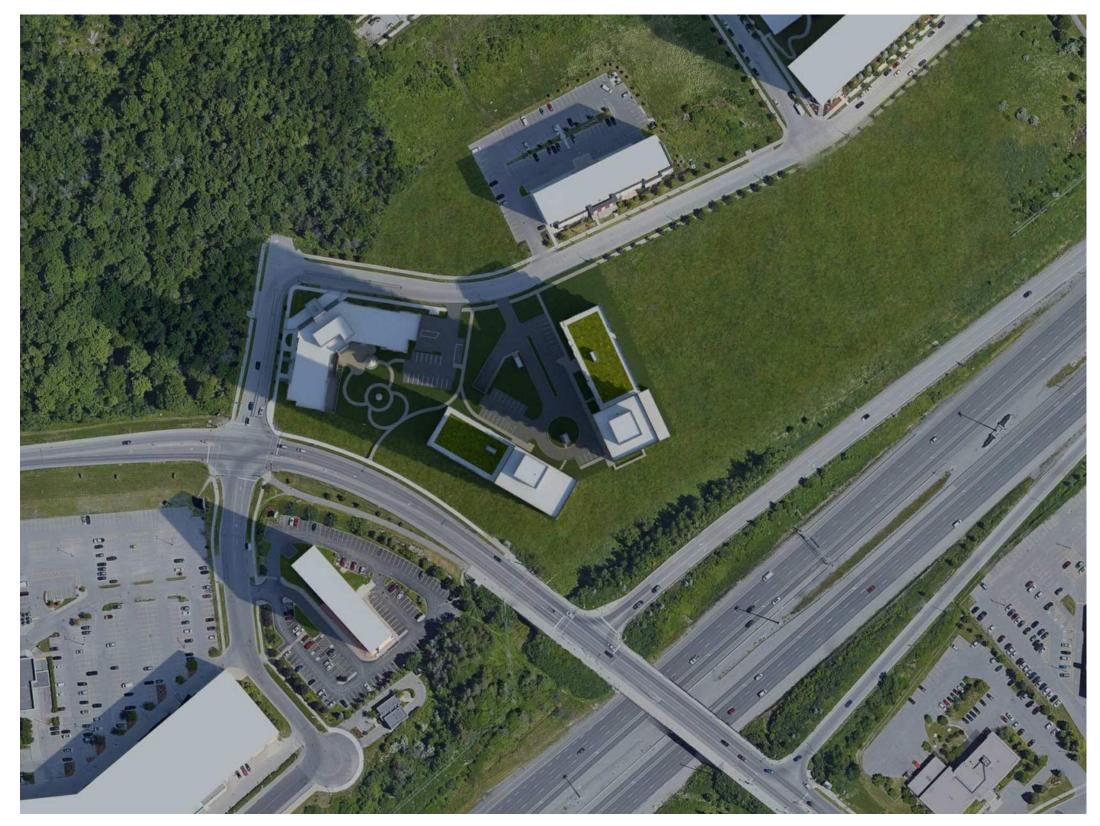


MARCH 21st 9:00 am

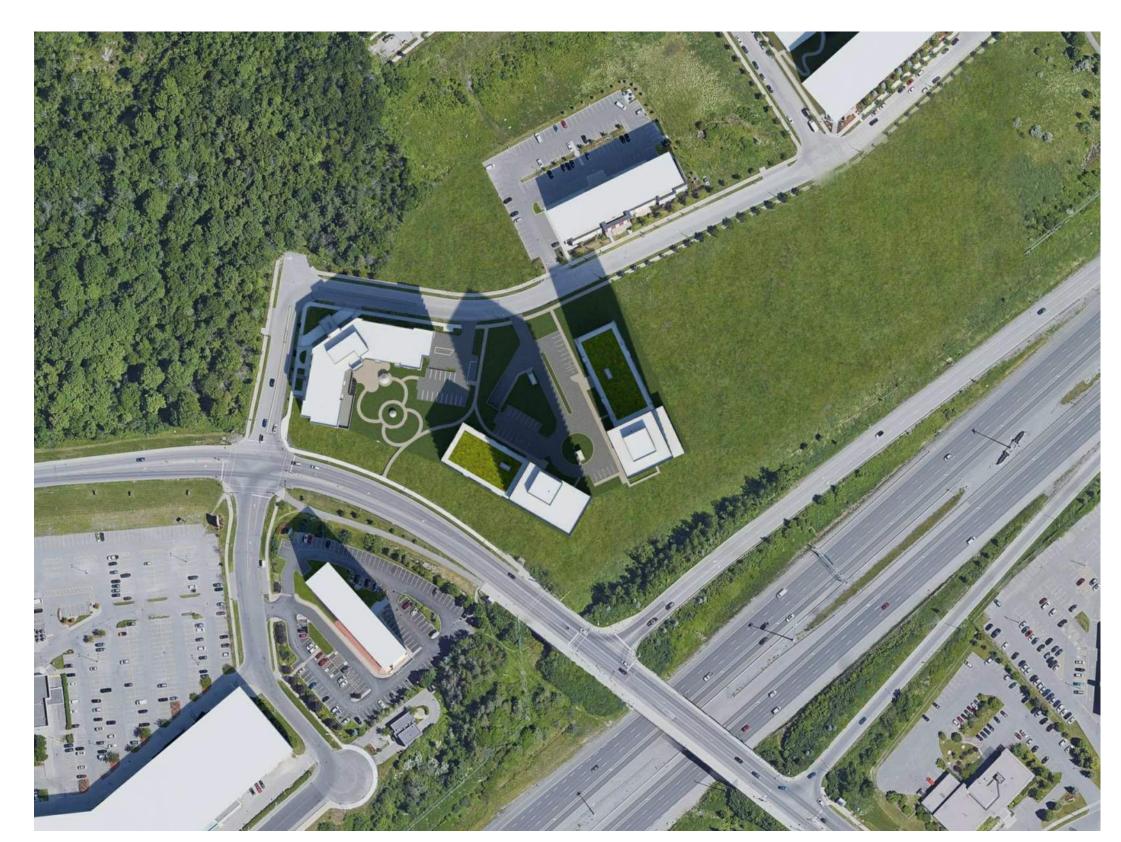

MARCH 21st 12:00 pm

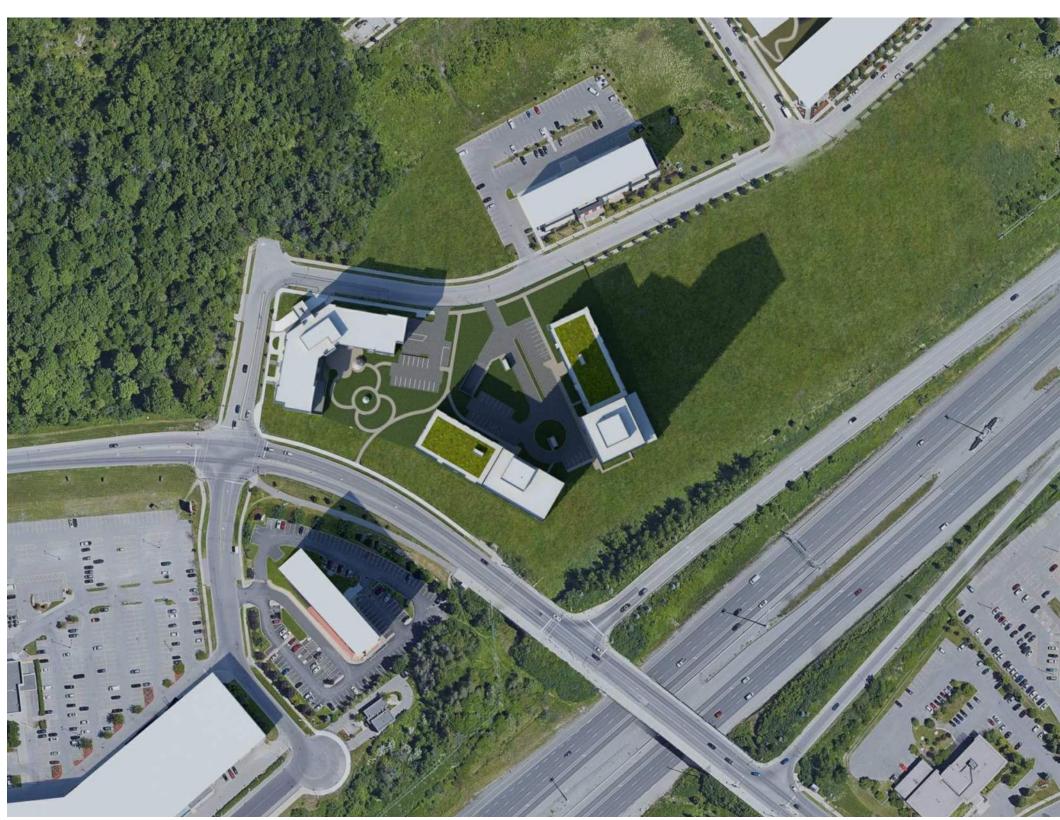

MARCH 21st 3:00 pm

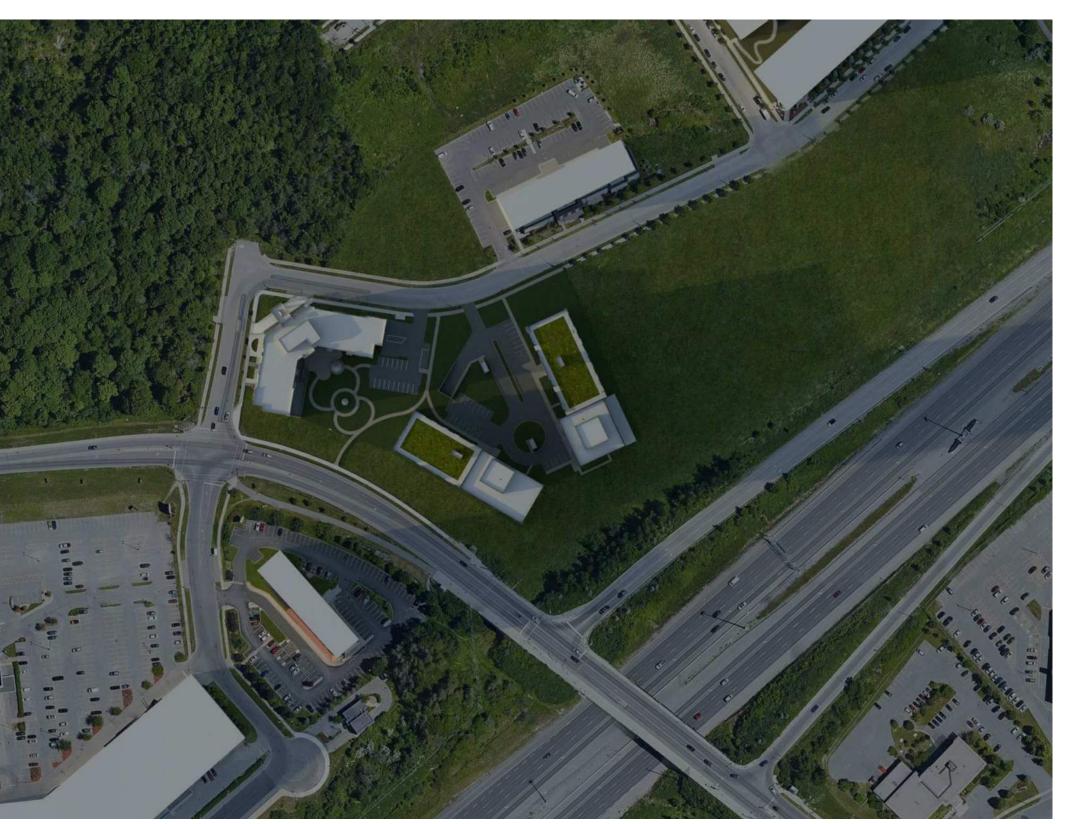

MARCH 21st 6:00 pm

- Ces documents d'architecture sont la propriété exclusive de
   NEUF architect(e)s et ne pourront être utilisés, reproduits ou copiés sans autorisation écrite préalable. / These architectural documents are the exclusive property of NEUF architect(e)s and cannot be used, copied or reproduced without written pre-authorisation

   Les dimensions apparaissant aux documents devront être vérifiées
   par l'entrepreneur avant le début des travaux. / All dimensions which appear on the documents must be verify by the contractor before to start the work.

   Veuillez aviser l'architecte de toute dimension erreur et/ou divergences entre ces documents et ceux des autres professionnels. / The architect must be notified of all errors, omissions and discrepancies between these documents and those of the others professionnals.
   Les dimensions sur ces documents doivent être lues et non mesurées. / The dimensions on these documents must be read and not measured.

STRUCTURE Structural Goodeve Structural Inc.
18-77, Auriga Drive, Ottawa ON K2E 7Z7
T 613 226 4558 goodevestructural.ca

ARCHITECTURE DE PAYSAGE Landscape Architect James B. Lennox & Associates
3332, Carling Avenue, Ottawa ON K2H 5A8
T 613 722 5168 jbla.ca

Novatech Eng. Consultants Ltd. 240, Michael Cowpland Drive, Suite 200, Ottawa ON K2M 1P6 T 613 234 9643 novatech-eng.com

ARCHITECTES Architect NEUF architect(e)s SENCRL 630, boul. René-Lévesque O. 32e étages, Montréal QC H3B 1S6 T 514 847 1117 NEUFarchitectes.com

SCEAU / Seal







## **1200 MARITIME WAY** (KANATA RENTAL)

EMPLACEMENT Location OTTAWA

NO PROJET No. 12371.00

NO RÉVISION

DESSINÉ PAR Drawn by

DATE (aa.mm.jj) 12/11/20

TITRE DU DESSIN Drawing Title


**SUN STUDY - MARCH** 

RÉVISION Revision

NO. DESSIN Dwg Number A1000

VÉRIFIÉ PAR Checked LH


ÉCHELLE Scale

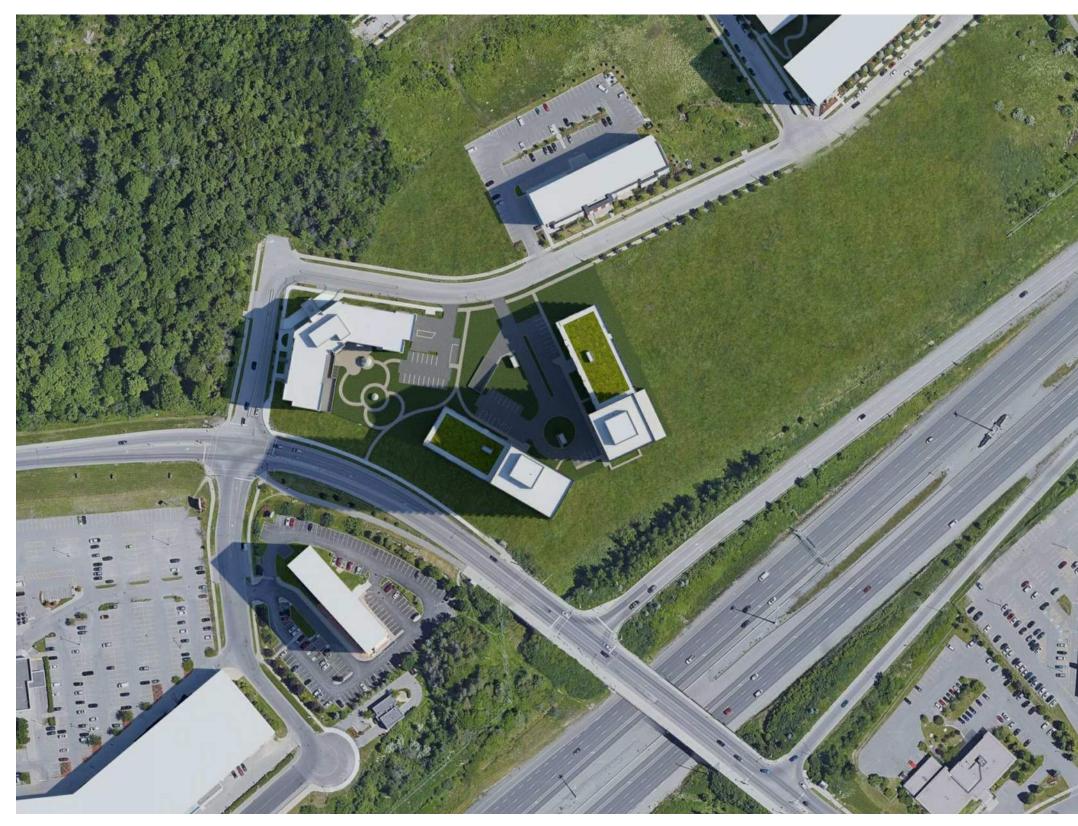






JUNE 21st 12:00 pm

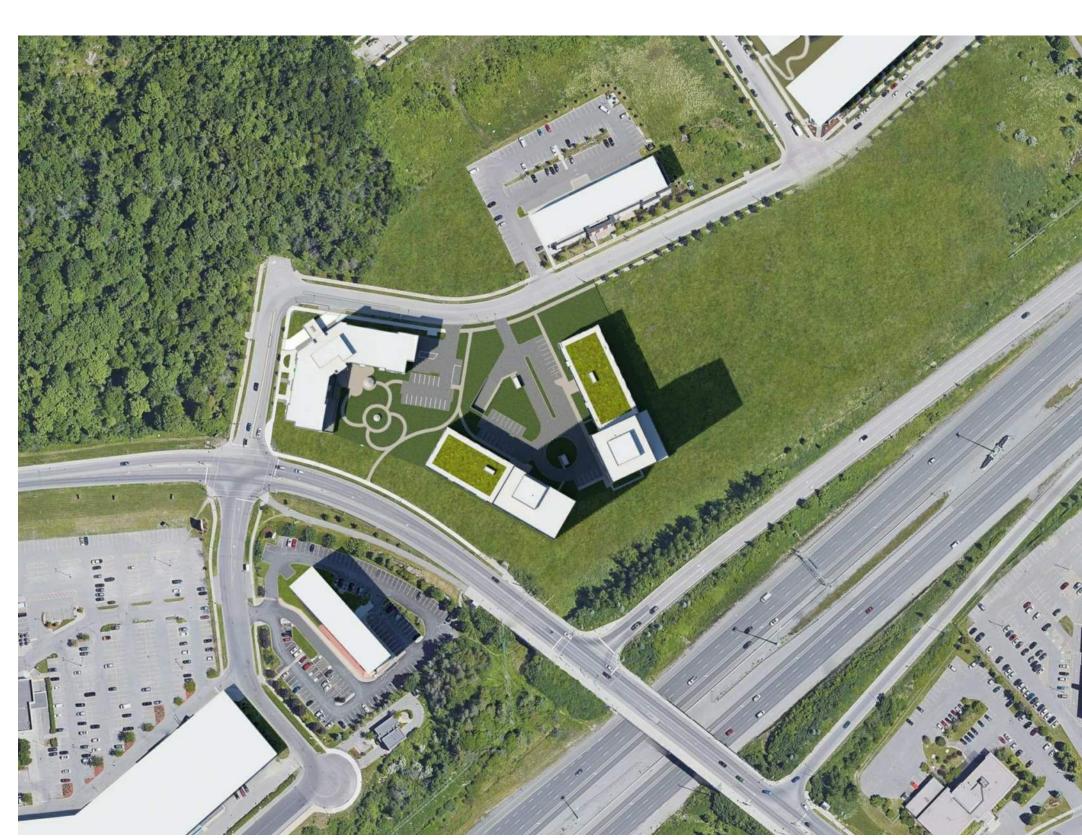

JUNE 21st 3:00 pm

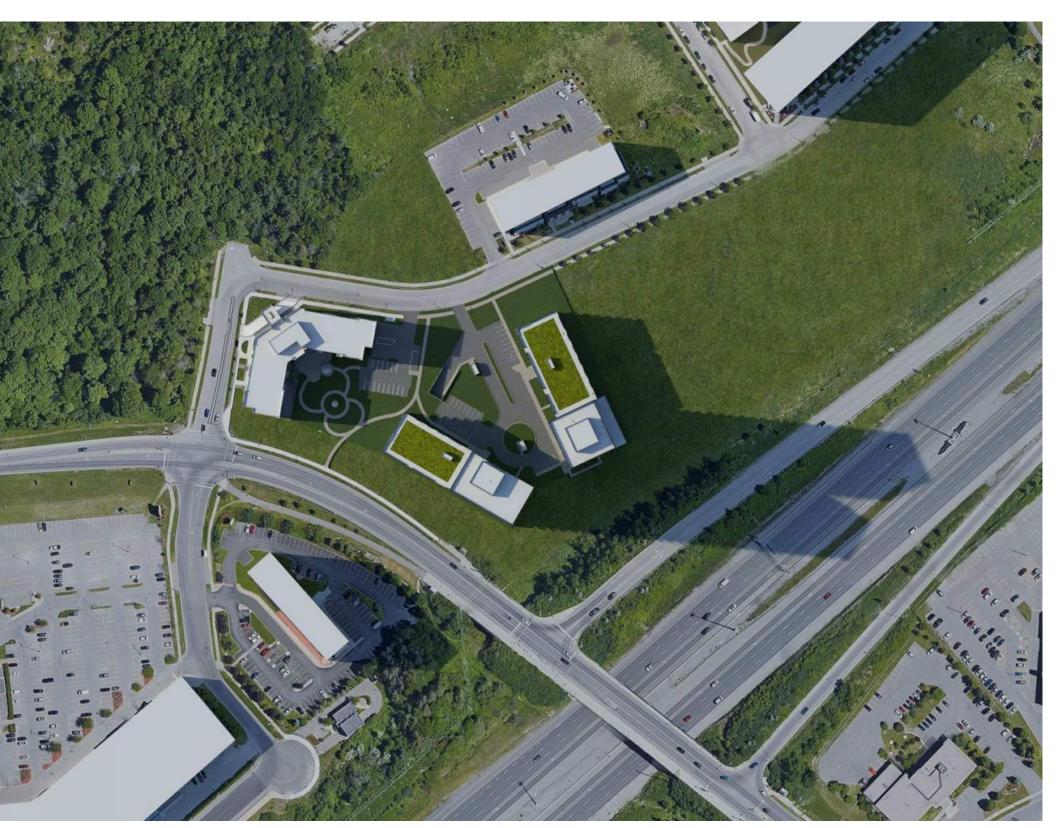

JUNE 21st 6:00 pm

- Ces documents d'architecture sont la propriété exclusive de
   NEUF architect(e)s et ne pourront être utilisés, reproduits ou copiés sans autorisation écrite préalable. / These architectural documents are the exclusive property of NEUF architect(e)s and cannot be used, copied or reproduced without written pre-authorisation

   Les dimensions apparaissant aux documents devront être vérifiées
   par l'entrepreneur avant le début des travaux. / All dimensions which appear on the documents must be verify by the contractor before to start the work.

   Veuillez aviser l'architecte de toute dimension erreur et/ou divergences entre ces documents et ceux des autres professionnels. / The architect must be notified of all errors, omissions and discrepancies between these documents and those of the others professionnals.
   Les dimensions sur ces documents doivent être lues et non mesurées. / The dimensions on these documents must be read and not measured.

STRUCTURE Structural Goodeve Structural Inc.
18-77, Auriga Drive, Ottawa ON K2E 7Z7
T 613 226 4558 goodevestructural.ca

ARCHITECTURE DE PAYSAGE Landscape Architect James B. Lennox & Associates
3332, Carling Avenue, Ottawa ON K2H 5A8
T 613 722 5168 jbla.ca

Novatech Eng. Consultants Ltd. 240, Michael Cowpland Drive, Suite 200, Ottawa ON K2M 1P6 T 613 234 9643 novatech-eng.com

ARCHITECTES Architect NEUF architect(e)s SENCRL 630, boul. René-Lévesque O. 32e étages, Montréal QC H3B 1S6 T 514 847 1117 NEUFarchitectes.com

SCEAU / Seal







## **1200 MARITIME WAY** (KANATA RENTAL)

EMPLACEMENT Location OTTAWA

NO RÉVISION

NO PROJET No. 12371.00

DESSINÉ PAR Drawn by


VÉRIFIÉ PAR Checked LH ÉCHELLE Scale

DATE (aa.mm.jj) 12/11/20


TITRE DU DESSIN Drawing Title

**SUN STUDY - JUNE** 


RÉVISION Revision

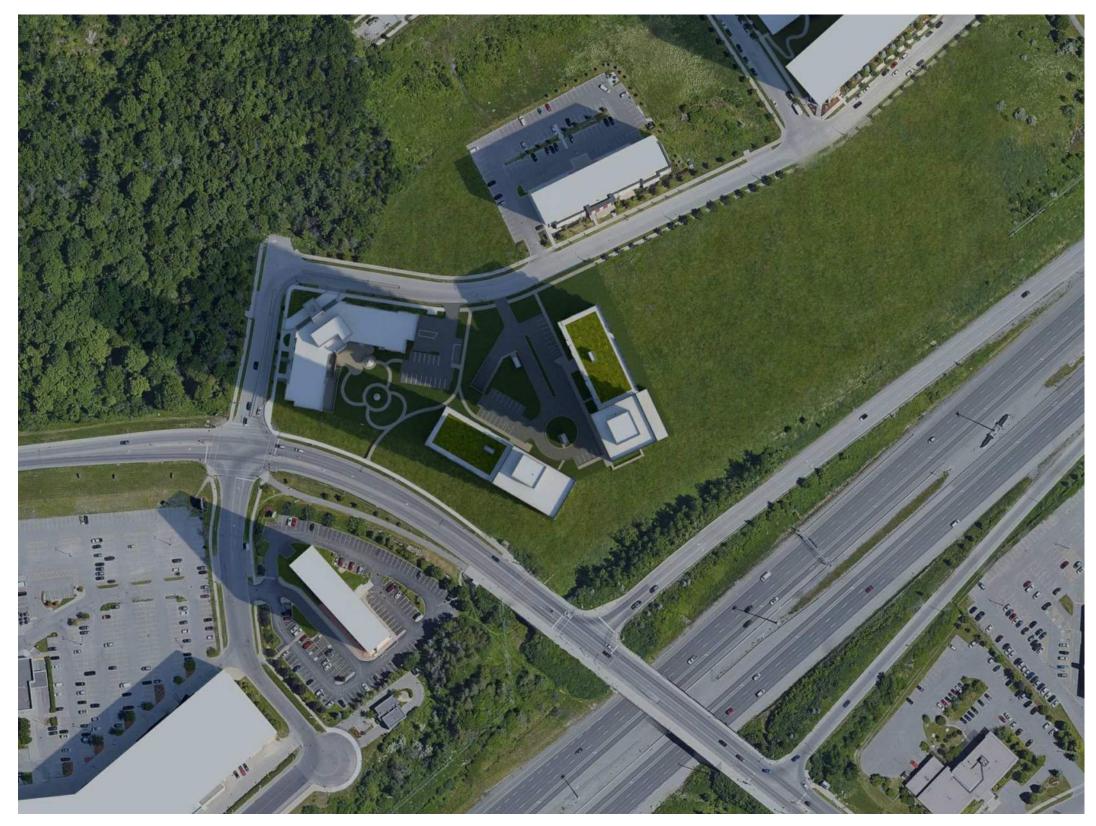


SEPTEMBER 21st 9:00 am

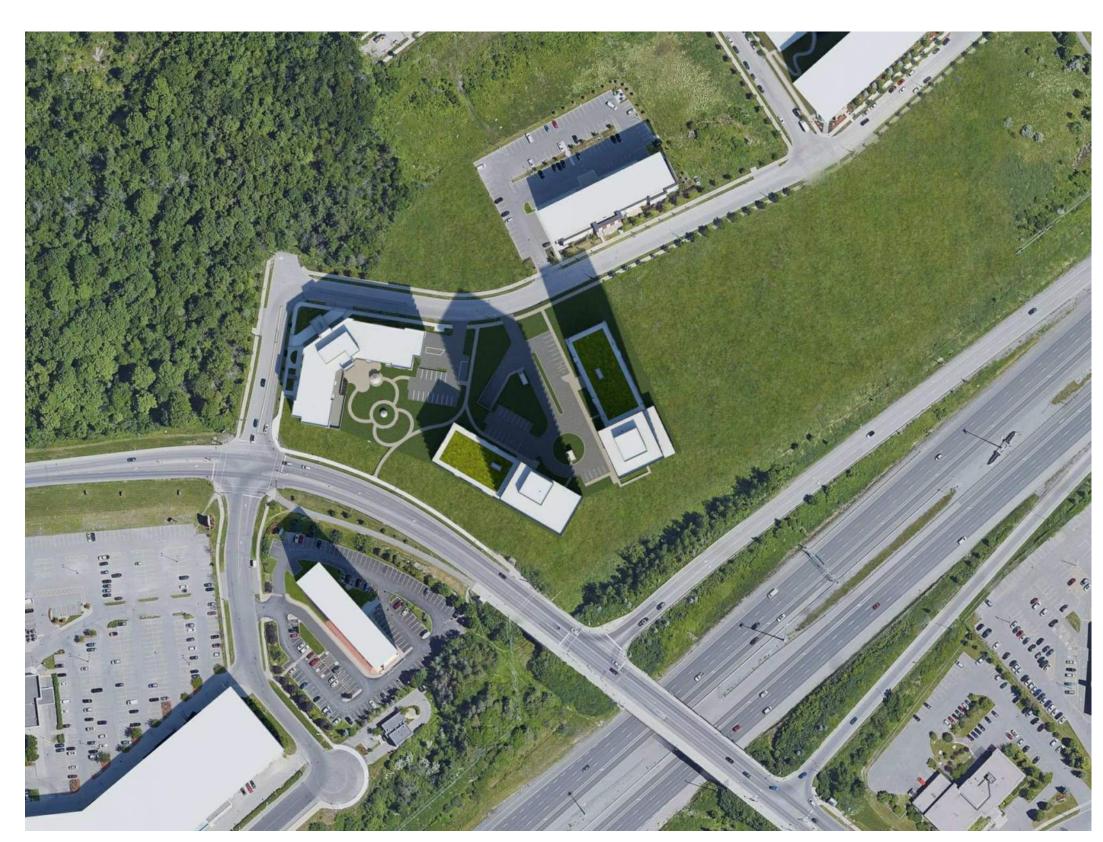

SEPTEMBER 21st 12:00 pm

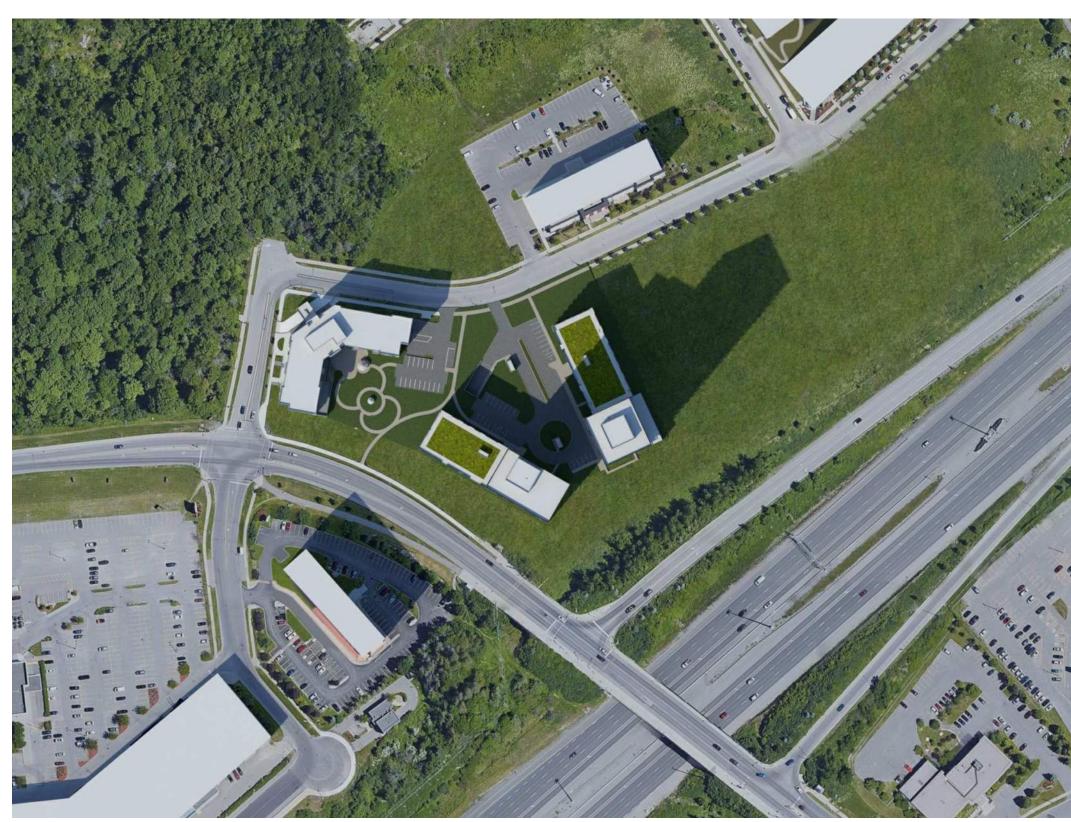

SEPTEMBER 21st 3:00 pm

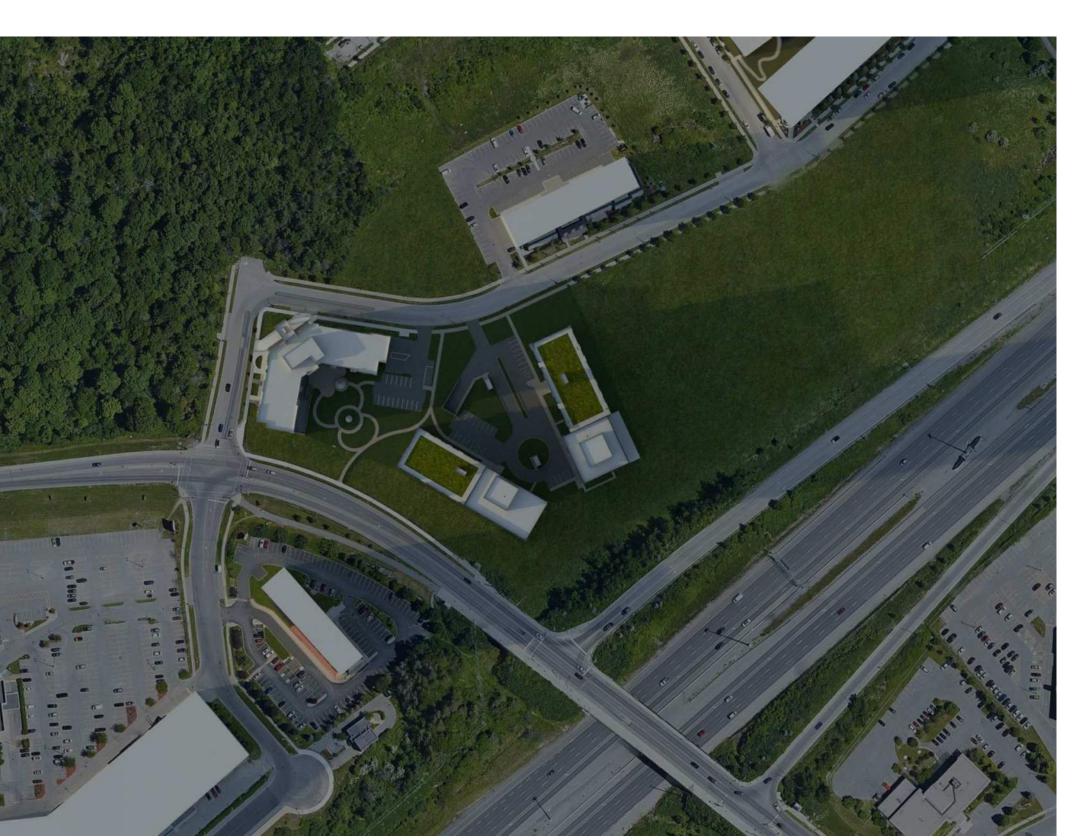

SEPTEMBER 21st 6:00 pm

- Ces documents d'architecture sont la propriété exclusive de
   NEUF architect(e)s et ne pourront être utilisés, reproduits ou copiés sans autorisation écrite préalable. / These architectural documents are the exclusive property of NEUF architect(e)s and cannot be used, copied or reproduced without written pre-authorisation

   Les dimensions apparaissant aux documents devront être vérifiées
   par l'entrepreneur avant le début des travaux. / All dimensions which appear on the documents must be verify by the contractor before to start the work.

   Veuillez aviser l'architecte de toute dimension erreur et/ou divergences entre ces documents et ceux des autres professionnels. / The architect must be notified of all errors, omissions and discrepancies between these documents and those of the others professionnals.
   Les dimensions sur ces documents doivent être lues et non mesurées. / The dimensions on these documents must be read and not measured.

STRUCTURE Structural Goodeve Structural Inc.
18-77, Auriga Drive, Ottawa ON K2E 7Z7
T 613 226 4558 goodevestructural.ca

ARCHITECTURE DE PAYSAGE Landscape Architect James B. Lennox & Associates
3332, Carling Avenue, Ottawa ON K2H 5A8
T 613 722 5168 jbla.ca

Novatech Eng. Consultants Ltd. 240, Michael Cowpland Drive, Suite 200, Ottawa ON K2M 1P6 T 613 234 9643 novatech-eng.com

ARCHITECTES Architect NEUF architect(e)s SENCRL 630, boul. René-Lévesque O. 32e étages, Montréal QC H3B 1S6 T 514 847 1117 NEUFarchitectes.com

SCEAU / Seal







## **1200 MARITIME WAY** (KANATA RENTAL)

EMPLACEMENT Location OTTAWA

NO RÉVISION

NO PROJET No. 12371.00


DESSINÉ PAR Drawn by


VÉRIFIÉ PAR Checked LH DATE (aa.mm.jj) 12/11/20 ÉCHELLE Scale

TITRE DU DESSIN Drawing Title SUN STUDY -


**SEPTEMBER** 

RÉVISION Revision

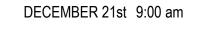

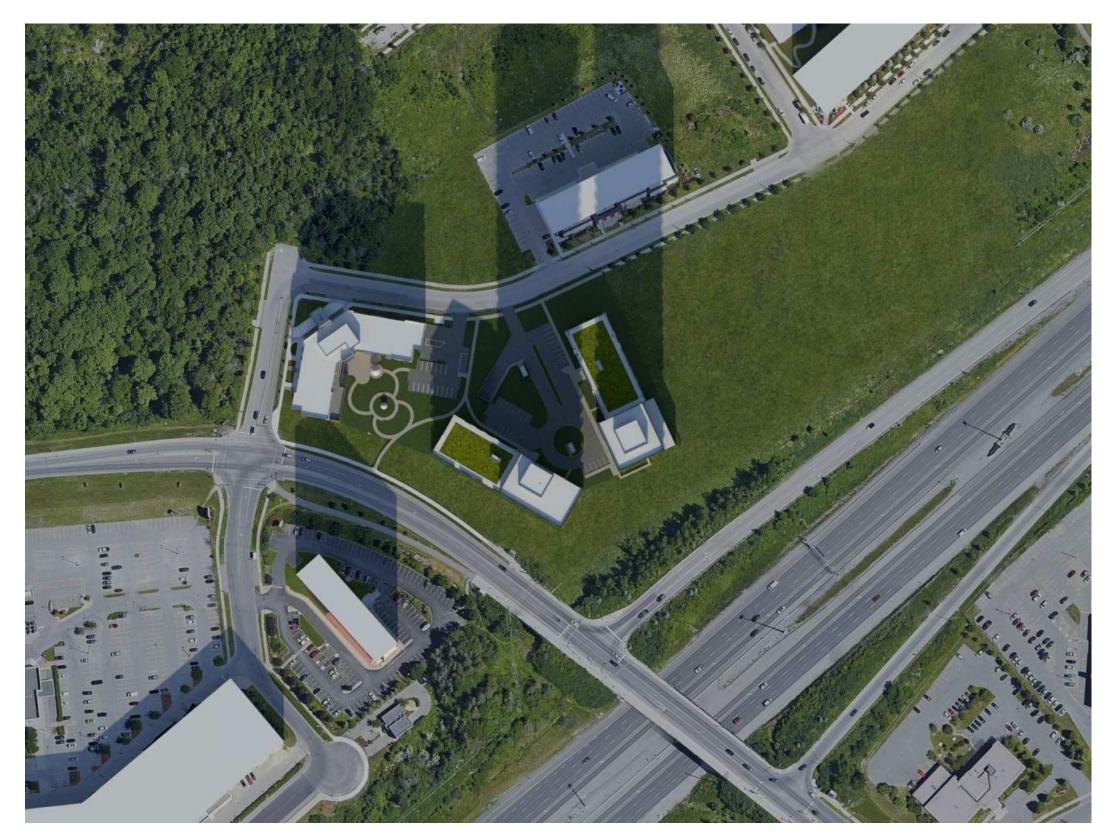

DECEMBER 21st 12:00 pm

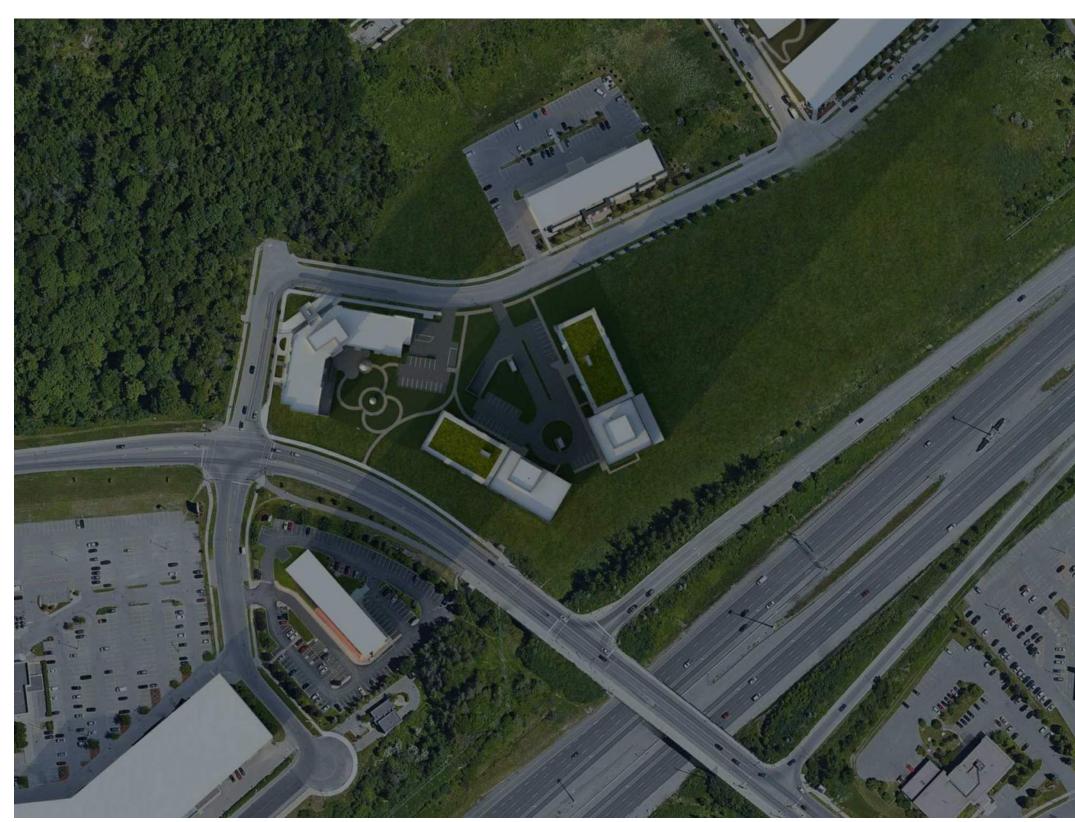

DECEMBER 21st 3:00 pm

Ces documents d'architecture sont la propriété exclusive de
 NEUF architect(e)s et ne pourront être utilisés, reproduits ou copiés sans autorisation écrite préalable. / These architectural documents are the exclusive property of NEUF architect(e)s and cannot be used, copied or reproduced without written pre-authorisation

 Les dimensions apparaissant aux documents devront être vérifiées
 par l'entrepreneur avant le début des travaux. / All dimensions which appear on the documents must be verify by the contractor before to start the work.

 Veuillez aviser l'architecte de toute dimension erreur et/ou divergences entre ces documents et ceux des autres professionnels. / The architect must be notified of all errors, omissions and discrepancies between these documents and those of the others professionnals.
 Les dimensions sur ces documents doivent être lues et non mesurées. / The dimensions on these documents must be read and not measured.

STRUCTURE Structural Goodeve Structural Inc.
18-77, Auriga Drive, Ottawa ON K2E 7Z7
T 613 226 4558 goodevestructural.ca

ARCHITECTURE DE PAYSAGE Landscape Architect James B. Lennox & Associates
3332, Carling Avenue, Ottawa ON K2H 5A8
T 613 722 5168 jbla.ca

Novatech Eng. Consultants Ltd. 240, Michael Cowpland Drive, Suite 200, Ottawa ON K2M 1P6 T 613 234 9643 novatech-eng.com

ARCHITECTES Architect NEUF architect(e)s SENCRL 630, boul. René-Lévesque O. 32e étages, Montréal QC H3B 1S6 T 514 847 1117 NEUFarchitectes.com

SCEAU / Seal







## **1200 MARITIME WAY** (KANATA RENTAL)

EMPLACEMENT Location
OTTAWA

NO PROJET No. 12371.00

DATE (aa-mm-jj)

NO RÉVISION

DESSINÉ PAR Drawn by

VÉRIFIÉ PAR Checked LH ÉCHELLE Scale

DATE (aa.mm.jj) 12/11/20 TITRE DU DESSIN Drawing Title

**SUN STUDY - DECEMBER** 

RÉVISION Revision

Ces documents d'architecture sont la propriété exclusive de

 NEUF architect(e)s et ne pourront être utilisés, reproduits ou copiés sans autorisation écrite préalable. / These architectural documents are the exclusive property of NEUF architect(e)s and cannot be used, copied or reproduced without written pre-authorisation

 Les dimensions apparaissant aux documents devront être vérifiées

 par l'entrepreneur avant le début des travaux. / All dimensions which appear on the documents must be verify by the contractor before to start the work.

 Veuillez aviser l'architecte de toute dimension erreur et/ou divergences entre ces documents et ceux des autres professionnels. / The architect must be notified of all errors, omissions and discrepancies between these documents and those of the others professionnals.

professionnals.

4 Les dimensions sur ces documents doivent être lues et non mesurées. / The dimensions on these documents must be read and not measured.

STRUCTURE Structural Goodeve Structural Inc.
18-77, Auriga Drive, Ottawa ON K2E 7Z7
T 613 226 4558 goodevestructural.ca

ARCHITECTURE DE PAYSAGE Landscape Architect James B. Lennox & Associates 3332, Carling Avenue, Ottawa ON K2H 5A8 T 613 722 5168 jbla.ca

Novatech Eng. Consultants Ltd.
240, Michael Cowpland Drive, Suite 200, Ottawa ON K2M 1P6
T 613 234 9643 novatech-eng.com

ARCHITECTES Architect NEUF architect(e)s SENCRL 630, boul. René-Lévesque O. 32e étages, Montréal QC H3B 1S6 T 514 847 1117 NEUFarchitectes.com

SCEAU / Seal







# **1200 MARITIME WAY** (KANATA RENTAL)

EMPLACEMENT Location
OTTAWA

NO PROJET No. 12371.00

DATE (aa-mm-jj)

ÉCHELLE Scale

NO RÉVISION A SITE PLAN COORDINATION
B FOR INFORMATION

DATE (aa.mm.jj) 12/16/20 TITRE DU DESSIN Drawing Title

**3D RENDERING** 

NO. DESSIN Dwg Number
A1100
#18348



STREETSCAPE LOOKING EAST

NOTES GÉNÉRALES General Notes

- Ces documents d'architecture sont la propriété exclusive de
  NEUF architect(e)s et ne pourront être utilisés, reproduits ou copiés sans autorisation écrite préalable. / These architectural documents are the exclusive property of NEUF architect(e)s and cannot be used, copied or reproduced without written pre-authorisation

  Les dimensions apparaissant aux documents devront être vérifiées par l'entrepreneur avant le début des travaux. / All dimensions which appear on the documents must be verify by the contractor before to start the work.

  Veuillez aviser l'architecte de toute dimension erreur et/ou divergences entre ces documents et ceux des autres professionnels. / The architect must be notified of all errors, omissions and discrepancies between these documents and those of the others professionnals.
- professionnals.

  4 Les dimensions sur ces documents doivent être lues et non mesurées. / The dimensions on these documents must be read and not measured.

STRUCTURE Structural Goodeve Structural Inc.
18-77, Auriga Drive, Ottawa ON K2E 7Z7
T 613 226 4558 goodevestructural.ca

ARCHITECTURE DE PAYSAGE Landscape Architect James B. Lennox & Associates
3332, Carling Avenue, Ottawa ON K2H 5A8
T 613 722 5168 jbla.ca

Novatech Eng. Consultants Ltd.
240, Michael Cowpland Drive, Suite 200, Ottawa ON K2M 1P6
T 613 234 9643 novatech-eng.com

ARCHITECTES Architect NEUF architect(e)s SENCRL 630, boul. René-Lévesque O. 32e étages, Montréal QC H3B 1S6 T 514 847 1117 NEUFarchitectes.com

SCEAU / Seal







## **1200 MARITIME WAY** (KANATA RENTAL)

EMPLACEMENT Location
OTTAWA

NO PROJET No. 12371.00

DATE (aa-mm-jj)

DATE (aa.mm.jj) 05/26/21 ÉCHELLE Scale

TITRE DU DESSIN Drawing Title **3D RENDERING** 

RÉVISION Revision

NO. DESSIN Dwg Number
A1101
#18348

- Ces documents d'architecture sont la propriété exclusive de
   NEUF architect(e)s et ne pourront être utilisés, reproduits ou copiés sans autorisation écrite préalable. / These architectural documents are the exclusive property of NEUF architect(e)s and cannot be used, copied or reproduced without written pre-authorisation
   Les dimensions apparaissant aux documents devront être vérifiées
   par l'entrepreneur avant le début des travaux. / All dimensions which appear on the documents must be verify by the contractor before to start the work.
- start the work.

  3 Veuillez aviser l'architecte de toute dimension erreur et/ou

  . divergences entre ces documents et ceux des autres professionnels. /
  The architect must be notified of all errors, omissions and discrepancies between these documents and those of the others
- professionnals.

  4 Les dimensions sur ces documents doivent être lues et non mesurées. / The dimensions on these documents must be read and not measured.

STRUCTURE Structural Goodeve Structural Inc.
18-77, Auriga Drive, Ottawa ON K2E 7Z7
T 613 226 4558 goodevestructural.ca

ARCHITECTURE DE PAYSAGE Landscape Architect James B. Lennox & Associates 3332, Carling Avenue, Ottawa ON K2H 5A8 T 613 722 5168 jbla.ca

Novatech Eng. Consultants Ltd.
240, Michael Cowpland Drive, Suite 200, Ottawa ON K2M 1P6
T 613 234 9643 novatech-eng.com

ARCHITECTES Architect NEUF architect(e)S SENCRL 630, boul. René-Lévesque O. 32e étages, Montréal QC H3B 1S6 T 514 847 1117 NEUFarchitectes.com

SCEAU / Seal







# **1200 MARITIME WAY** (KANATA RENTAL)

EMPLACEMENT Location
OTTAWA

NO PROJET No. 12371.00

DATE (aa-mm-jj)

DATE (aa.mm.jj) 05/26/21

TITRE DU DESSIN Drawing Title **3D RENDERING** 

NO. DESSIN Dwg Number
A1102
#18348

