

SITE BENCHMARK
FIRE HYDRANT ON TOP OF NUT OF FLANGE WITH AN ELEVATION OF 89.47, LOCATED ON MICHAEL STOQUOA STREET EAST SIDE OF ROADWAY.

True North


39 Auriga Dr. Nepean, ON K2E 7Y8


COPYRIGHT


This drawing has been prepared solely for the intended use, thus any reproduction or distribution for any purpose other than authorized by IBI Group is forbidden. Written dimensions shall have precedence over scaled dimensions. Contractors shall verify and be responsible for all dimensions and conditions on the job, and IBI Group shall be informed of any variations from the dimensions and conditions shown on the drawing. Shop drawings shall be submitted to IBI Group for general conformance before proceeding with fabrication.

IBI Group Professional Services (Canada) Inc. is a member of the IBI Group of companies



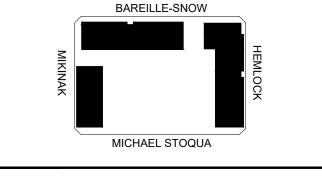

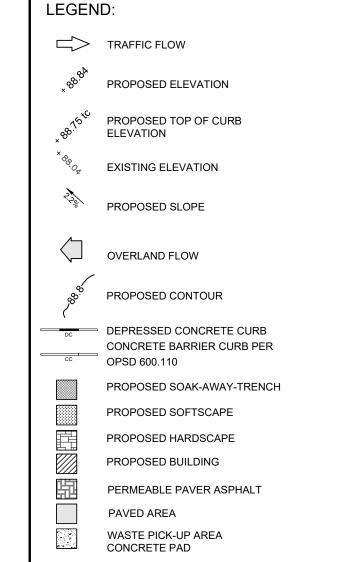

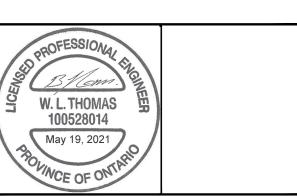

PRIME CONSULTANT

IBI GROUP Unit 110 - 650 Dalton Avenue Kingston ON K7M 8N7 Canada tel 613 531 4440 fax 613 531 7789 ibigroup.com

PROJECT MIKINAK REDEVELOPMENT

715 MIKINAK ROAD, OTTAWA, ON CANADA K1K 2G8

PROJECT NO: SCALE: 125599 1:500 DRAWN BY: CHECKED BY: PROJECT MGR: APPROVED BY:

SHEET TITLE GRADING PLAN (NORTH)

SHEET NUMBER

C-300

ISSUE

MUNICIPAL SITE PLAN APPROVAL OR DEVELOPER GRADING APPROVAL.

MAXIMUM LOT OR BLOCK GRASS SURFACE GRADE AT ANY LOCATION SHALL BE 8.0% WITH EMBANKMENTS (3:1 MAX.) OR RETAINING STRUCTURES PROVIDED AS REQUIRED TO TAKE UP GRADE DIFFERENTIALS IN EXCESS OF SUCH SLOPES. 9. EMBANKMENTS FORMED DURING THE GRADING OF LOTS AND BLOCKS SHALL HAVE THE FOLLOWING MAXIMUM GRADES: (A) ADJACENT TO DRIVEWAYS OR SWALE SIDE SLOPES - 4:1 MAXIMUM


(B) ELSEWHERE - 3:1 MAXIMUM 10. MAXIMUM DRIVEWAY GRADES TO BE 10.0%. MAXIMUM PARKING AREA PAVEMENT GRADES TO BE 6%.

SHALL BE CONFORMED TO

11. UNLESS OTHERWISE INDICATED, THE LOT LINE AND CORNER ELEVATIONS SHOWN HEREON ARE GENERALLY THE MINIMUM ELEVATIONS FOR THE SPECIFIED DRAINAGE PATTERN. ANY ALTERATIONS REQUIRE THE WRITTEN APPROVAL OF THE DESIGN ENGINEER.

12. GIVEN THE PROPOSED BUILDING GRADES MAY BE RAISED TO COMPENSATE FOR DIFFERENCES BETWEEN ASSUMED AND ACTUAL BUILDING DIMENSIONS IN ACCORDANCE WITH THE ESTABLISHED CRITERIA FOR THE DRAINAGE PATTERN. REAR SPECIFIED BUILDING GRADE TO BE ESTABLISHED BY CONTRACTOR TO SUIT BUILDING TYPE HOWEVER ALL GRADING REQUIREMENTS IDENTIFIED ON THIS PLAN AND AS REQUIRED BY THE MUNICIPALITY

13. GRADING AND SODDING OF ADJACENT ROADWAY BOULEVARDS WILL BE PERFORMED BY THE CONTRACTOR IN ACCORDANCE WITH MUNICIPAL

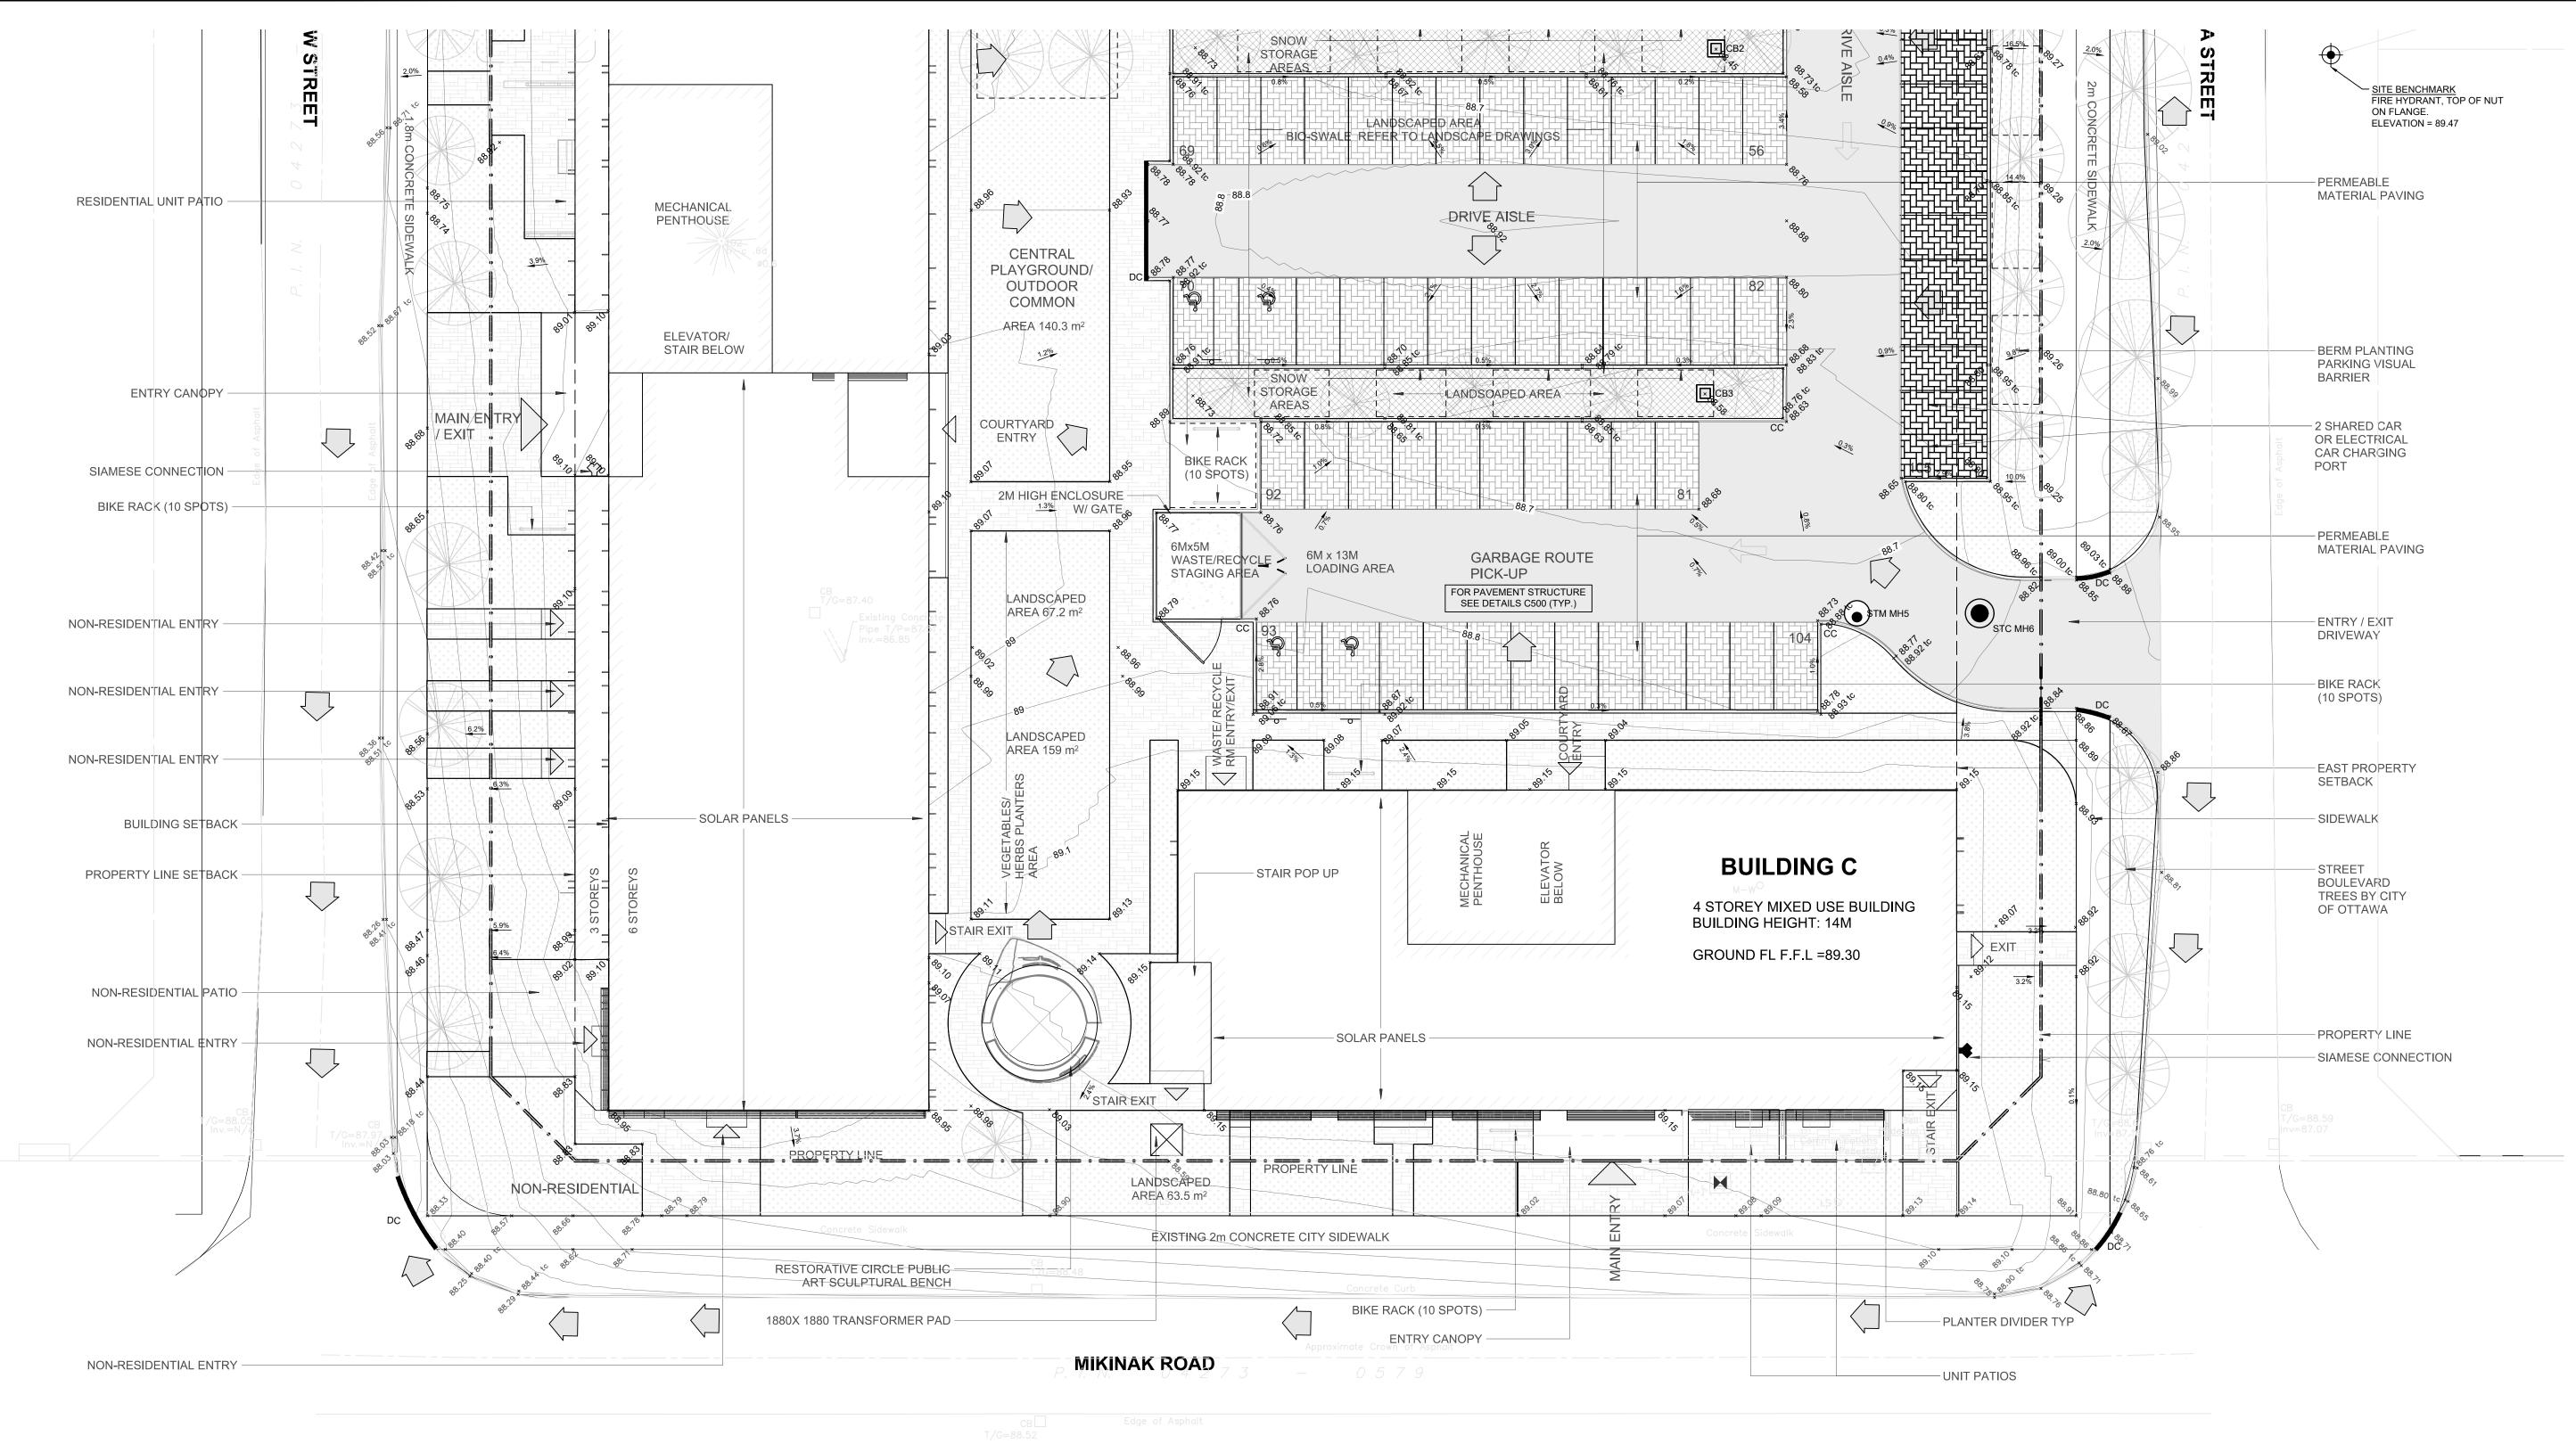


- GENERAL NOTES FOR LOT GRADING

 1. ALL LOTS AND BLOCKS FOR PRIVATE USE ON THE LANDS CORRESPONDING TO THIS DESIGN ARE TO BE DEVELOPED IN ACCORDANCE WITH THE PLAN DETAILS AND THESE NOTES.
- THE DEVELOPER SHALL NOT BE CONSIDERED RESPONSIBLE TO THE CONTRACTOR IN ANY RESPECT FOR THE AMOUNT OF GRADING OR EARTHWORK REQUIRED TO BE PERFORMED BY THE CONTRACTOR DUE TO THE INFORMATION PROVIDED ON THESE DRAWINGS EXCEPT WHERE REQUIRED TO PROMOTE INTERIM DRAINAGE. 3. ALL GROUND SURFACES SHALL BE EVENLY GRADED WITHOUT PONDING AREAS AND WITHOUT LOW POINTS EXCEPT WHERE APPROVED SWALES ARE
- PROVIDED THE CONTRACTOR SHALL ENSURE POSITIVE DRAINAGE ALONG SIDE LOT LINES AS REQUIRED TO MAINTAIN THE INTENT OF THE GRADING PLAN. THE CONTRACTOR SHALL COMPLETE THE DRAINAGE SWALES IN THE LOCATIONS AND TO THE GRADES AND ELEVATIONS, DEPTHS AND SECTIONS SPECIFIED ON THE PLAN, PRIOR TO FINAL LANDSCAPING BY THE CONTRACTOR. THE CONTRACTOR SHALL ENSURE THAT THE REQUIRED SWALES ARE
- ANY EMBANKMENT REQUIRED FOR INTERNAL GRADING IS TO BE COMMENCED ALONG THE INSIDE EDGE OF THE PROPERTY. THE GRADING OF ALL LOTS AND BLOCKS IS TO BE PERFORMED TO PROVIDE FINISHED PERIMETER SURFACES WHICH ARE FLUSH WITH GIVEN STREET LINE, REAR AND SIDE LINE ELEVATIONS.
- FINAL PERIMETER GRADES FOR A LOT OR BLOCK WHERE NOT OTHERWISE SHOWN HEREON SHALL BE COINCIDENT WITH THE ADJOINING PERIMETER GRADES OF AN ADJACENT LOT OR BLOCK WHICH SHALL HAVE BEEN PREVIOUSLY ESTABLISHED BY, OR CONSTRUCTED IN ACCORDANCE WITH A MUNICIPAL SITE PLAN APPROVAL OR DEVELOPER GRADING APPROVAL.
- MAXIMUM LOT OR BLOCK GRASS SURFACE GRADE AT ANY LOCATION SHALL BE 8.0% WITH EMBANKMENTS (3:1 MAX.) OR RETAINING STRUCTURES PROVIDED AS REQUIRED TO TAKE UP GRADE DIFFERENTIALS IN EXCESS OF SUCH SLOPES.
- 9. EMBANKMENTS FORMED DURING THE GRADING OF LOTS AND BLOCKS SHALL HAVE THE FOLLOWING MAXIMUM GRADES: (A) ADJACENT TO DRIVEWAYS OR SWALE SIDE SLOPES - 4:1 MAXIMUM

CONSTRUCTED IN ACCORDANCE WITH THE GRADING PLAN.

- (B) ELSEWHERE 3:1 MAXIMUM 10. MAXIMUM DRIVEWAY GRADES TO BE 10.0%. MAXIMUM PARKING AREA PAVEMENT GRADES TO BE 6%.
- 11. UNLESS OTHERWISE INDICATED, THE LOT LINE AND CORNER ELEVATIONS SHOWN HEREON ARE GENERALLY THE MINIMUM ELEVATIONS FOR THE SPECIFIED DRAINAGE PATTERN. ANY ALTERATIONS REQUIRE THE WRITTEN APPROVAL OF THE DESIGN ENGINEER.
- 12. GIVEN THE PROPOSED BUILDING GRADES MAY BE RAISED TO COMPENSATE FOR DIFFERENCES BETWEEN ASSUMED AND ACTUAL BUILDING DIMENSIONS IN ACCORDANCE WITH THE ESTABLISHED CRITERIA FOR THE DRAINAGE PATTERN. REAR SPECIFIED BUILDING GRADE TO BE ESTABLISHED BY CONTRACTOR TO SUIT BUILDING TYPE HOWEVER ALL GRADING REQUIREMENTS IDENTIFIED ON THIS PLAN AND AS REQUIRED BY THE MUNICIPALITY SHALL BE CONFORMED TO.
- 13. GRADING AND SODDING OF ADJACENT ROADWAY BOULEVARDS WILL BE PERFORMED BY THE CONTRACTOR IN ACCORDANCE WITH MUNICIPAL

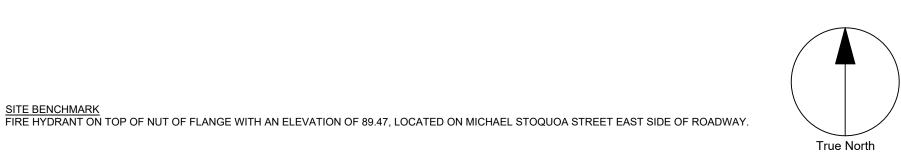





COPYRIGHT


This drawing has been prepared solely for the intended use, thus any reproduction or distribution for any purpose other than authorized by IBI Group is forbidden. Written dimensions shall have precedence over scaled dimensions. Contractors shall verify and be responsible for all dimensions and conditions on the job, and IBI Group shall be informed of any variations from the dimensions and conditions shown on the drawing. Shop drawings shall be submitted to IBI Group for general conformance before proceeding with fabrication.


IBI Group Professional Services (Canada) Inc. is a member of the IBI Group of companies

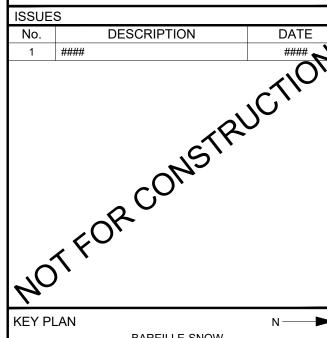


BAREILLE-SNOW MICHAEL STOQUA

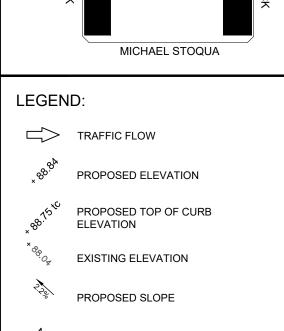


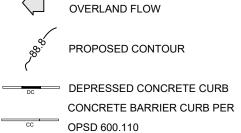

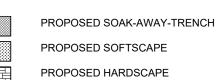

PROPOSED BUILDING PERMEABLE PAVER ASPHALT

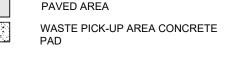

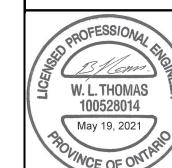

PRIME CONSULTANT

IBI GROUP Unit 110 - 650 Dalton Avenue Unit 110 - 650 Dalitori Avenue
Kingston ON K7M 8N7 Canada
tel 613 531 4440 fax 613 531 7789 ibigroup.com

PROJECT MIKINAK REDEVELOPMENT

715 MIKINAK ROAD, OTTAWA, ON CANADA K1K 2G8


PROJECT NO: SCALE: 125599 1:500 DRAWN BY: CHECKED BY: PROJECT MGR: APPROVED BY:

ISSUE

GRADING PLAN (SOUTH)

SHEET NUMBER


C-301

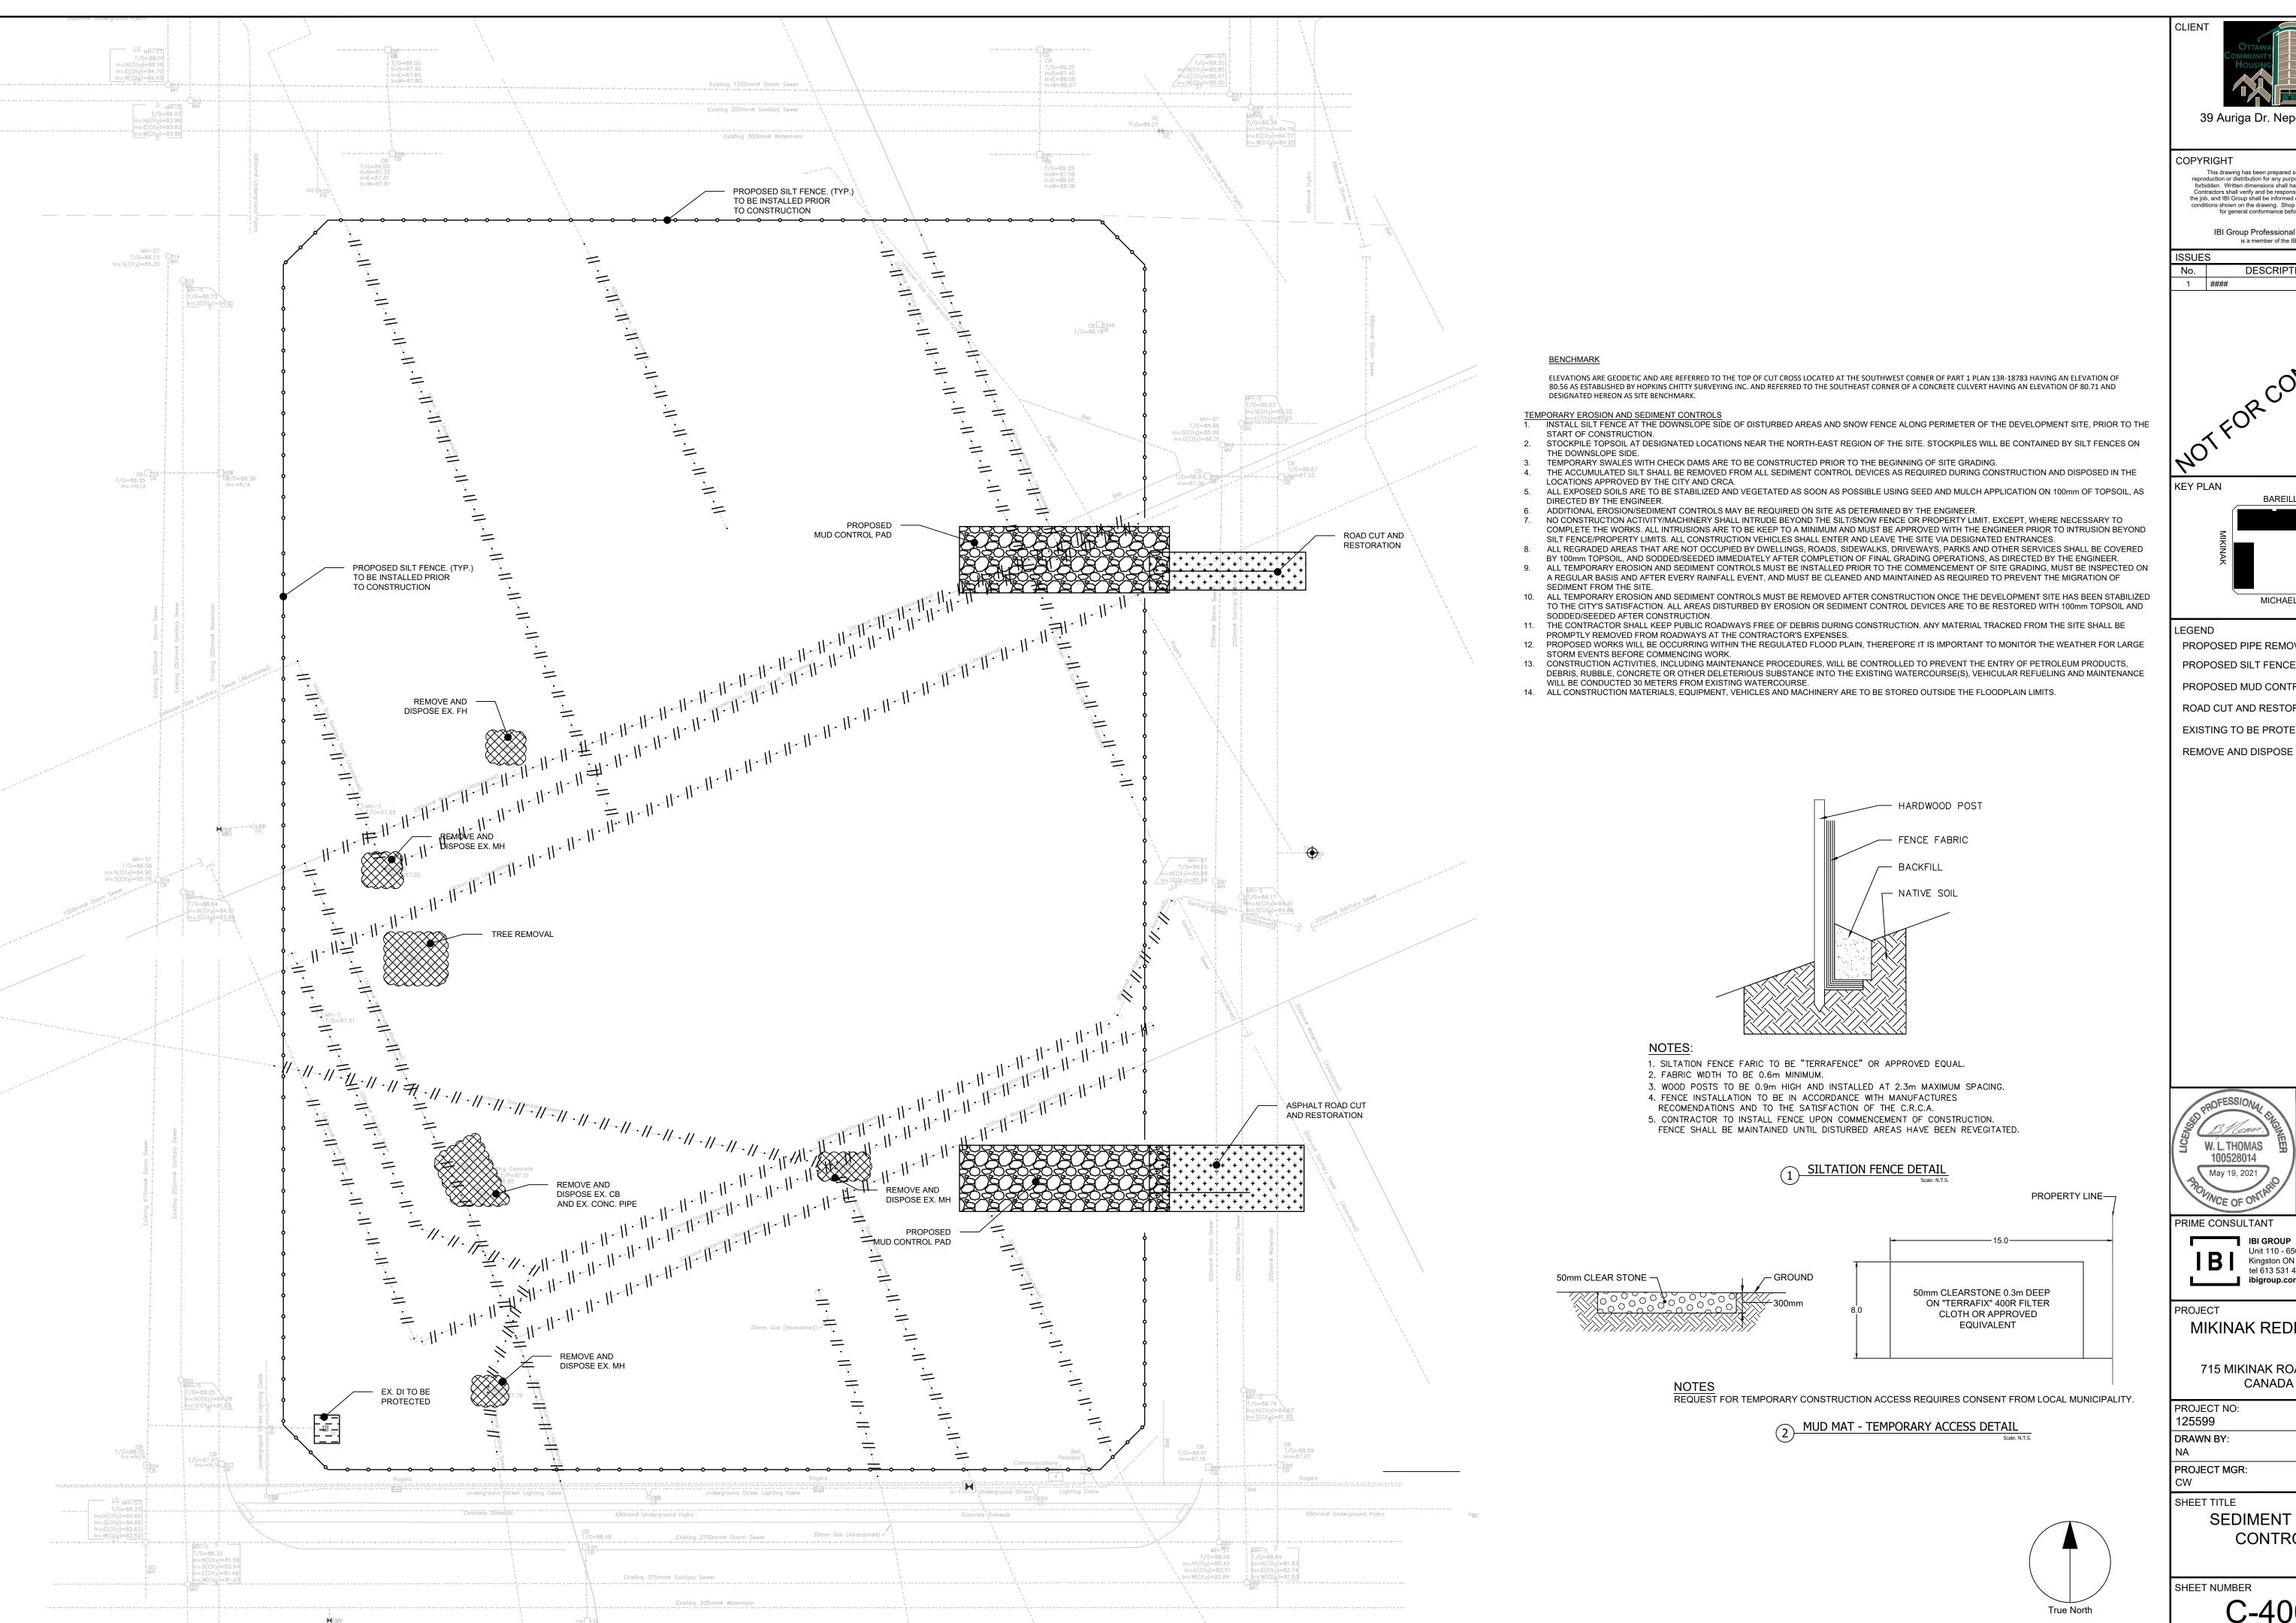




This drawing has been prepared solely for the intended use, thus any reproduction or distribution for any purpose other than authorized by IBI Group is forbidden. Written dimensions shall have precedence over scaled dimensions. Contractors shall verify and be responsible for all dimensions and conditions on the job, and IBI Group shall be informed of any variations from the dimensions and conditions shown on the drawing. Shop drawings shall be submitted to IBI Group for general conformance before proceeding with fabrication.


> IBI Group Professional Services (Canada) Inc. is a member of the IBI Group of companies

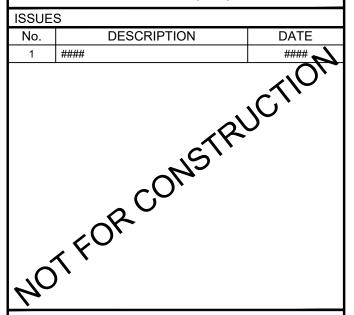

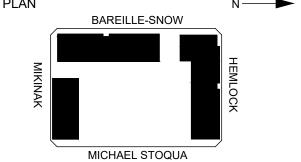

PROPOSED PIPE REMOVAL

PROPOSED SILT FENCE PROPOSED MUD CONTROL PAD ROAD CUT AND RESTORATION EXISTING TO BE PROTECTED

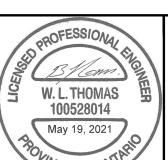

PRIME CONSULTANT

IBI GROUP Unit 110 - 650 Dalton Avenue
Kingston ON K7M 8N7 Canada
tel 613 531 4440 fax 613 531 7789
ibigroup.com


MIKINAK REDEVELOPMENT


715 MIKINAK ROAD, OTTAWA, ON CANADA K1K 2G8

PROJECT NO:	SCALE:
125599	1:500
DRAWN BY:	CHECKED BY:
NA	ВТ
PROJECT MGR:	APPROVED BY:
CW	BT


SEDIMENT & EROSION **CONTROL PLAN**


ISSUE C-400

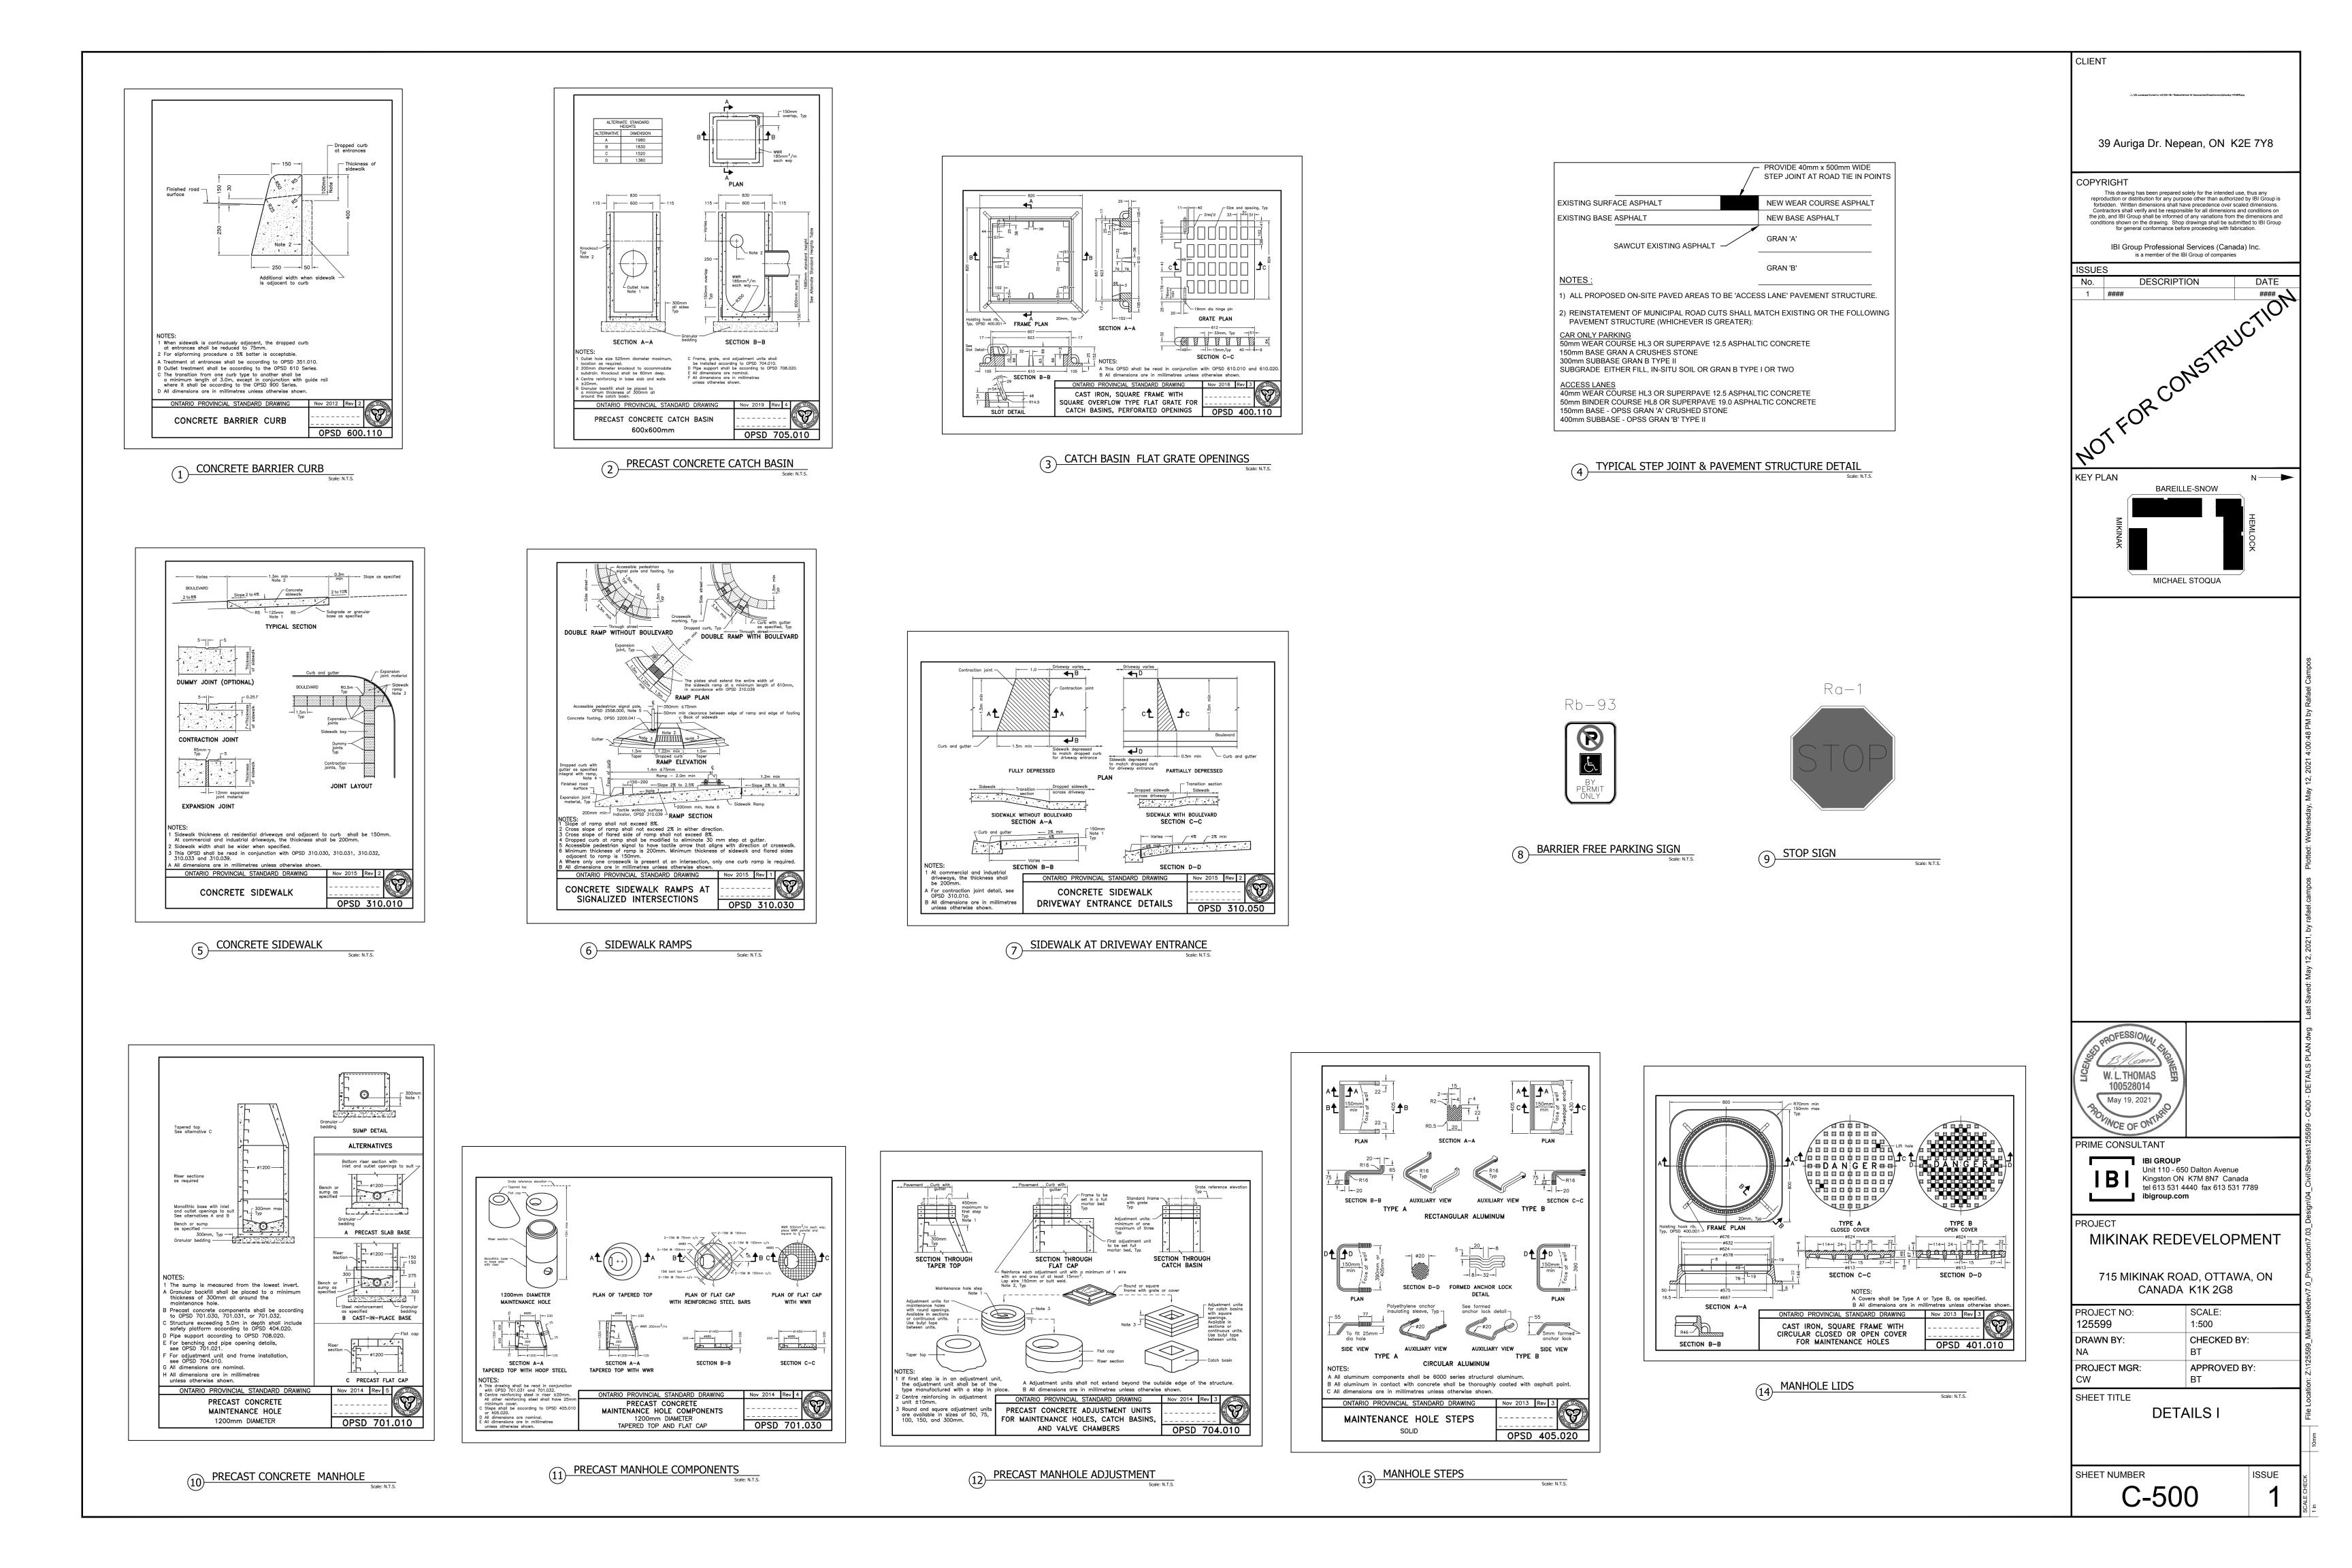

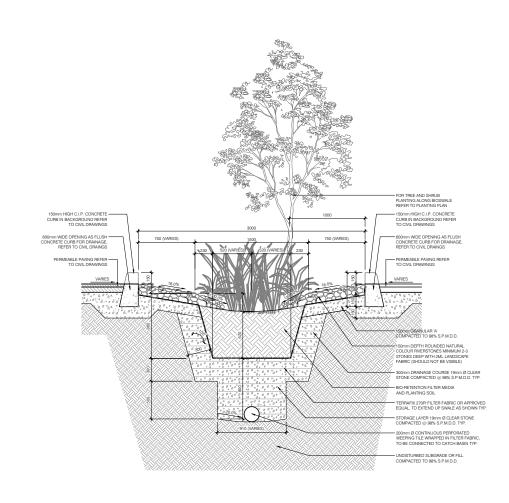



BIOSWALE Scale: N.T.S.

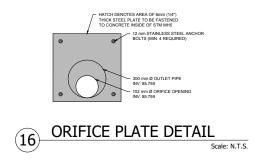

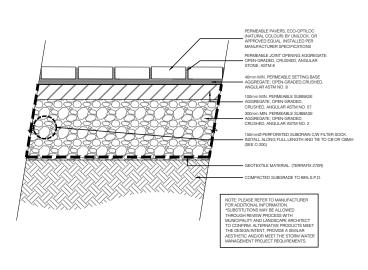



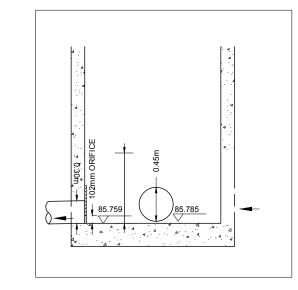

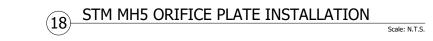






COPYRIGHT

This drawing has been prepared solely for the intended use, thus any reproduction or distribution for any purpose other than authorized by IBI Group is forbidden. Written dimensions shall have precedence over scaled dimensions. Contractors shall verify and be responsible for all dimensions and conditions on the job, and IBI Group shall be informed of any variations from the dimensions and conditions shown on the drawing. Shop drawings shall be submitted to IBI Group for general conformance before proceeding with fabrication.

IBI Group Professional Services (Canada) Inc. is a member of the IBI Group of companies

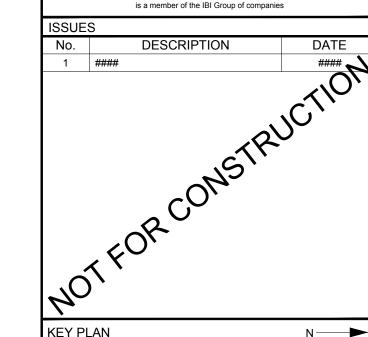

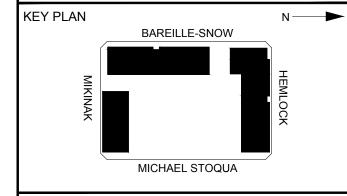

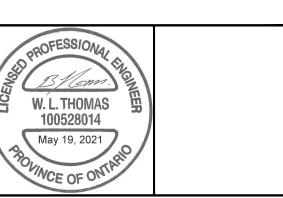

PRIME CONSULTANT

IBI GROUP
Unit 110 - 650 Dalton Avenue
Kingston ON K7M 8N7 Canada
tel 613 531 4440 fax 613 531 7789
ibigroup.com

PROJECT

MIKINAK REDEVELOPMENT

715 MIKINAK ROAD, OTTAWA, ON CANADA K1K 2G8

PROJECT NO:	SCALE:
125599	1:500
DRAWN BY:	CHECKED BY:
NA	BT
PROJECT MGR:	APPROVED BY:
CW	ВТ

SHEET TITLE

DETAILS II

ISSUE

SHEET NUMBER

C-501