

EXISTING 159mm DBH

\ LANDSCAPE PLAN

L.1 | SCALE 1:250


SUGAR MAPLE TØ


75mm COMPOSTED _

PINE MULCH (TYP)

PAVERS

PROPOSED PERMEABLE.

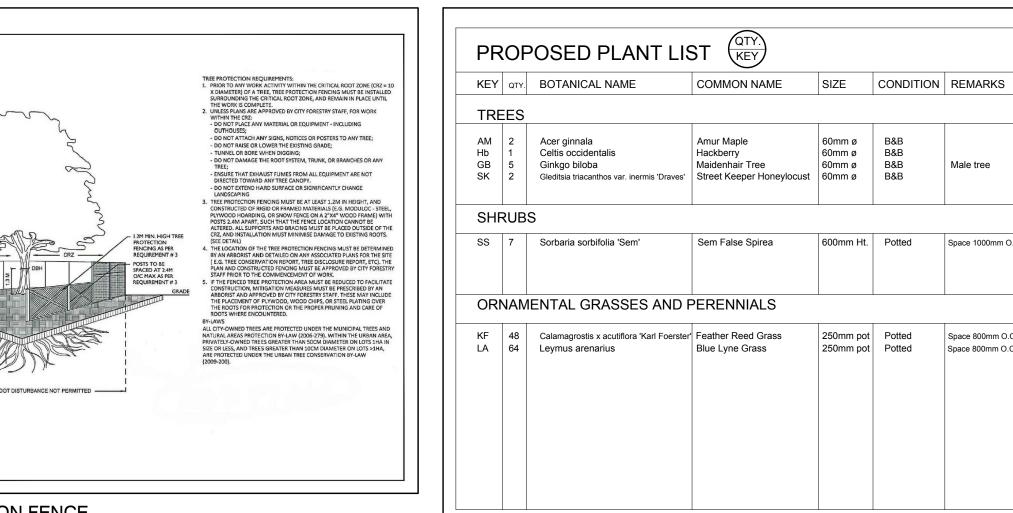

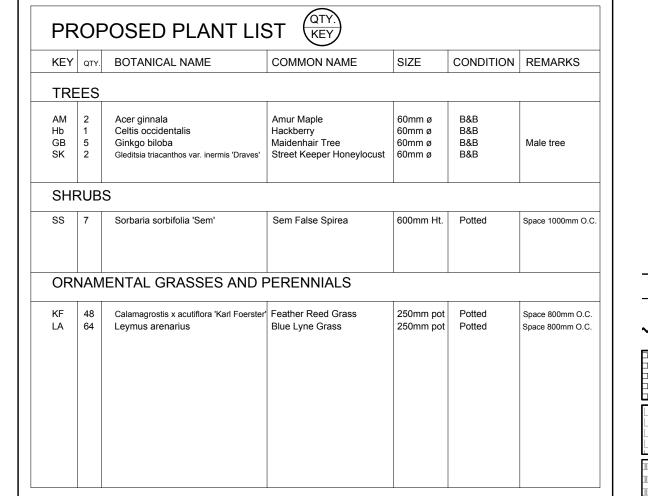

CITY STANDARDS. REFER TO CIVIL DRAWINGS

- ÆRACE BIKE RACK⊕

CITY OF OTTAWA

PARK SUBJECT TO

FUTURE DESIGN

N.I.C.

FASTENING SEE INSET A

FASTENING SEE INSET A -

LOOPED RODS: ½" DIA. HO ROLLED SOLID ROUND ROD

FACE VIEW

SCALE: NTS

TREE GUARD

Round

BANDS: 1 1½" X ¾6" HOT ROLLE FLAT BAR ON INSIDE OF ROD FASTENED WITH CONTINOUS WELDS (TYP) SEE INSET A FO

Ottawa

PROPOSED 100mm P.I.P.

APPROVED UNDISTURBED

GRANULAR 'A'

SUBGRADE

SIDE VIEW

APPROVED UNDISTURBED —

L.1


SUBGRADE

LOOP BIKE RACK

SCALE: NTS

FRONT VIEW

SIDEWALK

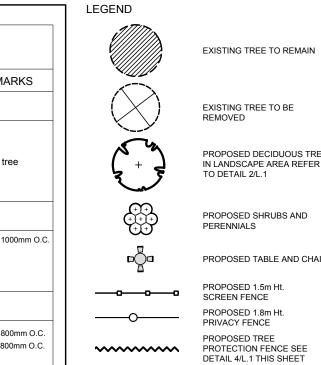

PROPOSED CONCRETE

PROPOSED CONCRETE PAVERS TYPE II

PROPOSED PERMEABLE

PROPOSED PEASTONE MULCH

PROPOSED SILVA CELL AREA

PROPOSED 75mm OF

EXISTING UTILITY POLE

EXISTING CATCH BASIN

EXISTING FIRE HYDRANT

PROPOSED REMOVABLE TRE GUARD SEE DETAIL 5/L.1 THIS

PROPOSED BIKE RACK

TACTILE WARNING STRIP

SHEET

1. ALL SHARP EDGES SHALL BE REMOVED; 2. ZINC RICH POWDER COATED

3. ZINC RICH POWDER COATED PAINTED BLACK

DATE: AUG 2019

TWSI

PROPOSED SOD

PAVERS TYPE I



630 RENÉ-LÉVESQUE BLVD W SUITE 3200, MONTREAL, QC H3B 1S6

SURVEYORS

1. IT IS THE RESPONSIBILITY OF THE APPROPRIATE CONTRACTOR OR OFFICIAL TO REPORT ANY ERRORS, OMISSIONS OR DISCREPANCIES ON THIS PLAN WITH ACTUAL SITE CONDITIONS T THE LANDSCAPE ARCHITECT BEFORE PROCEEDING WITH CONSTRUCTION. 2. THE CONTRACTOR IS TO NOTIFY ALL UTILITY COMPANIES AND

AUTHORITIES PRIOR TO ANY EXCAVATION AND ASCERTAIN LOCATIONS OF UNDERGROUND SERVICES.

3. THE CONTRACTOR IS TO REINSTATE ALL AREAS AND ITEMS DAMAGED AS A RESULT OF CONSTRUCTION ACTIVITY.

4. THE CONTRACTOR IS TO COMPLY WITH ALL PERTINENT CODES AND BY-LAWS. 5. THE CONTRACTOR IS TO MAINTAIN A POSITIVE SURFACE RUN-O

6. THE LANDSCAPE ARCHITECT IS NOT RESPONSIBLE FOR SUBSURFACE CONDITIONS. 7. THE CONTRACTOR IS TO IDENTIFY ALL EXISTING TREES TO

THROUGHOUT THE ENTIRE CONSTRUCTION PERIOD.

REMAIN ON SITE WITH THE LANDSCAPE ARCHITECT PRIOR TO 8. THE CONTRACTOR IS TO STAKE THE PROPOSED LOCATION OF ALL PLANT MATERIAL IN CONJUNCTION WITH THE LANDSCAPE

ARCHITECT PRIOR TO EXCAVATION. 9. MINIMUM DISTANCES FOR SELECTED DECIDUOUS TREES ARE A FOLLOWS:

BUILDING FOUNDATIONS 7.5M SIDEWALKS 1.5M

PUBLIC STREETS 2.5M UNDERGROUND INFRASTRUCTURE 2.0M

10. ALL TREES WITHIN 1M OF UNDERGROUND UTILITY TRENCHES ARE TO BE EXCAVATED BY HAND.

11. REMOVE ALL PROTECTIVE WRAPPING FROM TREE TRUNKS AFTER INSTALLATION.

12. STAKING OF TREES SHALL ONLY BE PERFORMED IF NECESSAF

13. ENSURE THAT MULCH IS PULLED BACK A MIN. DISTANCE OF


75MM FROM BASE OF TREE TRUNK.

12	REVISED TO SUIT NEW BUS STOP	04/30/2021	WF	JL
11	ISSUED FOR COORDINATION	03/29/2021	WF	JL
10	ISSUED FOR COORDINATION	03/23/2021	WF	JL
9	REVISED FOR SITE PLAN APPROVAL	03/10/2021	WF	JL
8	REVISED PER FORESTRY COMMENTS	02/12/2021	ML	JL
7	2000mm DIMENSIONS ADDED TO MCRAE SIDEWALK	01/13/2021	ML	JL
6	REVISED PER FORESTRY COMMENTS	12/18/2020	ML	JL
5	REVISED PER FORESTRY COMMENTS	12/15/2020	ML	JL
4	REVISED PER CITY COMMENTS	12/08/2020	ML	JL
3	APPLICATION AND PROJECT NUMBERS ADDED	12/07/2020	ML	JL
2	ISSUED FOR COORDINATION AND REVIEW	09/23/2020	ML	JL
1	ISSUED FOR SITE PLAN CONTROL	03/20/2020	ML	JL
No.	Issue	Date MM/DD/YY	DR	СК

JAMES B. LENNOX & ASSOCIATES INC. LANDSCAPE **ARCHITECTS** 3332 CARLING AVE. OTTAWA, ONTARIO K2H 5A8 Tel. (613) 722-5168 Fax. 1(866) 343-3942


MIXED USE APARTMENT BUILDING 320 McRAE AVENUE, OTTAWA, ON

LANDSCAPE PLAN

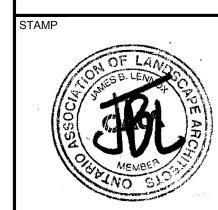

AS SHOWN TART DATE JUNE, 2019 ROJECT NO.

SCALE

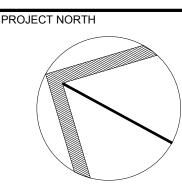

19MIS1965 DRAWING NO.

-0035

D07