

CAN CAN CAN CAN 17.5 CAN 12 14.5 WP WP 14.5 14.5 WP WP 14.5 14.5 WP WP 14.5 14.5 WP 14.5 WP 14.5 WP WP 14.5 14.5 14.5 WP

MTG. HT.

NOTE:

- ALL AREA LIGHTS ON NEW 15 FT. POLE MOUNTED ON 3 FT. CONCRETE BASE - ALL AREA LIGHT LOCATIONS PROVIDED BY OTHERS

FOOTCANDLE LEVELS CALCULATED AT GRADE USING INITIAL LUMEN VALUES								
AVG	MAX	MIN	AVG/MIN	MAX/MIN				
7.24	36.0	0.8	9.05	45.00				
0.93	17.4	0.0	N.A.	N.A.				
67.19	81	48	1.40	1.69				
	AVG 7.24 0.93	AVG MAX 7.24 36.0 0.93 17.4	AVG MAX MIN 7.24 36.0 0.8 0.93 17.4 0.0	AVG MAX MIN AVG/MIN 7.24 36.0 0.8 9.05 0.93 17.4 0.0 N.A.				

LUMINAIRE SCHEDULE										
SYMBOL	QTY	LABEL	ARRANGEMENT	LUMENS	LLF	BUG RATING	WATTS/LUMINAIRE	TOTAL WATTS	MANUFACTURER	CATALOG LOGIC
	2	A3-2	BACK-BACK	16100	1.040	B3-U0-G3	104	416	Cree Lighting	OSQ-ML-B-XX-XX + OSQM-B-16L-57K7-3M-UL-NM-XX
	3	A3B	SINGLE	12699	1.040	B2-U0-G2	104	312	Cree Inc	OSQ-ML-B-XX-XX + OSQM-B-16L-57K7-3M-UL-NM-XX + OSQ-BLSMF
	1	A4	SINGLE	16098	1.040	B3-U0-G3	104	104	Cree Inc	OSQ-ML-B-XX-XX + OSQM-B-16L-57K7-4M-UL-NM-XX
	4	A4B	SINGLE	12349	1.040	B2-U0-G2	104	416	Cree Inc	OSQ-ML-B-XX-XX + OSQM-B-16L-57K7-4M-UL-NM-XX + OSQ-BLSMF
	24	CAN	SINGLE	20332	1.040	B4-U0-G1	145.15	3483.6	Cree Inc	CPY250-B-DM-F-E-UL-XX-57K
\odot	9	L	SINGLE	1800	1.040	B1-U0-G0	20.5	184.5	Cree Lighting	LR6X-18L-40K-120V
>	12	WP	SINGLE	8543	1.040	B2-U0-G2	70.56	846.72	Cree Inc	XSPW-B-WM-3ME-8L-40K-UL-XX

ANY USE OF THIS DOCUMENTATION AND/OR OTHER ARTICLES PRODUCED BY RED LEONARD WITHOUT WRITTEN AUTHORIZATION FROM JAYME J. LEONARD IS STRICTLY PROHIBITED.

_		REV.	BY	DATE	DESC
	REDLEONARD	R1	FNE	4/16/21	REVISED AREA LIGHT L LIGHTING AT ENTRANCES
'II (()	ASSOCIATES	_			

1340 Kemper Meadow Dr, Forest Park, OH 45240 513-574-9500 | redleonard.com

IT LOCATIONS TO GET BETTER ES & REDUCE AMOUNT OF POLES

DISCLAIMER ANY SITE PLAN(S), FLOOR PLAN(S), RENDERING(S), LIGHTING LAYOUT(S) AND PHOTOMETRIC PLAN(S) INCLUDING BUT NOT LIMITED TO ANY PROJECT(S) CREATED/PRODUCED BY RED LEONARD ASSOCIATES INC., ARE ONLY INTENDED FOR ILLUSTRATION AND QUOTING PURPOSES ONLY. RED LEONARD ASSOCIATES HAS THE RIGHT TO USE THIRD PARTY LASERS, SCANNERS, AND CAMERAS BUT ACTUAL PROJECT CONDITIONS, DIMENSIONS, AND ACCURACY OF MEASUREMENTS MAY DIFFER FROM THESE OR ANY PARAMETERS. RED LEONARD ASSOCIATES INC. ASSUMES NO LIABILITY FOR WHAT IS CREATED/PRODUCED IN THESE RECREATIONS. THIS INCLUDES BUT IS NOT LIMITED TO THE USE OF, INSTALLATION OF AND/OR INTEGRITY OF EXISTING BUILDING(S), SURROUNDING AREA FOR PRODUCT(S) SUCH AS EXISTING POLE(S), ANCHOR BOLT(S), BASE(S), ARCHITECTURAL AND SIGNAGE STRUCTURE(S), LANDSCAPING PLAN(S), LIGHTING PLAN(S), FIXTURE SELECTION(S) AND PLACEMENT, MATERIAL(S), COLOR ACCURACY, TEXTURE(S), AND ANYTHING ATTRIBUTED TO PHOTO REALISM THAT IS CREATED. FURTHERMORE, RED LEONARD ASSOCIATES INC., DOES NOT ASSUME LIABILITY WHATSOEVER FOR ANY PURCHASES MADE BY CLIENT BEFORE, DURING, OR AT THE CONCLUSION OF THE PUBLISHED WORK. THE CUSTOMER, ITS RELATIVE AFFILIATES, AS WELL AS ANY OTHER PERSON(S) IN VIEWING OF THIS PRODUCT IS RESPONSIBLE FOR VERIFYING COMPLIANCE WITH ANY BUT NOT LIMITED TO ALL CODES, PERMITS, RESTRICTIONS, INSTRUCTIONS, PURCHASES, AND INSTALLATIONS OF OBJECTS VIEWED WITHIN THIS DOCUMENT(S) OR PROJECT(S). SYMBOLS ARE NOT DRAWN TO SCALE. SIZE IS FOR CLARITY PURPOSES ONLY. SIZES AND DIMENSIONS ARE APPROXIMATE, ACTUAL MEASUREMENTS MAY VARY. DRAWINGS ARE NOT INTENDED FOR ENGINEERING OR CONSTRUCTION USE. THIS DOCUMENT, ANY RED LEONARD DRAWING(S), OR PROJECT(S) IS NOT TO BE USED AND/OR INTENDED FOR ENGINEERING OR CONSTRUCTION PURPOSES, BUT FOR ILLUSTRATIVE PURPOSES ONLY. ANY LOCATIONS OF EMERGENCY LIGHTING SHOWN WERE PROVIDED BY OTHERS. RED LEONARD ASSOCIATES IS NOT RESPONSIBLE FOR INSUFFICIENT LIGHTING DURING AN EMERGENCY EVENT.


SCALE: LAYOUT BY: 1" = 30' FNE DWG SIZE: DATE:

D

4/9/21

CIRCLE K OTTAWA, ON RL-7298-S1-R1



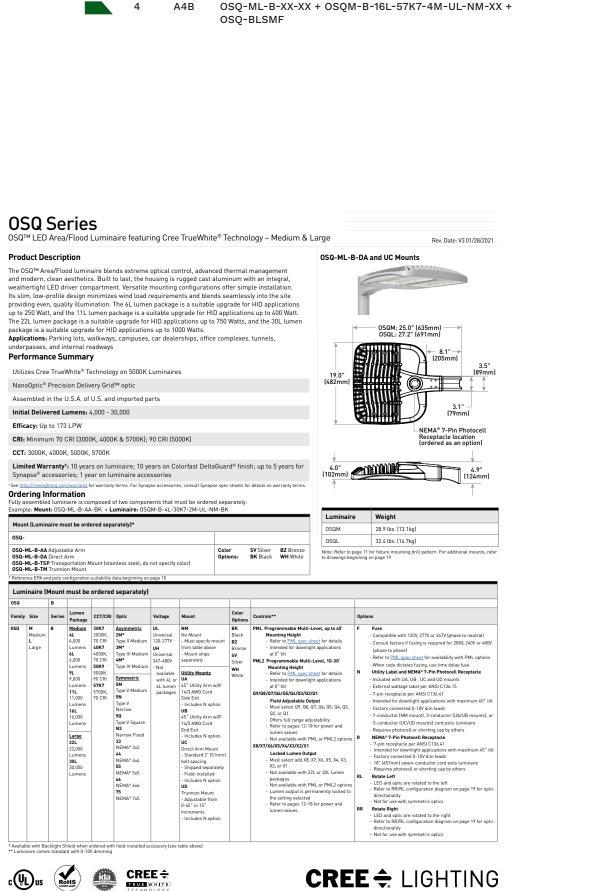


QTY LABEL DESCRIPTION


AREA 2 A3-2 OSQ-ML-B-XX-XX + OSQM-B-16L-57K7-3M-UL-NM-XX

A3B OSQ-ML-B-XX-XX + OSQM-B-16L-57K7-3M-UL-NM-XX +

A4 OSQ-ML-B-XX-XX + OSQM-B-16L-57K7-4M-UL-NM-XX

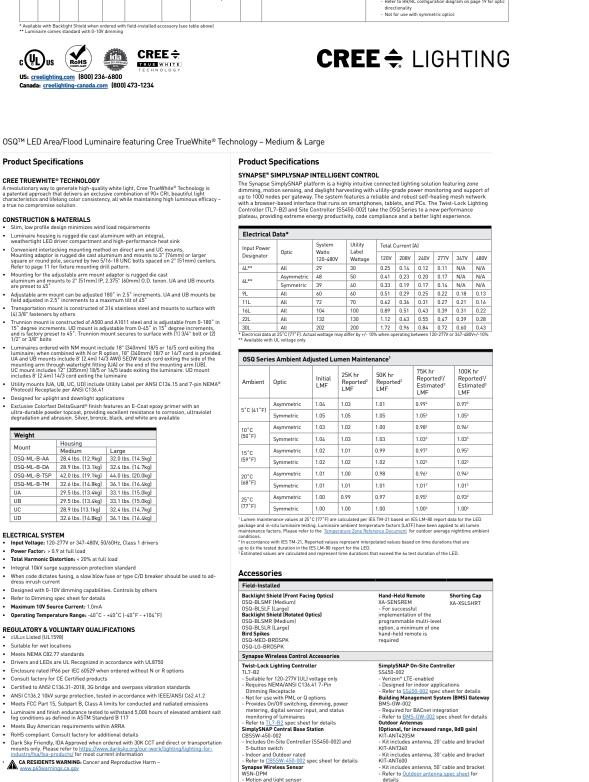


CREE & LIGHTING

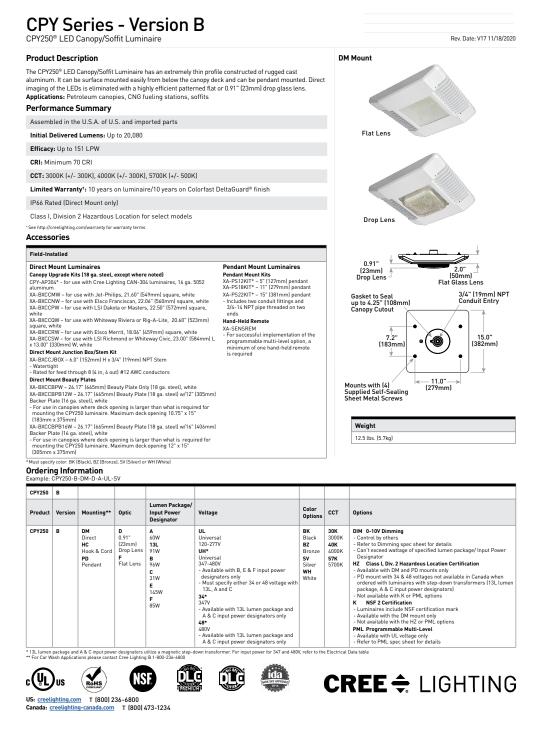

OTY LABEL DESCRIPTION


24 CAN CPY250-B-DM-F-E-UL-XX-57K

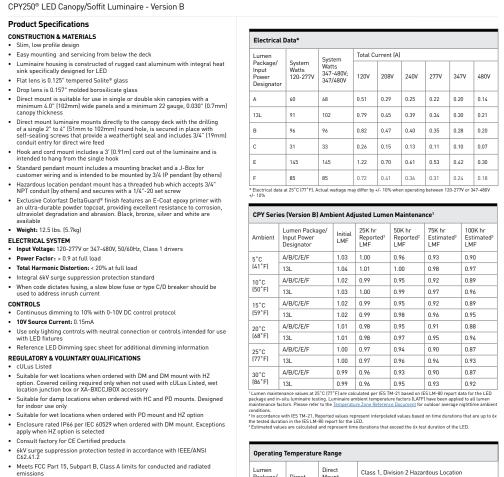


RoHS compliant. Consult factory for additional details

CA RESIDENTS WARNING: Cancer and Reproductive Harm –


US: creelighting.com T (800) 236-6800 Canada: creelighting-canada.com T (800) 473-1234

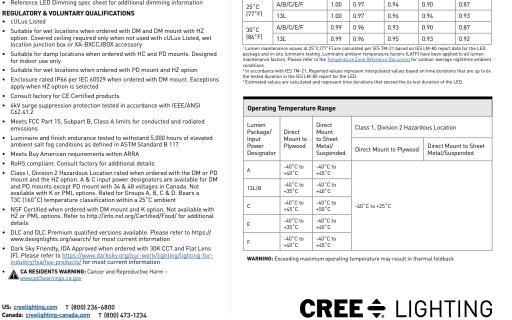


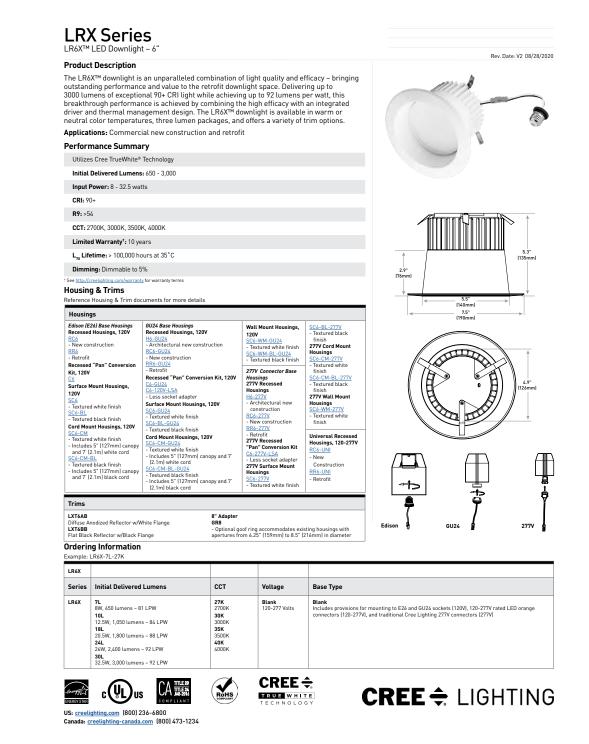

QTY LABEL DESCRIPTION

9 L LR6X-18L-40K-120V

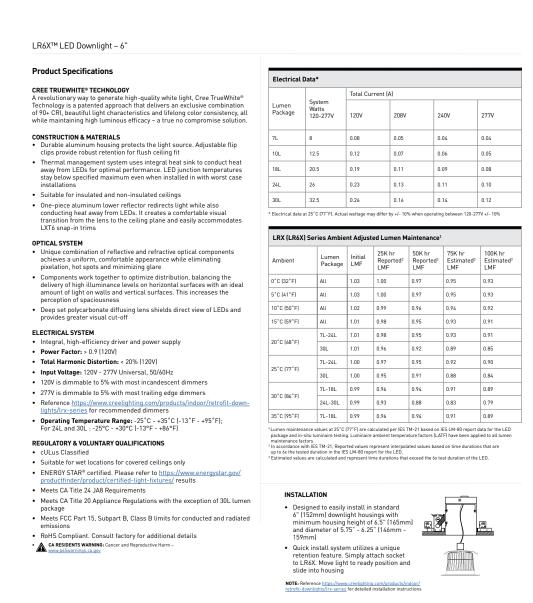


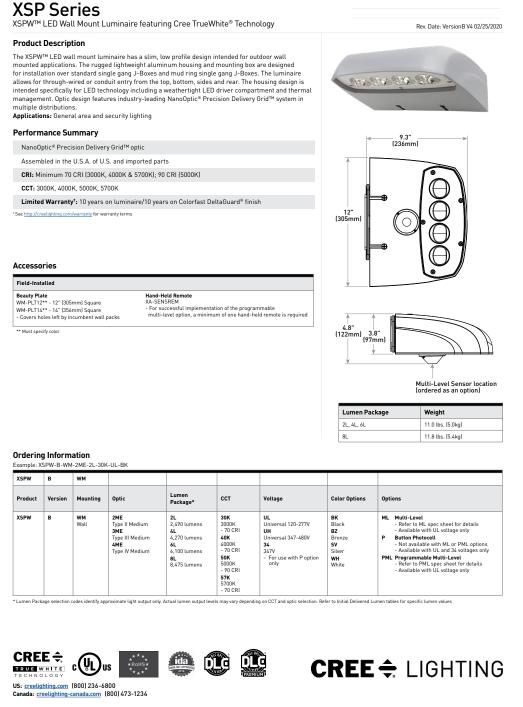

QTY LABEL DESCRIPTION

12 WP XSPW-B-WM-3ME-8L-40K-UL-XX

WALL MOUNTED

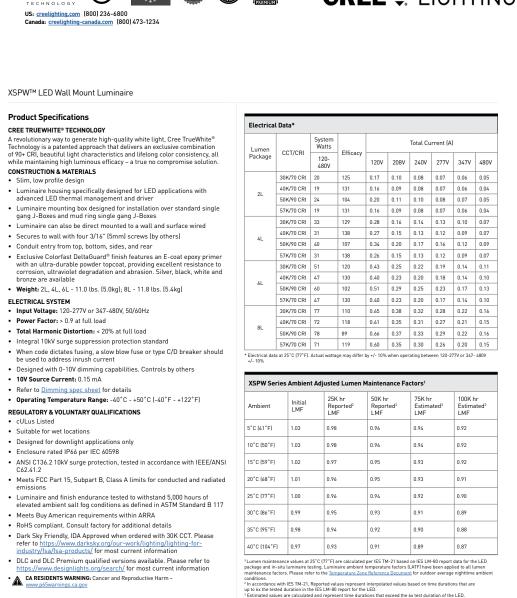

CREE
LIGHTING US: creelighting.com (800) 236-6800 Canada: creelighting-canada.com (800) 473-1234 US: <u>creelighting.com</u> (800) 236-6800 Canada: creelighting-canada.com [800] 473-1234

PROJECT NAME:



US: <u>creelighting.com</u> (800) 236-6800

Canada: creelighting-canada.com [800] 473-1234

US: creelighting.com (800) 236-6800 Canada: creelighting-canada.com (800) 4

Product Specifications

CREE TRUEWHITE® TECHNOLOGY

CONSTRUCTION & MATERIALS

Luminaire housing is rugged die cast aluminum with an integral, weathertight LED driver compartment and high-performance heat sink

 Weight

 Mount
 Housing Medium
 Large

 OSG-ML-B-AA
 28.4 lbs. [12.9kg]
 32.0 lbs. [14.5kg]

 OSG-ML-B-DA
 28.9 lbs. [13.1kg]
 32.4 lbs. [14.7kg]

 OSG-ML-B-TSP
 42.0 lbs. [19.1kg]
 46.0 lbs. [20.0kg]

 OSG-ML-B-TM
 32.6 lbs. [14.8kg]
 36.1 lbs. [15.0kg]

 UA
 29.5 lbs. [13.4kg]
 33.1 lbs. [15.0kg]

 UB
 29.5 lbs. [13.4kg]
 33.1 lbs. [15.0kg]

 UC
 28.9 lbs [13.1kg]
 32.4 lbs. [14.7kg]

 UD
 32.6 lbs. [14.8kg]
 36.1 lbs. [16.4kg]

ELECTRICAL SYSTEM

Input Voltage: 120-277V or 347-480V, 50/60Hz, Class 1 drivers

Power Factor: > 0.9 at full load

Total Harmonic Distortion: < 20% at full load

Designed with 0-10V dimming capabilities. Controls by other

Refer to Dimming Specialized to details
 Maximum 10V Source Current: 1.0mA
 Operating Temperature Range: -40°C -+40°C [-40°F -+104°F]


REGULATORY & VOLUNTARY QUALIFICATIONS

When code dictates fusing, a slow blow fuse or type C/D breaker should b dress inrush current


ANY SITE PLAN(S), FLOOR PLAN(S), RENDERING(S), LIGHTING LAYOUT(S) AND PHOTOMETRIC PLAN(S) INCLUDING BUT NOT LIMITED TO ANY PROJECT(S) CREATED/PRODUCED BY RED LEONARD ASSOCIATES INC., ARE ONLY INTENDED FOR ILLUSTRATION AND QUOTING PURPOSES ONLY. RED LEONARD ASSOCIATES HAS THE RIGHT TO USE THIRD PARTY LASERS, SCANNERS, AND CAMERAS BUT ACTUAL PROJECT CONDITIONS, DIMENSIONS, AND ACCURACY OF MEASUREMENTS MAY DIFFER FROM THESE OR ANY PARAMETERS. RED LEONARD ASSOCIATES INC. ASSUMES NO LIABILITY FOR WHAT IS CREATED/PRODUCED IN THESE RECREATIONS. THIS INCLUDES BUT IS NOT LIMITED TO THE USE OF, INSTALLATION OF AND/OR INTEGRITY OF EXISTING BUILDING(S), SURROUNDING AREA FOR PRODUCT(S) SUCH AS EXISTING POLE(S), ANCHOR BOLT(S), BASE(S), ARCHITECTURAL AND SIGNAGE STRUCTURE(S), LANDSCAPING PLAN(S), LIGHTING PLAN(S), FIXTURE SELECTION(S) AND PLACEMENT, MATERIAL(S), COLOR ACCURACY, TEXTURE(S), AND ANYTHING ATTRIBUTED TO PHOTO REALISM THAT IS CREATED, FURTHERMORE, RED LEONARD ASSOCIATES INC., DOES NOT ASSUME LIABILITY WHATSOEVER FOR ANY PURCHASES MADE BY CLIENT BEFORE, DURING, OR AT THE CONCLUSION OF THE PUBLISHED WORK, THE CUSTOMER, ITS RELATIVE AFFILIATES, AS WELL AS ANY OTHER PERSON(S) IN VIEWING OF THIS PRODUCT IS RESPONSIBLE FOR VERIFYING COMPLIANCE WITH ANY BUT NOT LIMITED TO ALL CODES, PERMITS, RESTRICTIONS, INSTRUCTIONS, PURCHASES, AND INSTALLATIONS OF OBJECTS VIEWED WITHIN THIS DOCUMENT(S) OR PROJECT(S), SYMBOLS ARE NOT DRAWN TO SCALE. SIZE IS FOR CLARITY PURPOSES ONLY, SIZES AND DIMENSIONS ARE APPROXIMATE. ACTUAL MEASUREMENTS MAY VARY, DRAWINGS ARE NOT INTENDED FOR ENGINEERING OR CONSTRUCTION USE. THIS DOCUMENT, ANY RED LEONARD DRAWING(S), OR PROJECT(S) IS NOT TO BE USED AND/OR INTENDED FOR ENGINEERING OR CONSTRUCTION PURPOSES, BUT FOR ILLUSTRATIVE PURPOSES ONLY. ANY USE OF THIS DOCUMENTATION AND/OR OTHER ARTICLES PRODUCED BY RED LEONARD WITHOUT WRITTEN AUTHORIZATION FROM JAYME J. LEONARD IS STRICTLY PROHIBITED.

CIRCLE K OTTAWA, ON DRAWING NUMBER: RL-7298-S1-R1



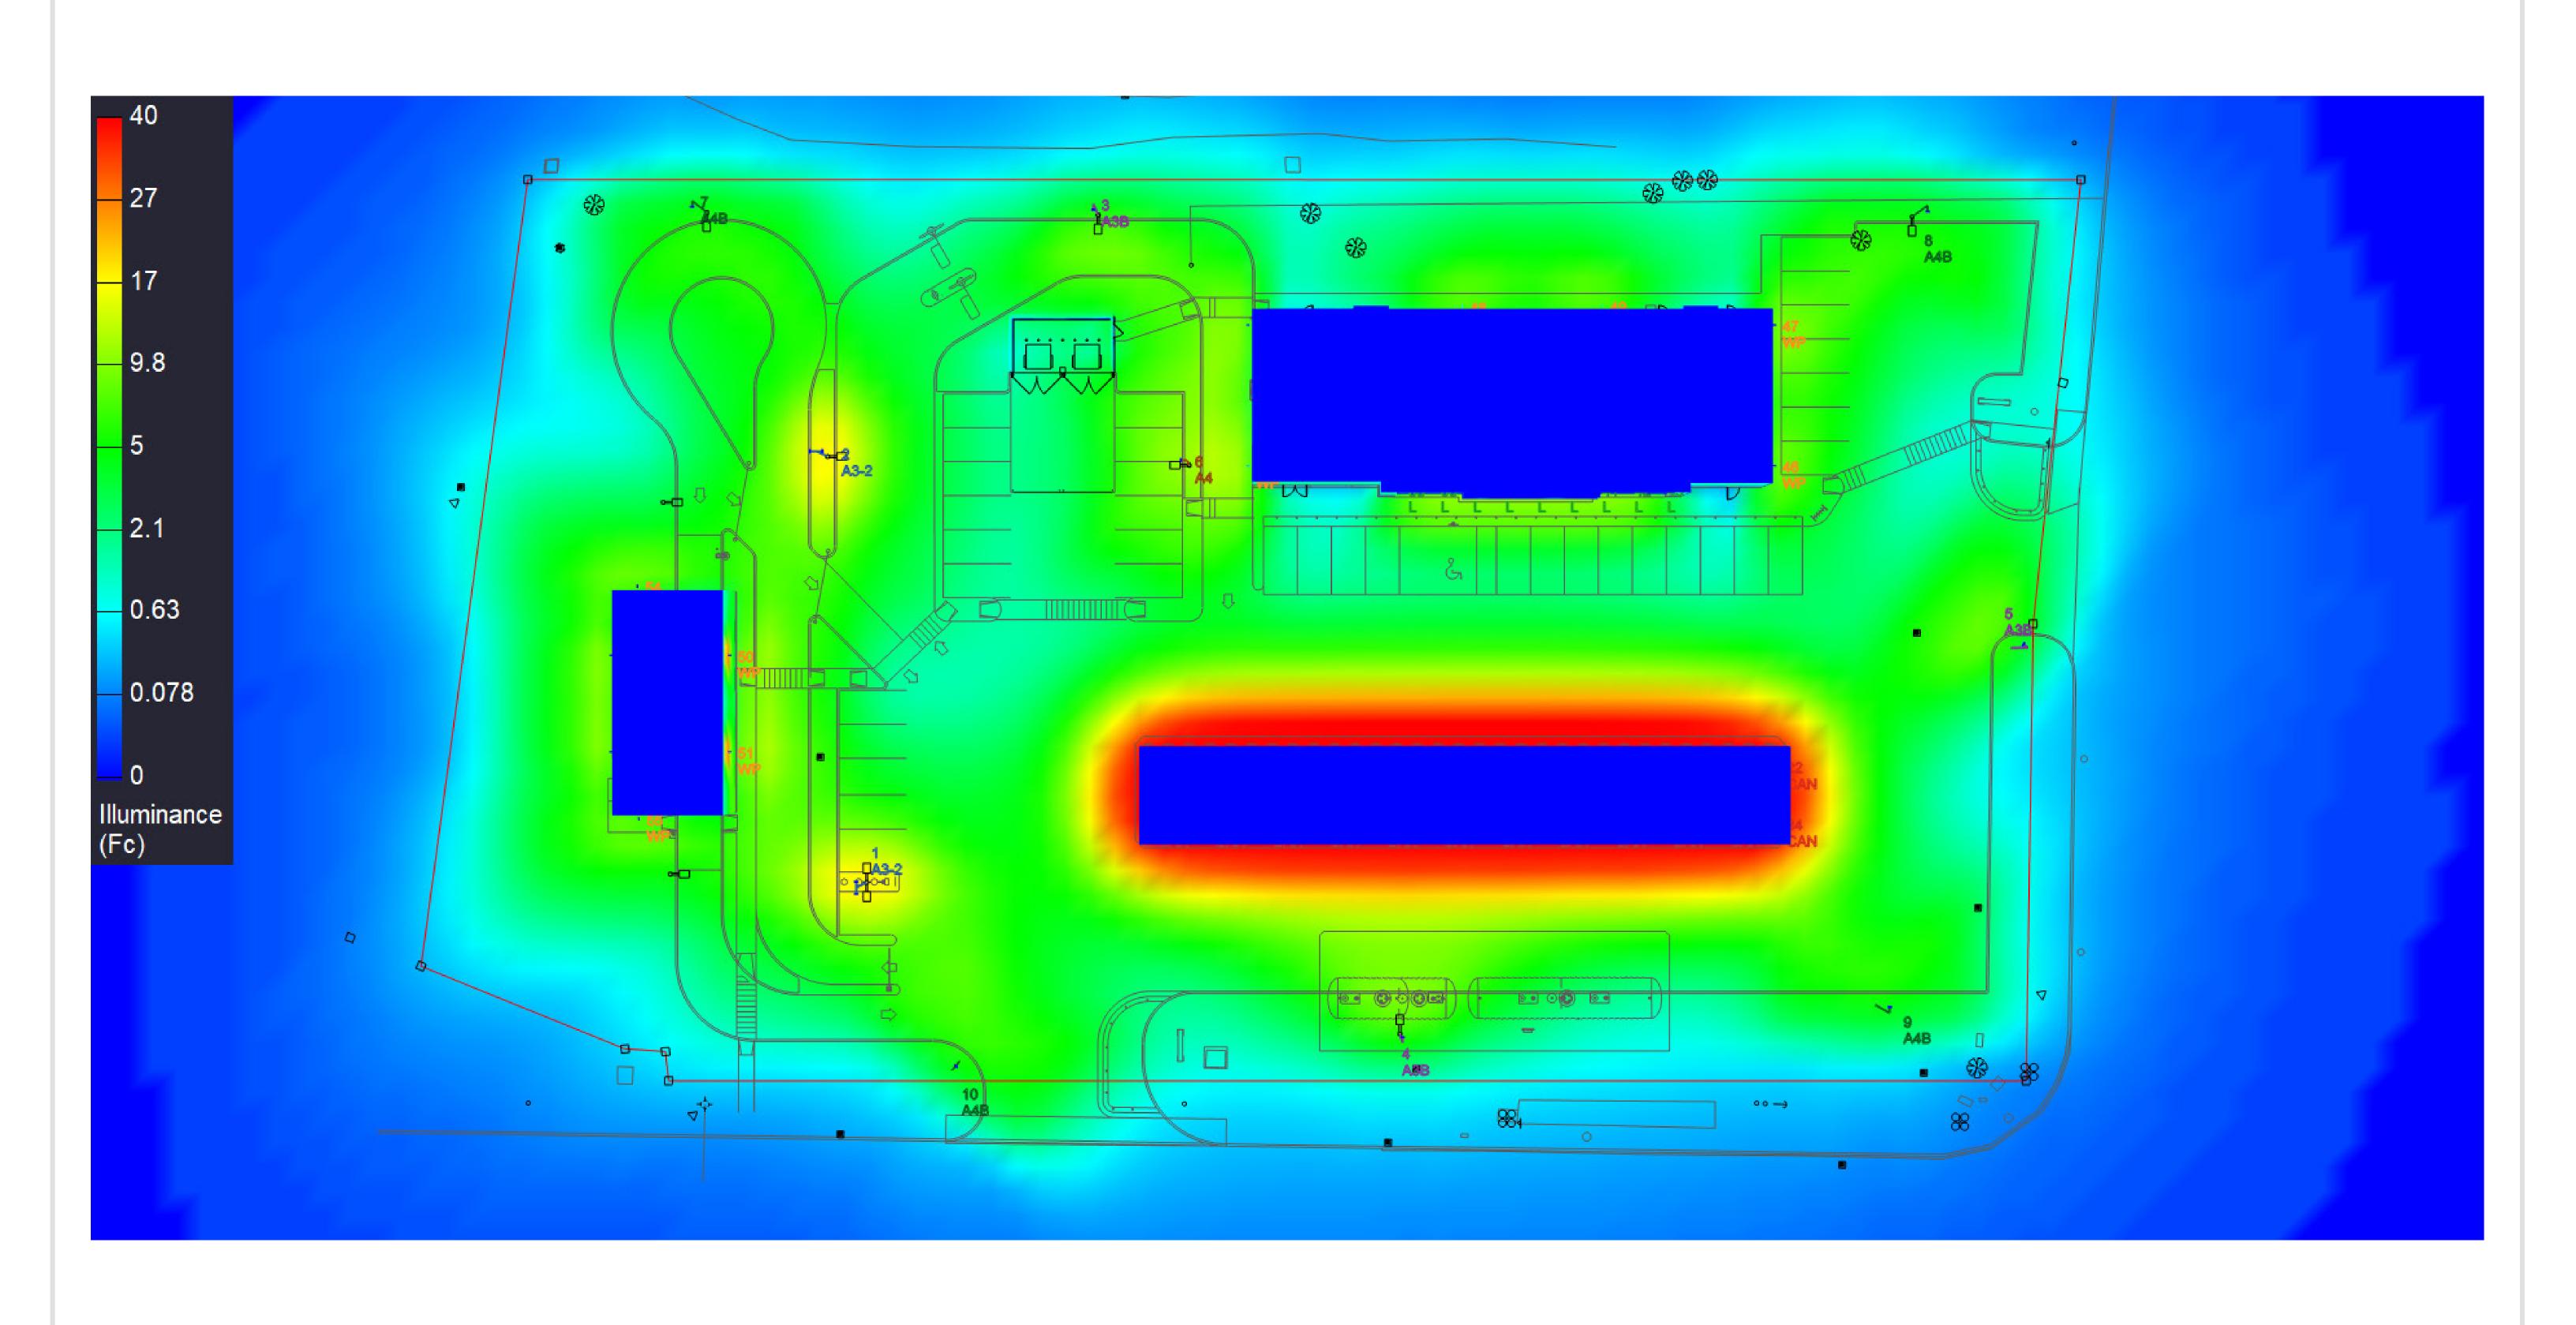



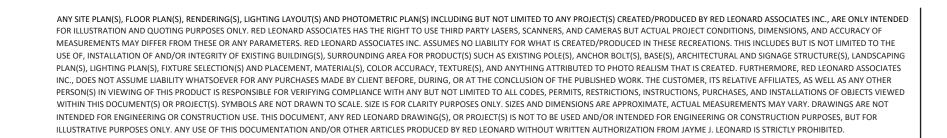

CIRCLE K
OTTAWA, ON
DRAWING NUMBER:
RL-7298-S1-R1



