

OVERALL SITE PLAN

A100 1:500

SITE PLAN NOTES

- CONTRACTOR TO MAKE GOOD ALL EXISTING AREAS (INSIDE OR OUTSIDE THE PROPERTY LINE) DISTURBED OR DAMAGED DURING PERIOD OF CONSTRUCTION, WHETHER SHOWN ON DRAWINGS OR NOT.
- 2. SITE PLANS ARE TO BE READ IN CONJUNCTION WITH DETAILS AND INFORMATION SHOWN ELSEWHERE ON DRAWINGS. IN THE EVENT OF DISCREPANCIES THE MORE STRINGENT REQUIREMENT SHALL GOVERN.
- 3. ALL EXCAVATION SHALL BE UNDERTAKEN IN SUCH A MANNER AS TO PREVENT MOVEMENT WHICH WOULD CAUSE DAMAGE TO ADJACENT PROPERTIES, EXISTING STRUCTURES, UTILITIES, ROADS & SIDEWALS, ETC. AT ALL STAGES OF CONSTRUCTION. EXCAVATIONS THAT EXCEED 1.2 M (4 FT.) IN DEPTH SHALL BE SHORED OR CUT BACK AT THE TOP SO THAT THE ANGLE OF THE CUT DOES NOT EXCEED 1:1 SLOPE. IF SHORING IS TO BE PROVIDED, SUBMIT DRAWINGS WITH DESIGN PARAMETERS CLEARLY STATED AND PREPARED BY P. ENG. (REGISTERED IN ONTARIO) WITH SEAL AND SIGNATURE, FOE APPROVAL UNDER SEPARATE PERMIT APPLICATION.
- 4. DISTANCES SHOWN ON THIS PLAN ARE IN METERS AND CAN BE CONVERTED TO FEET BY DIVIDING BY 0.3048.
- 5. DO NOT DISTURB OR RENOVE ANY EXISTING VEGETATION (TREES, SHRUBS, GROUND COVER, ETC.) WITHOUT ARCHITECT'S WRITTEN APPROVAL.

PARKING CALCULATION PARKING REQUIREMENTS FROM ZONING BY-LAW 2008-250

PARKING REQUIRED FOR CITY OF OTTAWA

1. ZONING REQUIRES NO PARKING

2. BARRIER FREE PARKING FOR 76-100 TOTAL SPACES - 4 SPACES (2 TYPE A + 2 TYPE B)

3. BICYCLE PARKING = 10,600 m2 / 1500 m2 = 8 SPACES

4. PARKING PROVIDED 63 STANDARD SPACES

18 REDUCED WIDTH SPACES (22% of TOTAL PROVIDED)

4 BARRIER FREE SPACES

TOTAL - 85 SPACES 8 BICYCLE PARKING SPACES

NOTE: UP TO 40% OF THE PROVIDED PARKING SPACES MAY BE REDUCED TO A MINIMUM WIDTH OF 2.4 METRES

Survey information based on drawing ACAD-Aecon-asbuilt surface-20200114.dwg received from Ainley on January 14, 2020.

LANDSCAPING CALCULATION

LANDSCAPING SURROUNDING PARKING (within 3 m) REQUIRED FOR CITY OF OTTAWA

TOTAL LANDSCAPED AREA (WITHIN 3 m OF PARKING LOT) = 840 m²
TOTAL AREA (PARKING LOT + SURROUNDING 3 m) = $3,075 \text{ m}^2$

LANDSCAPED AREA = 27.3% OF TOTAL AREA

	NEW BUILDING	∞XFH	EXISTING FIRE HYDRANT
	LIGHT DUTY ASPHALT	XCB	EXISTING CATCH BASIN
	HEAVY DUTY ASPHALT	XMH	EXISTING MANHOLE
	PROPERTY LINE	¤	PROPOSED SOFFIT MOUNTED LIGHT FIXTURE
	CHAIN LINK FENCE	W	PROPOSED WALL MOUNT LIGHT FIXTURE
	MAIN ENTRANCE / PRINCIPAL ENTRANCE	_p B	PROPOSED BOLLARD LIGHT FIXTURE
	SERVICE ENTRANCE	Ŭ- _P	PROPOSED LIGHT POLE
A	SECONDARY BUILDING ENTRANCE	BF	BARRIER-FREE PARKING STALL SIGN
	SECONDARY PRINCIPAL ENTRANCE	FR	FIRE ROUTE, NO PARKING SIGN
•	EMERGENCY EXIT	∳- HP	HYDRO POLE
6	BARRIER FREE PARKING STALL		BENCH
	CONCRETE SIDEWALK OR PAD	0	BORE HOLE LOCATION AND NUMBER
	1 IN 12 SLOPE DOWN TO DEPRESSED CURB		SNOW STORAGE LOCATION NOTE: ACCUMULATED SNOW TO BE REMOVED FROM SITE
DC	DEPRESSED CURB		FIRE ROUTE - CENTRELINE AND WIDTH

MUNICIPAL REVIEW		SITE DATA		
PROJECT NO.	1844	850 CHAMPLAIN STREET OTTAWA ONTARIO K1C 1K3		
DESCRIPTION		5 STOREY, 320 BED LONG TERM CARE FACILITY		
OFFICIAL PLAN		MIXED USE CENTRE / TOWN CENTRE		
ZONING BY-LAW		2008-250		
ZONING		MC[2179]		
PERMITTED USES		RESIDENTIAL CARE FACILITY		
REGULATION		REQUIREMENT	ACTUAL	
LOT AREA		NO MINIMUM	10 445 m ² (2.6 ACRES)	
LOT WIDTH		NO MINIMUM	90.1 m	
MAX. FLOOR SPACE	INDEX (FSI)	NO MAXIMUM	1.01 (OZBL) or 1.68 (normal G	
FRONT YARD		NO MINIMUM	+/- 1.30 m DISTANCE WILL CHANGE GI DESIGN-BUILD PREFAB MOI CONSTRUCTION PROCESS	
REAR YARD		NO MINIMUM	0.05 m	
INTERIOR SIDE YARE)	NO MINIMUM	N/A	
EXTERIOR SIDE YAR (CORNER SIDE YARD		NO MINIMUM	0.05 m (E) and 18.60 m (W)	
BUILDING HEIGHT		MINIMUM HEIGHT 6.7m	26.3 m	
(AS DEFINED BY OZBL)		NO MAXIMUM HEIGHT		
BUILDING FOOTPRIN	T AREA		3330.0 m ²	
GROSS FLOOR AREA			10 600 m ²	
(AS DEFINED BY OZBL)			(AS DEFINED BY OZBL)	
OPEN SPACE AREA			7281.2 m ²	

MUNICIPAL REVIEW	PARKIN	PARKING DATA		
REGULATION	REQUIREMENT	ACTUAL		
PARKING	NO MINIMUM	REFER TO PARKING CALCULATIONS ON THIS DRAWING		
DRIVING LANE WIDTH	MINIMUM 6.7 m	6.7 m		
PARKING AISLE WIDTH	MINIMUM 6.7 m	6.7 m		
PARKING SPACE	MINIMUM 2.6 m x 5.2 m	2.6 m x 5.2 m		
LANDSCAPING	15% OF PARKING LOT (INCLUDING LANDSCAPED BUFFER & INTERIOR LANDSCAPING)	27.3% (840 m ²) OF PARKING LO (INCLUDING LANDSCAPED BUFFER & INTERIOR LANDSCAPING)		
LANDSCAPED BUFFER AROUND PARKING LOT	ABUTTING STREET = 3 m NOT ABUTTING STREET = 1.5 m	ABUTTING STREET = 3 m NOT ABUTTING STREET = 1.5 m		

MUNICIPAL REVIEW	LOADING AREA DATA		
REGULATION	REQUIREMENT	ACTUAL	
MINIMUM NUMBER OF SPACES	2 SPACES	2 SPACES	
MINIMUM LOADING DIMENSIONS	3.5 m x 5.2 m	3.5 m x 9.0 m	
MINIMUM WIDTH OF DRIVEWAY ACCESSING LOADING SPACE	MINIMUM 6.7 m	6.7 m	
REQUIRED SCREENING	MINIMUM 2 m HIGH OPAQUE SCREEN	3.5 m HIGH RETAINING WALL AND 1.8m FENCE	
LOCATION	MINIMUM 9 m FROM LOT LINE ABUTTING PUBLIC STREET	22.0 m	

MUNICIPAL REVIEW

1:1

Planner & Landscape:
FOTENN Planning + Design
223 McLeod Street
Ottawa, ON, K2P 0Z8

Structural:
Entuitive
200 University Avenue, 7th Floor
Toronto, ON, M5H 3C6

Mechanical & Electrical:

499 King Street East, Suite 200 Hamilton, ON, L8N 1E1

Ainley Graham & Associates Limited 2724 Fenton Road

Geotechnical:
Paterson Group
154 Colonnade Road South
Ottawa, ON, K2E 7J5

Ottawa, ON, K1T 3T7

Transportation:

Parsons Transportation Group
1223 Michael Street, Suite 100
Ottawa, ON, K1J 7T2

Noise/Wind:
Gradient Wind Engineering Inc.
127 Walgreen Road
Ottawa, ON, K0A 1L0

Environmental
Kilgour & Associates LTD
2285 St. Laurent Boulevard
Ottawa, ON, K1G 4Z6

Prints issued to			
Particulars	No.	Date	
ISSUED FOR SPA 1ST SUBMIT	1	20/07/02	
ISSUED FOR UDRP PACKAGE	2	20/09/17	
ISSUED FOR SPARESUBMIT	3	20/12/16	
Particulars	No.	Date	ı

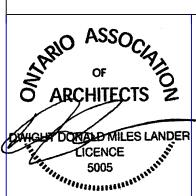
Revisions to drawing

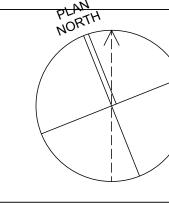
All previous issues of this drawing are superseded.



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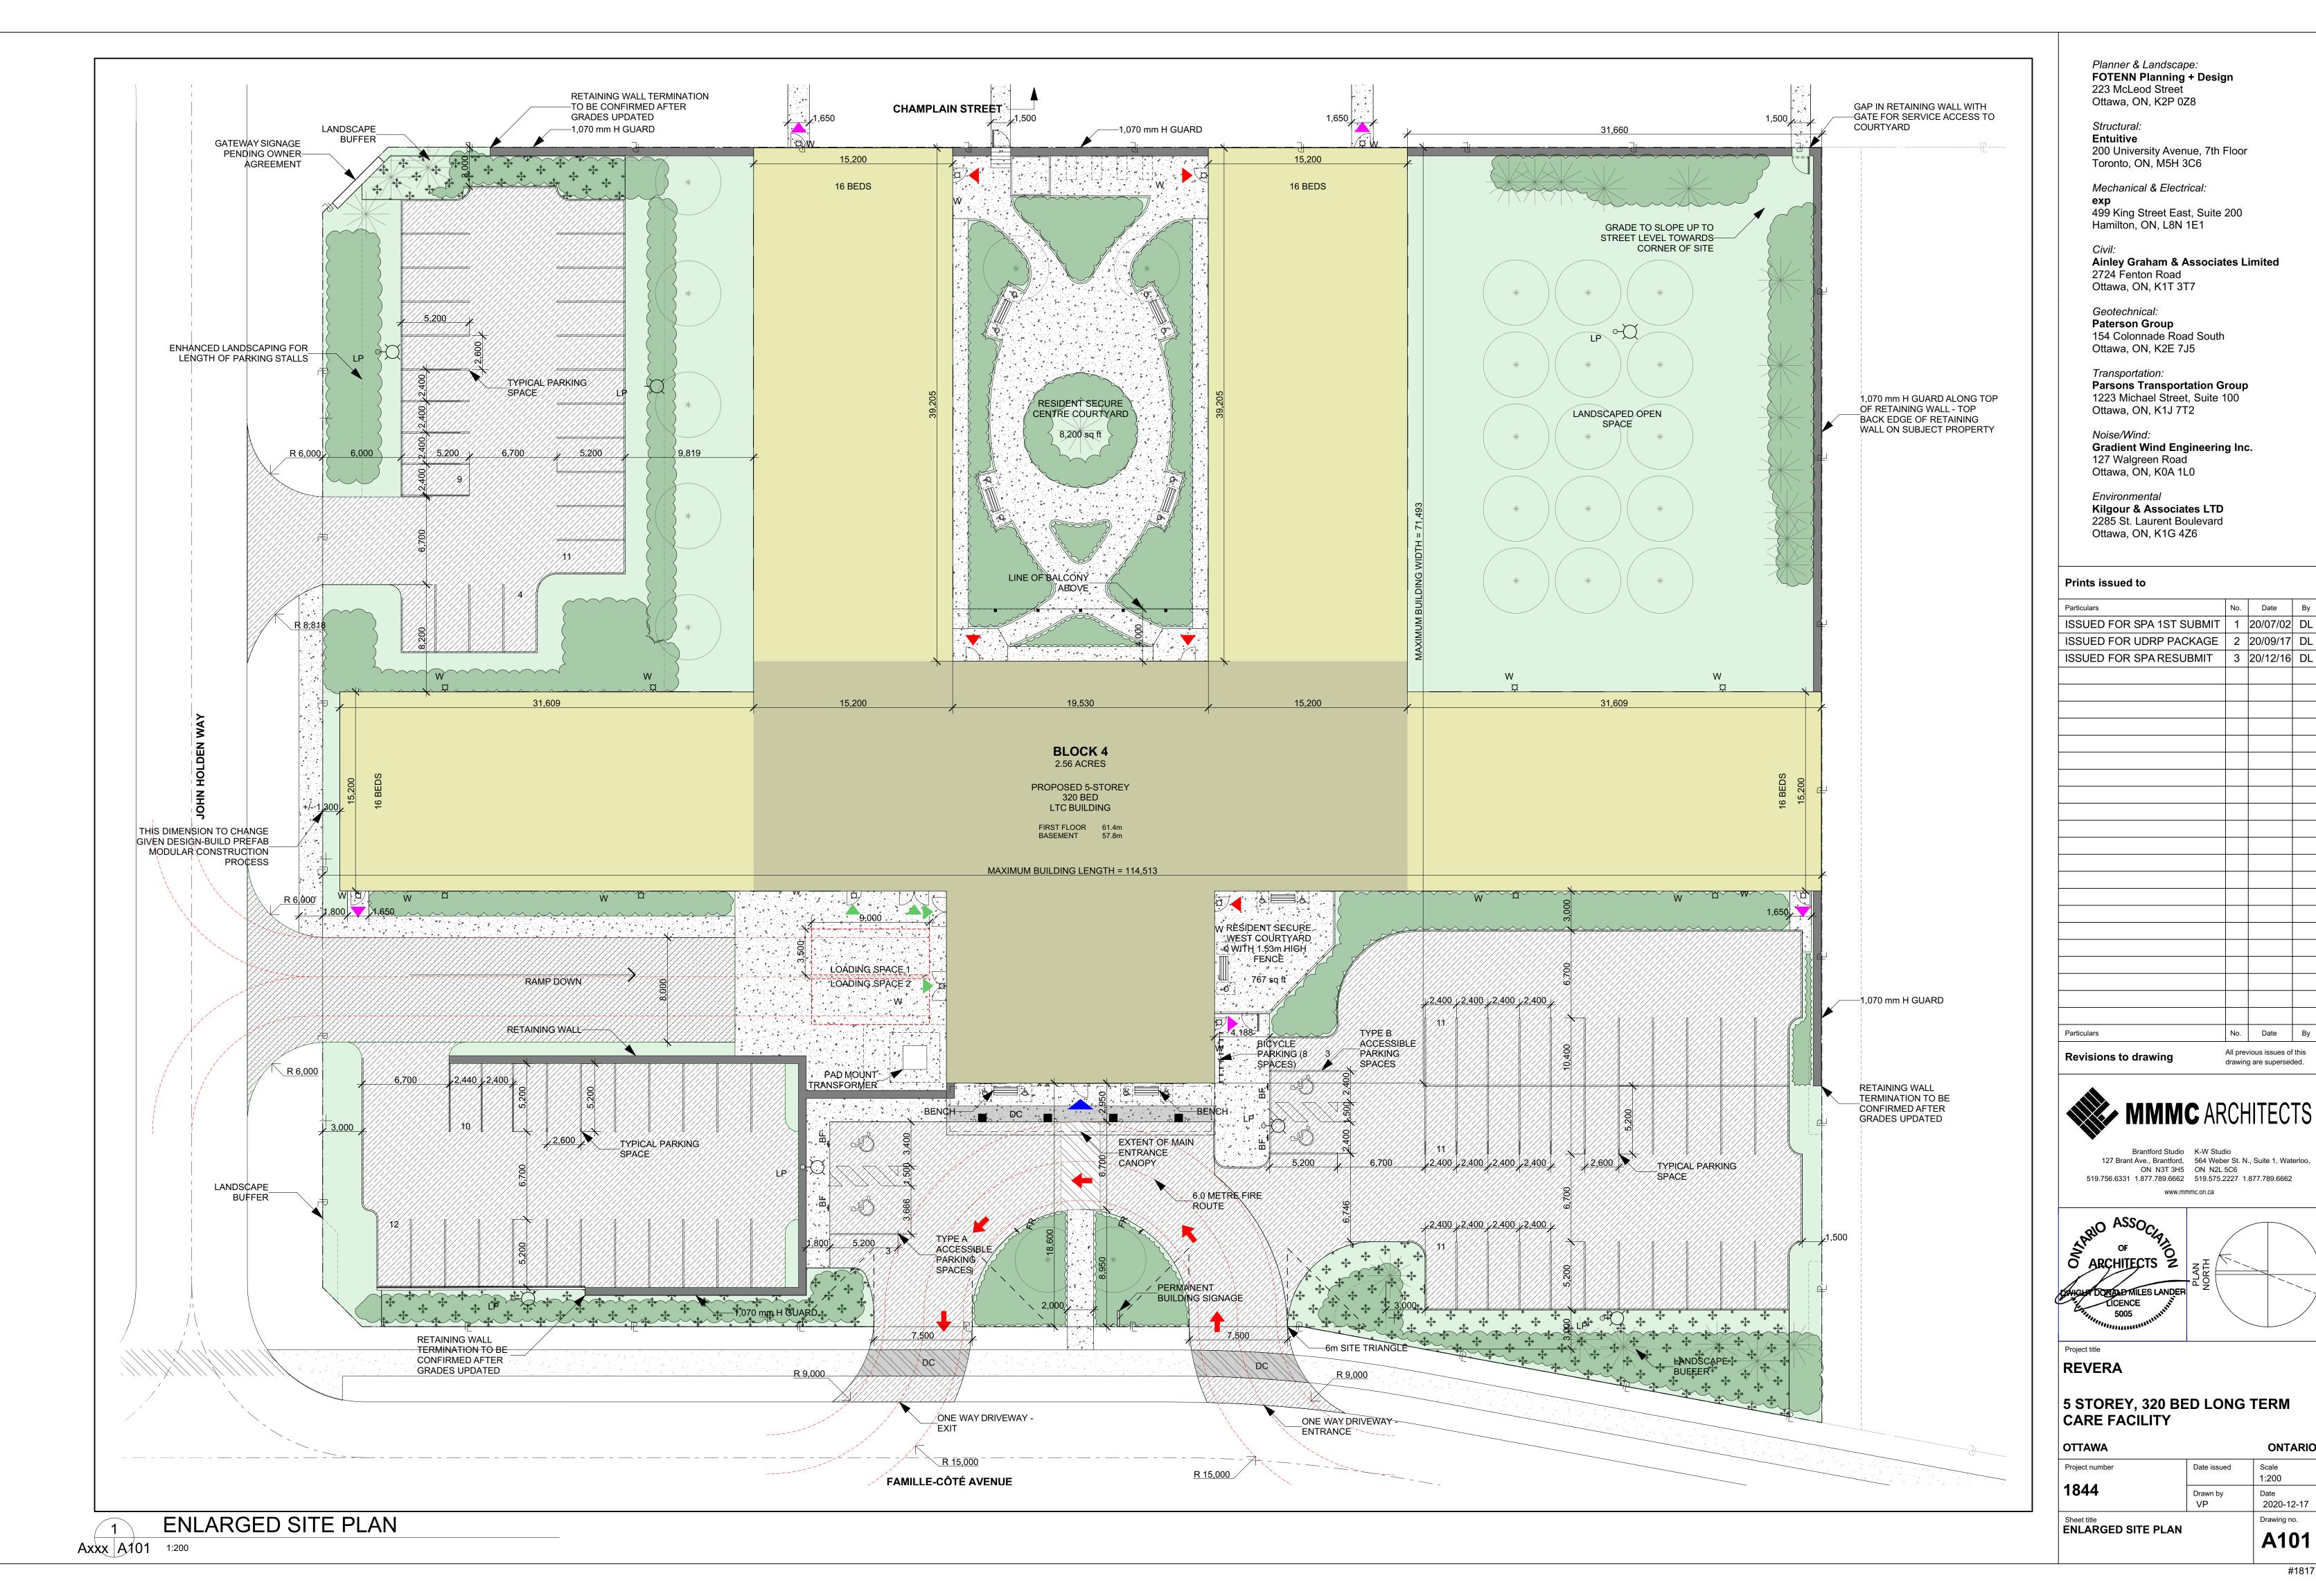
REVERA

5 STOREY, 320 BED LONG TERM CARE FACILITY

OTTAWA		ONTARIO
Project number	Date issued	Scale 1:500
1844	Drawn by	Date 2020-12-17

Sheet title
SITE PLAN

Drawing no.



ONTARIO

2020-12-17

A101

Drawing no.

1:200

Date issued

Drawn by VP

No. Date By

No. Date By

All previous issues of this

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