COACH HOUSE 120 WILBERT COX DRIVE 2-BEDROOM + ATTACHED CARPORT




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Layout, Plumbing Fixtures, Smoke & CO Detectors	A0.5
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ROOF UPDATES - 27 AUGUST 2020

DRAWING NOTES

GENERAL NOTES

1. ALL DIMENSIONS IN FT-IN UNLESS OTHERWISE SPECIFIED

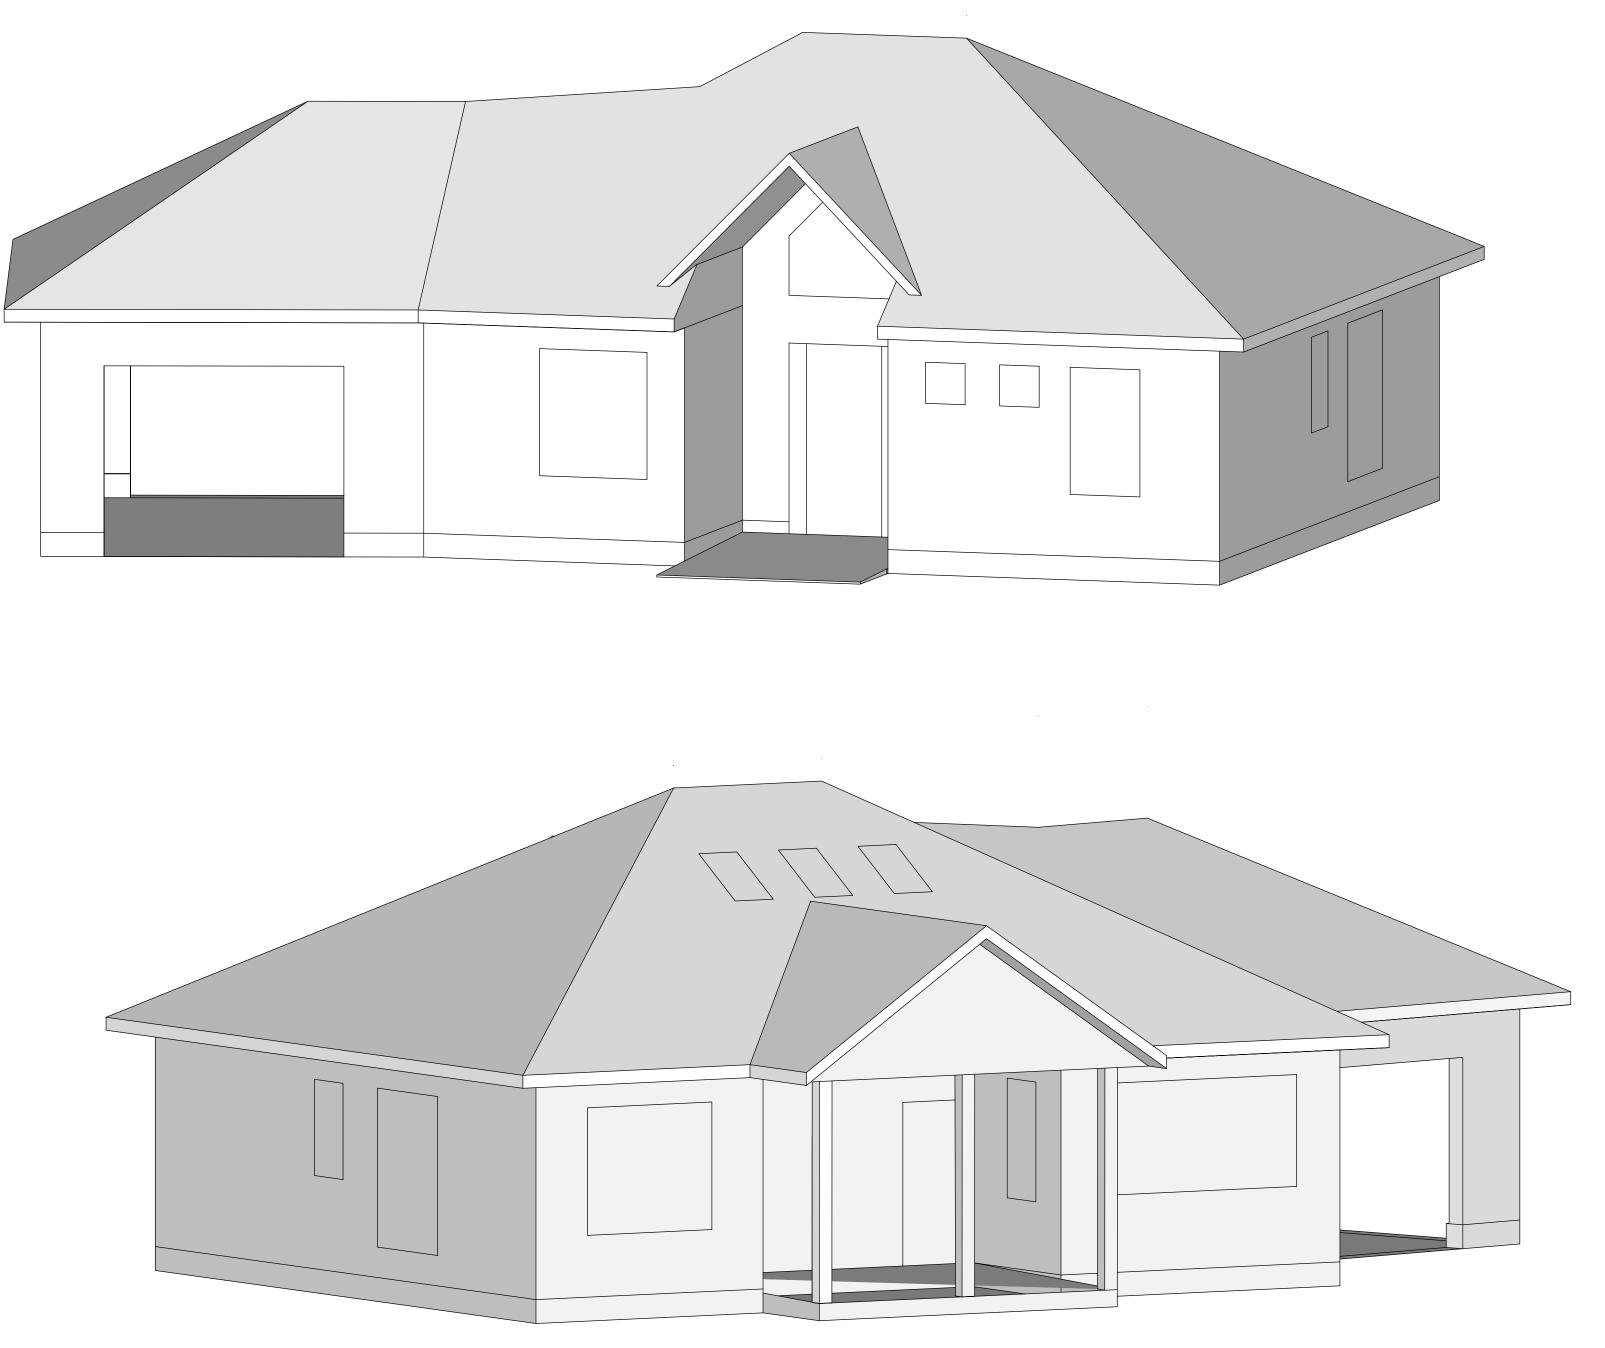2. ALL DIMENSIONS TO FINISH FACE OF WALL, MASONRY OPENING AND OUTSIDE EDGE OF DOOR FRAME OR WINDOW

3. ALL STANDARD CONSTRUCTION PRACTICES APPLY PER ONTARIO BUILDING CODE REVISION 2019

4. ALL CONTRACTORS RESPONSIBLE FOR DEBRIS AND WASTE REMOVAL

5. ONE SET OF DRAWINGS TO REMAIN ON SITE AT ALL TIMES

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APPROVAL AUTHORITY

SYMBOLS

DESIGNER Colin Hale B.A.Sc 120 Wilbert Cox Drive Carp, ON KoA1Lo

PROJECT Family Coach House - 2020

DRAWN BY CH


SCALE 1/4" = 1' -0"


REVISIONS

NO.	DESC.	DATE
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4	SUB. FOR NUDURA REVIEW	27 AUG 2020
5	ROOF UPDATES	

DESCRIPTION COVER PAGE



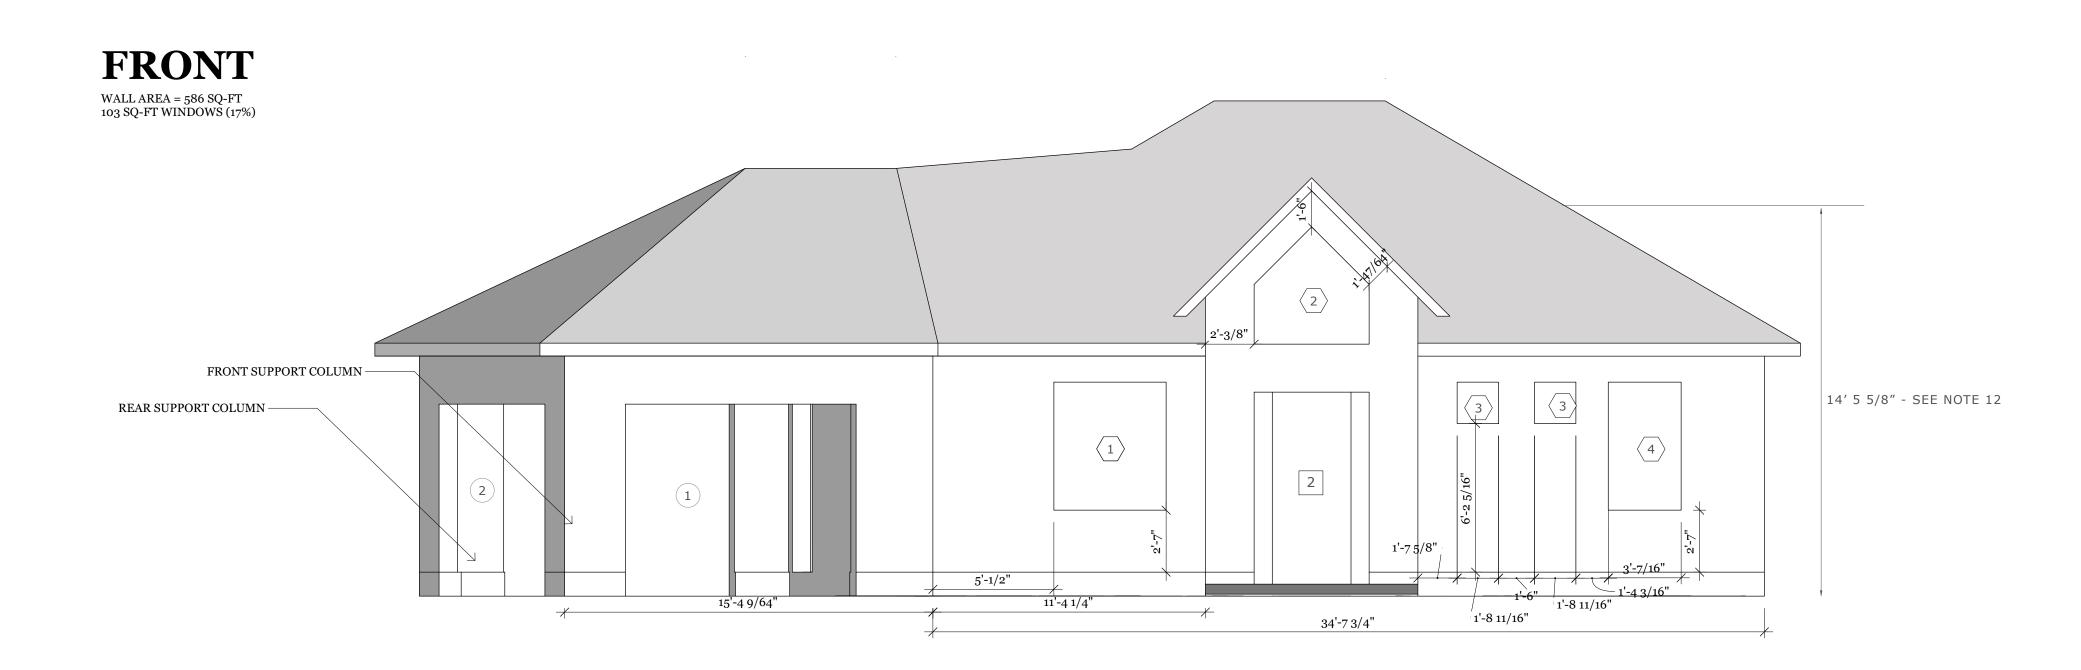


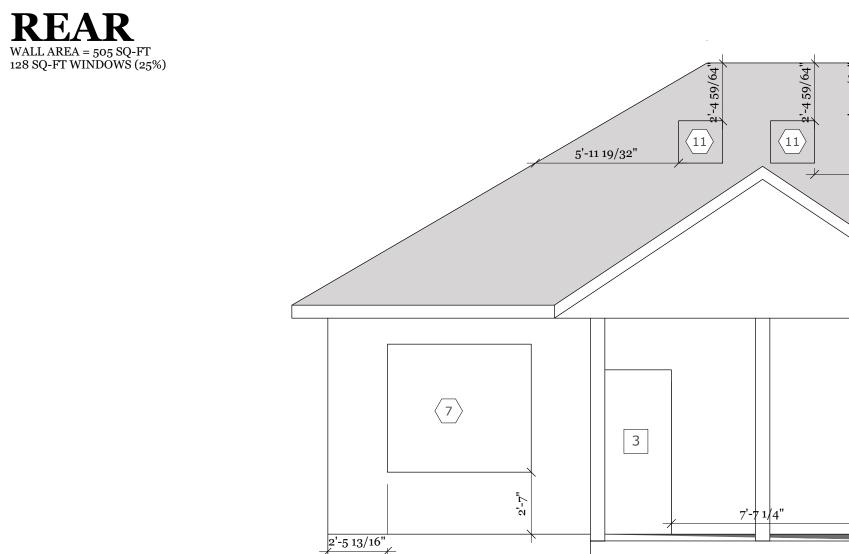

10'-11 1/4"

14'-4 1/4"

DOOR SCHEDULE						
DOOR NO.	QUANTITY	MFG/PART NUMBER	ТҮРЕ	GLAZING	LOCATION	ROUGH OPENING
1	RES	RESERVED	RESERVED	RESERVED	RESERVED	RESERVED
2	1	GOLDEN	FIXED	DOUBLE, LOW E, ARGON	ENTRANCE	57 1/2" X 96"
3	2	GOLDEN	METAL, EXTERIOR	DOUBLE, LOW E, ARGON	GREAT RM., GREAT RM.	36 1/2" X 82 1/16"
4	1	GOLDEN	METAL, EXTERIOR	N/A	CARPORT	36 1/2" X 82 1/16"

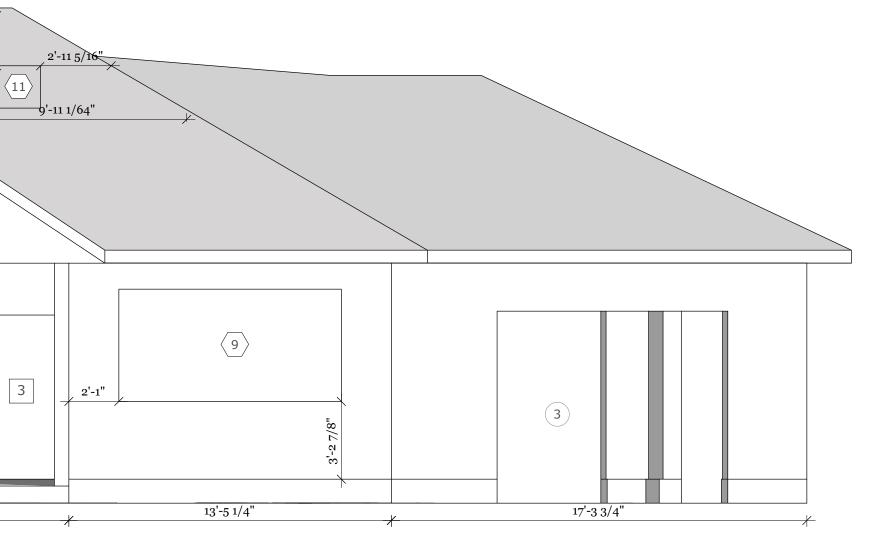

WIN	DO [°]	W SCHE	DULE			
WINDOW NO.	QUANTITY	MFG/PART NUMBER	ТУРЕ	GLAZING	LOCATION	ROUGH OPENING
1	1	GOLDEN AC506/AC916	CASEMENT, FIXED	DOUBLE, LOW E, ARGON	GUEST BDRM/OFFICE	56 1/8" X 64"
2	1	GOLDEN CUSTOM	FIXED	DOUBLE, LOW E, ARGON	ENTRANCE	57 1/2" X 29 7/8" & 56 5/8'
3	2	GOLDEN AC505	FIXED	DOUBLE, LOW E, ARGON	MASTER BDRM	20 11/16" X 20 11/16"
4	1	GOLDEN AC916	CASEMENT	DOUBLE, LOW E, ARGON	MASTER BDRM	36 7/16" X 64"
5	1	GOLDEN AC712	CASEMENT	DOUBLE, LOW E, ARGON	MASTER BATH	28 9/16" X 48 1/4"
6	1	GOLDEN AC505 X 12	FIXED 3X4 MOSIAC	DOUBLE, LOW E, ARGON	GREAT RM/DEN	60 1/16" X 79 3/4"
7	1	GOLDEN AC916/AC916	CASEMENT, FIXED	DOUBLE, LOW E, ARGON	DEN	71 7/8" X 64"
8	1	GOLDEN	HUNG, DOUBLE	DOUBLE, LOW E, ARGON	KITCHEN	28 9/16" X 60 1/16"
9	1	GOLDEN AC516/AC916/ AC916/AC516	CASEMENT/FIXED/ FIXED/CASEMENT	DOUBLE, LOW E, ARGON	KITCHEN	111 1/4" X 64"
10	RES	RESERVED	RESERVED	RESERVED	RESERVED	RESERVED
11	3	VELUX FCM 2234 0004	SKYLIGHT, CURB MOUNT	DOUBLE, LOW E, ARGON	ROOF	22 1/2" x 34 1/2"

DRAWING NOTES

1. ALL WINDOWS TO COMPLY WITH ENERGY STAR RATING FOR EASTERN ONTARIO AND CSA A440.2 CERTIFIED

2. BLACK POLYURETHANE EXTERIOR SEALING AROUND ALL WINDOWS, DOORS AND WALL TO SOFFIT INTERFACES AS PER OBC 9.7.6.2

3. TOLERANCE FOR ALL RSO DIMENSIONS TO BE +/- 1/8"

4. ALL WINDOWS AND DOORS TO BE INSTALLED FLUSH TO EXTERIOR WALLS, UNLESS OTHERWISE SPECIFIED

5. ICF ASSEMBLY AND INSTALLATION PER NUDURA 3-PART SPEC CSC (CAN)

6. THE MINIMUM 28 DAY COMPRESSIVE STRENGTH OF CONCRETE SHALL BE 20 MPA (3000PSI)

7. CONCRETE WORK SHALL CONFORM TO THE LATEST EDITIONS OF THE FOLLOWING STANDARD FOR MATERIALS AND WORKMANSHIP: CAN/CSA-A23.1/ A23.2/A23.3

8. LINTELS PER NUDURA INSTALLATION MANUAL APPENDIX E DESIGN LIMITATIONS AND TABLES FOR LINTELS

9. REBAR REINFORCING STEEL SHALL BE DEFORMED REBAR, PLACED IN ACCORDANCE WITH THE MANUALS OF STANDARD PRACTICE CANADA AND SHALL BE SUPPLIED AT THE FOLLOWING MINIMUM YIELD STRENGTH: CAN GRADE 400 (400 MPa)

10. WINDOW, DOOR AND SKYLIGHT INSTALLATION PER CSA A440.4-07 (REVISED - 2012)

11. FINISH WALLS PER NUDURA WITH BASF SENERGY SENERFLEX FINSH.

12. DISTANCE FROM MID-SPAN OF ROOF TO FINISHED GRADE

SYMBOLS

_	_	
/		
\backslash		

DOOR

GENERAL NOTES

1. ALL DIMENSIONS IN FT-IN UNLESS OTHERWISE SPECIFIED

2. ALL DIMENSIONS TO FINISH FACE OF WALL, MASONRY OPENING AND OUTSIDE EDGE OF DOOR FRAME OR WINDOW

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PROJECT Family Coach House - 2020

DRAWN BY CH

SCALE 1/4" = 1' -0"

REVISIONS

NO.	DESC.	DATE
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5	ROOF AND HELIX	2 SEP 2020

DESCRIPTION

ELEVATIONS NORTH AND SOUTH DOORS & WINDOWS DOOR & WINDOW SCHEDULES




OPENING

WINDOW


LEFT SIDE


WALL AREA = 315 SQ-FT

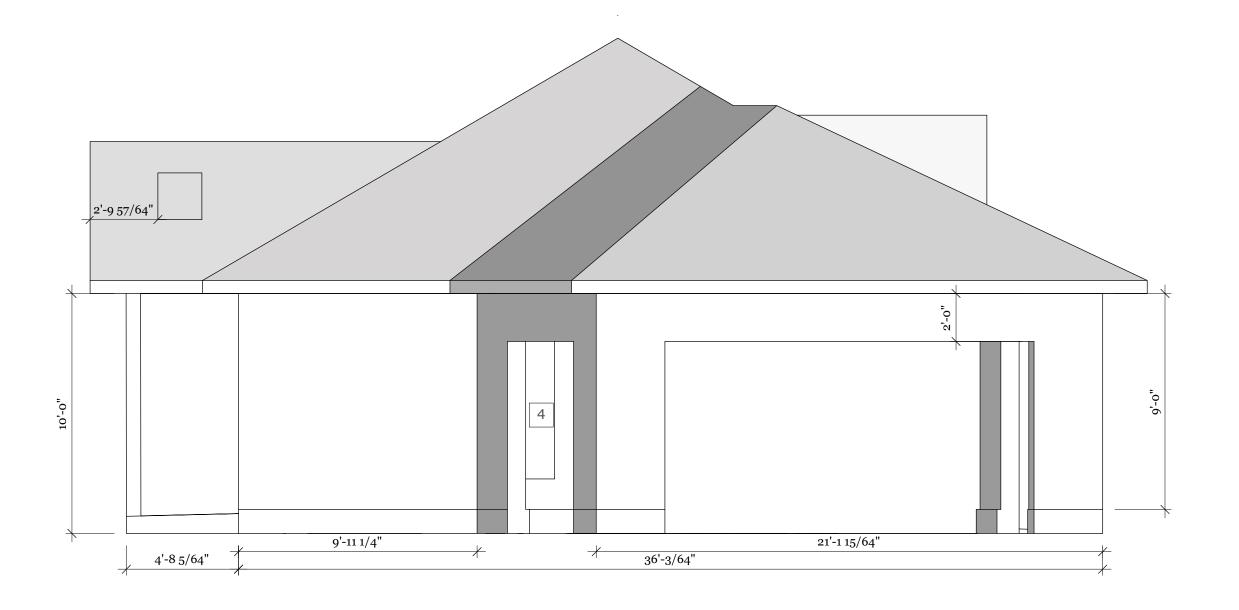

RIGHT SIDE

WALL AREA = 316 SQ-FT 42 SQ-FT GLAZED OPENINGS (13%)

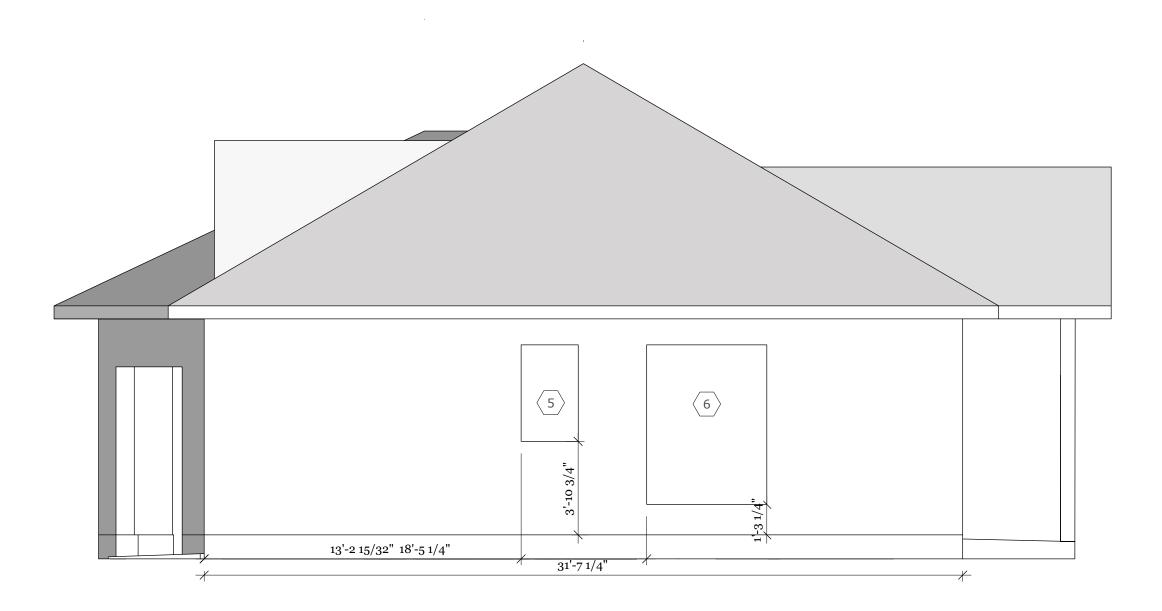

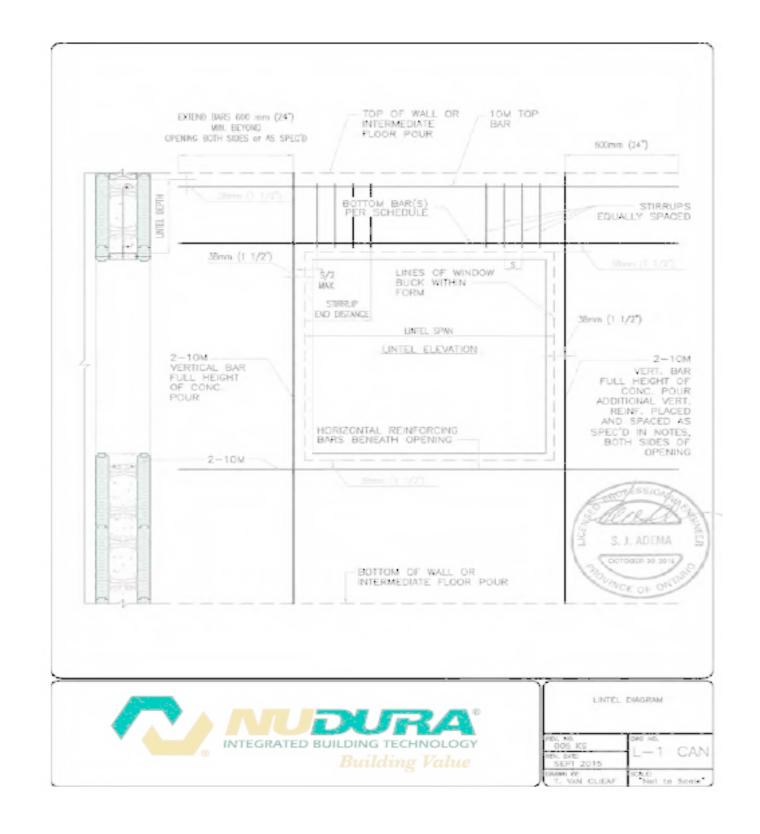

DRAWING NOTES

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PROJECT Family Coach House - 2020

DRAWN BY CH **SCALE** 1/4" = 1' -0"

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DESCRIPTION

ELEVATIONS NORTH AND SOUTH DOORS AND WINDOWS WALL & LINTEL DETAILS




SYMBOLS

 \bigcirc

DOOR

WINDOW

FOUNDATION

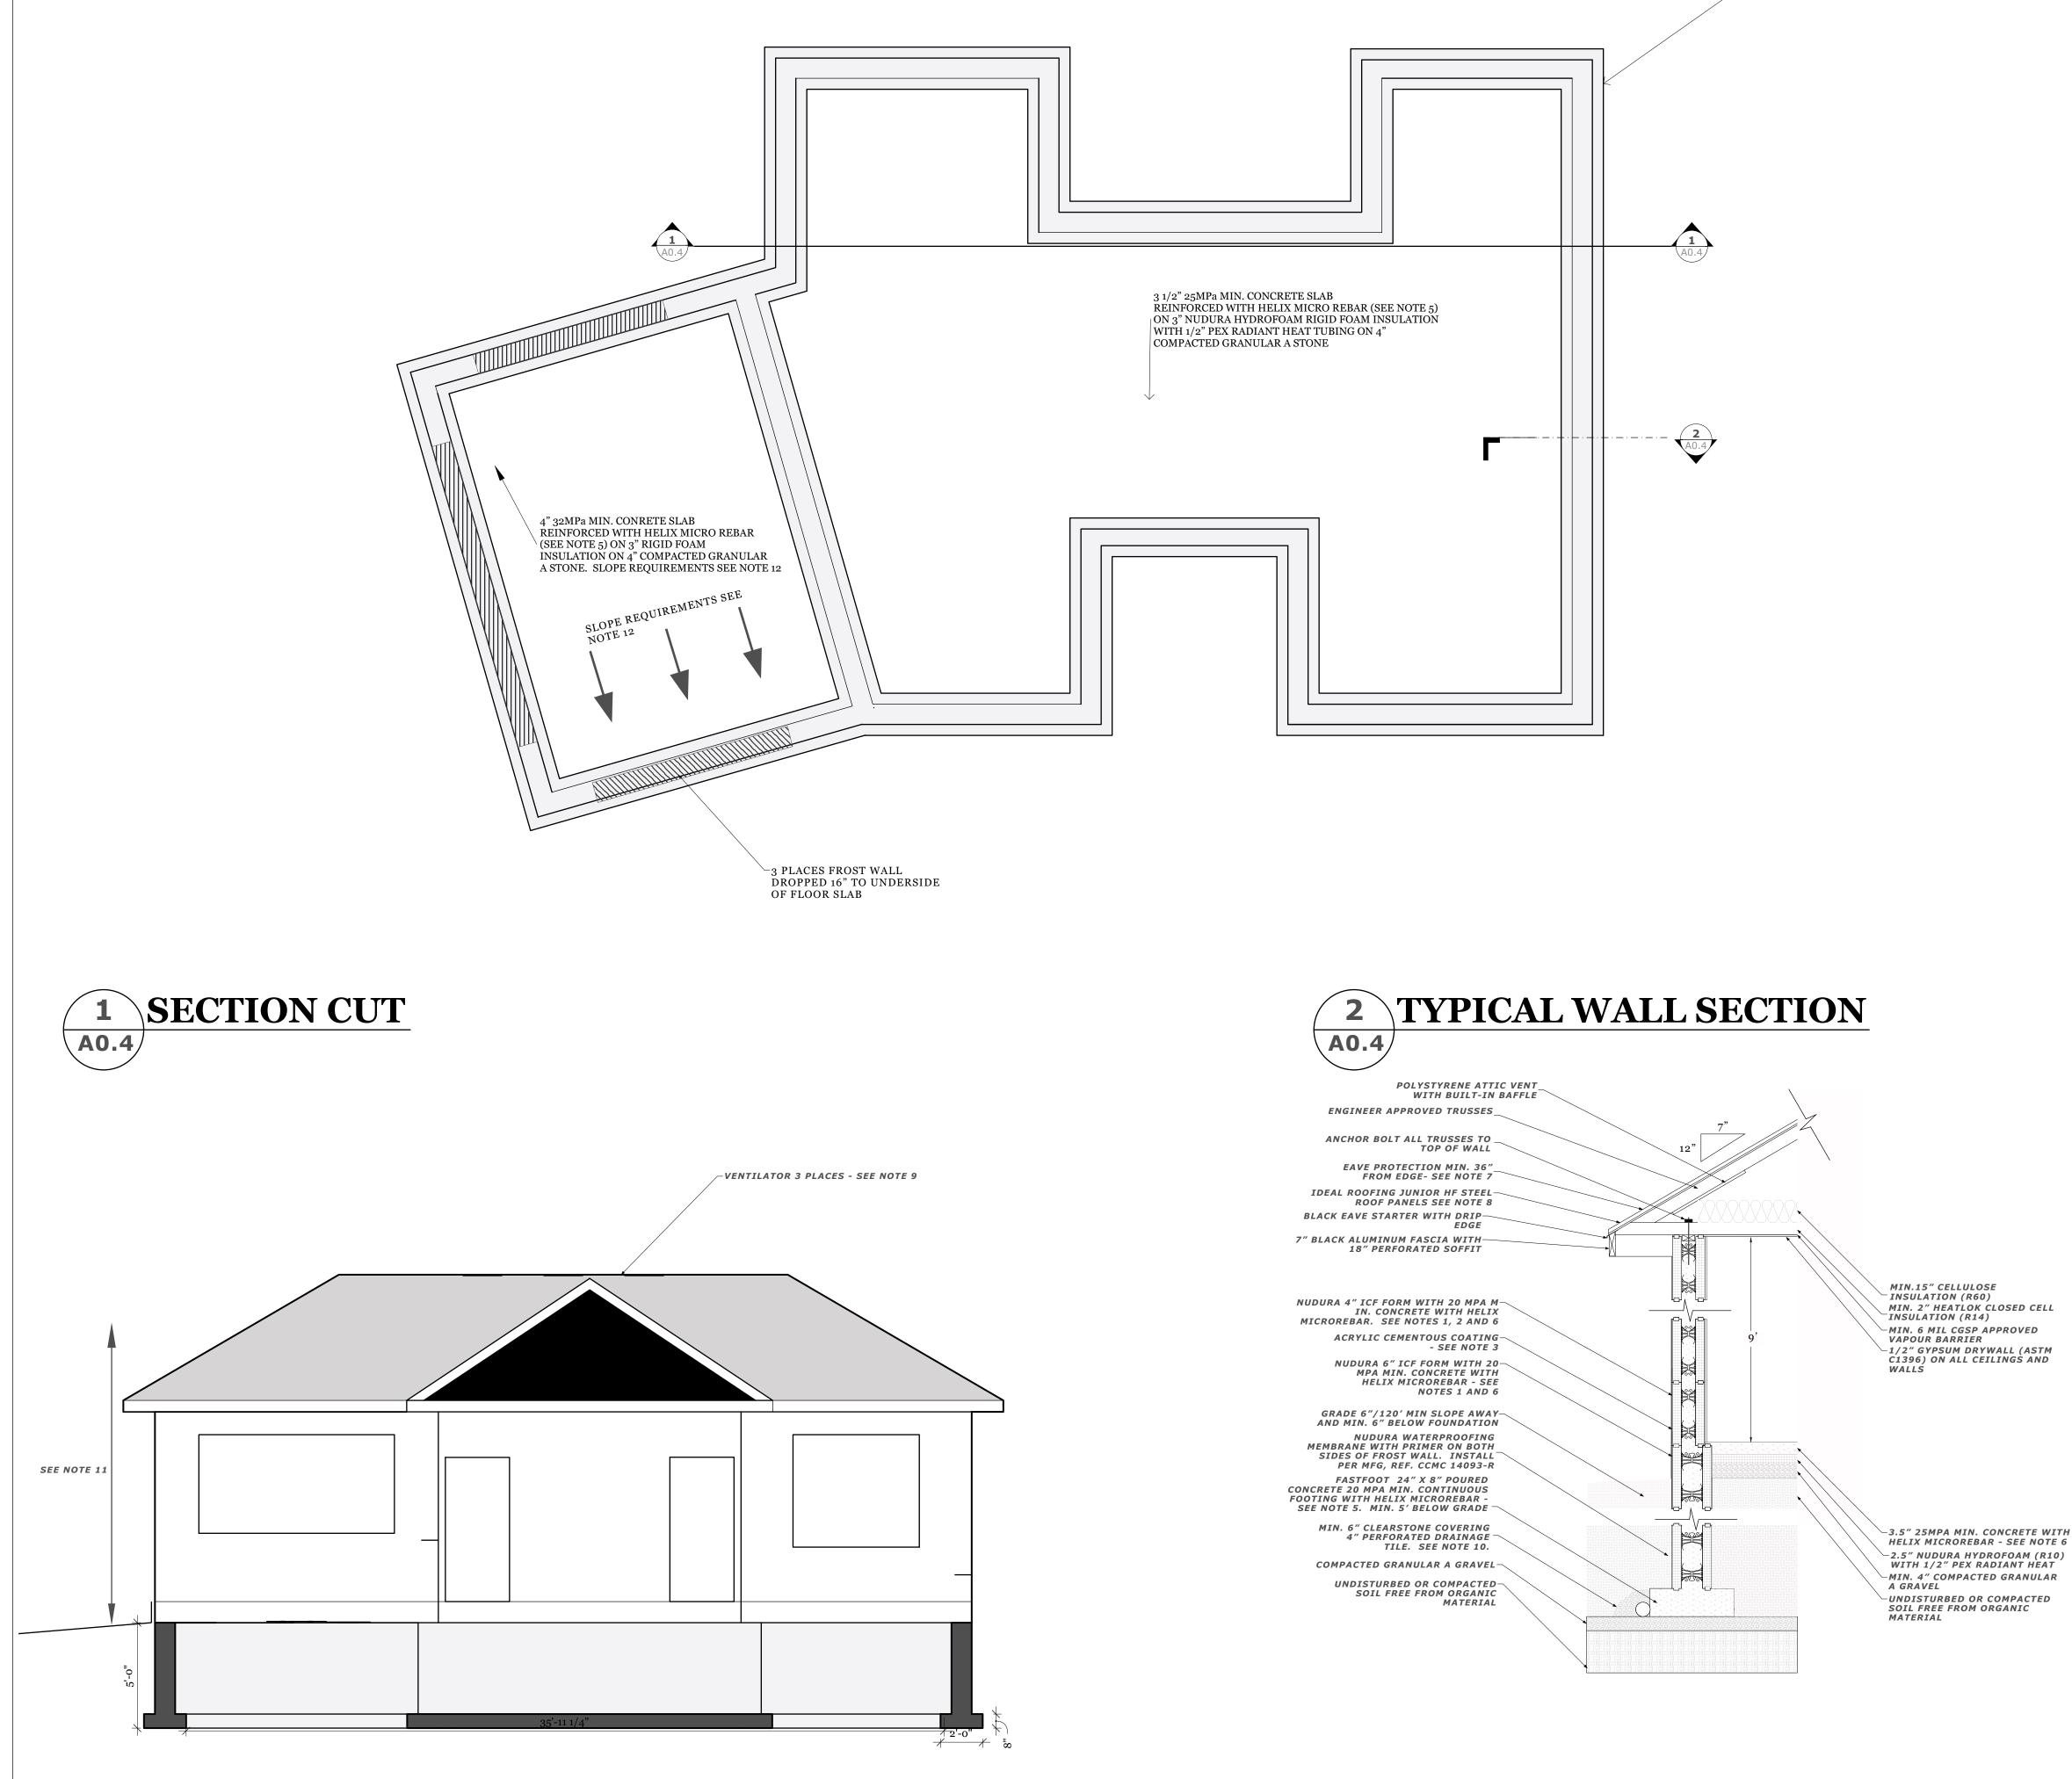

DRAWING NOTES

1. INSTALL NUDURA AS PER CCMC #16063. USE CONCRETE MIN. 32MPA, 5% AIR ENTRAINMENT PER ASTM 1089

2. NUDURA LOW EXP. FOAM TO BE APPLIED BETWEEN FIRST ROW AND FOUNDATION

3. PARGING WITH STUCCO TO BE APPLIED TO THE EXTERIOR PERIMETER FROM TOP OF WALL TO DEPTH OF 18" BELOW GRADE

4. INSULATE FOUNDATION PERIMETER WITH 3" RIDGID XPS INSULATION MIN 18" FROM TOP OF FROST WALL AND OUT 2FT AND 4FT WITHIN 2FT OF THE CORNERS

5. HELIX MICRO REBAR LOADING 9 LBS/ CY AND TO BE MIXED WITH CONCRETE AS PER MAN. INSTRUCTIONS

6. HELIX MICRO REBAR LOADING 22.5 LBS/CY AND TO BE MIXED WITH CONCRETE AS PER MAN. INSTRUCTIONS

7. HIGH QUALITY ICE AND WATER SHIELD TO BE APPLIED TO FIRST 6FT FROM THE EVE, ON FIRST 24IN AROUND PERIMETER AND 36IN ON EACH VALLEY SIDE. SYNTHETIC UNDERLAYMENT TO BE APPLIED TO THE REMAINDER OF THE EXPOSED ROOF

8. IDEAL ROOFING JUNIOR HF SERIES (COLOUR ID 690) TO BE INSTALLED PER MANU. INSTRUCTIONS

9. IDEAL ROOFING MODEL 480 VENTILATORS (COLOUR ID 690) TO BE INSTALLED PER MANU. INSTRUCTIONS.

10. MIN. SCHEDULE 30 PVC WITH HOLES FACING DOWN. DRAIN TO DAYLIGHT, OR OTHER APPROVED DISPOSAL, MIN. SLOPE 1/8" PER FOOT

11. DISTANCE FROM FINISHED GRADE TO MID-SPAN OF ROOF 4.5m

12. ALL AREAS SLOPED TOWARDS GARAGE DOOR MIN 1/8" PER FOOT

13. NUDURA CORP DESIGN U930 ICF 4" CAVITY FIRE ASSEMBLY RATING 2HR - AS PER ANSI/UL 263

SYMBOLS

GENERAL NOTES

1. ALL DIMENSIONS IN FT-IN UNLESS **OTHERWISE SPECIFIED**

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PROJECT Family Coach House - 2020

DRAWN BY CH

SCALE 1/4" = 1' -0"


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5	ROOF AND HELIX	2 SEP 2020

DESCRIPTION

FOUNDATION WALL AND ROOF DETAIL



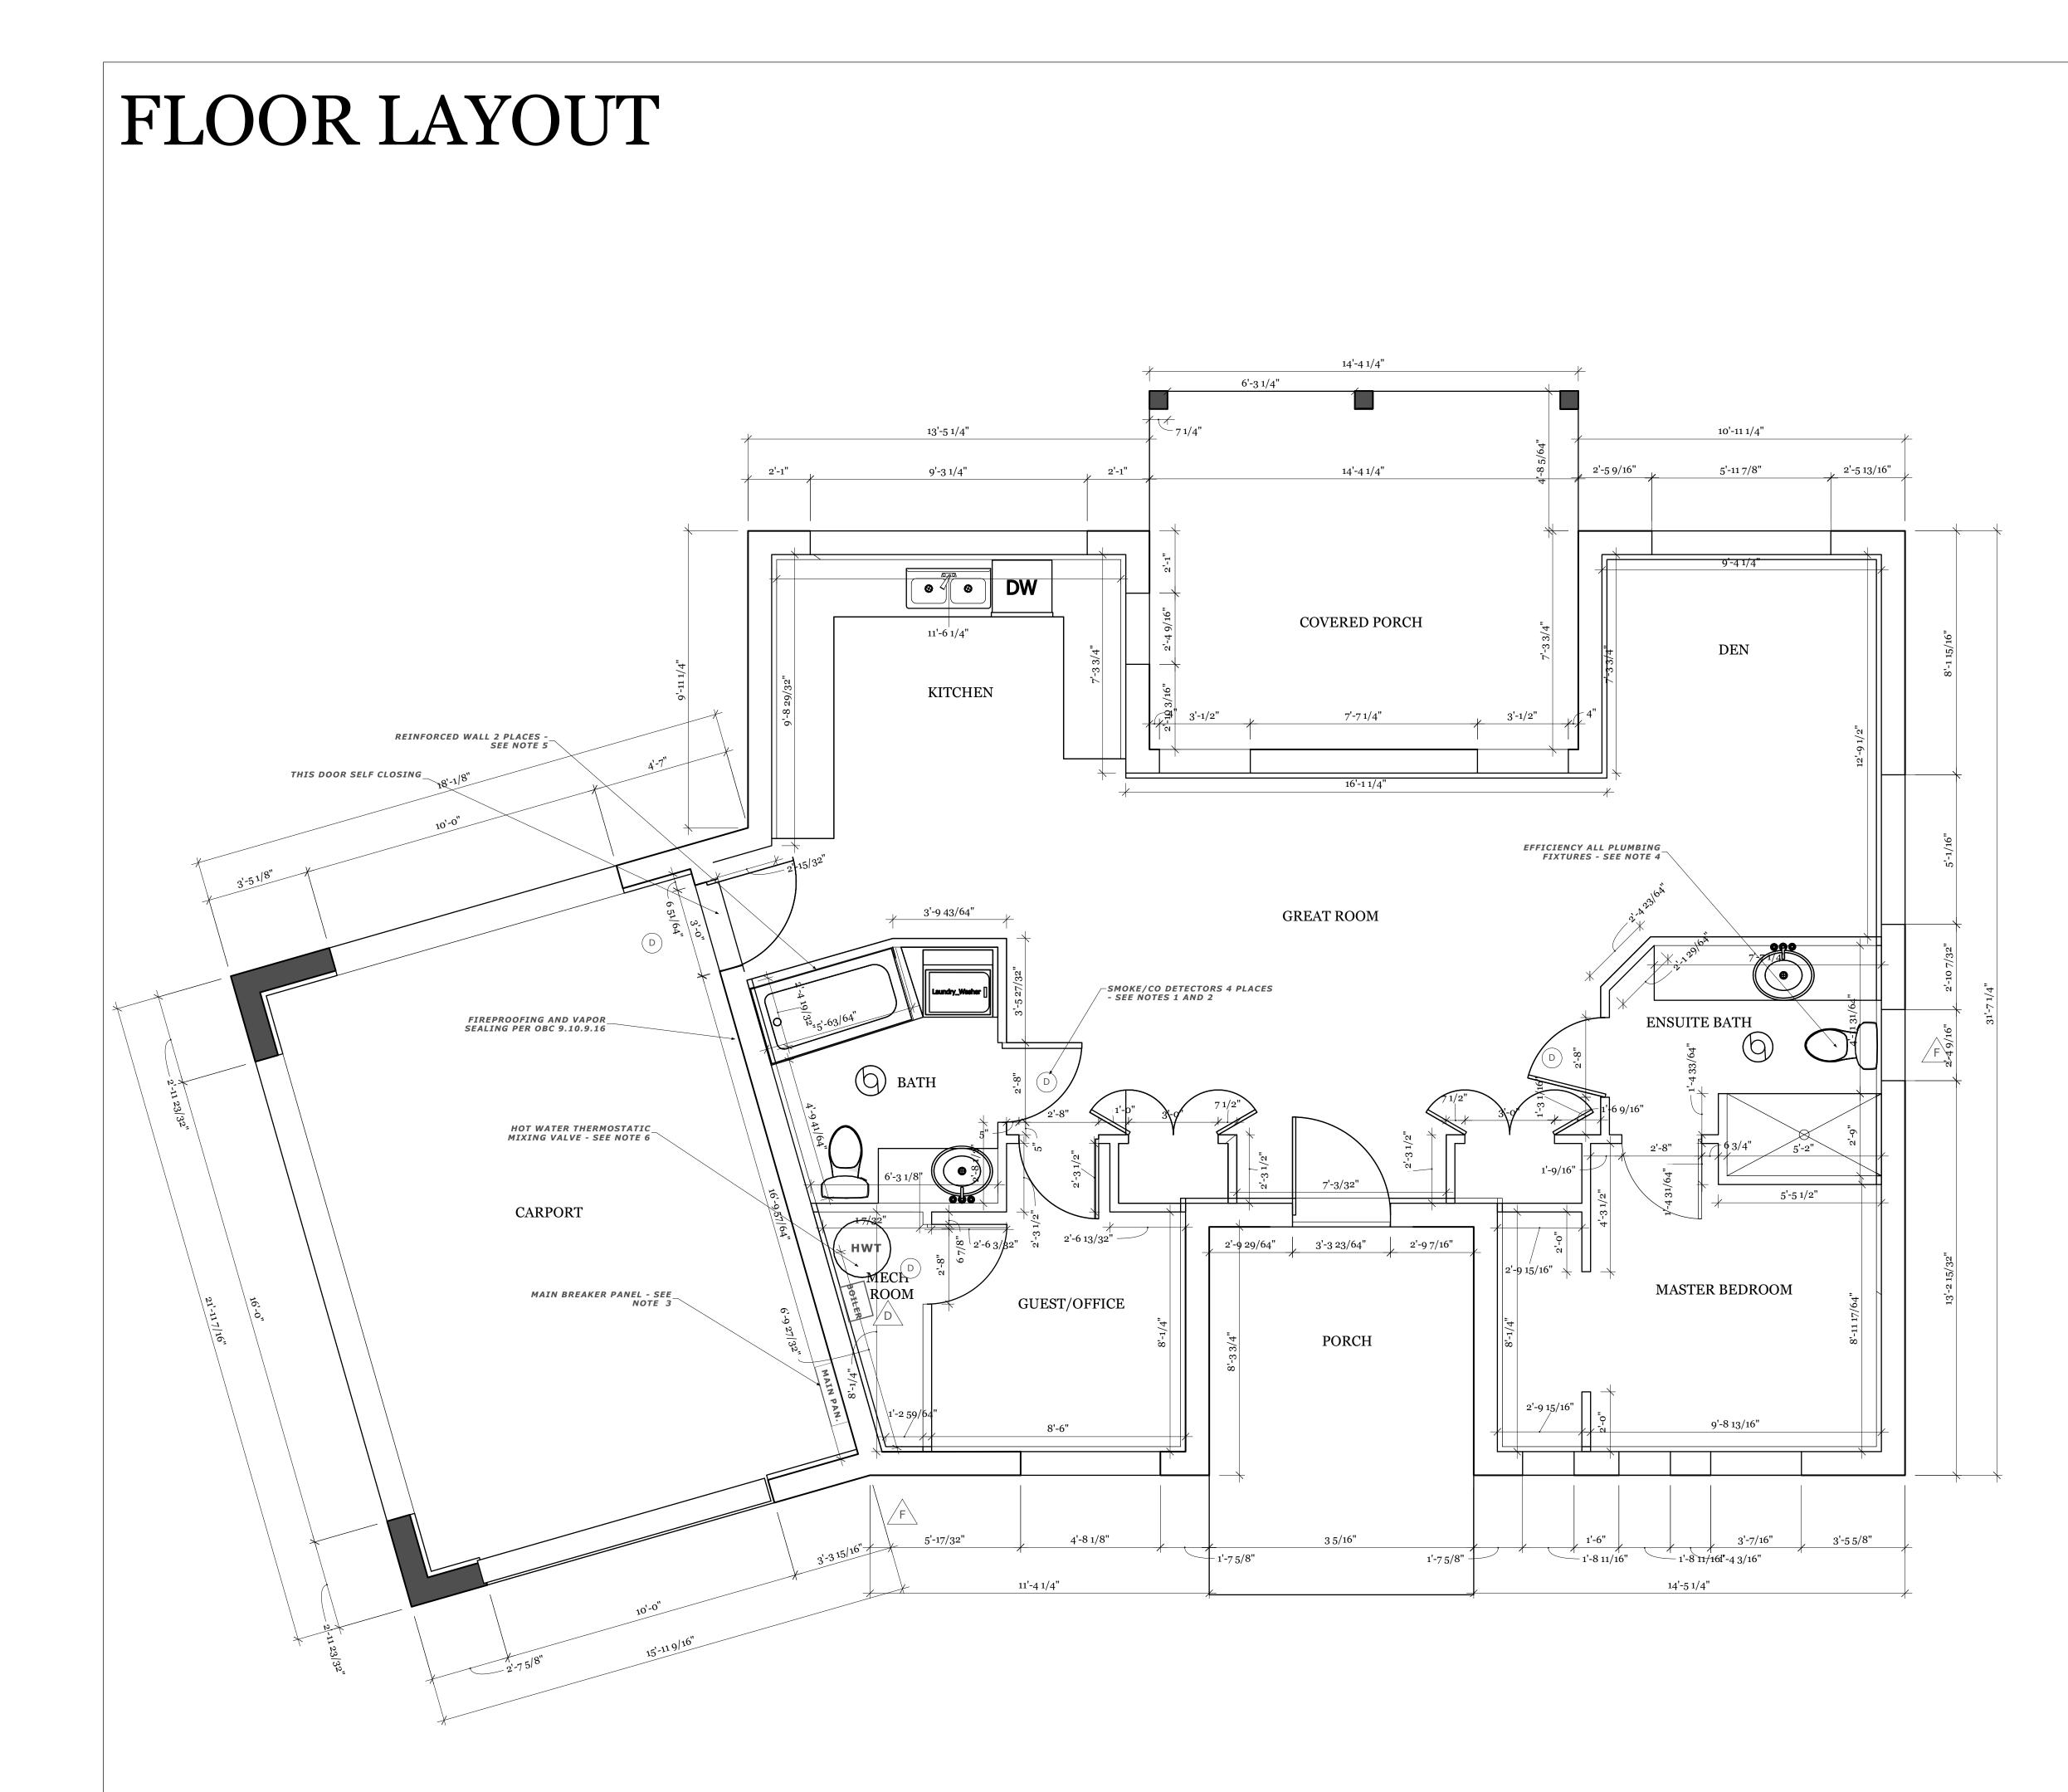

DRAWING NOTES

1. SMOKE DETECTORS TO BE INSTALLED PER CAN/ULC-S524 AND VERIFIED IN CONFORMANCE WITH CAN/ULC-S537

2. ALL CARBON MONOXIDE DETECTORS TO COMPLY WITH CAN/CSA-6.19

3. CONTRACTOR TO ARRANGE FOR ESA **INSPECTION WITHIN 2 DAYS OF MAIN** PANEL COMPLETION

4. WATER EFFICIENCY AS PER OBC TABLE 7.6.4.2.A

5. SHOWER/TUB STUD WALL **REINFORCING FOR FUTURE GRAB BARS** PER SECTION 9.5.2.3

6. MASTER THERMOSTATIC WATER-MIXING VALVE PER CAN/CSA B125-01

7. ELECTRICAL AND LIGHTING FIXTURES PER CEC INCLUDING, BUT NOT LIMITED TO, DISTANCE BETWEEN, TYPE AND GFCI REQUIREMENTS

GENERAL NOTES

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Colin Hale B.A.Sc 120 Wilbert Cox Drive Carp, ON KoĀ1Lo

PROJECT Family Coach House - 2020

DRAWN BY CH

SCALE 3/8" = 1'-0"

REVISIONS

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DESCRIPTION

LAYOUT AND PLUMBING FIXTURES SMOKE AND CO DETECTORS




SYMBOLS

F	OUTDOOR FREEZE PROTECTED FAUCE
D	FLOOR DRAIN
0	EXHAUST FAN VENTED DIRECTLY TO EXTERIOR OF BUILDING

D

SMOKE AND CARBON MONOXIDE DETECTOR

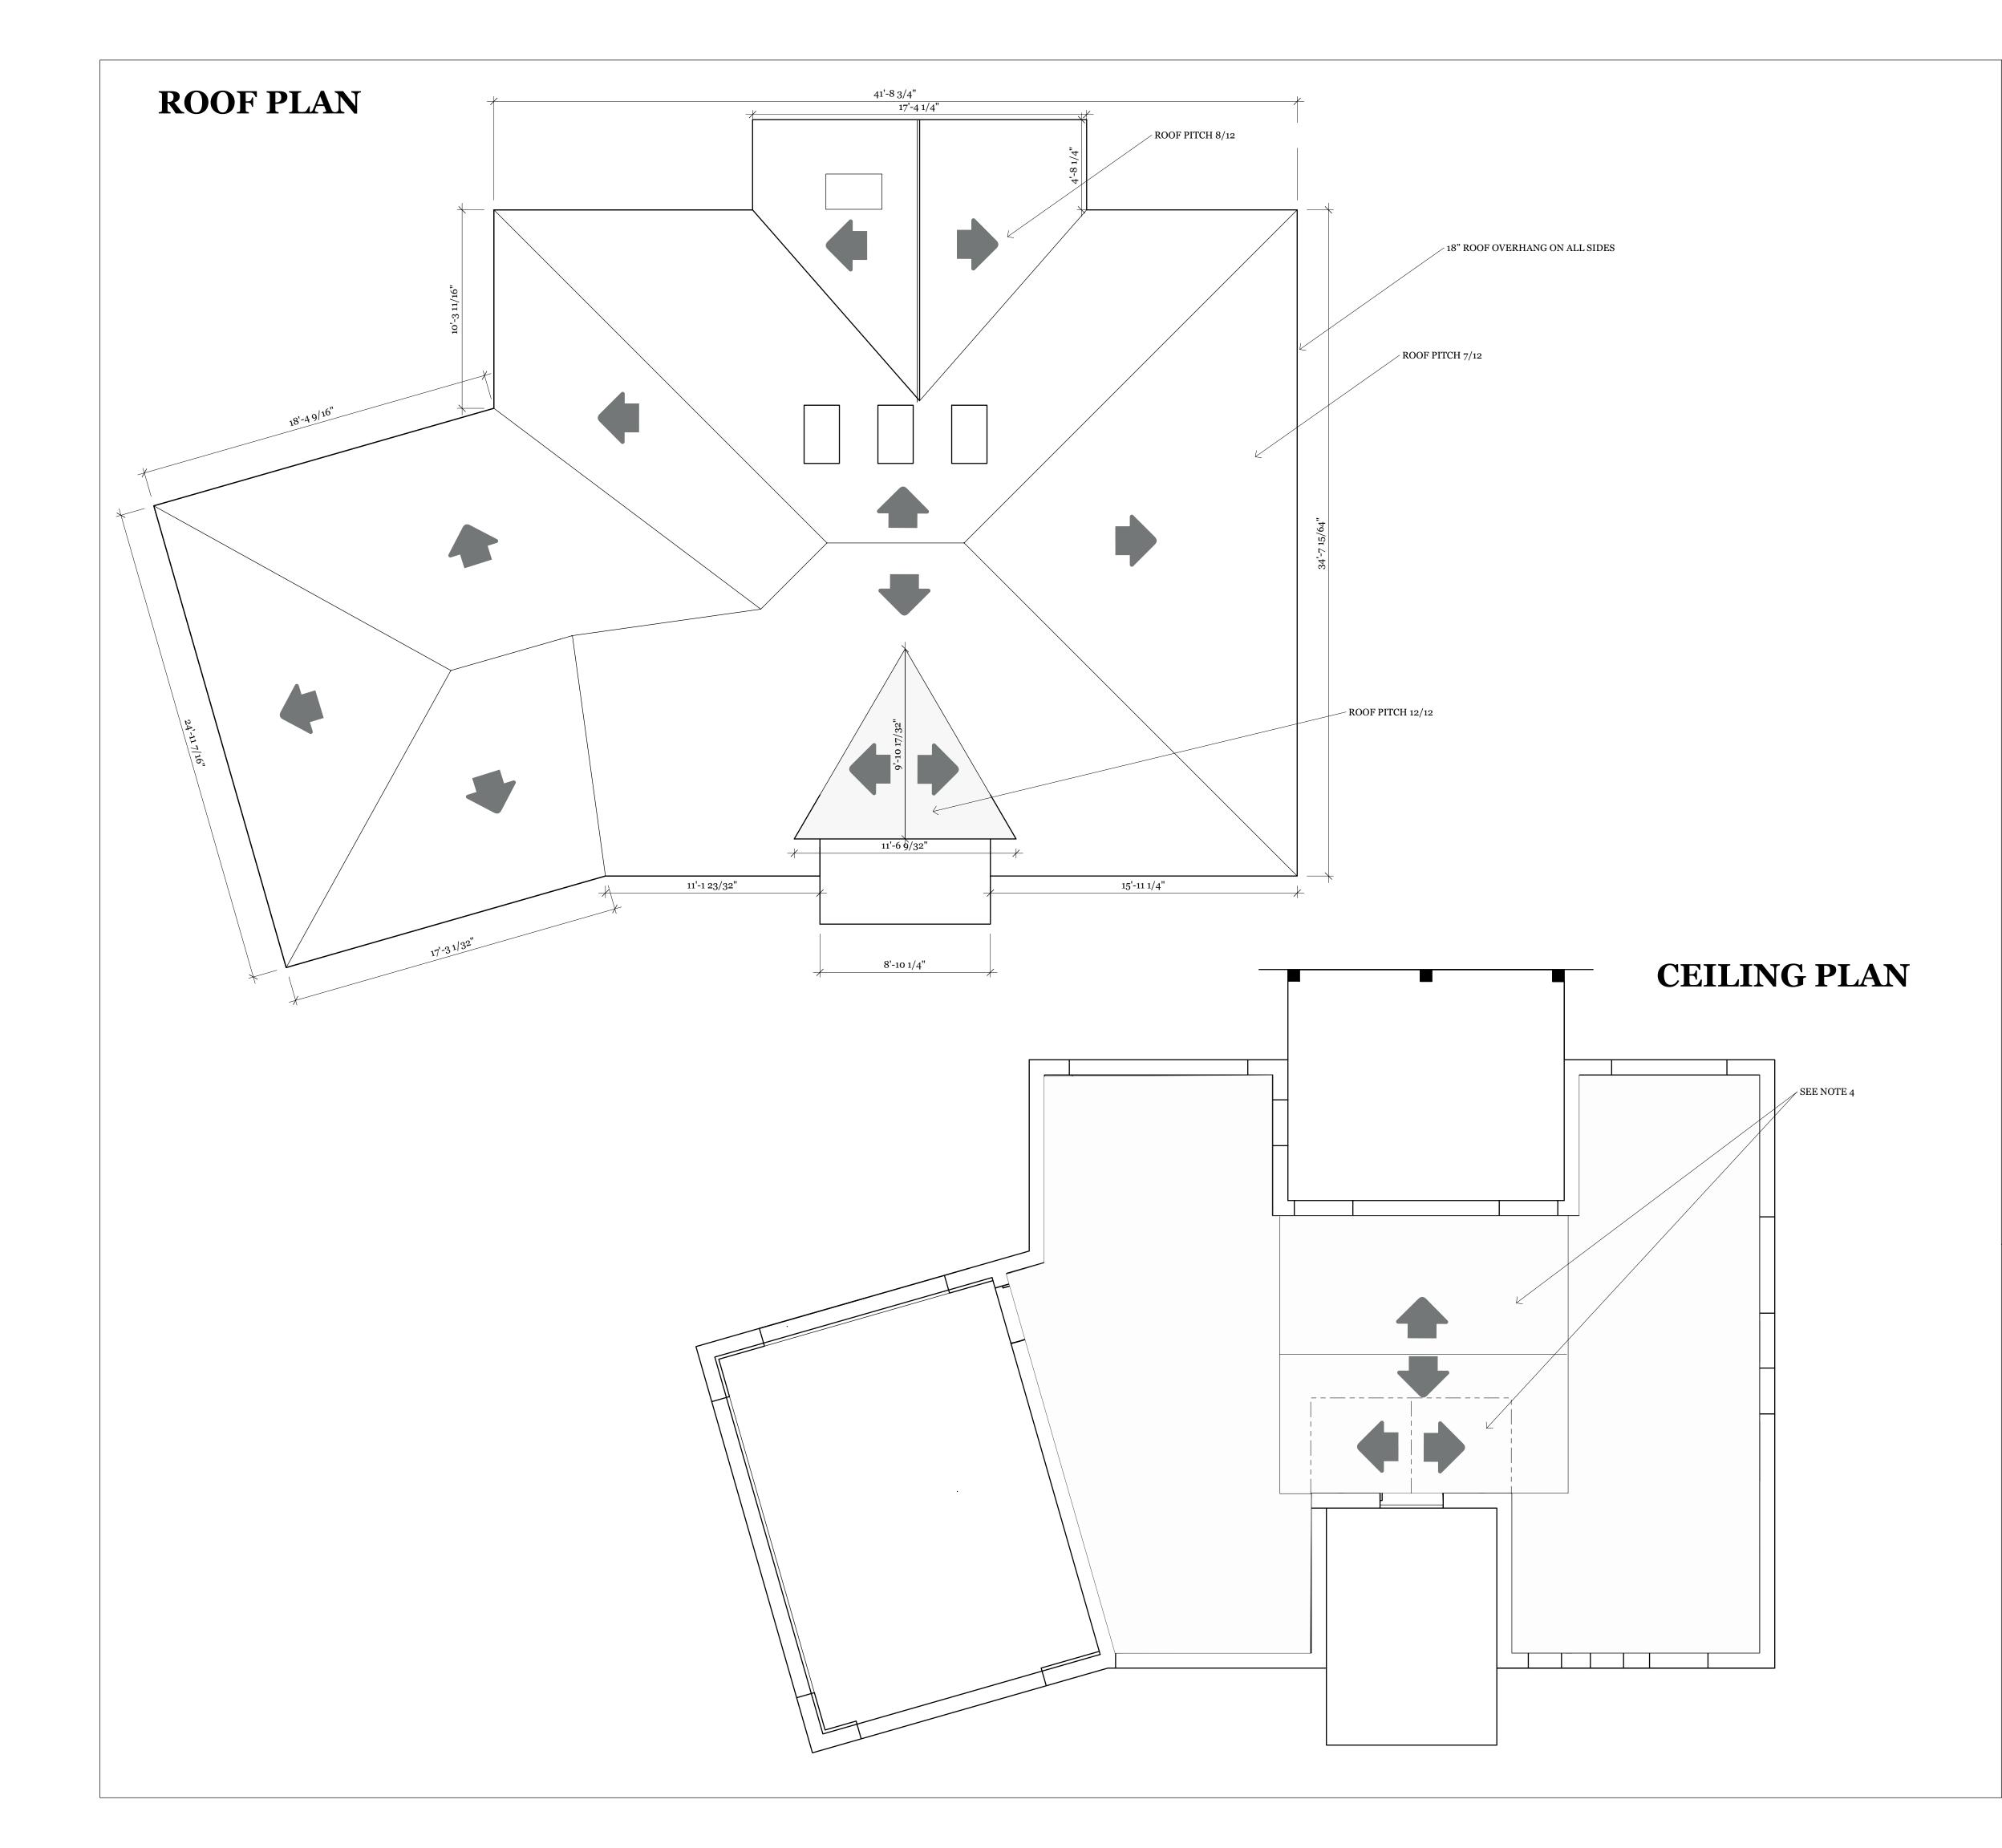

DRAWING NOTES

1. ALL ROOF TRUSSES TO COMPLY WITH OBC 9.23.13.11. WOOD ROOF TRUSSES AND STAMPED TRACEABLE TO CERTIFIED APPROVAL

2. HIGH QUALITY ICE AND WATER SHIELD TO BE APPLIED TO FIRST 6FT FROM THE EVE, ON FIRST 24IN AROUND PERIMETER AND 36IN ON EACH VALLEY SIDE. SYNTHETIC UNDERLAYMENT TO BE APPLIED TO THE REMAINDER OF THE EXPOSED ROOF

3. IDEAL ROOFING HS SERIES (COLOUR ID 690) AND MODEL 48-0 VENTILATORS (COLOUR ID 690) TO BE INSTALLED PER MANU. INSTRUCTIONS

4. THESE AREAS VAULTED - ALL OTHERS FLAT. LOCATION APPROXIMATE - TRUSS DESIGNER TO DETERMINE SPECIFIC DIMENSIONS

5. ALL ROOF SECTIONS TO BE 7/12 PITCH UNLESS OTHERWISE SPECIFIED

GENERAL NOTES

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SYMBOLS



PROJECT Family Coach House - 2020

DRAWN BY CH

SCALE 1/4" = 1'-0"

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DESCRIPTION ROOF PLAN CEILING PLAN



Energy Efficiency Design Summary: Prescriptive Method (Building Code Part 9, Residential)

This form is used by a designer to demonstrate that the energy efficiency design of a house complies with the building code using the prescriptive method described in Subsection 3.1.1. of SB-12. This form is applicable where the ratio of gross area of windows/sidelights/skylights/glazing in doors and sliding glass doors to the gross area of peripheral walls is not more than 22%.

		For use by P	rincipal Au	uthority		
Application No:			Model/	Certification Num	ber	
			6			
A. Project Information						
Building number, street name					Unit number	
120 Wilbert C	Cox Drive					
Municipality	Postal			an number / othe		
Carp	K0A	1L0	Coa	ch House		
B. Prescriptive Compliance	e [indicate the	building code co	ompliance	package bein	g employed in this house	e design]
SB-12 Prescriptive (input design	<i>package)</i> : P	Package: A5			Table: 3.1.1.3A	
C. Project Design Conditions						
Climatic Zone (SB-1):		uipment Effi	ciency		ating Fuel Source	
□ Zone 1 (< 5000 degree days)	■ ≥ 92% AF			■ Gas	and a state of the	[
■ Zone 2 (≥ 5000 degree days)	□ ≥ 84% < 9			🗆 Oil		[
Ratio of Windows, Skylights & Glass	s (W, S & G) to	o Wall Area			Iding Characteristics	0.000
$162.93 \mu^2$				-	t&Beam ICF Above	
Area of walls = $m^2 \text{ or } \frac{162.93}{\text{ ft}^2}$	W, S & G	_{6% =} <u>17</u>		Contraction of the second s	ground	
			·		ced Heat Pump (ASH	
Area of W, S & G =m ² or <u>29.25</u> ft	² Utilize window	averaging:	res ⊡No		Sourced Heat Pump (
D. Building Specifications [pr	rovide values an	d ratings of the	energy ef	ficiency compo	onents proposed]	
Energy Efficiency Substitutions						
ICF (3.1.1.2.(5) & (6) / 3.1.1.3.(5) &	(6))					
 Combined space heating and domes 		ting systems	(3.1.1.2.(7) / 3.1.1.3.	(7))	
Airtightness substitution(s)					1997-8967 	
	3.1.1.4.B Red	auired:			Permitted Substitutior	1:
Airtightness test required						
(Refer to Design Guide Attached)	3.1.1.4.C Re	quired:		Permitted Substitution:		1:
		quired:			Permitted Substitution	
Building Component	Minimum R	SI / R values m U-Value ⁽¹⁾		Building	Component	E
Thermal Insulation	Nominal	Effective	Windo	ws & Door	S Provide U-Value ⁽¹⁾ or E	ER rating
Ceiling with Attic Space					Glass Doors	+29
Ceiling without Attic Space	14.19			ts/Glazed F		0.51
Exposed Floor			Mecha			
Walls Above Grade	4.14 (ICF)			g Equip.(AF	UE)	
BasementWalls				fficiency (SF		90%
Slab (all >600mm below grade)			DHW H	leater (EF)		
Slab (edge only ≤600mm below grade)			DWHR	(CSA B55.1	(min. 42% efficiency))	
Slab (all ≤600mm below grade, or heated)	1.98		Combir	ned Heating	System	94%
(1) U value to be provided in either W/(m ² •k	() or Btu/(h•ft ² •F) but not both.				
E. Designer(s) [name(s) & BCIN(s)	, if applicable, o	f person(s) prov	iding infor	mation herein	to substantiate that desi	ign meet
Qualified Designer Declaration of desig	ner to have revi	iewed and take	responsib	ility for the des	sign work.	

BCIN

Signature

Form authorized by OHBA, OBOA, LMCBO. Revised December 1, 2016.

Name

Colin Hale

Lot 3 Part 7/4
□ Solid Fuel □ Earth Energy
e □ ICF Basement nt
fficiency Ratings
Showers
,

ts the building code]

Colin Hale Digitally signed by Colin Hale Date: 2020.07.26 15:41:41

GENERAL NOTES

1. ALL DIMENSIONS IN FT-IN UNLESS OTHERWISE SPECIFIED

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APPROVAL AUTHORITY

SYMBOLS

DESIGNER Colin Hale B.A.Sc 120 Wilbert Cox Drive Carp, ON KoA1Lo

PROJECT Family Coach House - 2020

DRAWN BY CH

SCALE N/A

REVISIONS

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DESCRIPTION ENGERY EFFICIENCY SUMMARY




SITE PLAN

120 WILBERT COX DRIVE COACH HOUSE LOT 3 PART 7 / CONCESSION 4 KOA 1LO CARP, ONTARIO


SUMMARY OF PERMITTED AND PROPOSED ZONING PROVISIONS

ZONING BYLAW SECTION 142

RR3 ZONE MAXIMUM PERMITTED HEIGHT 4.5m AND 4.5m PROPOSED MAXIMUM PERMITTED AREA 95M² AND 95m² PROPOSED (BYLAW 2017-231) REQUIRED FRONT LOT LINE SETBACK 10m AND 40m PROPOSED REQUIRED SIDE/REAR LOT LINE SETBACK 4M AND 6m PROPOSED REQUIRED WALKWAY WITH 1.2m TO 1.5m WIDTH AND 1.5M PROPOSED

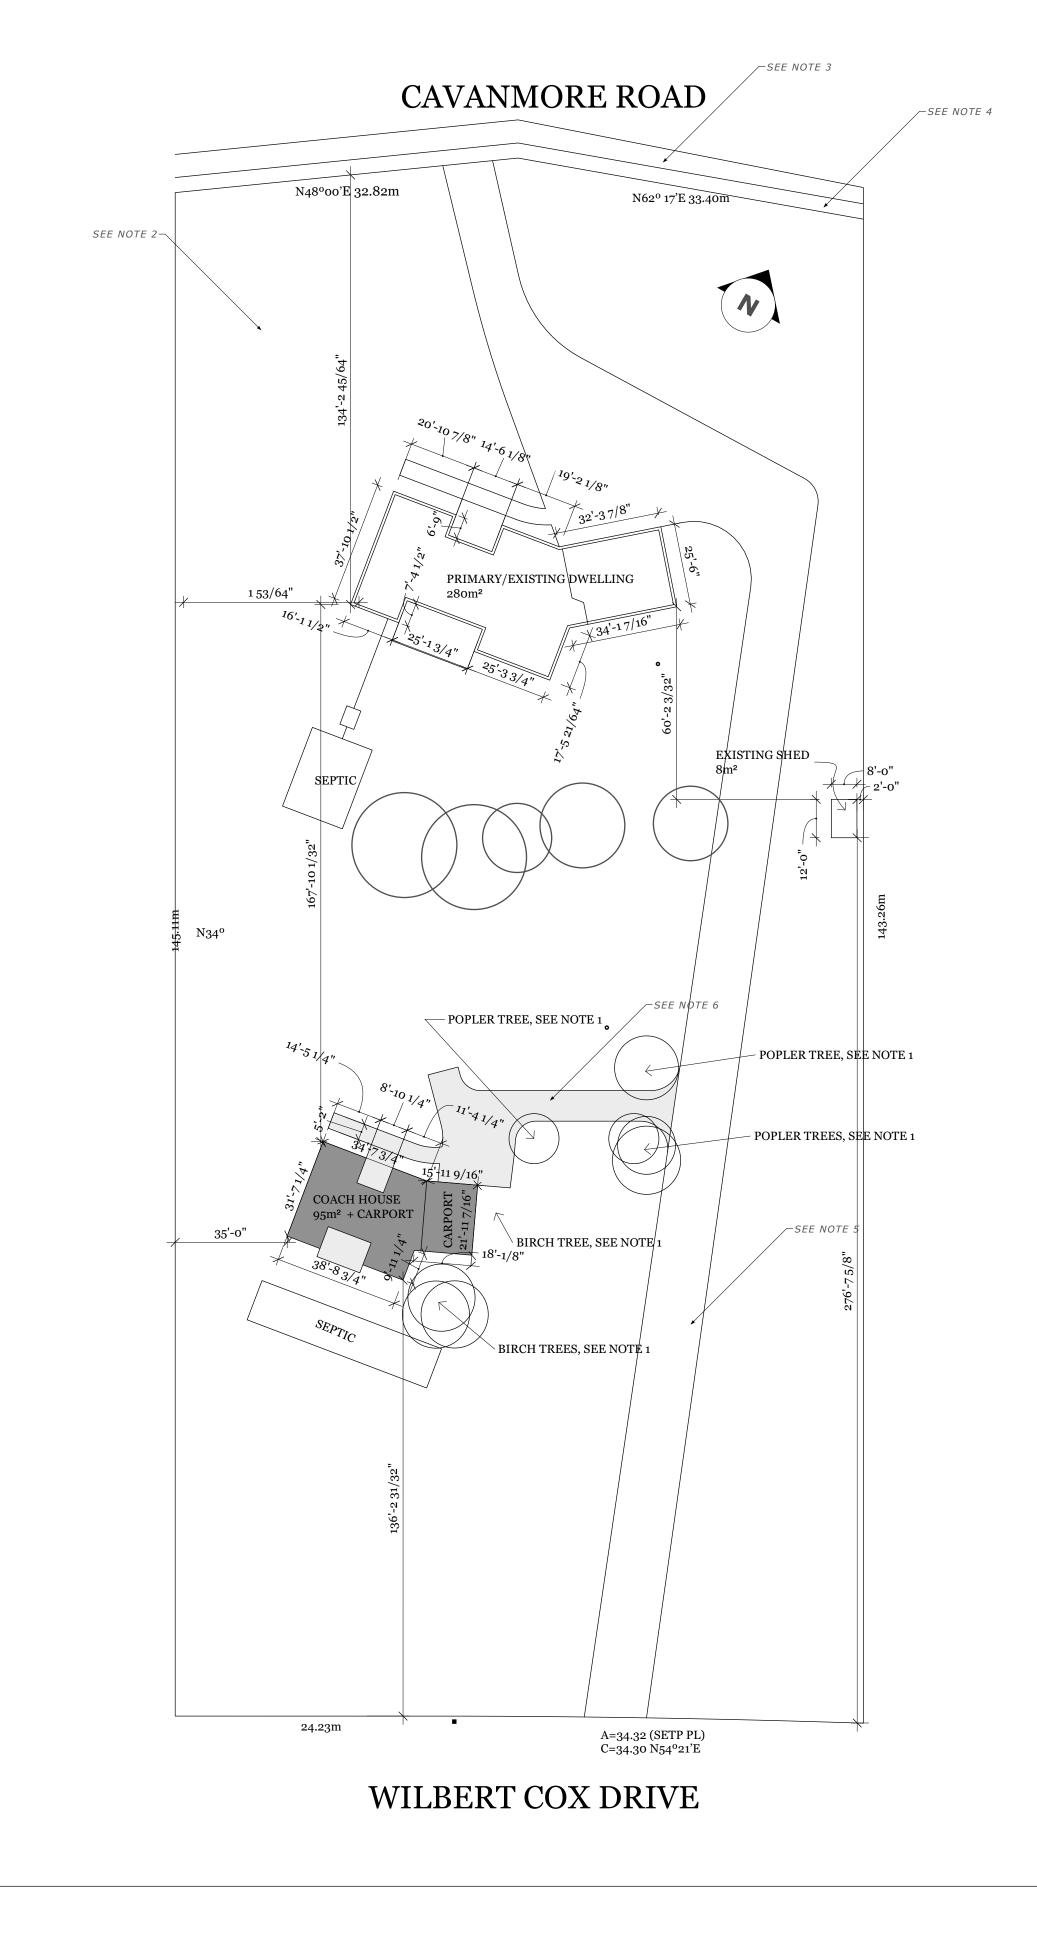

LANDSCAPING PLAN +SITE SERVICING INFORMATION

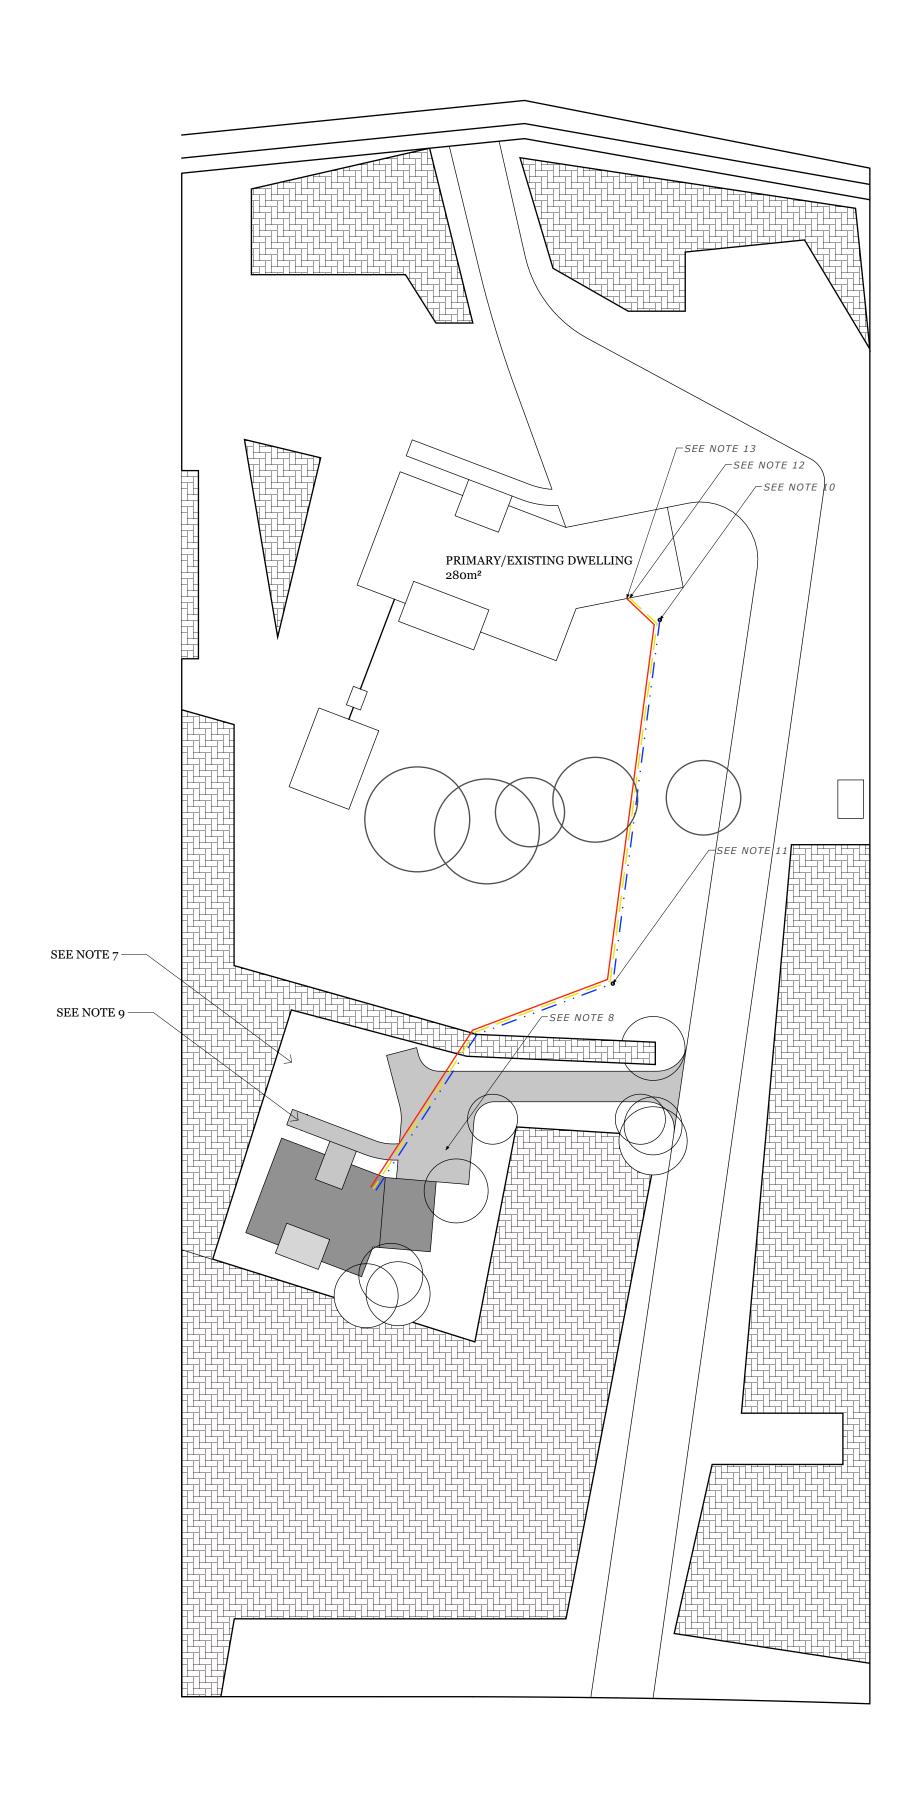

DRAWING NOTES

1. TREES, AS MARKED ON SITE, TO BE PRESERVED.

2. PART 3 O F PLAN 4R-16969. LOT AREA 2.3 ACRES

- 3. PART 6 OF PLAN 4R-16969
- 4. PART 7 OF PLAN 4R-16969
- 5. EXISTING DRIVEWAY
- 6. PROPOSED DRIVEWAY EXTENSION

7. FILL AND SLOPE AS PER GRADING PLAN. FINISH WITH MIN. 3" TOPSOIL AND FERTILIZED GRASS SEED

8. MIN. 12" GRANULAR A GRAVEL OVER LANDSCAPING FABRIC. SLOPE UP TO CARPORT LEVEL WITH FLOOR

9. INTERLOCK OVER MIN 12" COMPACTED GRANULAR A GRAVEL. INTERLOCK TO BE SELECTED BY OWNER

10. DISCONNECT LEGACY WELL AND CONNECT TO NEW WELL. SEE NOTE 11

11. THIS WELL TO SERVICE BOTH DWELLINGS. 1.5" LINE BURIED MIN. 5'

12. PE GAS LINE BURIED AT 36"AND AS PER CAN/CSA B149.1

13. 100A/240V HYDRO SERVICE INSTALLED AS PER ESA 12-012. MAINTAIN MIN. 12" SEPARATION FROM GAS LINE

GENERAL NOTES

1. ALL DIMENSIONS IN FT-IN UNLESS **OTHERWISE SPECIFIED**

2. ALL DIMENSIONS TO FINISH FACE OF WALL, MASONRY OPENING AND OUTSIDE EDGE OF DOOR FRAME OR WINDOW

3. ALL STANDARD CONSTRUCTION PRACTICES APPLY PER ONTARIO BUILDING CODE REVISION 2019

4. ALL CONTRACTORS RESPONSIBLE FOR DEBRIS AND WASTE REMOVAL

5. ONE SET OF DRAWINGS TO REMAIN ON SITE AT ALL TIMES

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APPROVAL AUTHORITY



Colin Hale B.A.Sc 120 Wilbert Cox Drive Carp, ON KoA1Lo

PROJECT Family Coach House - 2020

DRAWN BY CH

SCALE 1" = 30' -0"

REVISIONS


NO.	DESC.	DATE
-	DRAFT	15 March, 2020
1	BASELINE	4 JULY 2020
2	SUBMISSION FOR GRAD. PLAN	14 AUG 2020
3	SUB. FOR SITE PLAN CONTROL	19 AUG 2020
4	SUB. FOR NUDURA REVIEW	27 AUG 2020
5	ROOF AND HELIX	2 SEP 2020

DESCRIPTION

SITE PLAN LANDSCAPING PLAN SITE SERVICING INFO.



SYMBOLS

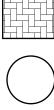

EXISTING TREED AREAS

VARIOUS MATURE TREES

STRUCTURAL SUMMARY

WAI	LL RI	EINFOR	CEM	EN	T SCHED	ULE	
OPENING	ТҮРЕ	LOCATION	LINTEL SPAN	LINTEL DEPTH	COMPLIANCE REF.	REINFORCEMENT DETAIL	NOTES
	WINDOW	GUEST BEDRM/OFFICE	56 1/8"	12"	NUDURA APPENDIX E DWG L1-CAN & TABLE L4-12M	1-10M BOTTOM REINFORCEMENT STEEL, 12" STIRRUP END DISTANCE	
2	WINDOW	ENTRANCE	57 1/2"	18"	NUDURA APPENDIX E DWG L1-CAN & TABLE L4-18M	1-10M BOTTOM REINFORCEMENT STEEL	
3	WINDOW	MASTER BDRM	20 11/16"	12"	NUDURA APPENDIX E DWG L1-CAN & TABLE L4-12M	1-10M BOTTOM REINFORCEMENT STEEL	
4	WINDOW	MASTER BDRM	36 7/16"	12"	NUDURA APPENDIX E DWG L1-CAN & TABLE L4-12M	1-10M BOTTOM REINFORCEMENT STEEL	
5	WINDOW	MASTER BATH	28 9/16	12"	NUDURA APPENDIX E DWG L1-CAN & TABLE L4-12M	1-10M BOTTOM REINFORCEMENT STEEL	
6	WINDOW	GREAT RM/DEN	60 1/16"	12"	NUDURA APPENDIX E DWG L1-CAN & TABLE L4-12M	1-10M BOTTOM REINFORCEMENT STEEL, 18" STIRRUP END DISTANCE	
7	WINDOW	DEN	71 7/8"	12"	NUDURA APPENDIX E DWG L1-CAN & TABLE L4-12M	1-10M BOTTOM REINFORCEMENT STEEL, 18" STIRRUP END DISTANCE	
8	WINDOW	KITCHEN	28 9/16"	12"	NUDURA APPENDIX E DWG L1-CAN & TABLE L4-12M	1-10M BOTTOM REINFORCEMENT STEEL	
9	WINDOW	KITCHEN	111 1/4"	12"	NUDURA APPENDIX E DWG L1-CAN & TABLE L4-12M	1-20M BOTTOM REINFORCEMENT STEEL, 42" STIRRUP END DISTANCE	
	RES	RESERVED	RES		RESERVED	RESERVED	
1	RES	RESERVED	RES		RESERVED	RESERVED	
2	DOOR	ENTRANCE	57 1/2"	24"	NUDURA APPENDIX E DWG L1-CAN & TABLE L4-24M	1-10M BOTTOM REINFORCEMENT STEEL	
3	DOOR	GREAT RM	36 1/2"	24"	NUDURA APPENDIX E DWG L1-CAN & TABLE L4-24M	1-10M BOTTOM REINFORCEMENT STEEL	
4	DOOR	CARPORT	36 1/2"	24"	NUDURA APPENDIX E DWG L1-CAN & TABLE L4-24M	1-10M BOTTOM REINFORCEMENT STEEL	
5	RES	RESERVED	RES		RESERVED	RESERVED	
	OPENING	CARPORT	10'	24"	NUDURA APPENDIX E DWG L1-CAN & TABLE L4-24M	1-15M BOTTOM REINFORCEMENT STEEL, 30" STIRRUP END DISTANCE	
2	OPENING	CARPORT	16'	24"	NUDURA APPENDIX E DWG L1-CAN & TABLE L4-24M	1-20M BOTTOM REINFORCEMENT STEEL, 60" STIRRUP END DISTANCE	
3	OPENING	CARPORT	10'	24"	NUDURA APPENDIX E DWG L1-CAN & TABLE L4-24M	1-15M BOTTOM REINFORCEMENT STEEL, 30" STIRRUP END DISTANCE	

MINIMUM SOLID WALL SUMMARY

SIDE	HEIGHT	TYPE	COMPLIANCE REF.	SOLID WALL SEGMENTS	REQUIRED LENGTH	ACTUAL LENGTH	REINFORSEMENT DETAILS
FRONT	9'	В	NUDURA TA 3950-17 SWT-6	2	3' 4"	3' 5 5/8"	AS PER NUDURA APPENDIX D + 2-15M FULL HEIGHT AT ENDS
RIGHT	9'	А	NUDURA TA 3950-17 SWT-6	1	7'4"	13' 2 15/32"	AS PER NUDURA APPENDIX D
BACK	9'	А	NUDURA TA 3950-17 SWT-6	1	7'4"	7'71/4"	AS PER NUDURA APPENDIX D
LEFT	9'	Α	NUDURA TA 3950-17 SWT-6	1	7'4"	9' 11 1/4"	AS PER NUDURA APPENDIX D

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SYMBOLS

 \bigcirc

DOOR

WINDOW

OPENING

DESIGNER Colin Hale B.A.Sc 120 Wilbert Cox Drive Carp, ON KoA1Lo

PROJECT Family Coach House - 2020

DRAWN BY CH

SCALE N/A

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WALL REINFORCEMENT SCHEDULE MIN. SOLID WALL SUMMARY

