

**DRAWING LEGEND**

- CB [Symbol] CATCH BASIN
- MH [Symbol] MANHOLE
- CB/MH [Symbol] CATCH BASIN/MANHOLE
- SPL [Symbol] SPRINGLINE OF PIPE
- INV [Symbol] INVERT OF PIPE
- SAN [Symbol] SANITARY SEWER
- ST [Symbol] STORM SEWER
- WS/WM [Symbol] WATER SERVICE/WATERMAIN
- CS [Symbol] CURB STOP & STANDPOST
- VB [Symbol] VALVE & VALVE BOX
- FH [Symbol] FIRE HYDRANT
- RD [Symbol] ROOF DRAIN
- WM [Symbol] WATER METER
- RM [Symbol] REMOTE WATER METER READOUT
- EG [Symbol] EXISTING GRADE ELEVATION
- PG [Symbol] PROPOSED GRADE ELEVATION
- ES [Symbol] EXISTING SLOPE OF GRADE
- PS [Symbol] PROPOSED SLOPE OF GRADE
- EO [Symbol] EMERGENCY OVERLAND FLOW
- CL [Symbol] CENTERLINE OF SWALE
- PL [Symbol] PROPERTY LINE
- DC [Symbol] 150mm CURB/DEPRESSED CURB
- LD [Symbol] LIGHT-DUTY PAVEMENT
- HD [Symbol] HEAVY-DUTY PAVEMENT
- CON [Symbol] CONCRETE
- LAN [Symbol] LANDSCAPE
- C.R.Z. [Symbol] CRITICAL ROOT ZONE
- FFL [Symbol] FIRST FLOOR ELEVATION
- USF [Symbol] UNDERSIDE OF FOOTING

**KEY PLAN**

**REVISIONS**

No.	DATE	REVISION
2	JUN 4-20	ISSUED FOR APPROVAL
1	MAY 21-20	ISSUED FOR COORDINATION

**D. B. GRAY ENGINEERING INC.**  
Stormwater Management - Grading & Drainage - Storm & Sanitary Sewers - Watermain  
700 Long Point Circle  
Ottawa, Ontario  
613-425-8044  
d.gray@dbgrayengineering.com

**Project:** PROPOSED 3 STOREY APARTMENT BUILDING  
1010 BYRON AVENUE  
OTTAWA, ONTARIO


**Drawing Title:** SITE SERVICING PLAN  
1:200 SCALE

**Engineer's Seal:** D.B. GRAY, 17016502, JUN 4-20, PROVINCE OF ONTARIO

**Drawn:** D.B.G.  
Hor. Scale 1:200  
Vert. Scale  
Date APR 29-20  
Job No. 20015

**Drawing No.:** C-1 of 7



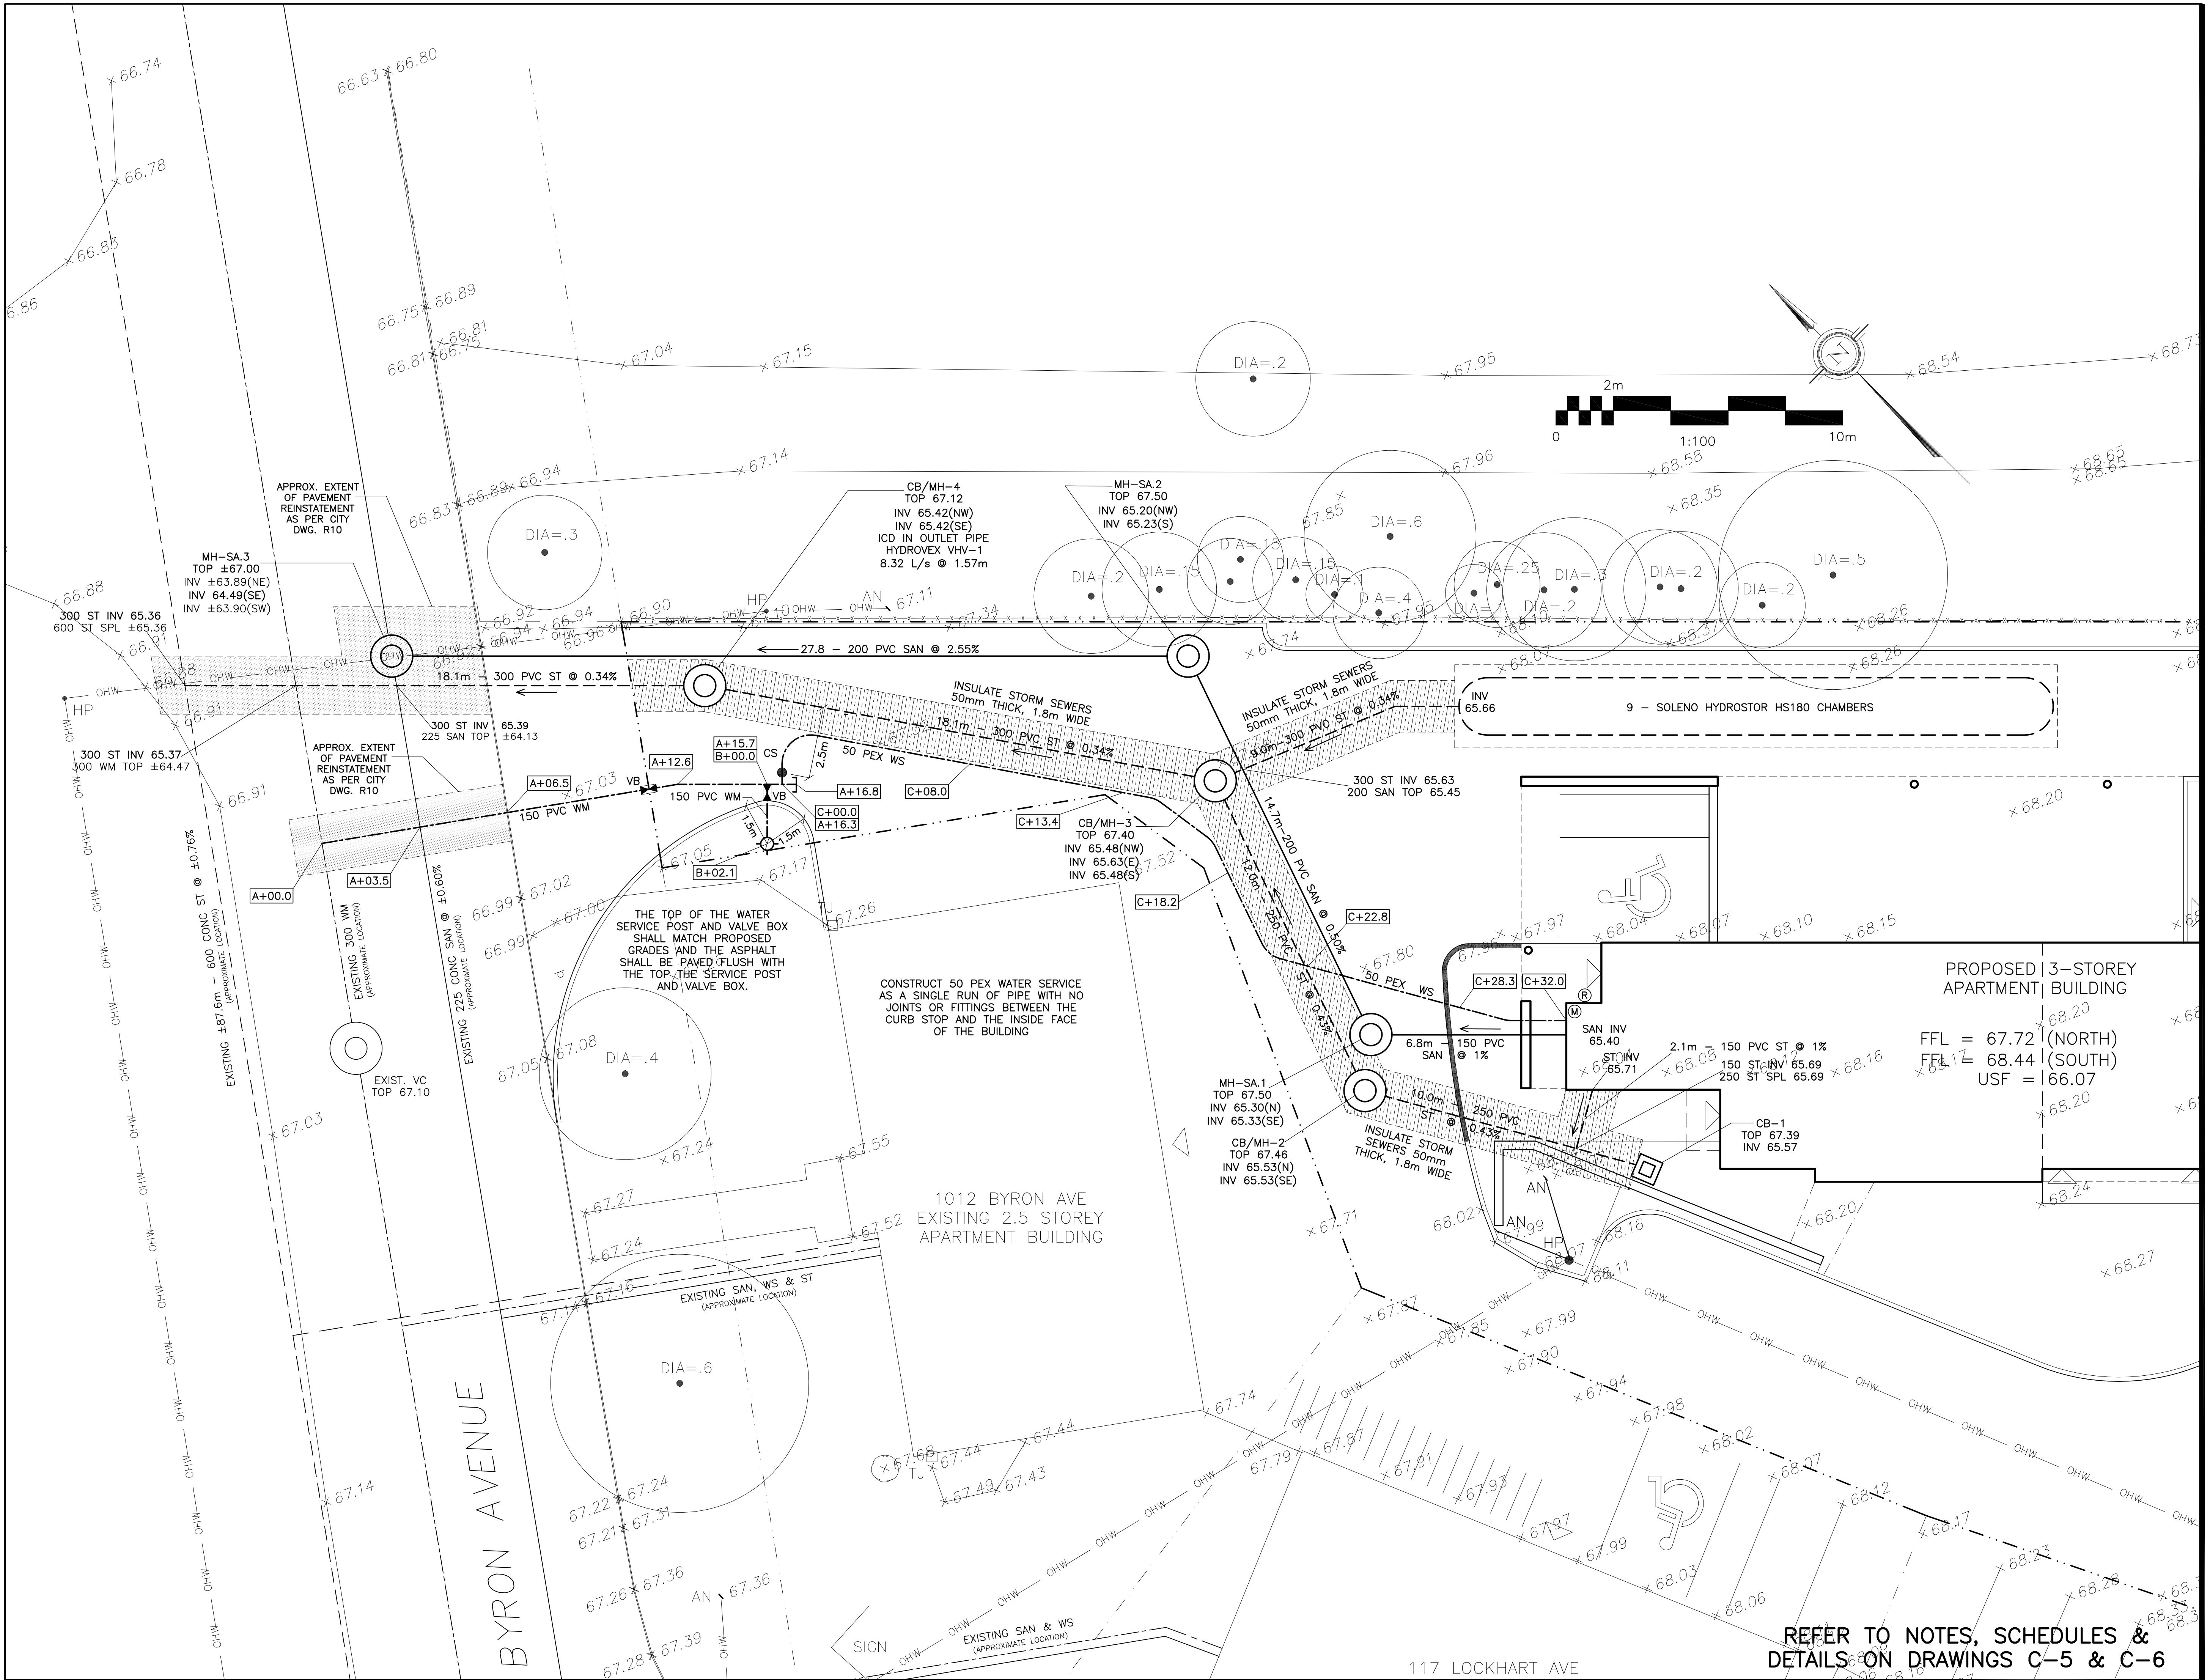

#### DRAWING LEGEND

- CB [Symbol] CATCH BASIN
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- [Symbol] D.C. 150mm CURB/DEPRESSED CURB
- [Symbol] LIGHT-DUTY PAVEMENT
- [Symbol] HEAVY-DUTY PAVEMENT
- [Symbol] CONCRETE
- [Symbol] LANDSCAPE
- [Symbol] C.R.Z. CRITICAL ROOT ZONE
- [Symbol] FFL FIRST FLOOR ELEVATION
- [Symbol] USF UNDERSIDE OF FOOTING

#### KEY PLAN



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Project  
**PROPOSED 3 STOREY  
APARTMENT BUILDING  
1010 BYRON AVENUE  
OTTAWA, ONTARIO**

Drawing Title  
**SITE SERVICING PLAN**  
1:100 SCALE

Engineer's Seal  
  
NOT VALID UNLESS  
SIGNED & DATED

Drawn D.B.G.  
Hor. Scale 1:100  
Vert. Scale  
Date APR 29-20  
Job No. 20015

Drawing No.  
**C-2**  
of 7

REFER TO NOTES, SCHEDULES &  
DETAILS ON DRAWINGS C-5 & C-6



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DETAILS ON DRAWINGS C-5 & C-6
















### LEGEND

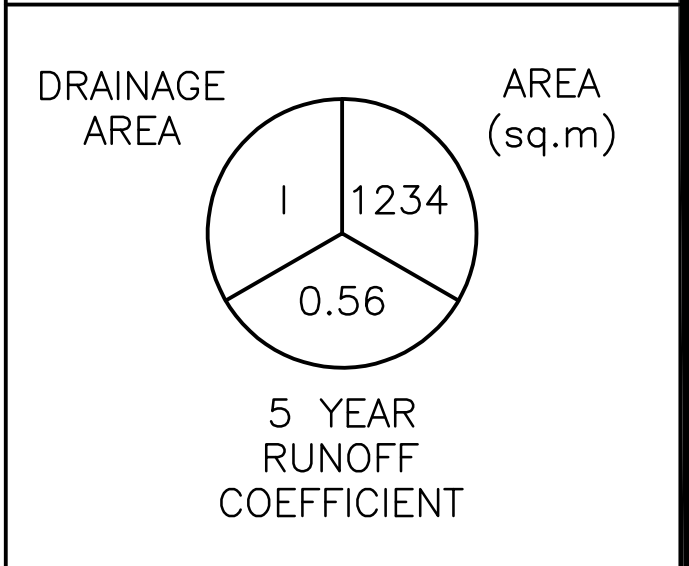

## KEY PLAN



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No.	DATE	REVISION

D. B. GRAY ENGINEERING INC.

Stormwater Management - Grading & Drainage - Storm & Sanitary Sewers - Watermain


700 Long Point Circle 613-425-8044  
Ottawa, Ontario d.gray@dbgrayengineering.com

Project

PROPOSED 3 STOREY  
APARTMENT BUILDING  
1010 BYRON AVENUE  
OTTAWA, ONTARIO

Drawing Title
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## DRAINAGE PLAN

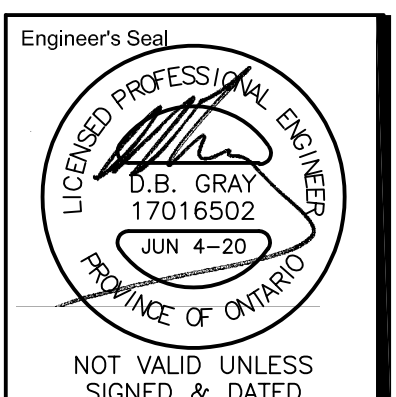

Drawn	D.B.G.
Hor. Scale	1:200
Vert. Scale	
Date	APR 29-20
Job No.	20015

Drawing No.  
C-7  
of 7

