


PROPOSED REAR ELEVATION

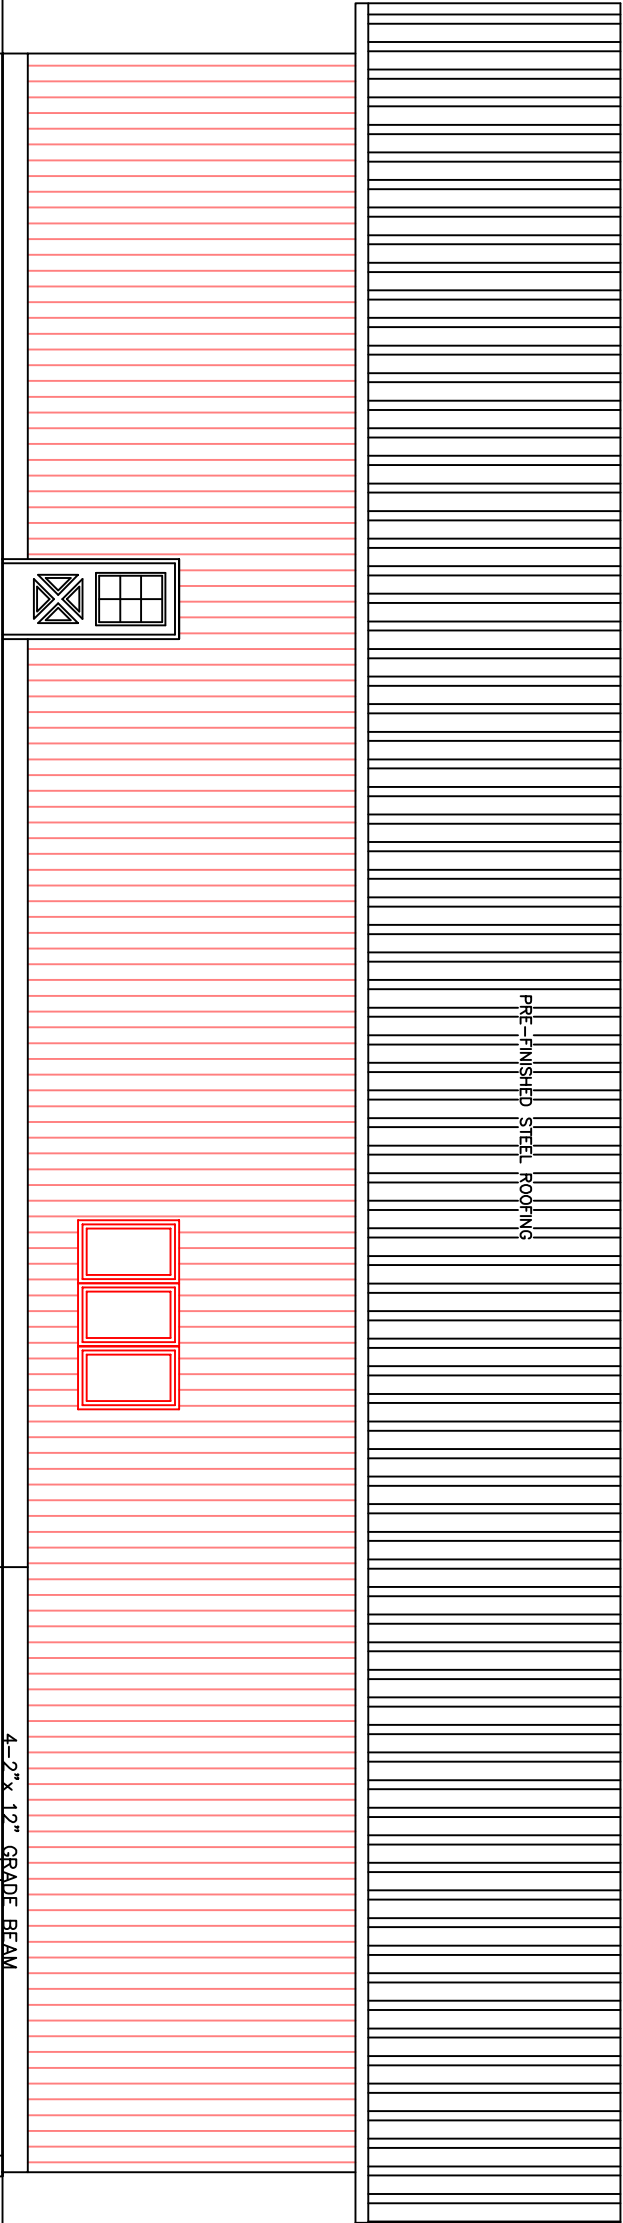

PROPOSED RIGHT SIDE ELEVATION

NATURAL VENTILATION

- 1 INSULATION SHALL BE INSTALLED AND OTHER CONSTRUCTION WORK UNDERTAKEN IN A MANNER WHICH WILL NOT REDUCE THE FLOW OF AIR THROUGH VENTS OR THROUGH ANY PORTION OF THE ROOF SPACE OR ATTIC WHERE NECESSARY TO ENSURE EFFECTIVE AIR CIRCULATION. SPECIAL VENTING DEVICES SUCH AS DUCTS OR BAFFLES SHALL BE INSTALLED.
- 2 ROOF SPACE OR ATTICS ABOVE INSULATED CEILINGS SHALL BE VENTILATED WITH OPENING TO THE EXTERIOR HAVING A TOTAL UNOBSTRUCTED AREA OF NOT LESS THAN 1/300 OF THE INSULATED CEILING AREA (OF WHICH 1/2 IS TO BE LOCATED IN SOFFIT). SUCH VENTS SHALL BE LOCATED SO AS TO PROVIDE MAXIMUM EFFECTIVE AIR CIRCULATION AND, IN RIDGE TYPE ROOFS APPROX. HALF OF THE TOTAL VENT AREA SHALL BE LOCATED AT OR NEAR THE RIDGE.


WOOD FRAMING

- 1 ALL FRAMING LUMBER TO O.B.C. STANDARDS SIZES OF JOISTS, LINTELS, ETC. INDICATED ON DRAWINGS, SPECIFIED AS PER NO. 2 SPF (UNLESS OTHERWISE NOTED).
- 2 B.U. WOOD BEAMS TO HAVE MIN. 89MM ( 3 1/2") BEARING
- 3 LATERAL SUPPORT – (WALLS SUPPORTING JOISTS) –ANCHOR SILL PLATE AT 2400mm ( 8'-0") o.c. WITH 13mm ( 1/2") DIA. ANCHOR BOLTS EMBEDDED 100mm ( 4") INTO CONCRETE OR ANCHORED EVERY 4TH JOIST NOT RESTING ON A PLATE WITH 4.8mm X 38mm STEEL JOIST ANCHORS N.B.
- 4 MIN. 38mm ( 2") END BEARING REQUIRED FOR SUPPORT FOR JOISTS, CEILING JOISTS, ROOF JOISTS AND RAFTERS.
- 5 WOOD STUD PARTITIONS TO BE MADE UP OF 38mm X 140mm ( 2"x6") SPR. 400 ( 16") o.c. AND 38mm X 140mm ( 2"x6") TOP AND BOTTOM PLATES. DOUBLE TOP STUDS AROUND OPNGS. AND TRIPPLE STUDS IN CORNERS IN BEARING STUD PARTITIONS.


REVISIONS:


NO.	REVISION	DATE
1	ISSUED FOR GENERAL REVIEW	
2		
3		

IN ACCORDANCE WITH THE 2012 ONTARIO BUILDING CODE, I HAVE REVIEWED AND TAKE RESPONSIBILITY FOR THE DESIGN ACTIVITIES

SIGNATURE:  DATE: Jan. 13/20

GARY R. RUYF BCIN: 24393  
RUYF DRAFTING & DESIGN INC. BCIN: 29582

**Ruyf Drafting & Design Inc.**

 AutoCAD Drafting • Design  
Graphic Architectural Perspectives

RR2 Mountain, On. K0E 1S0 613-989-3232

**Project**  
**PROPOSED STORAGE SHED**

Client JOHN & EMILY KELLY  
2234 RIVER RD., MANOTICK, ON K4M 1B4

Drawing Title  
ELEVATIONS

Scale 1/8" = 1'-0"	Date JANUARY, 2020
Drawn By G. RUYF	Drawing No.
Checked By	
Approved By	

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