




1 TREE CONSERVATION REPORT & LANDSCAPE PLAN
SCALE: 1:500

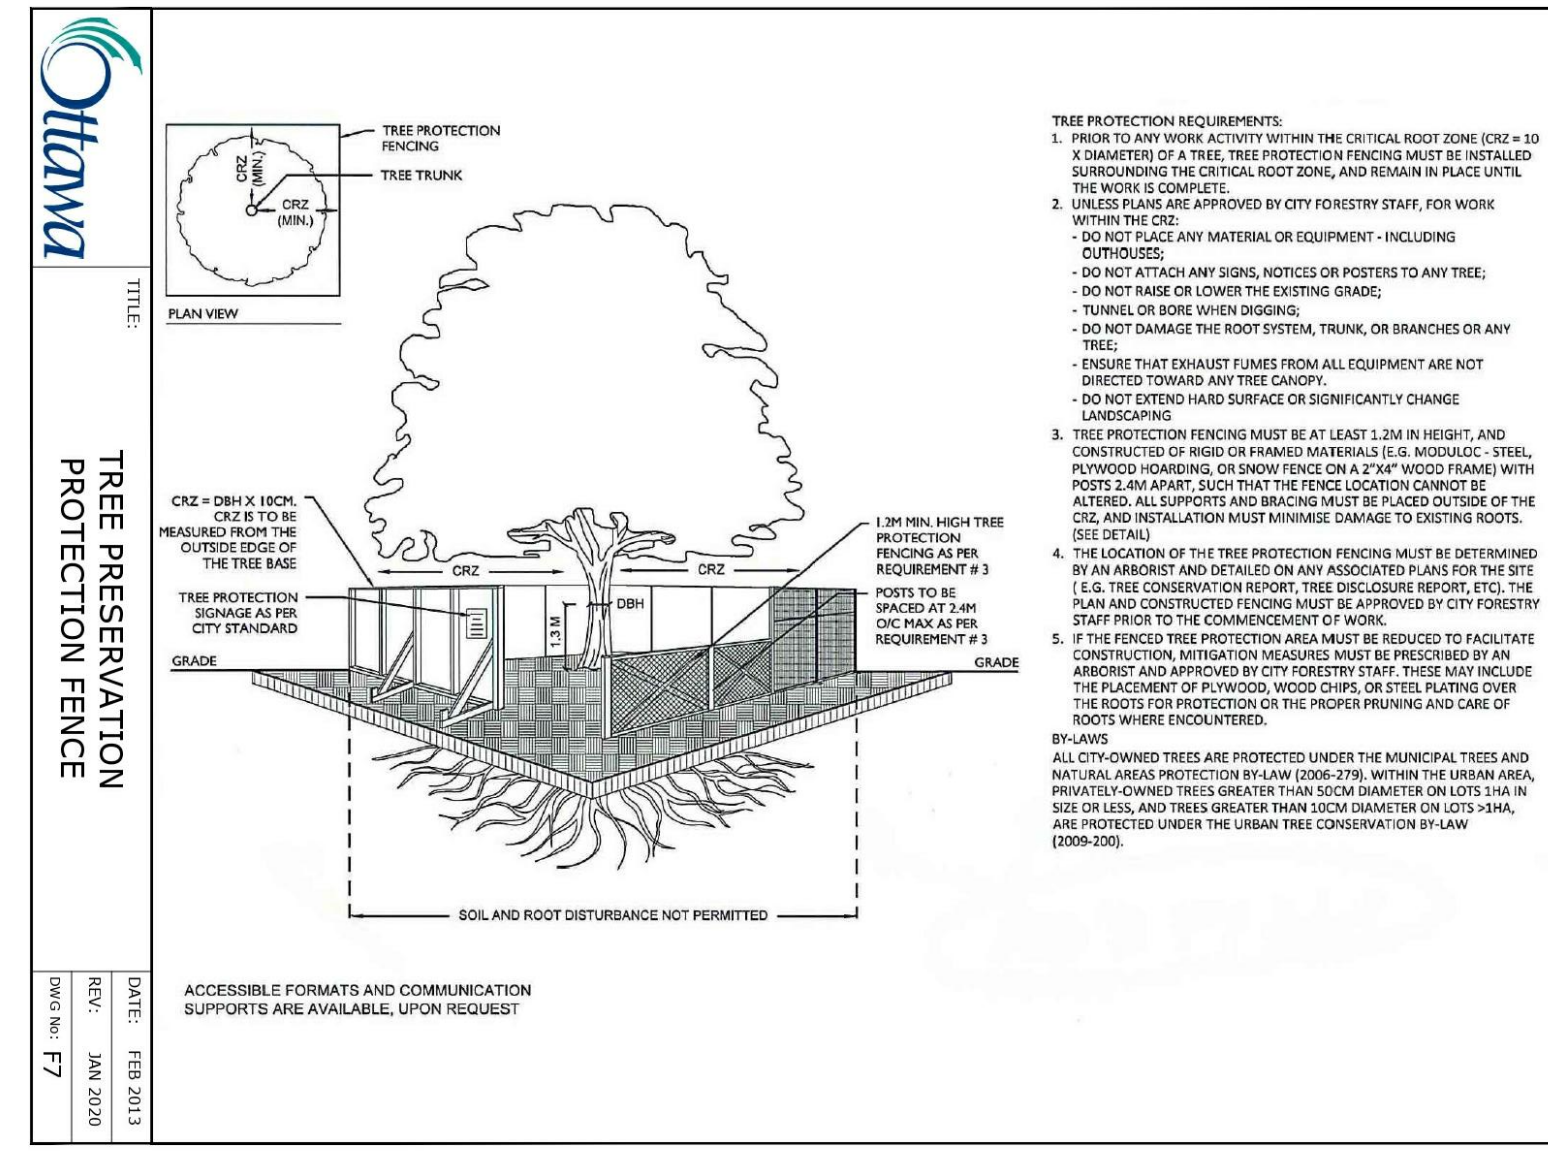


2 TREE PROTECTION FENCE
SCALE: NTS

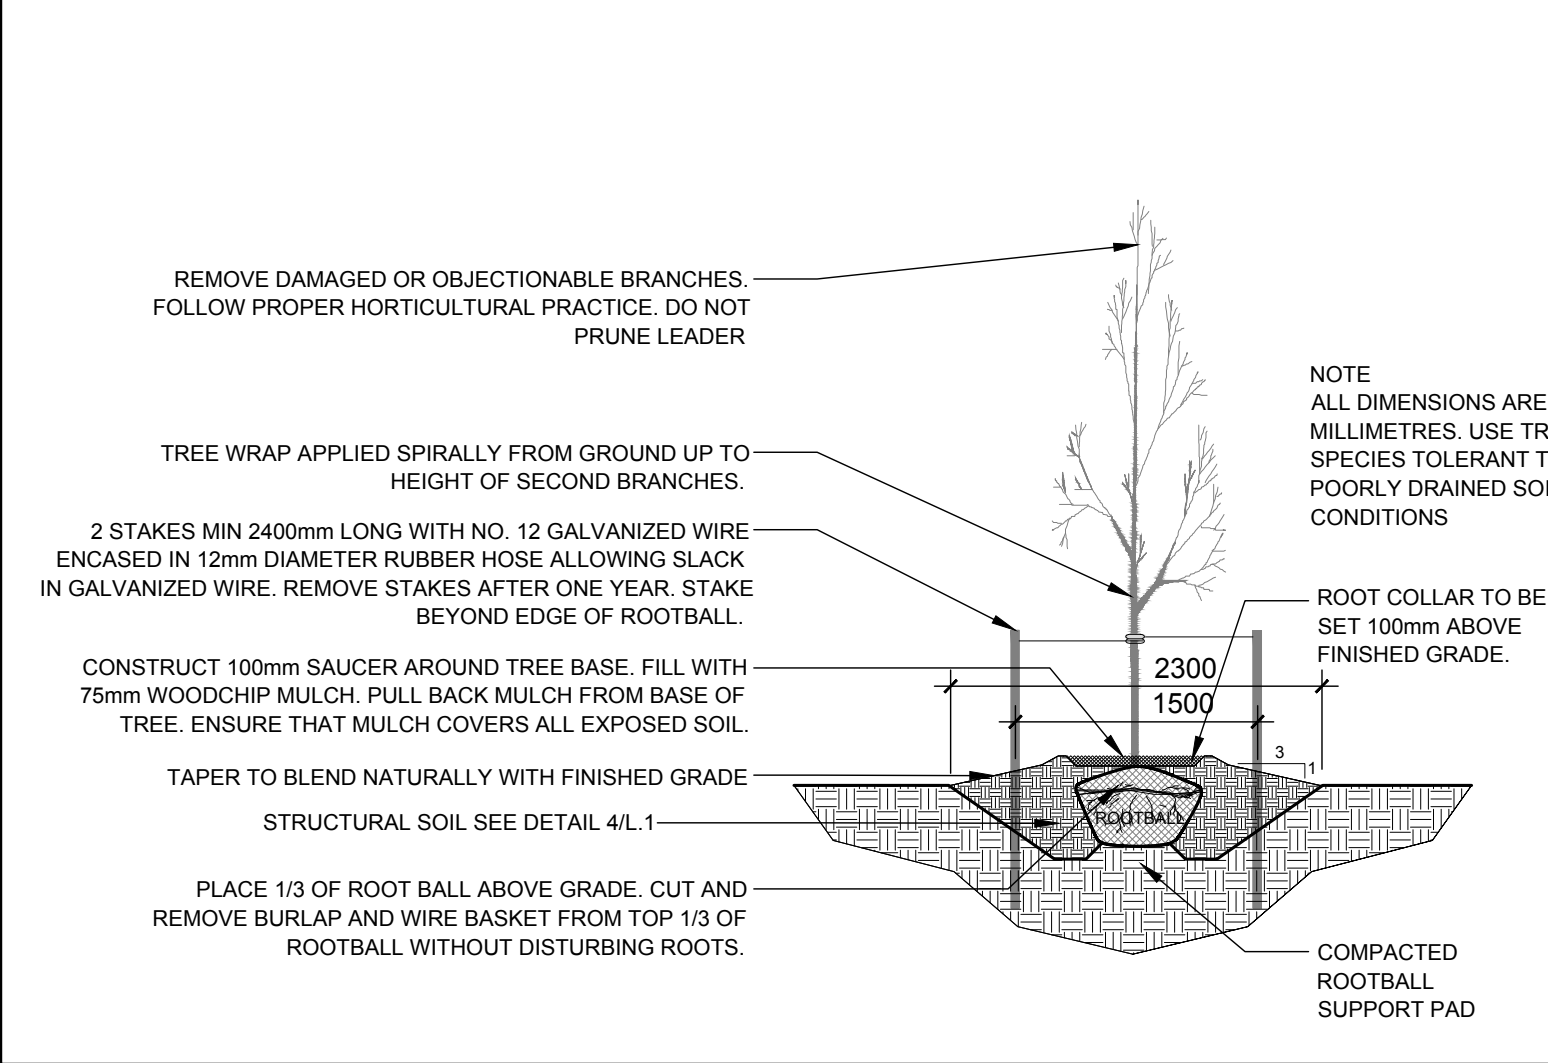

3 DECIDUOUS TREE PLANTING
SCALE: NTS

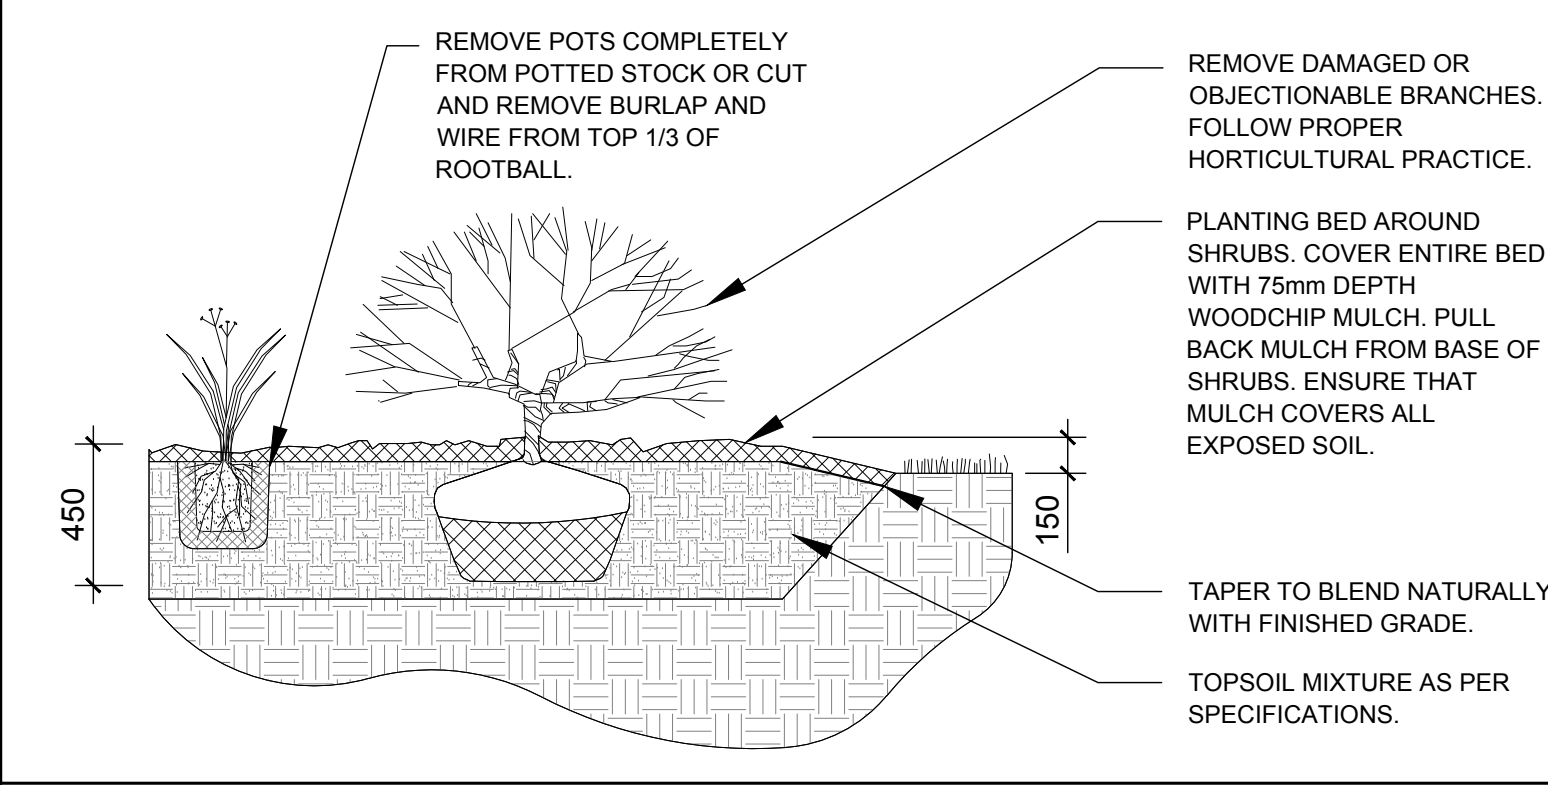

4 SHRUB / PERENNIAL PLANTING
SCALE: NTS

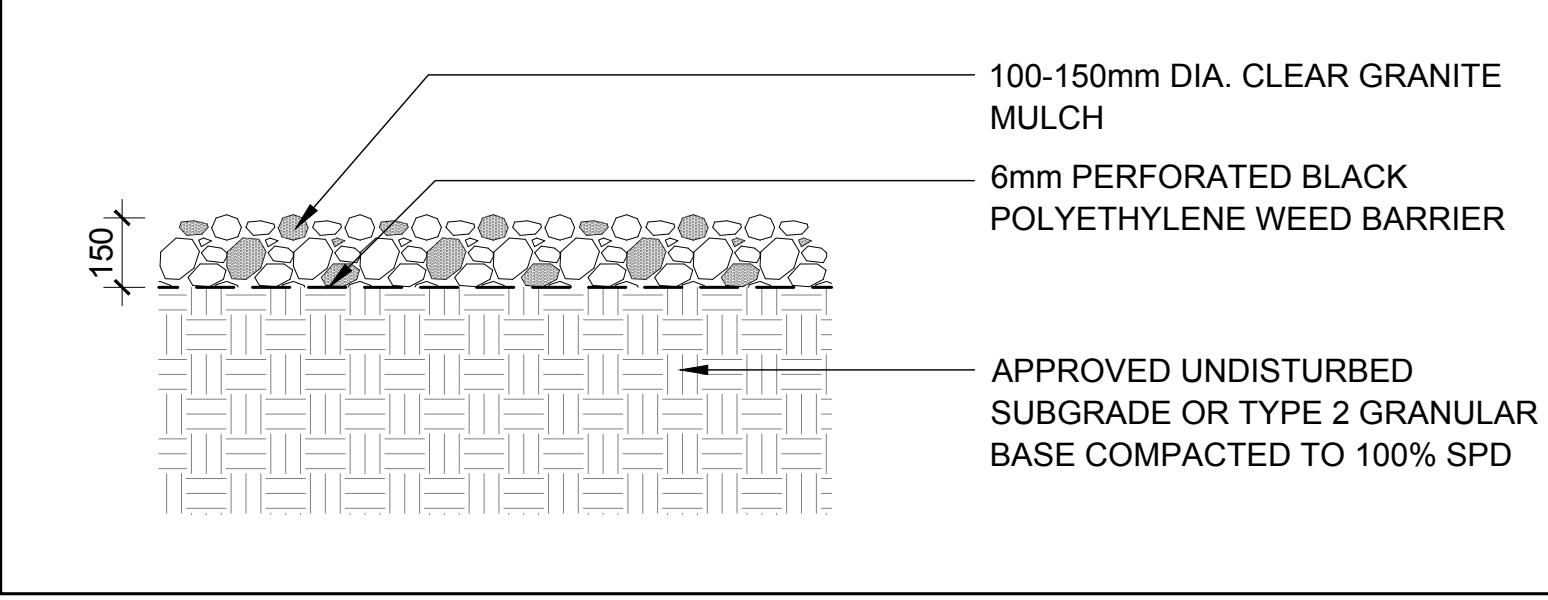

5 RIVERSTONE MULCH
SCALE: NTS

PROPOSED PLANT LIST

KEY	QTY	BOTANICAL NAME	COMMON NAME	SIZE	CONDITION	REMARKS
TREES						
HB	5	<i>Celtis occidentalis</i>	Hackberry	60mm ø	B&B	
HL	7	<i>Gleditsia triacanthos</i> 'Draves'	Street Keeper Honey Locust	60mm ø	B&B	
RM	1	<i>Acer rubrum</i>	Red Maple	60mm ø	B&B	
WI	1	<i>Salix alba</i> 'Tristis'	Weeping Willow	60mm ø	B&B	
SHRUBS						
AH	50	<i>Hydrangea arborescens</i> 'Annabelle'	Annabelle Hydrangea	1 gallon pot	Potted	1000 mm o.c.
PC	13	<i>Colonesaster apiculatus</i>	Peking Colonesaster	600mm ht.	Potted	1000 mm o.c.
RR	21	<i>Rosa rugosa</i>	Rugosa Rose	800mm ht.	Potted	1000 mm o.c.
SS	19	<i>Sorbaria sorbifolia</i> 'Sem'	Sem False Spirea	600mm ht.	Potted	1000 mm o.c.
PERENNIALS AND ORNAMENTAL GRASSES						
GH	72	<i>Hosta 'Guacamole'</i>	Guacamole Hosta	1 gallon pot	Potted	600 mm o.c.
HP	13	<i>Hosta 'Patriot'</i>	Patriot Hosta	1 gallon pot	Potted	600 mm o.c.
KF	128	<i>Calamagrostis 'Karl Foerster'</i>	Karl Foerster Grass	250mm pot	Potted	800 mm o.c.
SG	32	<i>Panicum virgatum</i> 'Shenandoah'	Shenandoah Switch Grass	250mm pot	Potted	800 mm o.c.

EXISTING TREE LIST

KEY	QTY	BOTANICAL NAME	COMMON NAME	SIZE	CONDITION	REMARKS
TREES						
AI	*	<i>Alnus incana</i>	Speckled Alder	50-100mm DBH	Good	See Plan
AN	*	<i>Acer negundo</i>	Manitoba Maple	100-200mm DBH	Good	See Plan
AR	1	<i>Acer rubrum</i>	Red Maple	250mm DBH	Fair	See Plan
AS	10	<i>Acer saccharum</i>	Sugar Maple	100-800mm DBH	Dead-Good	See Plan
FR	*	<i>Fraxinus</i> sp.	Ash	100-499mm DBH	Dead-Good	See Plan
MA	*	<i>Malus</i> sp.	Crabapple	100-300mm DBH	Fair-Good	See Plan
PP	6	<i>Picea pungens</i> 'Glauca'	Colorado Blue Spruce	300mm DBH	Good	See Plan
PD	*	<i>Populus deltoides</i>	Eastern Cottonwood	100-450mm DBH	Poor-Good	See Plan
SR	1	<i>Syringa reticulata</i>	Japanese Tree Lilac	300mm DBH	Good	See Plan
SA	*	<i>Salix</i> sp.	Willow	100-350mm DBH	Poor-Good	See Plan
TA	*	<i>Tilia americana</i>	Basswood	100-900mm DBH	Dead-Good	See Plan
TO	*	<i>Thuja occidentalis</i>	Eastern White Cedar	100-300mm DBH	Dead-Good	See Plan
UA	*	<i>Ulmus americana</i>	American Elm	100-300mm DBH	Dead-Good	See Plan

*DENOTES NUMEROUS

GENERAL NOTES:

- It is the responsibility of the appropriate contractor or official to report any errors, omissions or discrepancies on this plan with actual site conditions to the Landscape Architect before proceeding with construction.
- The contractor is to notify all utility companies and authorities prior to any excavation and ascertain locations of underground services.
- The contractor is to reinstatement all areas and items damaged as a result of construction activity.
- The contractor is to comply with all pertinent codes and by-laws.
- The contractor is to maintain a positive surface run-off throughout the entire construction period.
- The Landscape Architect is not responsible for subsurface conditions.
- The contractor is to identify all existing trees to remain on site with the Landscape Architect prior to construction.
- The contractor is to stake the proposed location of all plant material in conjunction with the Landscape Architect prior to excavation.
- Minimum distances for selected deciduous trees are as follows:
 - Building Foundations 7.5m
 - Sidewalks 1.5m
 - Public Streets 2.5m
 - Underground Infrastructure 2.0m
- All trees within 1m of underground utility trenches are to be excavated by hand.
- Remove all protective wrapping from tree trunks after installation.
- Staking of trees shall only be performed if necessary.
- Ensure that mulch is pulled back a min. distance of 75mm from base of tree trunk.

CLIENT: **HINDU TEMPLE OF OTTAWA CARLETON**
4835 BANK STREET, OTTAWA, ONTARIO K1J 1G6
Tel: (613) 613.822.1531

CONSULTANTS: **VECTOR DESIGN ARCHITECTS**
14 STATHAMBY STREET, OTTAWA, ONTARIO K2G 5N8
Tel: (613) 613.421.9969

CIVIL ENGINEERS: **LRL ASSOCIATES LTD.**
5430 CANOTEK RD. GLOUCESTER ON K1J 8G2
Tel: (613) 613.842.3434

LEGEND

- GROUP OF EXISTING TREES TO REMAIN
- EXISTING TREE TO REMAIN
- GROUP OF EXISTING TREES TO BE REMOVED
- EXISTING TREE TO BE REMOVED
- PROPOSED DECIDUOUS TREE
- PROPOSED SHRUBS/ PERENNIALS/ ORNAMENTAL GRASSES
- PROPOSED GRASS SEED
- PROPOSED SEED FOR STORMWATER PONDING AREAS
- PROPOSED RIVERSTONE MULCH
- PROPOSED RIP-RAP (REFER TO CIVIL DRAWING)
- PROPOSED TREE PROTECTION FENCE

1	ISSUED FOR SITE PLAN CONTROL	03/18/2020	ML	JL
No.	Issue	Date	Drawn	DR CK

JAMES B. LENNOX & ASSOCIATES INC. LANDSCAPE ARCHITECTS
3332 CARLING AVE. OTTAWA, ONTARIO K2J 5A8
Tel: (613) 722-5168 Fax: (866) 343-3942

PROJECT: **PROPOSED ASSEMBLY HALL - HINDU TEMPLE**
4835 BANK STREET, OTTAWA ON

DRAWING: **TREE CONSERVATION REPORT & LANDSCAPE PLAN**

STAMP: **ASSOCIATION OF LANDSCAPE ARCHITECTS OF ONTARIO**
MEMBER: **JAMES B. LENNOX**

SCALE: AS SHOWN
START DATE: AUGUST 2019
PROJECT NO.: 19MIS1974
DRAWING NO.: **L.1**
PLOT SIZE ARCH-D