
EROSION AND SEDIMENT CONTROLS DURING CONSTRUCTION.

DURING ALL CONSTRUCTION ACTIVITIES, EROSION AND SEDIMENTATION SHALL BE CONTROLLED BY THE FOLLOWING TECHNIQUES:

- 1. LIMITING THE EXTENT OF EXPOSED SOILS AT ANY GIVEN TIME.
- 2. REVEGETATION OF EXPOSED AREAS AS SOON AS POSSIBLE. 3. MINIMIZATION OF AREA TO BE CLEARED AND DISRUPTION TO ADJACENT AREAS.
- 4. INSTALLATION OF FILTER CLOTH BETWEEN FRAME AND COVER ON ALL PROPOSED CATCH BASINS AND CATCH BASIN
- 5. A SILT FENCE TO BE INSTALLED 0.3m INSIDE THE SITE PROPERTY LINE TO LOCATIONS SHOWN ON THIS DRAWING.
- 6. A VISUAL INSPECTION SHALL BE COMPLETED DAILY ON SEDIMENT CONTROL BARRIERS AND ANY DAMAGE REPAIRED IMMEDIATELY. CARE WILL BE TAKEN TO PREVENT DAMAGE DURING CONSTRUCTION OPERATIONS.
- 7. IN SOME CASES SOME BARRIERS MAY BE REMOVED TEMPORARILY TO ACCOMODATE THE CONSTRUCTION OPERATIONS. THE AFFECTED BARRIERS WILL BE REINSTATED AT NIGHT WHEN CONSTRUCTION IS COMPLETED.
- 8. THE SEDIMENT CONTROL DEVICES WILL BE CLEANED OF ACCUMULATED SILT AS REQUIRED. THE DEPOSITS WILL BE DISPOSED OF AS PER THE REQUIREMENTS OF THE CONTRACT.
- 9. DURING THE COURSE OF CONSTRUCTION IF THE ENGINEER BELIEVES THAT ADDITIONAL PREVENTION METHODS ARE REQUIRED TO CONTROL EROSION AND SEDIMENTATION, THE CONTRACTOR WILL INSTALL ADDITONAL SILT FENCES OR OTHER METHODS AS REQUIRED TO THE SATISFACTION OF THE
- 10. CONSTRUCTION AND MAINTENANCE REQUIRMENTS FOR EROSION AND SEDIMENT CONTROLS TO COMPLY WITH ONTARIO PROVINCIAL STANDARD SPEFICICATION (OPSS) OPSS 805, AND CITY OF OTTAWA SPECIFICATIONS.

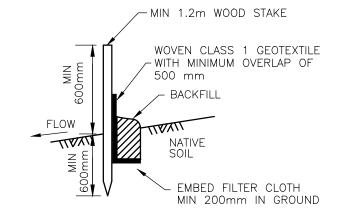

LIGHT DUTY SILT FENCE BARRIER

NOTES:

- . WOVEN WIRE FENCE TO BE FASTENED SECURELY TO WOOD POSTS WITH WIRE TIES OR STAPLES.
- 2. POSTS TO BE SPACED AT 2.3 METRES CENTRE TO
- 3. WHEN TWO SECTIONS OF FILTER CLOTH ADJOIN EACH OTHER THEY SHALL BE OVERLAPPED BY A MINIMUM OF
- 4. MAINTENANCE SHALL BE PERFORMED AS NEEDED AND MATERIAL REMOVED WHEN "BULGES" DEVELOP IN THE SILT
- 5. WOOD POSTS TO BE HARDWOOD TYPE (50mm x 50mm).
- 6. GEOTEXTILE TO BE EMBEDDED 200mm INTO GROUND.

7. GEOTEXTILE TO CONFORM TO OPSS 805 STANDARDS.

- 8. SILT FENCE MUST BE INSTALLED BEFORE COMMENCEMENT OF CONSTRUCTION AND IN ACCORDANCE WITH DETAIL. SILT FENCE CAN BE REMOVED AFTER LANDSCAPING IS
- 9. SEDIMENTS MUST BE CLEARED AWAY WHEN THEY REACH HALF THE HEIGHT OF THE FENCE.

TEMPORARY LIGHT DUTY SILT FENCING (AS PER OPSD,219. 10) TO BE PLACED

TEMPORARY STRAW BALE CHECK

DAM (AS PER OPSD.219.110)

300mmø (MIN) RIP-RAS

UNDERLAID WITH GEOTEXTILE.


FLOW CHE DAM SET
AT 150.0m ABOVE
BOTT OF SWALE AT
2.0m WIDE

\0.3m (INSIDE PROPERTY LINE\

TEMPORARY LIGHT DUTY SILT FENCING

.3m INSIDE PROPERTY LINE

(AS_PER_OPSD.219.110) TO BE PLACED

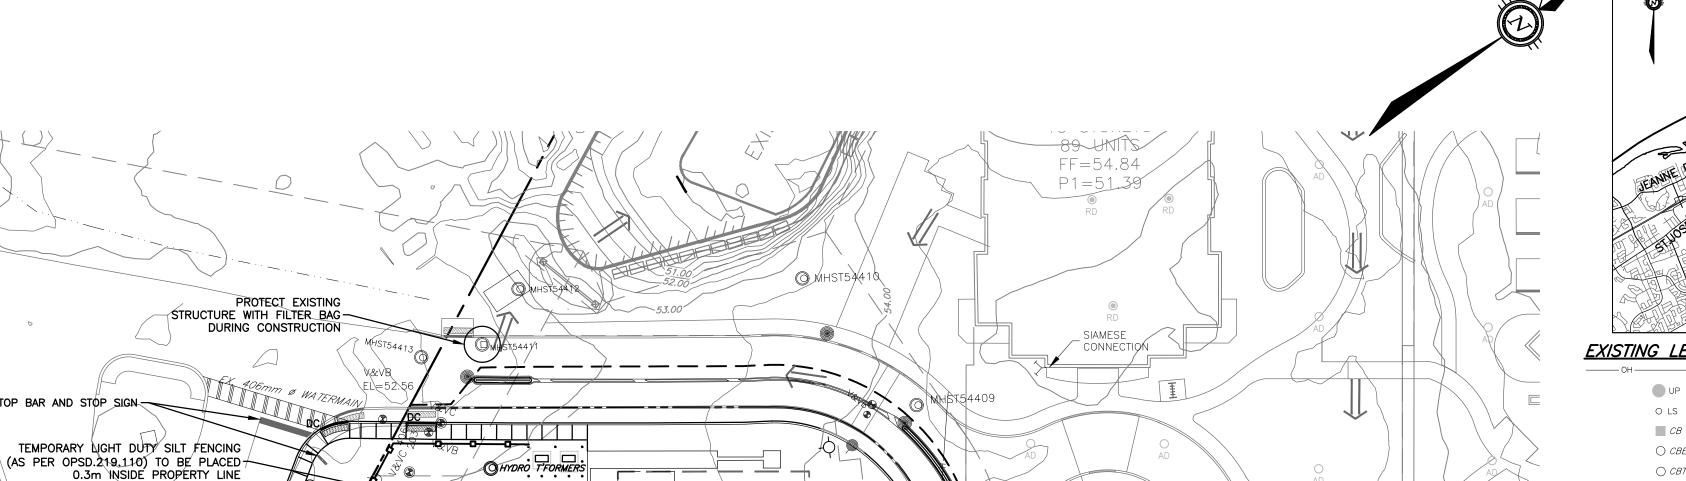

PHASE 5

TOWER 5E

22 STOREYS

196 UNITS FF=54.60 GRS=52.62

P1 = 49.68

P2=47.03 P3=44.38

PHASE 5 TOWER 5A

32 STOREYS

286 UNITS

FF=54.60

GRS=52.62

P1*≠*49.68

P2=47.03

LIMIT OF U/G
PARKING BELOW

(3 LEVELS)

P3=44.38

PROTECT PROPOSED

PROTECT EXISTING AND PROPOSED STRUCTURES WITH

FILTER BAG DURING

HEADWALL AS PER

OPSD 804.030. TOP OF HEADWALL=53.50

PROTECT EXISTING

DURING CONSTRUCTION

STRUCTURE WITH FILTER BAG

MHST76835

STRUCTURES WITH FILTER

HEADWALL AS PER OPSD 804.030. — TOP OF HEADWALL=53.50

TEMPORARY STRAW

3.0m MULTI-USE PATHWA


-BALE CHECK DAM (AS-

PER OPSD.219.110)

REGIONAL ROAD 174 (WEST BOU)

REGIONAL ROAD 174 (EAST BOUND)

BAG DURING CONSTRUCTION

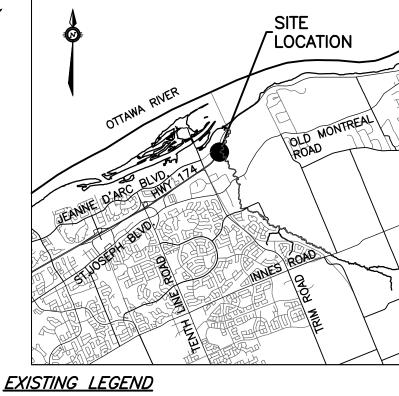

KEY PLAN

● UP	UTILITY POLE
O LS	LIGHT STANDARD
☐ CB	CATCHBASIN
○ CBE	CATCHBASIN ELBOW
○ CBT	CATCHBASIN TEE
● AD	AREA DRAIN
T/G	TOP OF GRATE
□ GM	GAS METER
MH	MANHOLE (SANITARY OR STORM
G	GAS MAIN
V&VB	VALVE AND VALVE BOX
V&VC	VALVE AND VALVE CHAMBER


FIRE HYDRANT

EX.250mmø SAN STORM SEWER __ __EX.300mmø STM__ _ SANITARY SEWER EX.200mmø_WM WATERMAIN

ORIGINAL GROUND ELEVATION EXISTING CONTOUR OVERLAND FLOW ROUTE

PROPOSED LEGEND PROPERTY LINE 200mmø SAN SANITARY SEWER ______ 200mmø STM ___ STORM SEWER

WATERMAIN CLAY SEAL

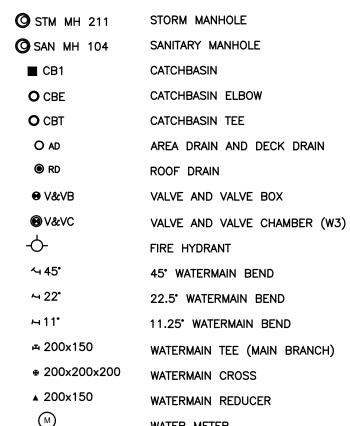

WATER METER REMOTE WATER METER READER sc ⊱ SIAMESE CONNECTION FF= FLOOR ELEVATION GRS= GARAGE FLOOR SLAB ELEVATION PARKING LEVEL FLOOR ELEVATION 3.0% SLOPE AND DIRECTION OF FLOW

FINAL GRADE HIGH POINT TERRACING T/G= TOP OF GRATE ELEVATION T/F= TOP OF FLANGE OVERLAND FLOW ROUTE PHASING LIMITS SILT FENCE

BARRIER CURB (SC1.1) DEPRESSED BARRIER CURB LOCATION SWALE AND DIRECTION OF FLOW

RETAINING WALL BUILDING ENTRY LOCATION STRUCTURE TO BE ADJUSTED STRUCTURE TO BE RELOCATED

STRAW BALE CHECK DAM LOCATION • • • •

OH OH OVERHEAD WIRES

ARCHITECTURE DE PAYSAGE Landscape architect

TOPOGRAPHIC INFORMATION

DATED JULY 20, 2018

JOB BENCHMARK

MTM-NAD83 ZONE 9

ELEVATION=52.68

NORTHING=5040610.15 EASTING=384736.57

NCC MONUMENT 01919680184

PROVIDED BY ANNIS, O'SULLIVAN, VOLLEBEKK LTD.

PROVIDED BY ANNIS, O'SULLIVAN, VOLLEBEKK LTD.

exp SERVICES INC. 2650 Queensview Drive, Unit 100, Ottawa, ON, K2B 8H6 T 613 688 1899 F 613 225 7330 www.exp.com

ARCHITECTES Architect NEUF architect(e)s sencre 630, boul. René-Lévesque O. 32e étage, Montréal QC H3B 1S6 T 514 847 1117 NEUFarchitectes.com

SCEAU Seal

exp Services Inc. t: +1.613.688.1899 | f: +1.613.225.7337 2650 Queensview Drive, Suite 100 Ottawa, ON K2B 8H6

CXD.

• BUILDINGS • EARTH & ENVIRONMENT • ENERGY • • INDUSTRIAL • INFRASTRUCTURE • SUSTAINABILITY •



OUVRAGE Project PETRIE'S LANDING I-PHASES 3-5

EMPLACEMENT Location NO PROJET No. OTT-00247308-A0 OTTAWA, ON.

Ю	RÉVISION	DATE (aa.mm.j
	ISSUED FOR REVIEW	18.08.03
2	ISSUED FOR SITE PLAN APPROVAL	18.09.14

110	REVIOION	DATE (dd.IIIII.jj)
1	ISSUED FOR REVIEW	18.08.03
2	ISSUED FOR SITE PLAN APPROVAL	18.09.14
3	ISSUED FOR CLIENT REVIEW	19.04.05
4	ISSUED FOR SITE PLAN APPROVAL	19.05.10
5	ISSUED FOR SITE PLAN APPROVAL	19.05.22
6	ISSUED FOR SPA-CITY COMMENTS	19.07.22
7	REVISED PER CITY COMMENTS	19.07.30

DESSINÉ PAR Drawn by VÉRIFIÉ PAR Checked by **B.THOMAS** S.BUTLER

DATE (aa.mm.jj) 18.07.18 ÉCHELLE Scale 1:400 TITRE DU DESSIN Drawing Title


EROSION & SEDIMENT CONTROL PLAN TOWERS 5A & 5B

C301



APPROVED

By Jeff McEwen at 3:22 pm, Mar 25, 2020

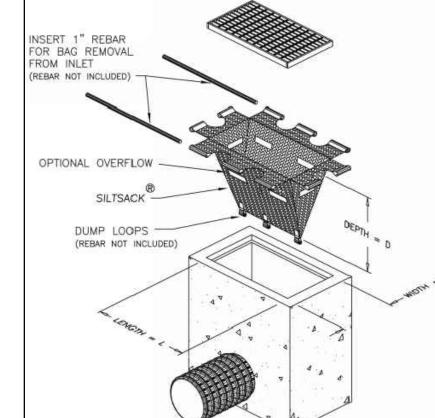

PROVIDE FILTER BAGS AS SHOWN (GEO-SYNTHETICS MANUFACTURER OR APPROVED EQUIVALENT)

FILTER BAG DETAIL

