



1 EXTERIOR WEST ELEVATION A3.0 SCALE 1:100

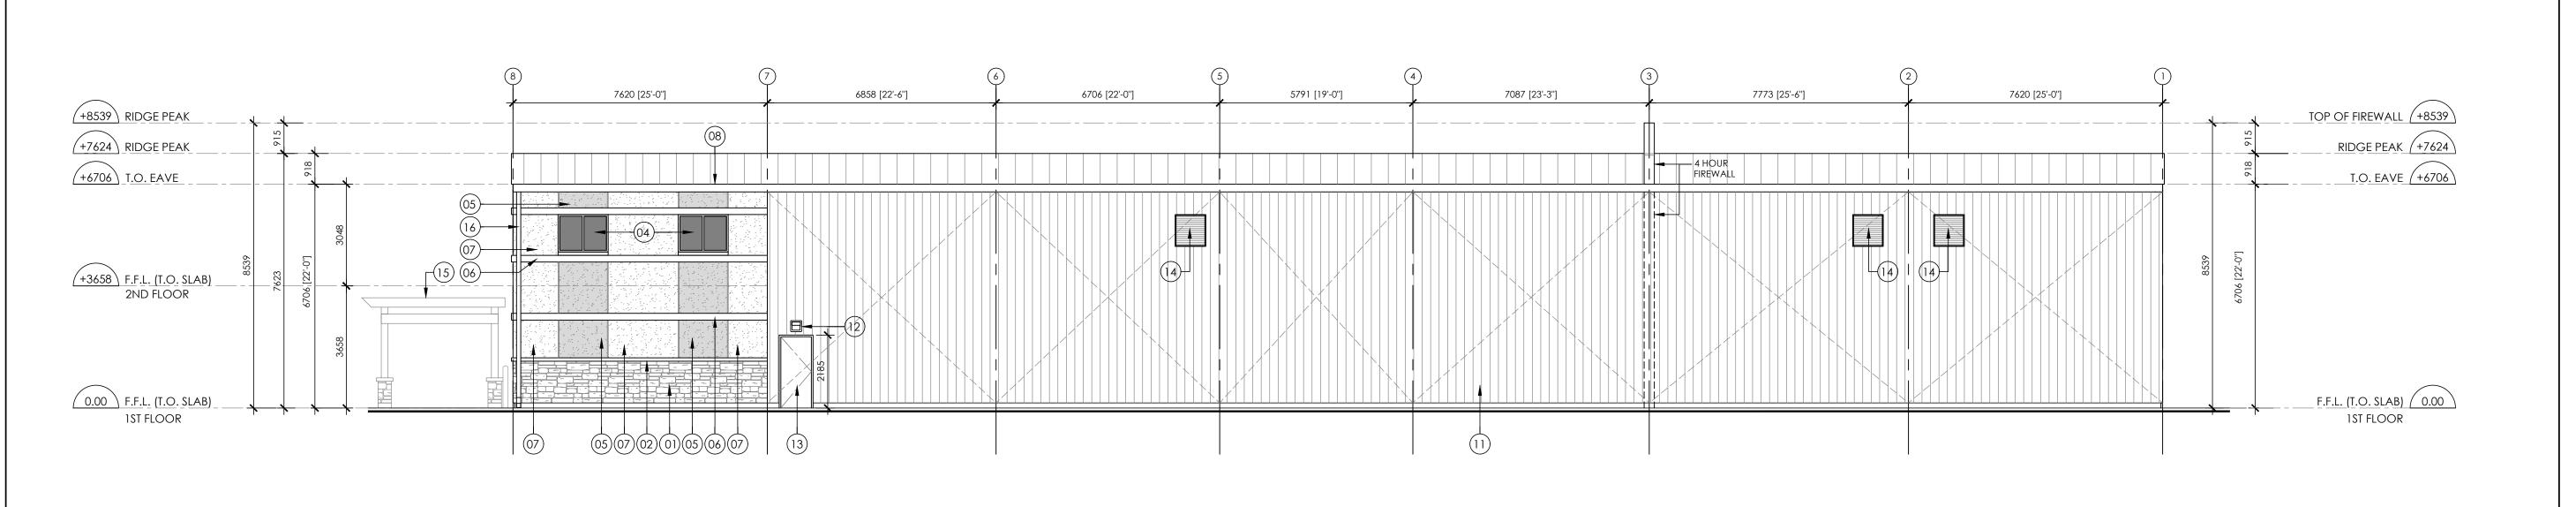

2 EXTERIOR EAST ELEVATION A3.0 SCALE 1:100

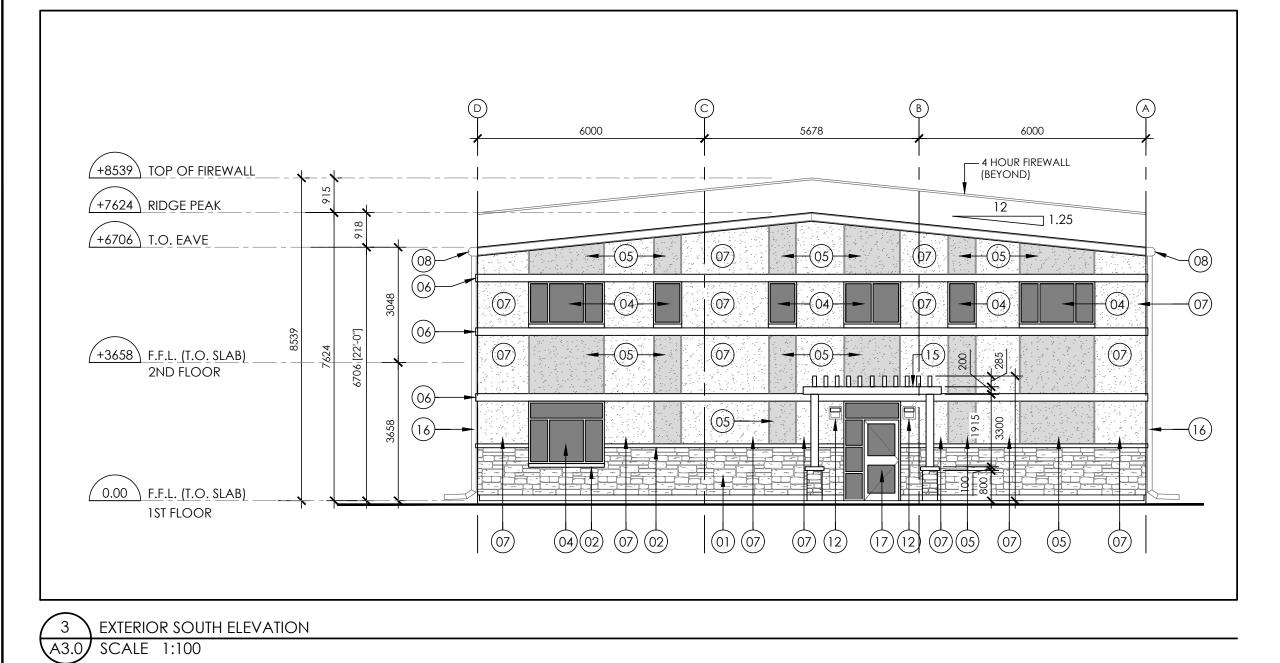


6000 — 4 HOUR FIREWALL +8539 TOP OF FIREWALL (BEYOND) +7624 RIDGE PEAK +6706 T.O. EAVE 12 +3658 F.F.L. (T.O. SLAB) 2ND FLOOR 0.00 F.F.L. (T.O. SLAB) **1ST FLOOR** 4 EXTERIOR NORTH ELEVATION

EXTERIOR ELEVATIONS NOTES

- 01) EXTERIOR ARCHITECTURAL STONE VENEER PRODUCT STYLE, FINISH AND COLOUR TO BE DETERMINED.
- 02) ARCHITECTURAL PRECAST CONCRETE SILL/CAP PERMACON, BUFFED, COLOUR TO BE DETERMINED.
- 03) RESERVED.
- 04) DARK TINTED GLASS IN BLACK ANODIZED ALUMINUM WINDOW.
- 05) E.I.F.S. (ACCENT COLOUR) DRYVIT, SAND PEPPLE, COLOUR: TO BE DETERMINED.
- 06) E.I.F.S (TRIM/BAND) DRYVIT, SAND PEPPLE, COLOUR: TO BE DETERMINED.
- 07) E.I.F.S. (GENERAL COLOUR) DRYVIT, SAND PEPPLE, COLOUR: TO BE DETERMINED.
- (08) PRE-FINISHED METAL ROOF GUTTER/EAVESTROUGH.
- 09) 4267 (W) X 4875 (H) INSULATED SECTIONAL STEEL OVERHEAD DOOR.
- 150 Ø CONCRETE FILLED STEEL BOLLARD (TYP.). PAINT FINISH COLOUR: TO BE DETERMINED.
- 32mm GALVANIZED CORRUGATED STEEL PANEL. PBR PANEL FROM ROBERTSON BUILDING SYSTEMS. COLOUR: TO BE DETERMINED.
- (12) EXTERIOR WALL MOUNTED LIGHT FIXTURE (TYP.). EXTERIOR INSULATED STEEL DOOR AND FRAME. PAINT COLOUR: TO BE DETERMINED.
- MECHANICAL HVAC/FAN LOUVER C/W PRE-FINISHED
- EXTERIOR METAL TRIM. MAPLE FINISHED WOOD TRELLIS/ENTRANCE CANOPY ON (4) WOOD POSTS AND CONCRETE PIER
- PRE-FINISHED STEEL DOWNSPOUT. COLOUR TO MATCH BUILDING CORRUGATED STEEL PANEL.
- EXTERIOR INSULATED ALUMINUM STOREFRONT DOOR AND SIDELIGHT ASSEMBLY WITH DARK TINTED GLASS.

GENERAL NOTES

- CONTRACTOR SHALL VERIFY ALL DIMENSIONS ON SITE AND SHALL REPORT ANY DISCREPANCIES TO THE ARCHITECT PRIOR TO
- COMMENCEMENT OF WORK. CONTRACTOR MUST COMPLY WITH ALL CODES AND BYLAWS AND OTHER REGULATIONS BY AUTHORITIES HAVING JURISDICTION OVER THE
- DO NOT SCALE THIS DRAWING.
- THIS DRAWING MAY NOT BE USED FOR CONSTRUCTION UNLESS SEALED/SIGNED BY THE
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00 ISSUED FOR SITE PLAN APPROVAL 2019/11/13 DATE (YY/MM/D

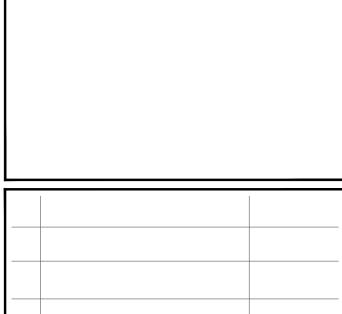REVISIONS

ORIENTATION

architecture

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PROJECT

BADGER DAYLIGHTING **EQUIPMENT STORAGE AND** OFFICE BUILDING

3025 CARP ROAD, OTTAWA, ON

DRAWING TITLE

ELEVATIONS

A.A. | DRAWING NO. REVIEWED BY START DATE 2019/08/06

PROJECT NO. 19011 REVISION NO.

SHEET SIZE: ARCH D 24" X 36" (609.6mm X 914.4mm)

PLOT DATE: November 13, 2019