Municipal Address: 289 Ca	f Ottawa arling Avenue	R4T[831]	at C	10 8 6	R4T TM[2214] S221
Registered Owner: John H Lot Area: 1270.5	loward Society of Ottawa 526 m²			14 14	B
Zoning Analysis			2 24 22 20 18 16	14	2 - 33 - 2
Ottawa Zoning By-Law: 2008-2 Zone: AM 10			GM F(1:0)		% AM[2022] S303
	- I-Use Office and Apartmer	nt Building	M	ature Neighbo	urhoods Overlay
			Zone sous-ja	icente du cara	ictère des anciens quartiers
		MC F(2.0)	1		* ?
		28	BEL	01	SUBJECT PROPERTY:
		50	BELL ST.S.	/	289 CARLING AVE Carling Arena Mainstreet Avenue Carling, artère principale
			ů,	789	Avenue Caving altere principale
					WE
			AM10		CARLING AVE.
					700 201
		20			R4M 251 2
		OU CO		6	R1QQ
		Are.	© 2018	- City Of Ottawa/Mile	e d'Ottawa. © Teranet Entrerises Inc.
		SCALE 1:1			
Development Stand					LEGAL DESCRIPTION:
		Required	Provided	Compliance	LOT 10 AND PART OF LOTS 8,
Minimum Lot Area Minimum Lot Width		No Minimum No Minimum	1,270.53 sq.m 32.95m/27.23m	Yes	AND 11 (CARLING AVENUE)
Minimum Required Yard	Front Yard (Carling Ave)	No minimum	3.7 m (ROW	Yes	REGISTERED PLAN 31326
		At least 50 % of frontage must be occupied by	dedication) 27.46m Frontage	Yes	
		building walls located within 3.0 m of the frontage Minimum ground floor height within 10 m of front		Yes	
		lot line: 4.5 m Minimum building height within 10 m of front lot	10.15 m	Yes	CITY OF OTTAWA
	Corner Side Yard	line: 7.5 m No minimum	0.05 m	Yes	
	Interior Side Yard Rear Yard	No minimum No minimum	0.24 - 0.77 m 0.14 m	Yes Yes	
Minimum Building Height		Any portion of a building within 10 m of a front or corner lot line must have a minimum of 2 (two)	7 Stories, 22.53 m	Yes	BUILDING AREA (OUT TO OUT)
		stories and have a minimum building height of: 7.5 m			Level Area (m2) Ar
Minimum Building Height		Ground floor must be 4.5 m above average grade	4.5 m	Yes	LO LOWER PARKING/ BASEMENT MAIN 1009.85
Maximum Building Height Permitted Projections	parapet, rooftop access	30 m (up to 9 storeys)	22.53m 0.9 m parapet	Yes Yes	ENTRANCES AND OFFICE L1 UPPER PARKING 959.18
Permitted Projections	parapet, roonop access		1.5m elevator penthouse	res	L2 OFFICES947.05L3 OFFICES AND RESIDENTIAL546.93
Corner Sight Triangle Landscaping		5x5m at Bell St and Carling Ave	provided All provided yards	Yes Yes	L4 RESIDENTIAL UNITS546.92L5 RESIDENTIAL UNITS546.92
Lanascaping		Rone required	to be landscaped where not	105	L6 RESIDENTIAL UNITS 546.92
			occupied by driveways and		GROSS FLOOR AREA (GFA)
Orientation of Principal		The ground floor façade facing a public street	pathways 2 entrances at	Yes	Name of Area Level
Entrance:		located within 3.0 m of the front or corner side lot line must include a minimum of one active entrance for each individual occupancy located immediately	corner		AMENITY L3 OFFICES AND RESIDENTIAL AMENITY L4 RESIDENTIAL UNITS
Façade Requirements		adjacent to the front or corner lot lines A minimum of 50% of the surface area of the	Carling Ave: 52%	Yes	AMENITY L5 RESIDENTIAL UNITS AMENITY L6 RESIDENTIAL UNITS
raçade Requirements		ground floor façade facing a public street must be comprised of transparent glazing and active	Bell St: 51%	163	
Parking Spaces	Area Y on Schedule 1A	customer or resident entrance access doors			EXT AMENITY L3 OFFICES AND RESIDENTIAL
	Occupant Units 0.5 spaces/dwelling	40 units - 12 units = 28 units		Yes	OFFICE L0 LOWER PARKING/ BASEMENT MAIN
	unit, no off street motor vehicle parking	28 units x 0.5 spaces/ unit			OFFICE L0 LOWER PARKING/ BASEMENT MAIN ENTRANCES AND OFFICE OFFICE L2 OFFICES
	is required to be provided for the first 12 units	= 14 spaces			OFFICE L3 OFFICES AND RESIDENTIAL
8 8	Visitor Units 0.1 spaces/dwelling	40 units - 12 units = 28 units		Yes	Residential L3 OFFICES AND RESIDENTIAL
	unit, no off street motor vehicle parking	28 units x 0.1 spaces/unit			Residential LS OFFICES AND RESIDENTIAL Residential L4 RESIDENTIAL UNITS Residential L5 RESIDENTIAL UNITS
	is required to be provided for the first	= 2.8 spaces = 3 spaces			Residential LS RESIDENTIAL UNITS Residential L6 RESIDENTIAL UNITS
Parking Office:	12 units	1 space/ 100 sq.m GFA		Yes	
		999 ÷ 100 10 spaces			
Parking Total:		Shared provisions for visitor/office: -1 Total Parking Spaces = 14+ 3 + 9 = 26 spaces	29 spaces	Yes	
Driveway Width (parking access)		For lots containing fewer than 20 spaces, minimum: 3.0 m (single traffic)	3.0m/3.2m	Yes	
· ·		Minimum 6.7 m Minimum 2.6 m x 5.2 m	6.8 m 2.6 x 5.2 m	Yes Yes	
Drive Aisle Width Size of parking spaces:		1 Space	1 Space 1 Space	Yes	
Size of parking spaces: Parking For Physically	Туре А: Туре В:	1 Space		Yes	
Size of parking spaces: Parking For Physically		1 Space Not in required front of corner side yard	located within building	105	
Size of parking spaces: Parking For Physically Disabled Parking Location Bicycle Parking			building	Yes	
Size of parking spaces: Parking For Physically Disabled Parking Location Bicycle Parking	Type B: Dwelling units in the same building as a non-residential use:	Not in required front of corner side yard 0.5 spaces/unit 40 dwelling units x 0.5 20 spaces	building	Yes	
Size of parking spaces: Parking For Physically Disabled Parking Location Bicycle Parking	Type B: Dwelling units in the same building as a	Not in required front of corner side yard 0.5 spaces/unit 40 dwelling units x 0.5 20 spaces 1 space/ 250 m2 GFA 999	building		
Size of parking spaces: Parking For Physically Disabled Parking Location Bicycle Parking	Type B: Dwelling units in the same building as a non-residential use: Office:	Not in required front of corner side yard 0.5 spaces/unit 40 dwelling units x 0.5 20 spaces 1 space/ 250 m2 GFA 999 ÷ 250 3.9 spaces = 4 spaces	20 Spaces 4 Spaces	Yes Yes	
Size of parking spaces: Parking For Physically Disabled Parking Location Bicycle Parking	Type B: Dwelling units in the same building as a non-residential use:	Not in required front of corner side yard 0.5 spaces/unit 40 dwelling units x 0.5 20 spaces 1 space/ 250 m2 GFA 999 ÷ 250 3.9 spaces = 4 spaces 24 Spaces 1 for every office use between 1,000 and 1,999 m2	building 20 Spaces 4 Spaces 24 Spaces Office space: 999	Yes	
Size of parking spaces: Parking For Physically Disabled Parking Location Bicycle Parking	Type B: Dwelling units in the same building as a non-residential use: Office: Total (Indoor):	Not in required front of corner side yard 0.5 spaces/unit 40 dwelling units x 0.5 20 spaces 1 space/ 250 m2 GFA 999 ÷ 250 3.9 spaces = 4 spaces 24 Spaces 1 for every office use between 1,000 and 1,999 m2 office GFA	building 20 Spaces 4 Spaces 24 Spaces Office space: 999 m2 = 0 Loading Space	Yes Yes Yes Yes	
Size of parking spaces: Parking For Physically Disabled Parking Location Bicycle Parking	Type B: Dwelling units in the same building as a non-residential use: Office:	Not in required front of corner side yard 0.5 spaces/unit 40 dwelling units x 0.5 20 spaces 1 space/ 250 m2 GFA 999 ÷ 250 3.9 spaces = 4 spaces 24 Spaces 1 for every office use between 1,000 and 1,999 m2 office GFA 6 sq.m / unit x 40 units	building 20 Spaces 4 Spaces 24 Spaces Office space: 999 m2 = 0 Loading Space	Yes Yes Yes	
Size of parking spaces: Parking For Physically Disabled Parking Location Bicycle Parking Loading Space Amenity Space	Type B: Dwelling units in the same building as a non-residential use: Office: Total (Indoor):	Not in required front of corner side yard 0.5 spaces/unit 40 dwelling units x 0.5 20 spaces 1 space/ 250 m2 GFA 999 ÷ 250 3.9 spaces = 4 spaces 24 Spaces 1 for every office use between 1,000 and 1,999 m2 office GFA 6 sq.m / unit	building 20 Spaces 4 Spaces 24 Spaces Office space: 999 m2 = 0 Loading Space	Yes Yes Yes Yes	



РВС Development & Construction Management Group Inc. PROJECT MANAGER: PBC DEVELOPMENT & CONSTRUCTION MANAGEMENT GROUP INC.

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Civil Engineer:

e-mail:

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e-mail:

Geotechnical Engineer: PATERSON GROUP INC. 154 COLONNADE RD. SOUTH OTTAWA, ONTARIO K2E 7J5 Tel: (613) 226-7381 Fax:` e-mail:

Landscape Architect: JAMES B. LENNOX & ASSOCIATES INC.

3332 CARLING AVE. OTTAWA, ONTARIO K2H 5A8 Tel: (613) 722–5168 Fax: 1 (866) 343–3942 e-mail:vp@jbla.ca

Surveyor:

FARLEY, SMITH & DENIS SURVEYING LTD. 190 COLONNADE ROAD OTTAWA, ONTARIO K2E 7J5 Tel: (613) 727-8228 Fax: (613) 727–1823 e-màil:

Transportation:


CGH TRANSPORTATION

OTTAWA, ONTARIO Tel: (905) 251 4070 Fax: ` e-mail:

Acoustic:

GRADIENT WIND

127 WALGREEN RD OTTAWA, ONTARIO, KOA 1LO Tel: (613) 836-0934 Fax: e-mail:

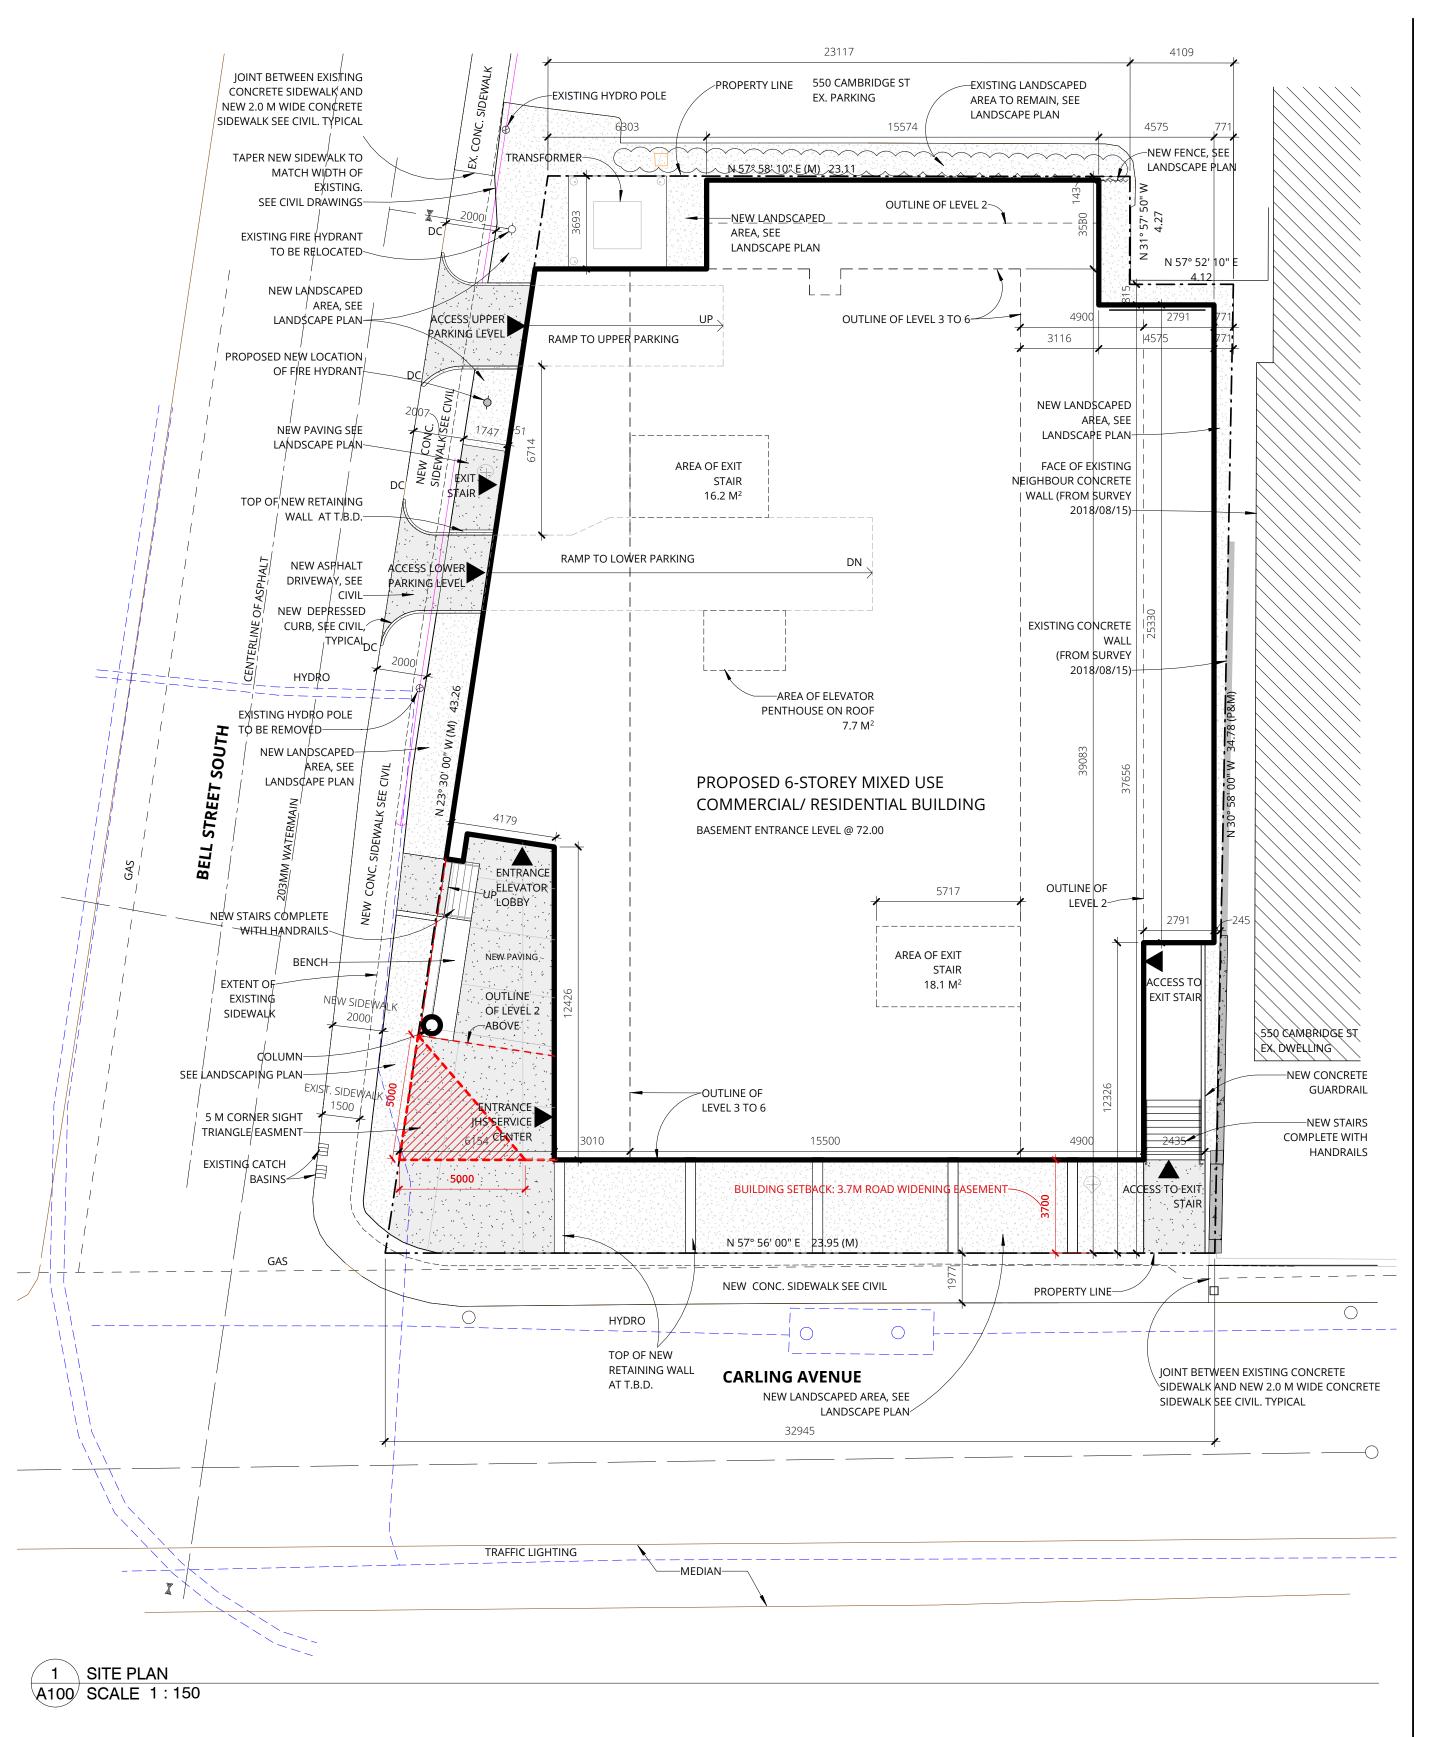

LEGAL DESCRIPTION:

LOT 10 AND PART OF LOTS 8, 9 AND 11 (CARLING AVENUE), REGISTERED PLAN 31326, CITY OF OTTAWA Based on Survey by Fairhall Moffatt & Woodland LTD, dated 2018/08/16

NOTES:

Contractor shall check and verify all dimensions on site and report any discrepancies to the Architect before proceeding.

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K	WC	KV	VC ARC	HITECTS INC.
C	MY	FA	X (613) 238-2117 613) 238-6595 wc@kwc-arch.com
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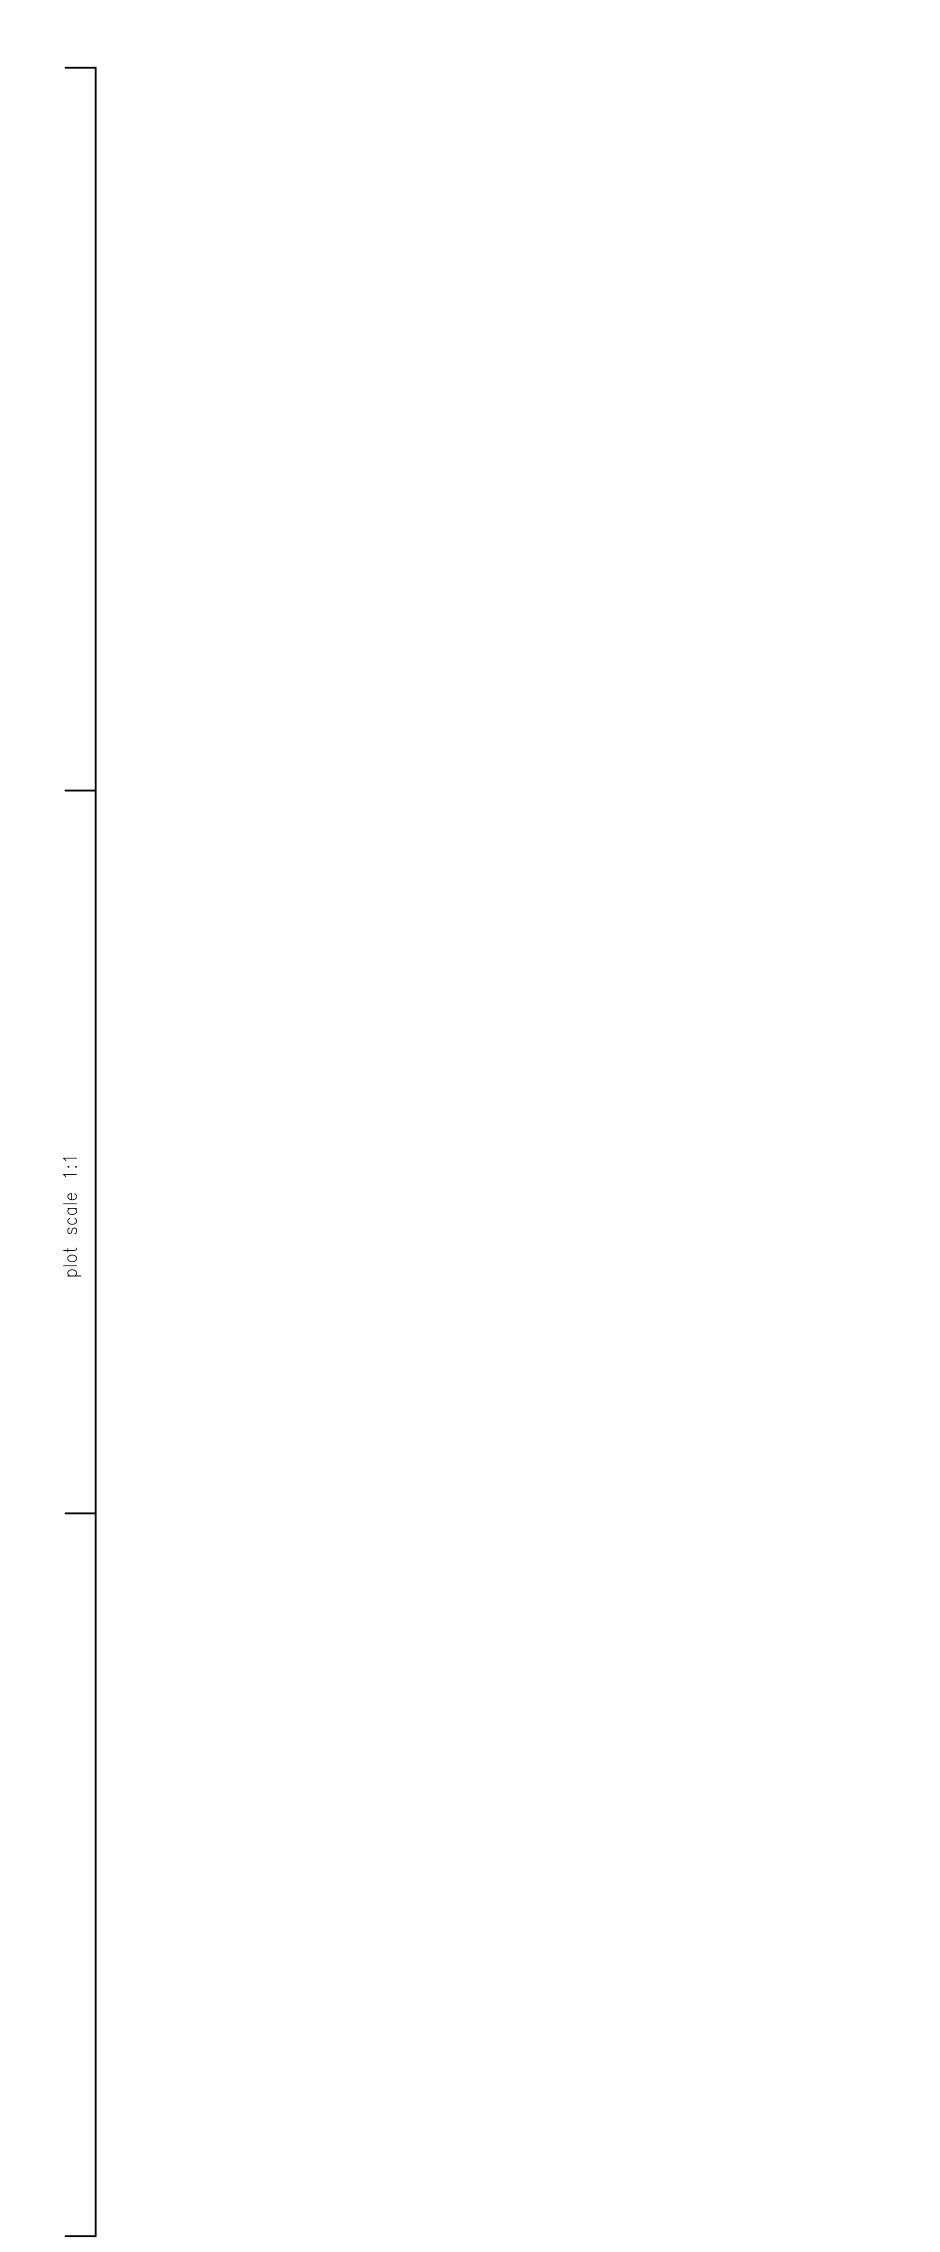
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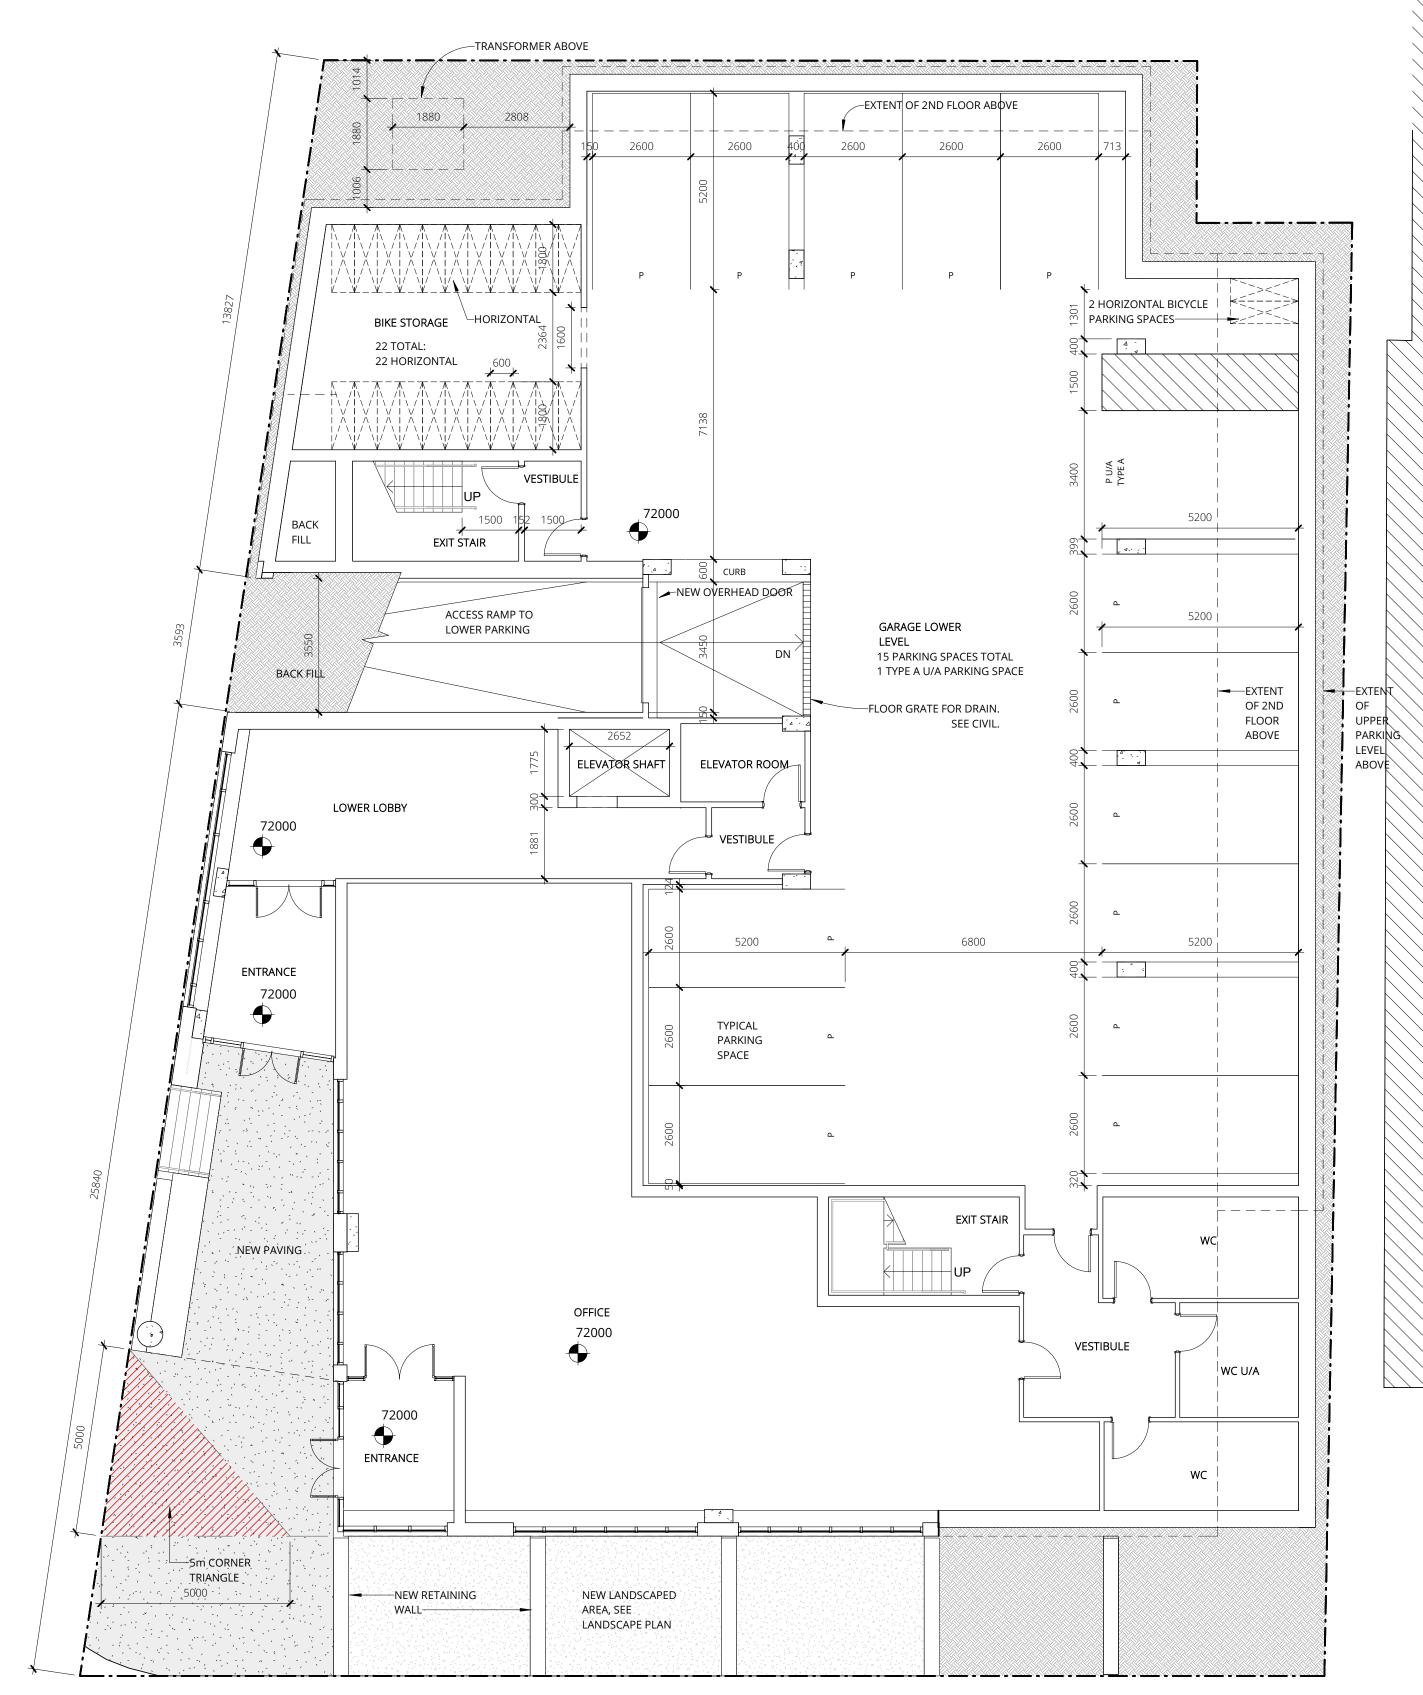
JHS - 289 CARLING AVENUE

JOHN HOWARD SOCIETY 289 CARLING AVE, OTTAWA

designed by conçu par	KWC	approved by approuvé par	RZ
drawn by dessiné par	EI	project no. no. du projet	1850
date	2010 MAY 00	scale	
	2019-MAY-09		as noted

SITE PLAN





1 LO LOWER PARKING/ BASEMENT MAIN ENTRANCES AND OFFICE A101 SCALE 1:100

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NOTES:

Contractor shall check and verify all dimensions on site and report any discrepancies to the Architect before proceeding.

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north	nord	 383 Parko	PH WIESBROCK
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К Э	ЖХ	PHONE FAX E MAIL	(613) 238-2117 (613) 238-6595 kwc@kwc-arch.com
detail no.		FAX	(613) 238-6595

project projet

JHS - 289 CARLING AVENUE

JOHN HOWARD SOCIETY 289 CARLING AVE, OTTAWA


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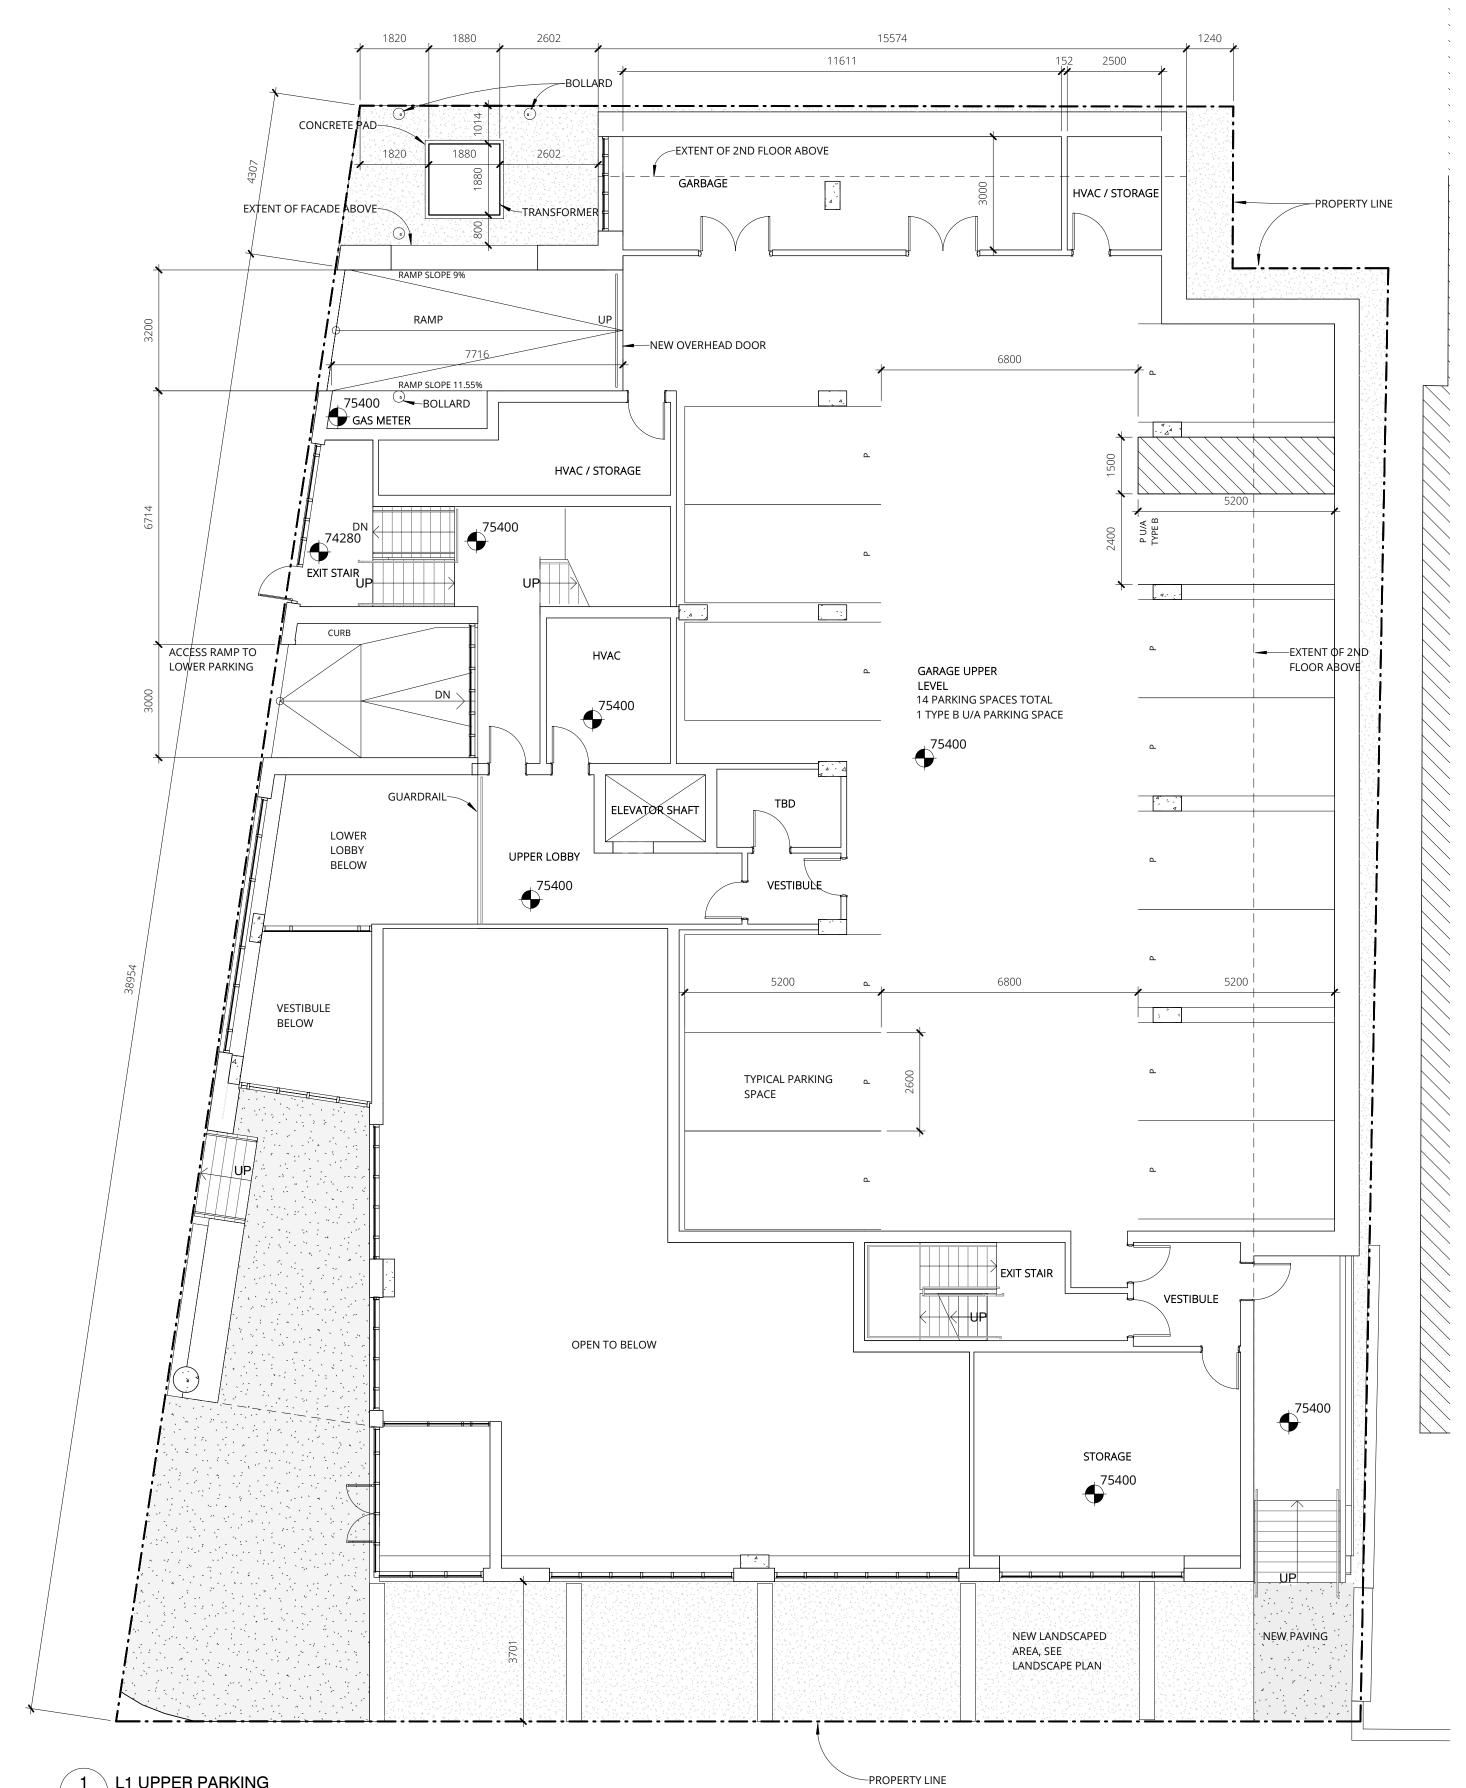
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LEVEL 0 LOWER PARKING PLAN

sheet no. no. de la feuille **A101**

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1 L1 UPPER PARKING A102 SCALE 1 : 100

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J	М МС	Ottawa O	ntario Canada K1Y 4R4 RCHITECTS INC.
		PHONE FAX	(613) 238-2117
J		E MAIL	(613) 238-6595 kwc@kwc-arch.com
detail no.	МЛ		(613) 238-6595 kwc@kwc-arch.com détail no.

project projet

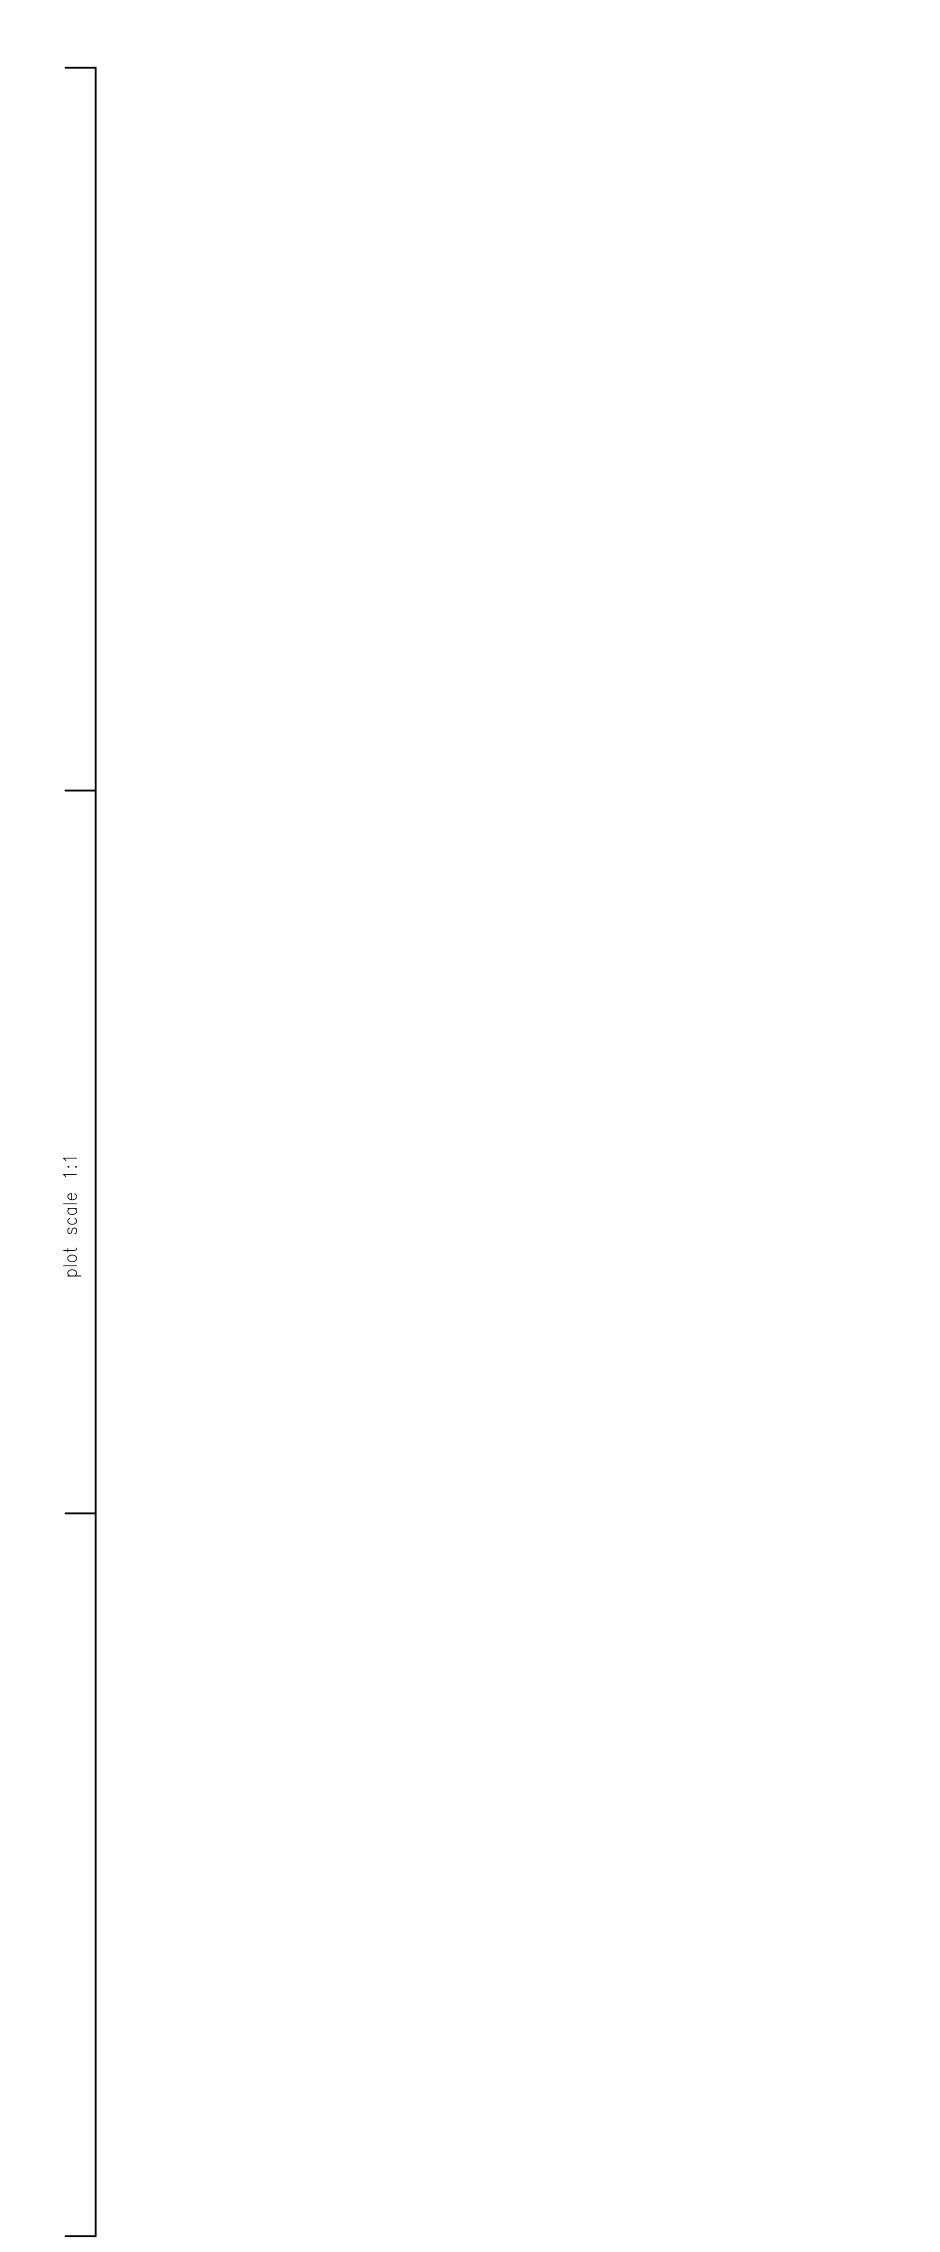JHS - 289 CARLING AVENUE

JOHN HOWARD SOCIETY 289 CARLING AVE, OTTAWA

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drawn by dessiné par	EI	project no. no. du projet	1850
date	2019-MAY-09	scale	as noted

drawing / dessin

LEVEL 1 UPPER PARKING PLAN

sheet no. no. de la feuille **A102**

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