


NORTHWEST ELEVATION

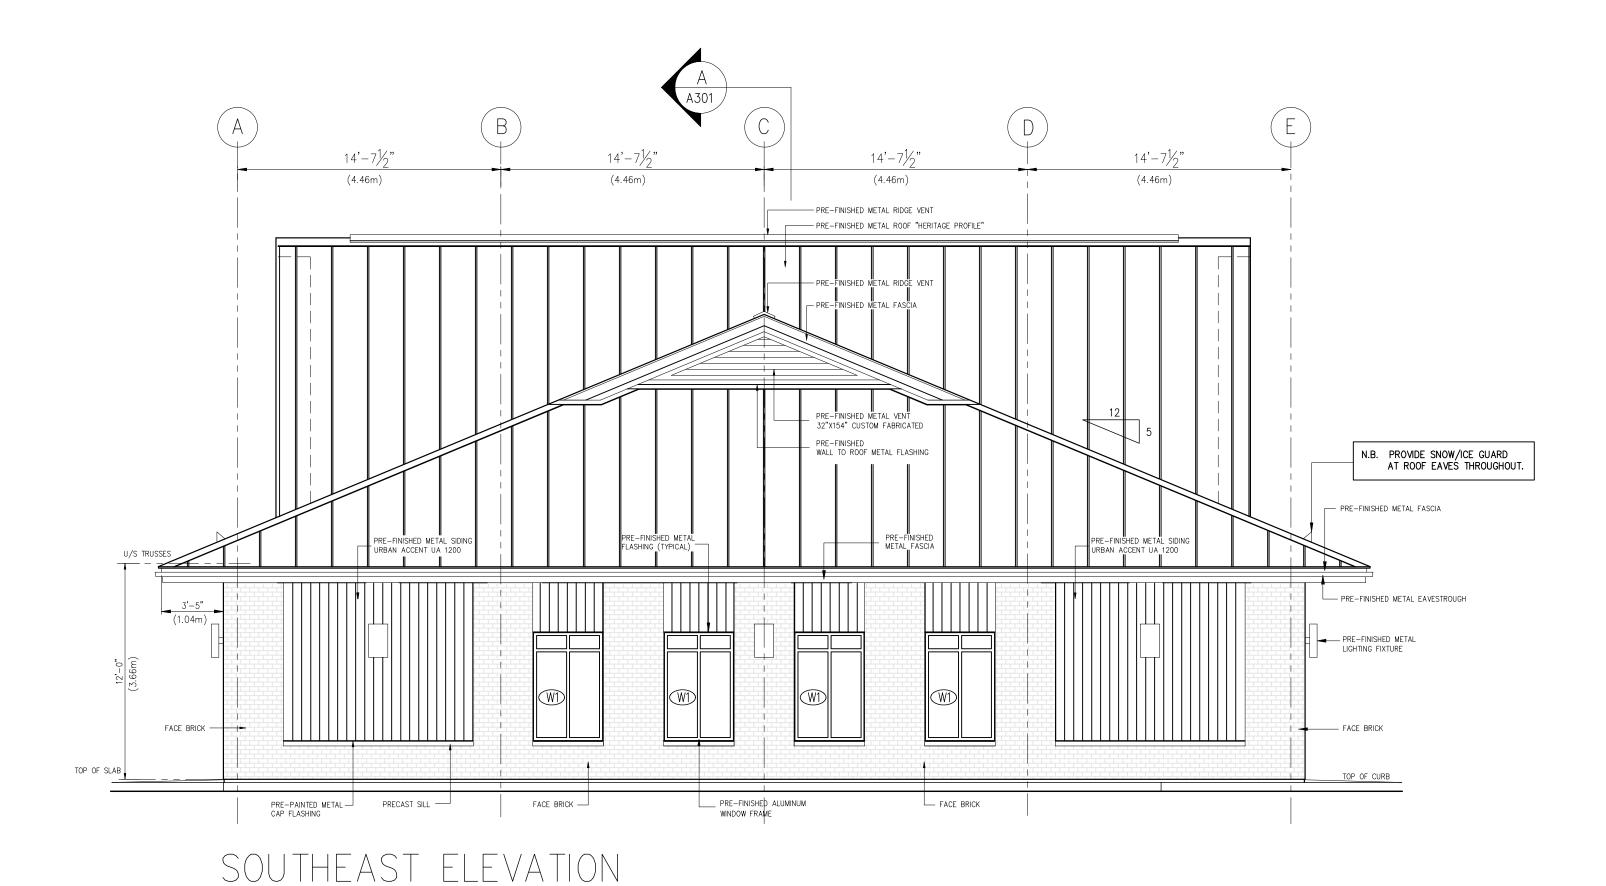

EXTERIOR FINISHES LEGEND:


METAL ROOF AND RIDGE VENT: IDEAL ROOFING HERITAGE (HF) PROFILE 24GA. 20 1/4" WIDE PANELS COL. MARITIME GREY ID 690

PERIMETER WALL ACCENT BRICK: PERMACON MELVILLE SLIK BRICK (UNIT A) $3\frac{1}{2}$ " X $3\frac{1}{8}$ " X $10\frac{1}{8}$ " COL. ROCKLAND BLACK (DARK GREY GROUT)

VALSPAR WEATHER XL - COL. STONE GREY ID 8305

CONSULTANTS:

ALUMINUM FASCIA: PRE-PAINTED METAL FLASHING: COL. TO MATCH METAL ROOFING VENTED ALUMINUM SOFFIT: COL. TO MATCH METAL ROOFING PRE-PAINTED METAL WALL TO ROOF FLASHING: COL. MARITIME GREY ID 690 CUSTOM METAL GABLE VENTS: SIDES VALSPAR WEATHER XL - COL. CHARCOAL ID 8306 PRECAST CONCRETE WINDOW SILL/BRICK CAP: STANDARD GREY CUSTOM METAL GABLE VENTS: FRONT & REAR VALSPAR WEATHER XL - COL. STONE GREY ID 8305 PRE-PAINTED ALUMINUM WINDOWS AND DOORS: FRONT AND REAR GABLE SIDING & TRIM: IDEAL ROOFING COL. BLACK - LOW SHEEN URBAN ACCENT SERIES UA 1200 VALSPAR WEATHER XL - COL. STONE GREY ID 8305 DOOR HARDWARE: URBAN ACCENT SERIES UA 1101 STAINLESS STEEL FINISH VALSPAR WEATHER XL - COL. CHARCOAL ID 8306 (REFER TO WALL ELEVATIONS) LIGHTING FIXTURES: BLACK - LOW SHEEN FINISH PRE-PAINTED METAL FLASHING: VALSPAR WEATHER XL - COL. STONE GREY ID 8305 SIGN BOX FRAME: BLACK - LOW SHEEN FINISH PERIMETER WALL METAL SIDING & TRIM: IDEAL ROOFING URBAN ACCENT SERIES UA 1200 VALSPAR WEATHER XL - COL. STONE GREY ID 8305

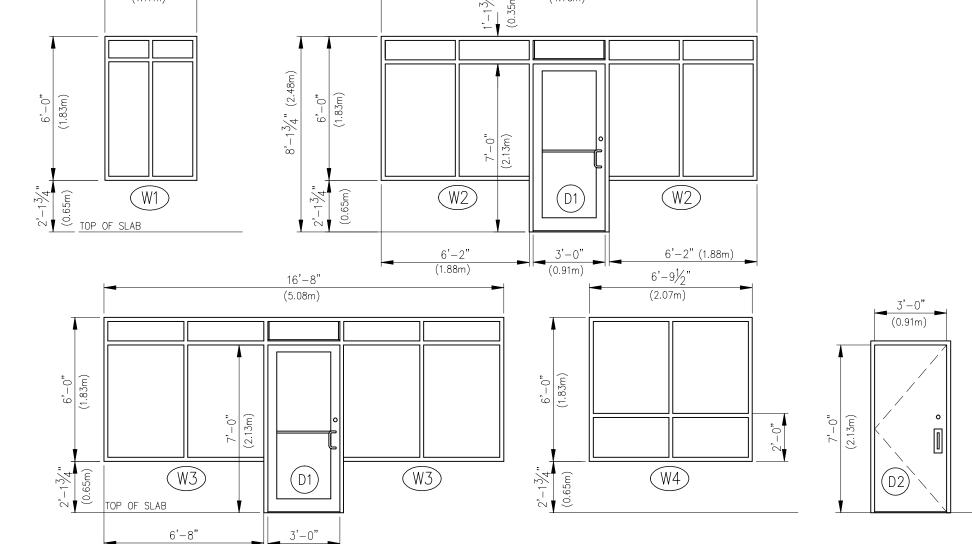

WINDOWS AND DOORS SCHEDULE

N.B. ALL ALUMINUM FRAMES TO BE THERMALLY BROKEN

ANODIZED ALUMINUM FRAME - BLACK LOW SHEEN 4 FIXED PANELS INSULATED GLASS C/W LOW-E, ARGON QUANTITY: 8

ANODIZED ALUMINUM FRAME – BLACK LOW SHEEN 4 FIXED PANELS INSULATED GLASS C/W LOW-E, ARGON QUANTITY: 6

ANODIZED ALUMINUM FRAME — BLACK LOW SHEEN INSULATED TEMPERED GLASS C/W LOW-E, ARGON, WEATHERSTRIPPING, SWEEP, THERMALLY BROKEN ALUMINUM THRESHOLD, DOOR CLOSER - LCN1460 CDH2615-1 FINISH 32D STAINLESS PUSH/PULL KEYED CYLINDER EXIT LOCK WITH INTERIOR THUMBTURN ANODIZED ALUMINUM FRAME - BLACK LOW SHEEN
4 FIXED PANELS
INVALIATED GLASS C/W LOW-E, ARGON

ANODIZED ALUMINUM FRAME — BLACK LOW SHEEN 4 FIXED PANELS SINGLE GLASS NOTE: WINDOW LOCATED IN ROOF DORMER GABLE WALL - NON HEATED SPACE ARCHITECTURAL DESIGN FEATURE ONLY

STEEL DOOR & FRAME C/W THERMO BREAK INSULATED CORE DOOR, WEATHERSTRIPPING, SWEEP, THERMALLY BROKEN ALUMINUM THRESHOLD, DOOR CLOSER - LCN1460, ADAMS RITE 8400 PANIC SET WITH EXTERIOR PULL AND KEYED CYLINDER LOCK - STAINLESS

GENERAL NOTE: ZONE 1 (I-P) OBC SB-10 DIV. 5 REQUIREMENTS FOR: VERTICAL FENESTRATION 0%-40% WALL/WINDOW RATIO MAXIMUM ASSEMBLY U-VALUE = 0.38MAXIMUM ASSEMBLY SHGC = 0.40MINIMUM VT/SHGC = 1.10

ENTRANCE DOORS MAXIMUM ASSEMBLY U-VALUE = 0.69MAXIMUM ASSEMBLY SHGC = 0.40

MINIMUM THERMAL RESISTANCE OF INSULATED CORE METAL DOORS = R4 OR RSI 0.7

09 REVISED TO NEW SITE PLAN, NEW MAY 28/19 PROJECT ADDRESS AND FOR PERMIT REVISED TO 5 RETAIL UNITS WITH CORRECTIONS TO ALL DWGS & UBMITTED FOR FINAL REVIEW. UBMITTED FOR M&E P.ENG. AUG 31/18 RE-SUBMITTED FOR STRUCTURAL MAR 9/18 SUBMITTED FOR ENGINEERING SEPT 16/13 REVISED FOR CLIENT REVIEW JUNE 29/1:

REVISED FOR CLIENT REVIEW

SUBMITTED FOR CLIENT REVIEW

MALETTE

DESIGN

BCIN No. 112887

TEL: 613-762-6069

malettedesign@yahoo.ca

ALL WORK TO BE DONE IN ACCORDANCE WITH THE LATEST

T IS THE RESPONSIBILITY OF THE INDIVIDUAL CONTRACTOR

TO CHECK AND VERIFY ALL DIMENSIONS ON SITE AND TO

CONTRACTORS MUST COMPLY WITH ALL PERTINENT CODES

CONFIRM LOCATION OF ALL UNDERGROUND SERVICES PRIOR

DO NOT SCALE DRAWINGS. COPYRIGHT RESERVED.

REPORT ANY DISCREPANCIES TO THE DESIGNER AND/OR

EDITION OF THE ONTARIO BUILDING CODE.

CONSULTANTS.

AND BY-LAWS.

TO EXCAVATION.

PROJECT TITLE:

PROPOSED RETAIL BUILDING

APR 24/12

APR 23/12 DATE

6075 BANK ST. GREELY, ON

DRAWING TITLE:

EXTERIOR ELEVATIONS WINDOWS/DOORS **SCHEDULE**

PROJECT No. : DWG No: DATE: APRIL 20, 2012 A-202 SCALE:

3/16" = 1'- 0" DWG BY: G. MALETTE BCIN No. 26217